
HIGH SCHOOL TENNIS COURT REPLACEMENT

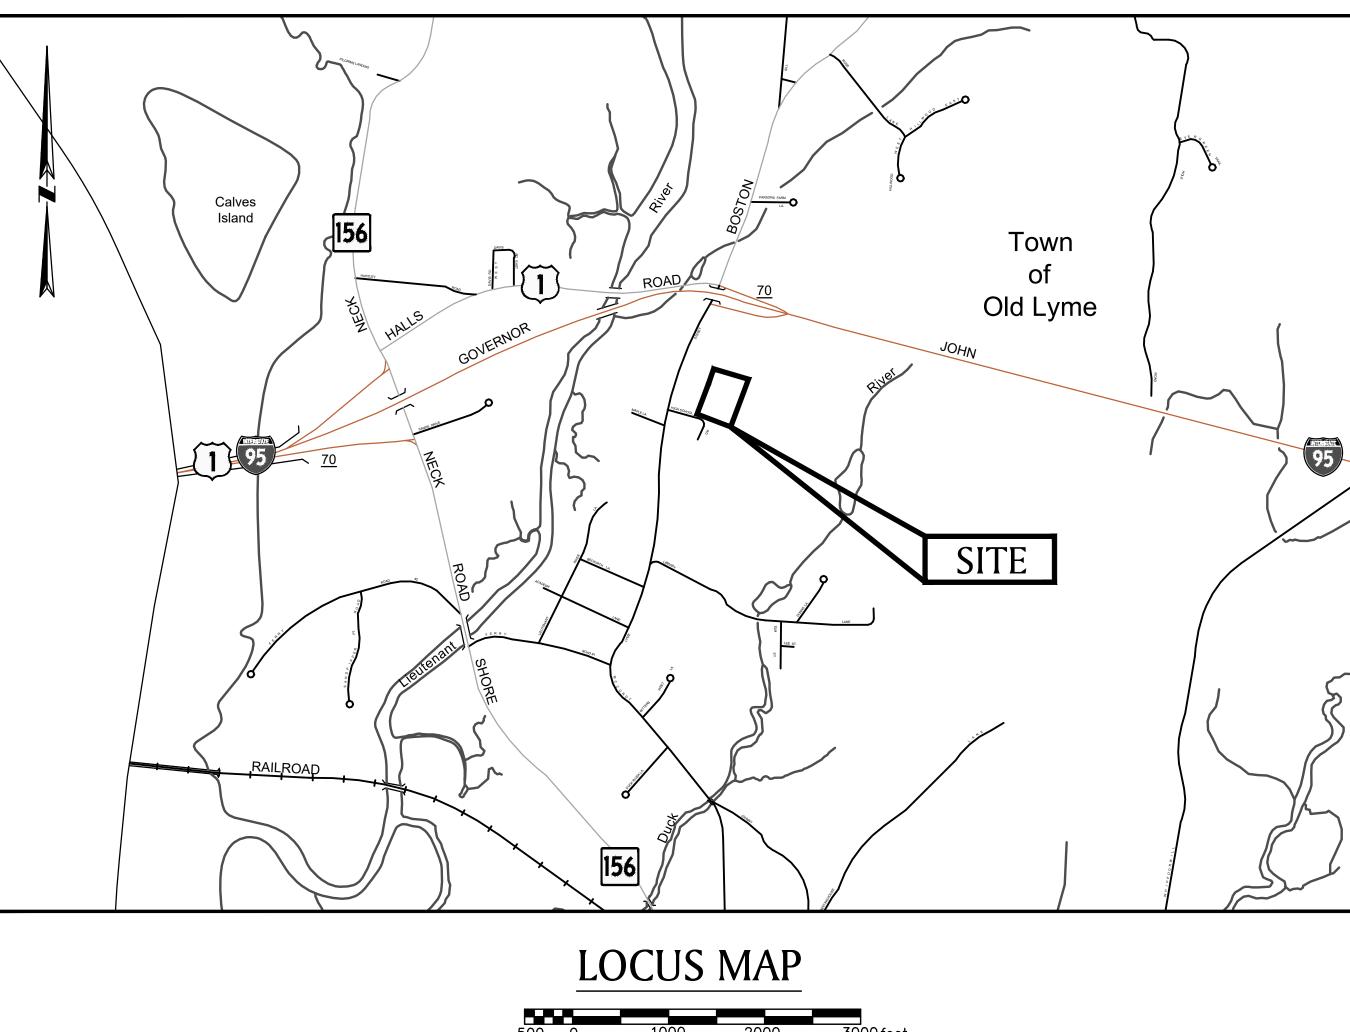

PREPARED FOR:

REGIONAL SCHOOL DISTRICT NO.18 49 LYME STREET OLD LYME, CT 06371

69 LYME STREET OLD LYME JANUARY 3, 2020

SCALE: $1'' = 1000' \pm$

ISSUED FOR BID

INDEX OF DRAWINGS

- T-1.0 COVER SHEET
- **EXISTING CONDITIONS PLAN** E-1.0
- SITE PREPARATION PLAN L-1.0
- SITE PLAN L-2.0
- L-3.0 GRADING AND DRAINAGE PLAN
- DETAILS L-4.0
- DETAILS L-4.1
- DETAILS L-4.2


PREPARED BY:





JOB NO: 83759.00 DWG NO:

SHEET T-1.0

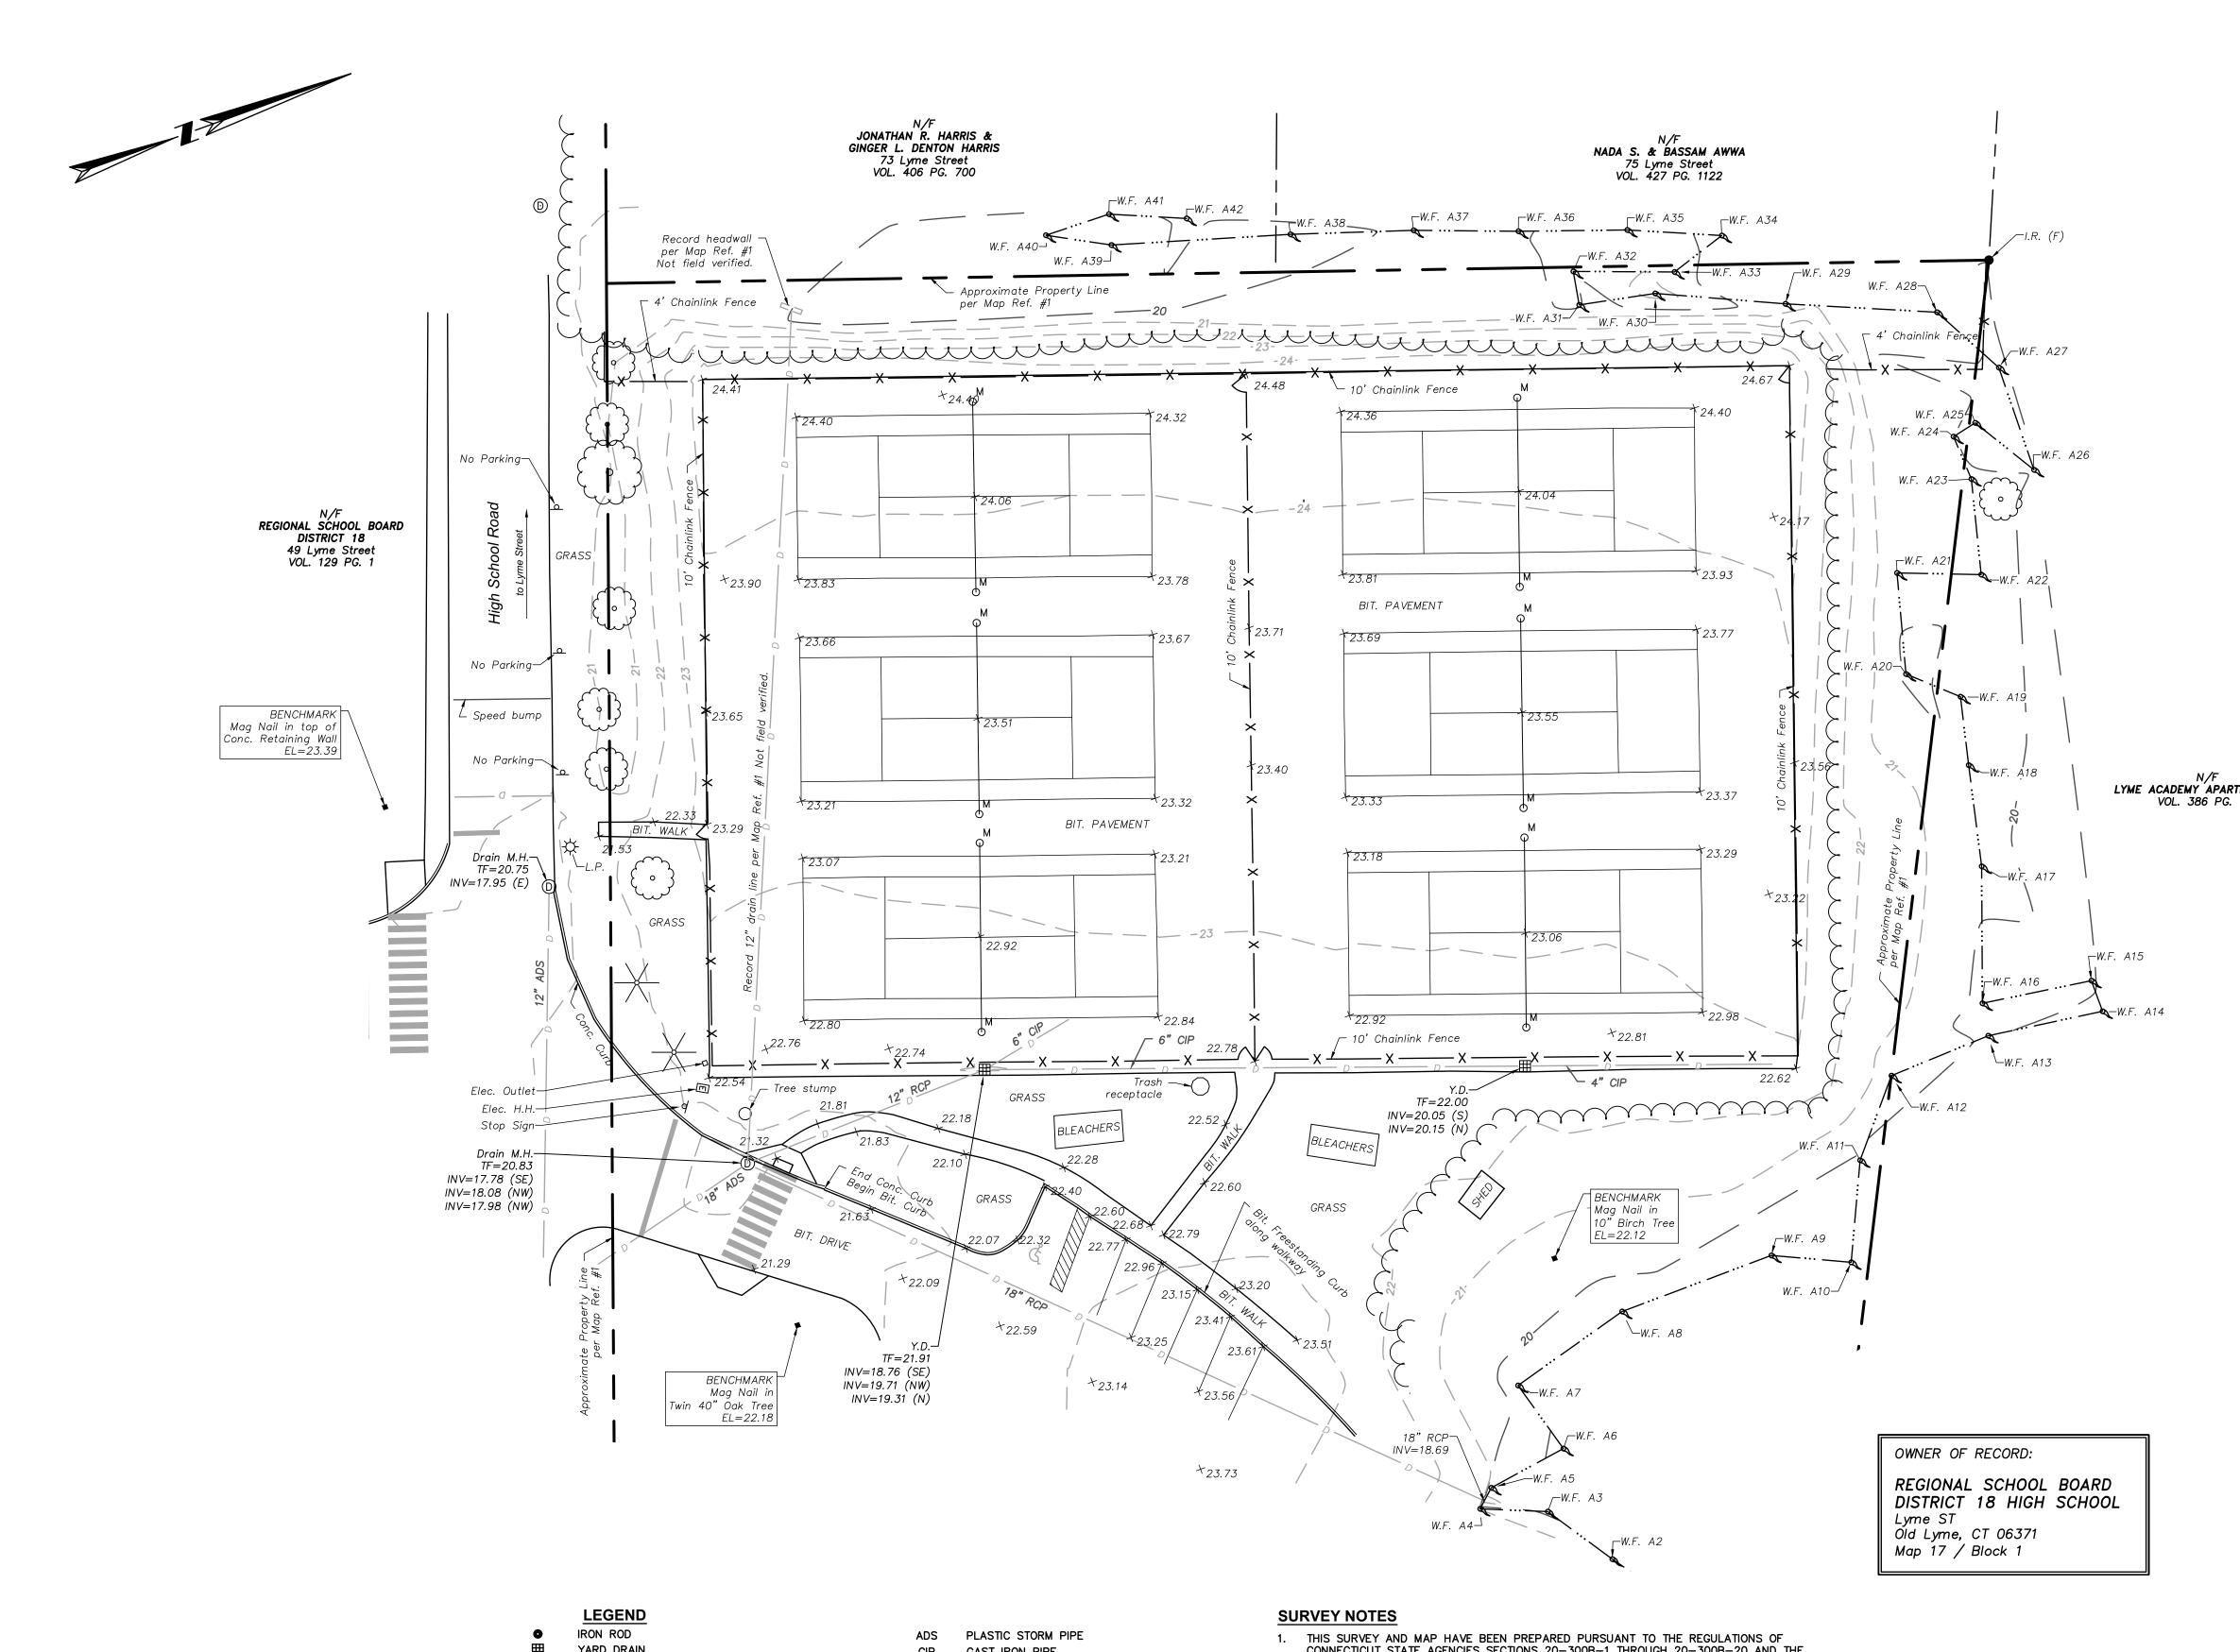

	LEGEND		
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Ħ	YARD DRAIN	CIP	CAST
\bigcirc	STORM DRAINAGE MANHOLE	ELEC.	ELECT
E	ELECTRIC HAND HOLE	H.H.	HANDH
o M	METAL POST	М.Н.	MANHO
°, ↓ ↓ ()	LIGHT POLE SIGN WETLANDS FLAG DECIDUOUS TREE	Y.D. I.R. W.F. A9	YARD IRON F WETLA STORM
HT. RCP	Conifer tree Bituminous Reinforced concrete Pipe		FENCE WALL, BOUNE

MAP REFERENCES:

1. "PROPERTY SURVEY AND EXISTING CONDITIONS PLAN PROPERTY OF REGIONAL SCHOOL DISTRICT NUMBER 18 LYME STREET OLD LYME, CONNECTICUT" DATE: JANUARY 10, 2006 SCALE: 1"=40' SHEET 2 OF 5 PREPARED BY DICESARE BENTLEY

- F IRON PIPE TRIC OHOLE HOLE
-) DRAIN ROD AND FLAG # RM DRAINAGE PIPES
- E, CHAINLINK , STONE NDARY, WETLANDS

- CONNECTICUT STATE AGENCIES SECTIONS 20-300B-1 THROUGH 20-300B-20 AND THE "STANDARDS FOR SURVEYS AND MAPS IN THE STATE OF CONNECTICUT" AS ADOPTED BY THE CONNECTICUT ASSOCIATION OF LAND SURVEYORS, INC. ON SEPTEMBER 26, 1996. TOPOGRAPHIC ACCURACY CONFORMS WITH T-2 STANDARDS AND IS BASED ON AN ACTUAL FIELD SURVEY
- THIS IS NOT A PROPERTY SURVEY.
- 2. THE INTENT OF THIS SURVEY AND PLAN: EXISTING CONDITIONS FOR IMPROVEMENT PLANNING.
- 3. THE FIELD SURVEY WAS PERFORMED ON THE GROUND BY BSC GROUP ON DEC. 18, 2019. 4. THE VERTICAL DATUM SHOWN IS BASED UPON NATIONAL AMERICAN VERTICAL DATUM OF 1988 (NAVD88), THE REFERENCE MERIDIAN (NORTH ARROW) SHOWN IS BASED UPON NORTH AMERICAN DATUM OF 1983 (NAD83), BOTH HORIZONTAL AND VERTICAL DATUMS ARE DETERMINED FROM RTK/G.P.S.
- 5. EXISTING UTILITIES, WHERE SHOWN HEREON, ARE APPROXIMATE. NO GUARANTEE IS IMPLIED OR INTENDED AS TO THE ACCURACY, LOCATION OR THAT ALL UTILITIES AND/OR SUBSURFACE STRUCTURES ARE SHOWN. CONSULT WITH THE APPROPRIATE UTILITY COMPANY OR AGENCY PRIOR TO DESIGNING IMPROVEMENTS, COMMENCING DEMOLITION OR CONSTRUCTION. "CALL BEFORE YOU DIG" 1-800-922-4455.

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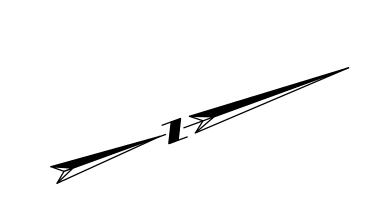
MICHAEL C. HEALEY, P.L.S. No. 17247	
HIGH SCHOOL TENNIS COURT REPLACEMENT	
69 LYME STREET	
IN OLD LYME CONNECTICUT	
EXISTING CONDITIONS PLAN	
JANUARY 3, 2020	
REVISIONS:	
	-
PREPARED FOR: REGIONAL SCHOOL DISTRICT NO.18 49 LYME STREET OLD LYME, CT 06371	
300 Winding Brook Drive Glastonbury, Connecticut 06033 860 652 8227	
© 2019 BSC GROUP, INC. SCALE: $1'' = 20'$ 0 10 20 40 FEET	


FILE: 83759.00-XCP.DWG

JOB. NO: **83759.00**

E-1.0

DWG. NO:



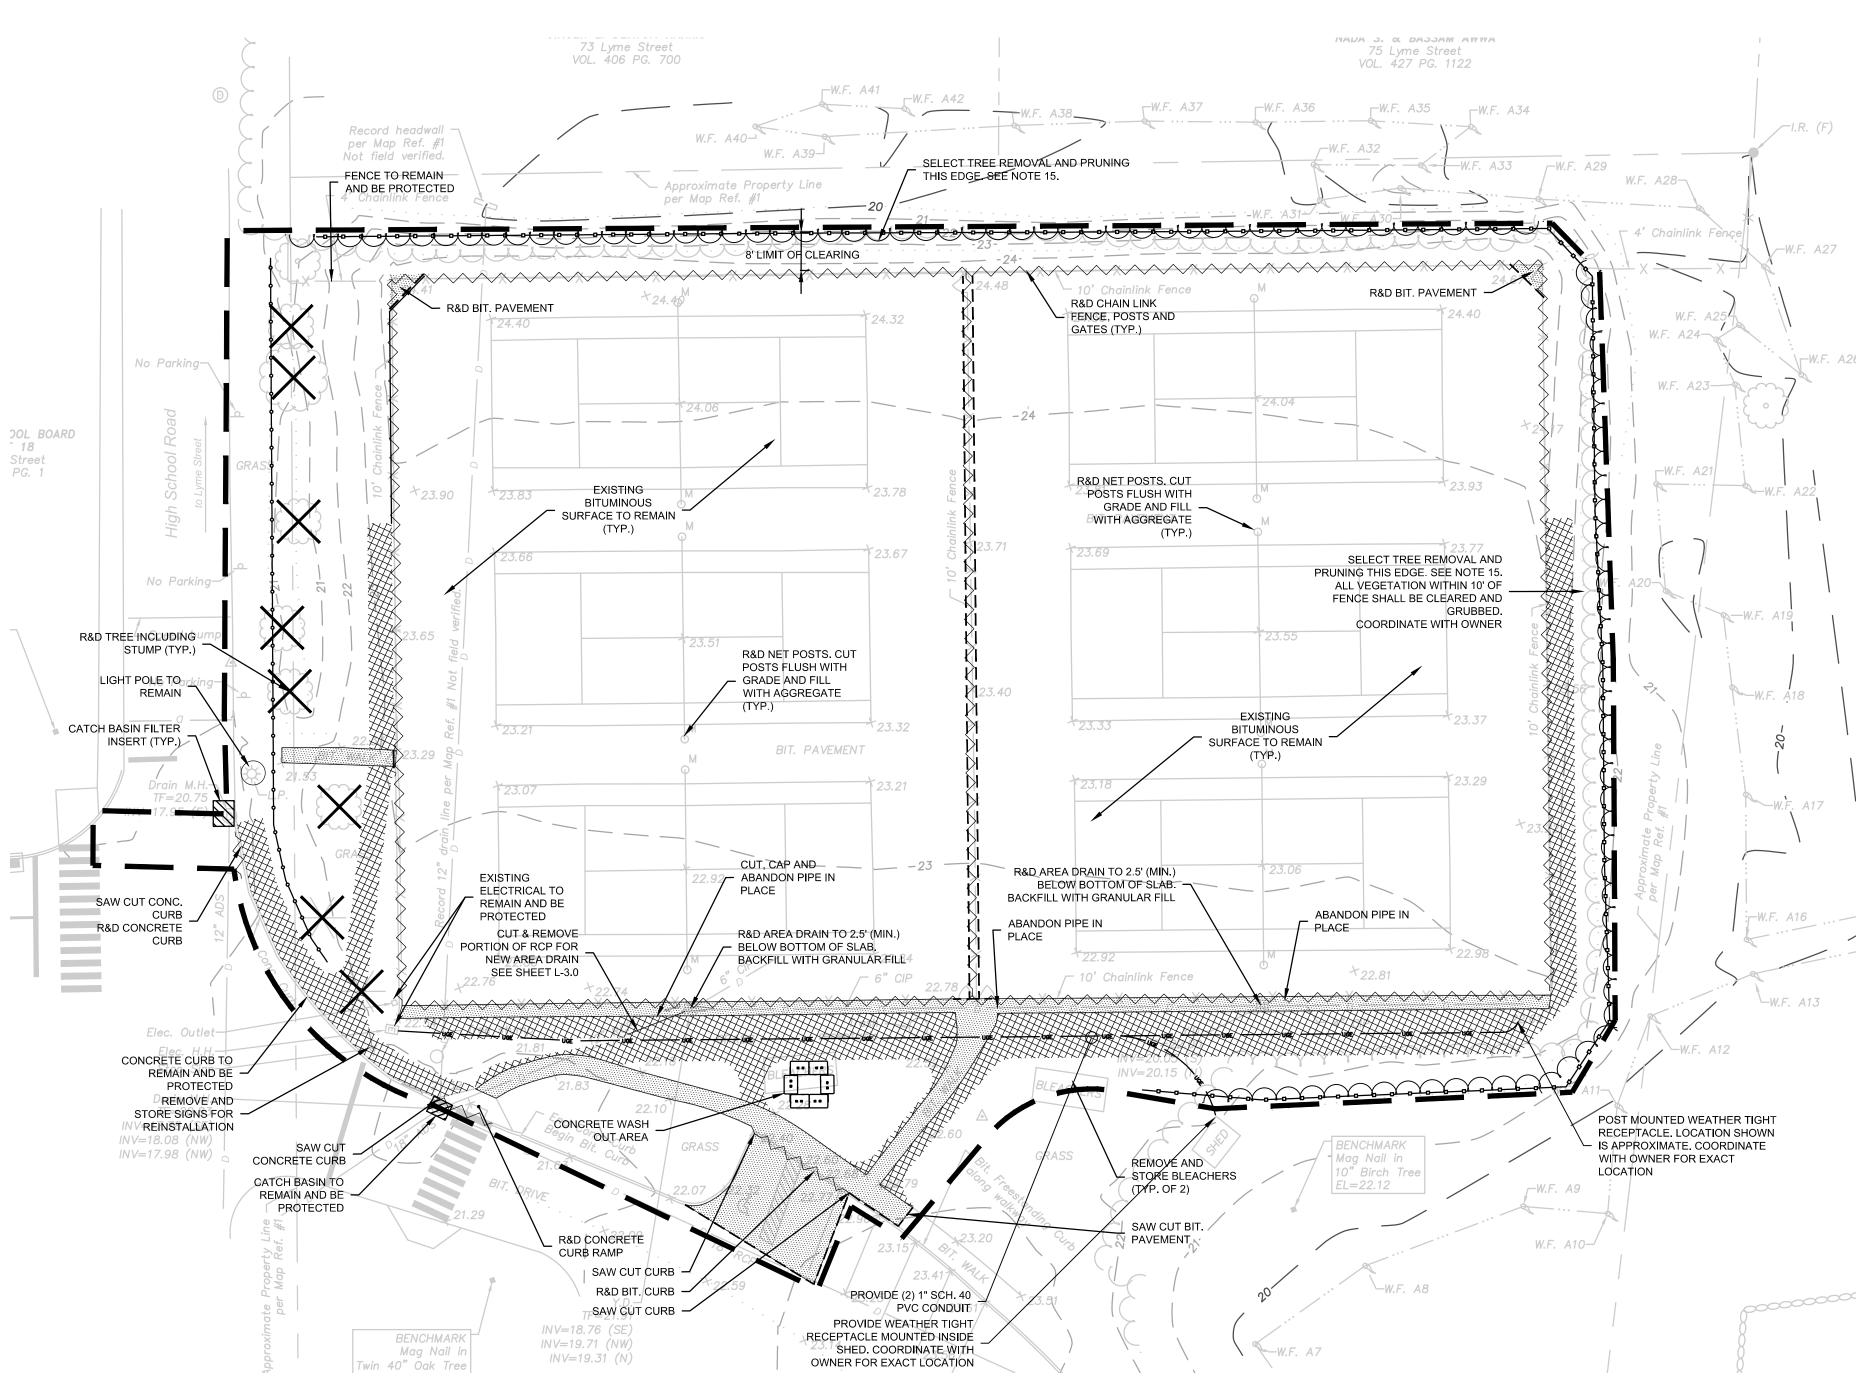

LEGEND

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- PROPERTY LINE
- LIMIT OF WORK
- _____ DEMOLITION SAWCUT ______ -____ -___ - SILT FENCE
 - PROTECT SITE FEATURE TO REMAIN
 - R&D PAVEMENT
 - STRIP TOPSOIL
 - R&D SITE FEATURE
 - AREA DRAIN FILTER INSERT - CATCH BASIN FILTER INSERT

 - CONCRETE WASHOUT AREA

R&D - REMOVE AND DISPOSE

NOTES:

- 1. THIS PLAN IS FOR SITE PREPARATION ONLY. SEE OTHER PLANS FOR THE SCOPE OF CONSTRUCTION WORK.
- 2. DO NOT PROCEED WITH THE WORK UNTIL ALL E&S CONTROL MEASURES ARE IN-PLACE AND HAVE BEEN INSPECTED AND APPROVED BY THE ENGINEER.
- 3. THE MEASURES SPECIFIED HEREON ARE THE MINIMUM REQUIREMENTS FOR E&S CONTROL AND ARE SHOWN IN GENERAL SIZE AND LOCATION ONLY. THE CONTRACTOR SHALL BE RESPONSIBLE FOR ENSURING THAT ALL E&S CONTROL MEASURES ARE CONFIGURED AND CONSTRUCTED IN A MANNER THAT WILL MINIMIZE EROSION OF SOILS AND PREVENT THE TRANSPORT OF SEDIMENTS AND OTHER POLLUTANTS TO ANY RESOURCE AREAS. PROVIDE ADDITIONAL E&S MEASURES AS REQUIRED TO CONTROL EROSION AND SILTATION THROUGHOUT THE DURATION OF THE CONSTRUCTION AS CONDITIONS DICTATE AND/OR AS DIRECTED BY THE OWNER OR THE ENGINEER.
- MINIMIZE EROSION OF SOILS AND PREVENT THE TRANSPORT OF SEDIMENTS AND OTHER POLLUTANTS TO ANY RESOURCE AREAS.
- 4. MONITOR AND INSPECT ALL E&S MEASURES IN AN ONGOING MANNER THROUGHOUT THE WORK AND TAKE CORRECTIVE MEASURES, AS REQUIRED, TO 5. ANY EROSION AND SEDIMENTATION MEASURE IMPLEMENTED BEYOND THAT SHOWN HEREON SHALL CONFORM TO APPLICABLE SECTIONS OF THE STATE OF CONNECTICUT'S "2002 CONNECTICUT GUIDELINES FOR SOIL EROSION AND SEDIMENT CONTROL."
- 6. ANY STOCKPILED MATERIAL SHALL BE SUBJECT TO EROSION CONTROL MEASURES THAT INCLUDE A MINIMUM OF SILT FENCE OR HAY BALE BARRIER COVER STOCKPILES IF SIGNIFICANT RAINFALL IS PREDICTED.
- 7. PROVIDE TEMPORARY SEEDING WITH MULCH ON ALL EXPOSED SOIL AREAS WHERE WORK WILL BE SUSPENDED FOR LONGER THAN 30 DAYS. APPLY SEED

AND MULCH WITHIN THE FIRST 7 DAYS OF SUSPENDING WORK. WHEN SEEDING IS NOT POSSIBLE DUE TO SEASONAL WEAT FACTORS, PROVIDE TEMPORARY STRUCTURAL SOIL PROTECTION SUCH AS MULCH, WOODCHIPS, EROSION CONTROL MATT 8. ALL TEMPORARY SLOPES IN EXCESS OF 3 (HORIZONTAL) TO 1 (VERTICAL) SHALL BE STABILIZED WITH EROSION CONTROL N

9. NO RUNOFF SHALL BE ALLOWED TO ENTER ANY STORMWATER SYSTEM OR EXIT THE SITE PRIOR TO TREATMENT FOR SEDII


EQUIVALENT.

- 10. THE CONTRACTOR SHALL MAINTAIN A CLEAN CONSTRUCTION SITE AND SHALL NOT ALLOW THE ACCUMULATION OF RUBBIS ALL TRASH SHALL BE CLEANED ON A DAILY BASIS AND THE SITE SHALL BE LEFT IN A NEAT CONDITION AT THE END OF EACH
- 11. TAKE ALL NECESSARY PRECAUTIONS TO AVOID THE SPILLAGE OF FUEL OR OTHER POLLUTANTS AND ADHERE TO ALL APPL REGULATIONS RELATED TO SPILL PREVENTION, CONTROL, AND RESPONSE.
- 12. FOR DUST CONTROL, PERIODICALLY MOISTEN EXPOSED SOIL SURFACES WITH WATER AND MAINTAIN ADEQUATE MOISTURE
- 13. SWEEP ADJACENT ROADWAYS IF MUD OR SOIL IS TRACKED ON TO THEM, OR AS DIRECTED BY THE ENGINEER. SHOULD THE FAIL TO PREVENT THE TRACKING OF SOILS OR SEDIMENT OFF OF THE PROJECT SITE, A WASHING RACK SHALL BE INSTALL MEASURES TO COLLECT RESULTING WASTEWATER.
- 14. DRAINAGE STRUCTURE FILTER INSERTS SHALL BE INSTALLED AND CLEANED/CHANGED PER THE MANUFACTURER'S RECOMI INSTALLED COMPLETELY AROUND INLETS OF EXISTING AND PROPOSED DRAINAGE STRUCTURES SUCH THAT NO RUNOFF IS DRAINAGE SYSTEMS WITHOUT FILTERING THROUGH THE DEVICE.
- 15. ALL VEGETATION WITH 8' OF WEST FENCE LINE AND 10' OF NORTH FENCE LINE SHALL BE CLEARED AND GRUBBED. ADDTIOI REQUIRED TO FACILITATE THE WORK. BRANCHES THAT ENCROACH OVER THE TOP OF THE COURTS SHALL BE PRUNED BAC COURTS AT A MINIMUM AND TO THE TRUNK WHERE PRACTICAL. FOLLOW ALL ARBORICULTURAL STANDARDS AND PRACTIC PERFORMED BY CT-LICENSED ARBORIST. COORDINATE WITH OWNER.

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MMENDATIONS. UNITS SHALL BE IS ALLOWED TO ENTER	
ONAL CLEARING MAY BE CK TO OUTSIDE THE LIMITS OF CES. WORK SHALL BE	ISSUED F

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No. 1224
OF CONNECTION
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v
JESSE HARRIS, PLA No. 1224
JEGGE HARRIG, FEA NO. 1224
HIGH SCHOOL
TENNIS COURT
REPLACEMENT
69 LYME STREET
IN
OLD LYME
CONNECTICUT
SITE PREPARATION PLAN
JANUARY 3, 2020
REVISIONS:
PREPARED FOR:
REGIONAL SCHOOL DISTRICT NO.18
49 LYME STREET OLD LYME, CT 06371
, .
BSC GROUP
BSC GROUP 300 Winding Brook Drive
300 Winding Brook Drive Glastonbury, Connecticut 06033
300 Winding Brook Drive
300 Winding Brook Drive Glastonbury, Connecticut 06033
300 Winding Brook Drive Glastonbury, Connecticut 06033 860 652 8227
300 Winding Brook Drive Glastonbury, Connecticut 06033 860 652 8227 © 2019 BSC GROUP, INC.
300 Winding Brook Drive Glastonbury, Connecticut 06033 860 652 8227 © 2019 BSC GROUP, INC. SCALE: 1" = 20'
300 Winding Brook Drive Glastonbury, Connecticut 06033 $\overline{860\ 652\ 8227}$ © 2019 BSC GROUP, INC. SCALE: 1" = 20' $\overline{0\ 10\ 20\ 40\ FEET}$

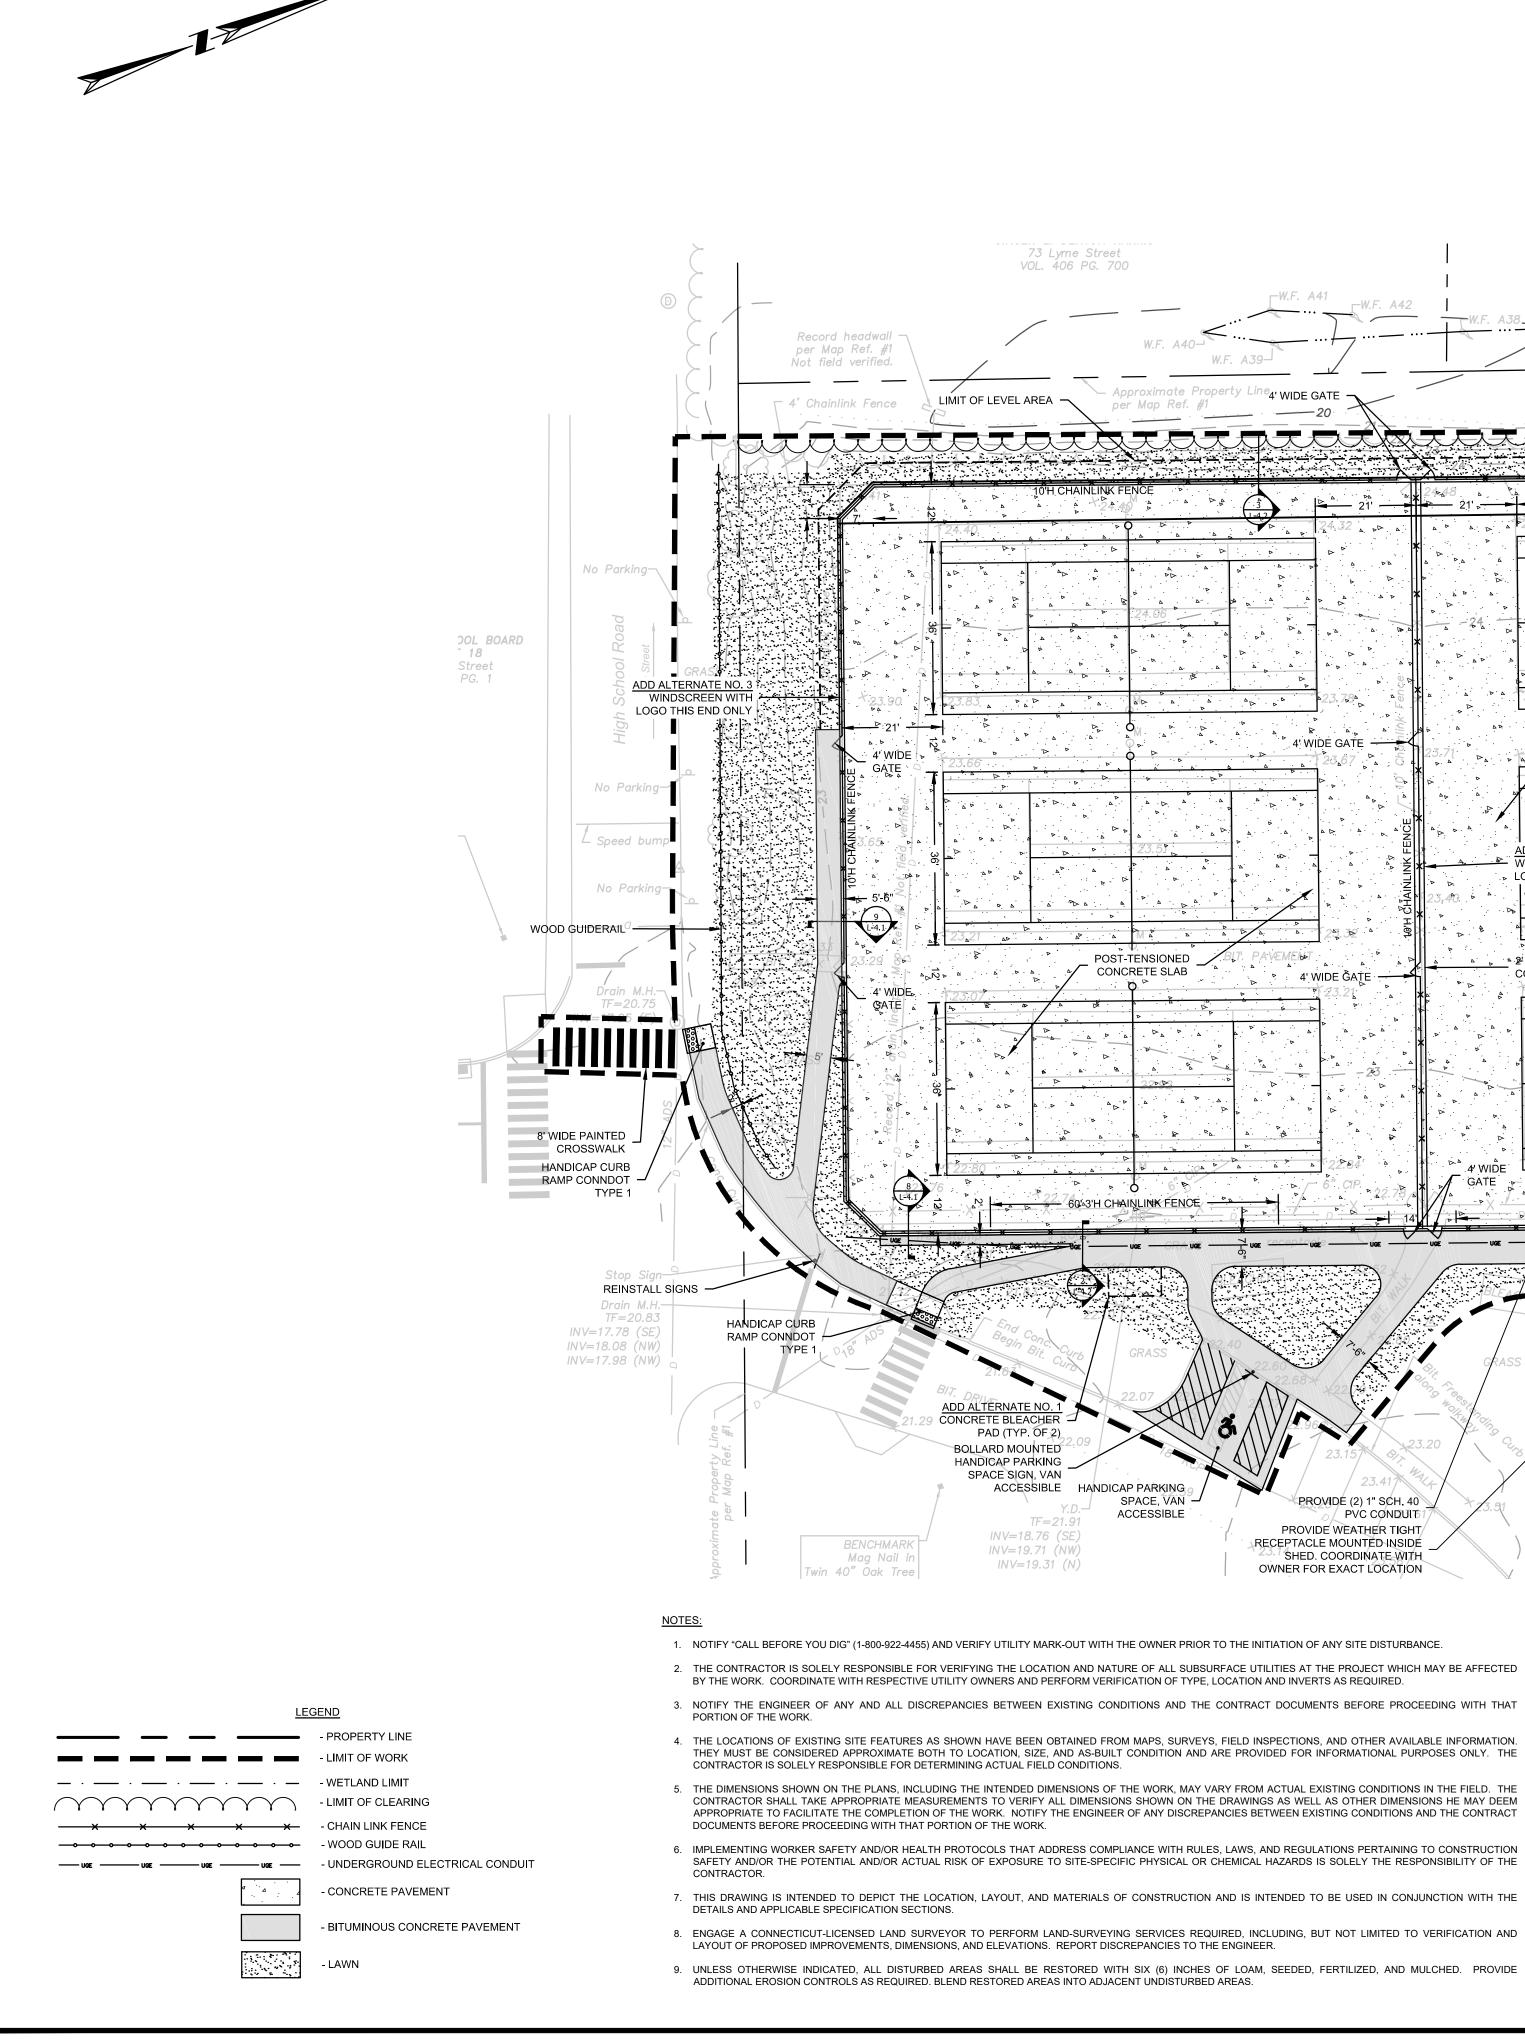

6. IMPLEMENTING WORKER SAFETY AND/OR HEALTH PROTOCOLS THAT ADDRESS COMPLIANCE WITH RULES, LAWS, AND REGULATIONS PERTAINING TO CONSTRUCTION SAFETY AND/OR THE POTENTIAL AND/OR ACTUAL RISK OF EXPOSURE TO SITE-SPECIFIC PHYSICAL OR CHEMICAL HAZARDS IS SOLELY THE RESPONSIBILITY OF THE 7. THIS DRAWING IS INTENDED TO DEPICT THE LOCATION, LAYOUT, AND MATERIALS OF CONSTRUCTION AND IS INTENDED TO BE USED IN CONJUNCTION WITH THE 8. ENGAGE A CONNECTICUT-LICENSED LAND SURVEYOR TO PERFORM LAND-SURVEYING SERVICES REQUIRED, INCLUDING, BUT NOT LIMITED TO VERIFICATION AND 9. UNLESS OTHERWISE INDICATED, ALL DISTURBED AREAS SHALL BE RESTORED WITH SIX (6) INCHES OF LOAM, SEEDED, FERTILIZED, AND MULCHED. PROVIDE

-W.F. A41

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W.F. A40-

per Map Ref. #1

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SPACE, VAN -ACCESSIBLE

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POST-TENSIONED

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24.40 ₽

W.F. A39-

- Approximate Property Line₄ WIDE GATE

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-W.F. A42

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PROVIDE (2) 1" SCH. 40

PROVIDE WEATHER TIGHT

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RECEPTACLE MOUNTED INSIDE

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🕞 🛛 4' WIDE ĜATE — 🌱

P 23

. 4' WIDE GATE 🗕 🗕

- 15. ALL NON-ACCESSIBLE PARKING SPACES ARE 9' X 18'. VERIFY OVERALL LAYOUT DIMENSIONS BASED ON THESE DIMENSIONS AND THE NUM
- FIELD-ADJUST OVERALL LAYOUT DIMENSION IN CONCERT WITH THE ENGINEER IF REQUIRED. 16. DIMENSIONS INDICATED ARE TO FACE OF CURB, PAVEMENT EDGE, EDGE OR CENTERLINE OF IMPROVEMENT, OR AS OTHERWISE NOTED.

- 14. UNLESS OTHERWISE SPECIFIED, MISCELLANEOUS CONCRETE PADS SHALL BE CONSTRUCTED PER SIDEWALK DETAIL.
- PLAN WITH THE JOINT PATTERNS DEPICTED ON THE DRAWINGS.

- 12. CONSTRUCTION JOINTS: REINFORCEMENT SHALL NOT CONTINUE THROUGH CONSTRUCTION JOINTS.

- 13. PRIOR TO INITIATION OF CONCRETE FLATWORK, SUBMIT PROPOSED CONSTRUCTION JOINT PLAN TO THE ENGINEER FOR REVIEW AND APPE

ADD ALTERNATE NO. 3 WINDSCREEN WITH

▲ & WIDE ★ 5" THICK ▲ ▷ ▷ ▲ ◎

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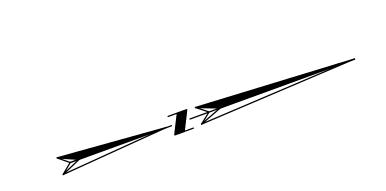
CONCRETE CLOSURE STRIP


▹ LOGO THIS END ONLY

A. . .

- 11. RAMPS SHALL COMPLY WITH CT BUILDING CODE, REF. 2012 IBC SECTION 1010 AND ICC/ANSI A117.1 2009 CHAPTER 4, SECTION 405.

INADA J. O. DAJJAM AWWA		
75 Lyme Street VOL. 427 PG. 1122 W.F. A37 W.F. A36 W.F. A35 W.F. A34 		No. 1224
W.F. A29 W.F. A28 W.F. A28 W.F. A28 W.F. A28 W.F. A28		A Contraction of the second se
10'H CHAINLINK FENCE		JESSE HARRIS, PLA No. 1224
W.F. A24 W.F. A24 W.F. A24		HIGH SCHOOL TENNIS COURT
W.F. A23		REPLACEMENT
POST-TENSIONED W.F. A22		
		69 LYME STREET
ERNATE NO. 3 REEN WITH IIS END ONLY		in OLD LYME
х 5" тніск		CONNECTICUT
TE CLOSURE STRIP CONTRACTOR CONTR		SITE PLAN
$ \begin{array}{c ccccccccccccccccccccccccccccccccccc$		JANUARY 3, 2020
$\begin{array}{c ccccccccccccccccccccccccccccccccccc$	ELECTRICAL NOTES: 1. ALL EXISTING SUBSURFACE UTILITIES, STRUCTURES AND SITE ELEMENTS TO REMAIN, SUBJURE DEDUCTED FROM RAMAGE ANY RAMAGE TO EXISTING SITE FURNING SUBJURE	J. I. (2, 2, 2, 2, 2, 2, 2, 2, 2, 2, 2, 2, 2,
W.F. A13	 SHALL BE PROTECTED FROM DAMAGE. ANY DAMAGE TO EXISTING SITE ELEMENTS SHALL BE REPAIRED OR REPLACED AT NO ADDITIONAL COST TO THE OWNER. ALL ELECTRICAL WORK SHALL BE COMPLETED BY A CT-LICENSED ELECTRICIAN. COMPLY WITH ALL APPLICABLE CODES AND REGULATIONS. COORDINATE AND ACCOMMODATE THE INSPECTION OF ALL ELECTRICAL WORK WITH AUTHORITIES HAVING JURISDICTION. 	REVISIONS:
POST MOUNTED WEATHER TIGHT RECEPTACLE. LOCATION SHOWN	 ALL ELECTRICAL COMPONENTS SHALL BE WATERTIGHT, NEMA 6P. CONDUIT: RIGID PVC ELECTRICAL CONDUIT, NEMA TC 2 AND UL-651; FITTINGS AND CONDUIT BODIES: PVC TO MATCH CONDUIT, NEMA TC 3; PRIMER AND CEMENT' ASTM F656/ASTM D2564. 	
BENCHMARK Mag Nail in 10" Birch Tree EL=22.12 W.F. A9	4. COORDINATE WITH OWNER TO LOCATE THE EXISTING ELECTRICAL LINE. THIS LOCATION MAY BE SUBJECT TO FLOODING, ALL COMPONENTS OF THE SYSTEM SHALL BE WATERTIGHT. WHERE EXISTING WORK IS NOT WATERPROOF, PROVIDE SINGLE-COMPONENT, GUN-GRADE 100% SILICONE SEALANT OR WATERPROOF CABLE GLAND TO ISOLATE NEW WORK AND PREVENT WATER INTRUSION. PROVIDE SHOP DRAWINGS OF ALL PROPOSED CONNECTIONS FOR ENGINEER AND OWNER'S APPROVAL.	
W.F. A10-		
W.F. A8		PREPARED FOR:
 ALL CURBING IS BITUMINOUS CONCRETE UNLESS OTHERWISE INDICATED. WHERE CURBING IS CALLED-FOR ADJACENT TO SIDEWALKS, IT SHALL BE CONCRETE CURB AND SIDEWALK PER APPLICABLE DETAILS. 	E MONOLITHIC	REGIONAL SCHOOL DISTRICT NO.18 49 LYME STREET OLD LYME, CT 06371
 THE CROSS-SLOPE OF ANY SIDEWALK, WALKWAY, OR OTHER PEDESTRIAN SURFACE SHALL NOT BE STEEPER THAN 1:48 (2%). ACCESSIBLE ROUTES SHALL COMPLY WITH CONNECTICUT BUILDING CODE. THE RUNNING SLOPE OF WALKING SURFACES SHALL NOT BE STEEPER THAN 1:48 (2%). DANDE SURFACE SHALL COMPLY WITH CONSECTION (200 STEEPER THAN 1:48 (2%)). 	1:20 (5%). THE 1. CONCRETE BLEACHER PADS 2. PORTABLE BLEACHERS	
 RAMPS SHALL COMPLY WITH CT BUILDING CODE, REF. 2012 IBC SECTION 1010 AND ICC/ANSI A117.1 2009 CHAPTER 4, SECTION 405. CONSTRUCTION JOINTS: REINFORCEMENT SHALL NOT CONTINUE THROUGH CONSTRUCTION JOINTS. PRIOR TO INITIATION OF CONCRETE FLATWORK, SUBMIT PROPOSED CONSTRUCTION JOINT PLAN TO THE ENGINEER FOR REVIEW AND APPROVAL. COOR PLAN WITH THE JOINT PATTERNS DEPICTED ON THE DRAWINGS. 	3. WIND SCREEN WITH LOGO	BSC GROUP 300 Winding Brook Drive
 UNLESS OTHERWISE SPECIFIED, MISCELLANEOUS CONCRETE PADS SHALL BE CONSTRUCTED PER SIDEWALK DETAIL. ALL NON-ACCESSIBLE PARKING SPACES ARE 9' X 18'. VERIFY OVERALL LAYOUT DIMENSIONS BASED ON THESE DIMENSIONS AND THE NUMBER OF SPACE FIELD-ADJUST OVERALL LAYOUT DIMENSION IN CONCERT WITH THE ENGINEER IF REQUIRED. DIMENSIONS INDICATED ARE TO FACE OF CURB, PAVEMENT EDGE, EDGE OR CENTERLINE OF IMPROVEMENT, OR AS OTHERWISE NOTED. 	ES INDICATED.	Glastonbury, Connecticut 06033 860 652 8227
 PROVIDE FOR THE LAYOUT AND STAKING/MARKING OF THE PROPOSED LOCATION OF ALL PROPOSED SITE IMPROVEMENTS, INCLUDING FURNISHII ENGINEER'S APPROVAL OF THE LAYOUT PRIOR TO PROCEEDING WITH THE WORK. UNLESS OTHERWISE INDICATED, LINES ARE PARALLEL OR PERPENDICULAR TO LINE FROM WHICH THEY ARE MEASURED. 	NGS. OBTAIN	© 2019 BSC GROUP, INC. SCALE: 1" = 20' 0 10 20 40 FEET
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		JOB. NO: 83759.00 L-Z.U



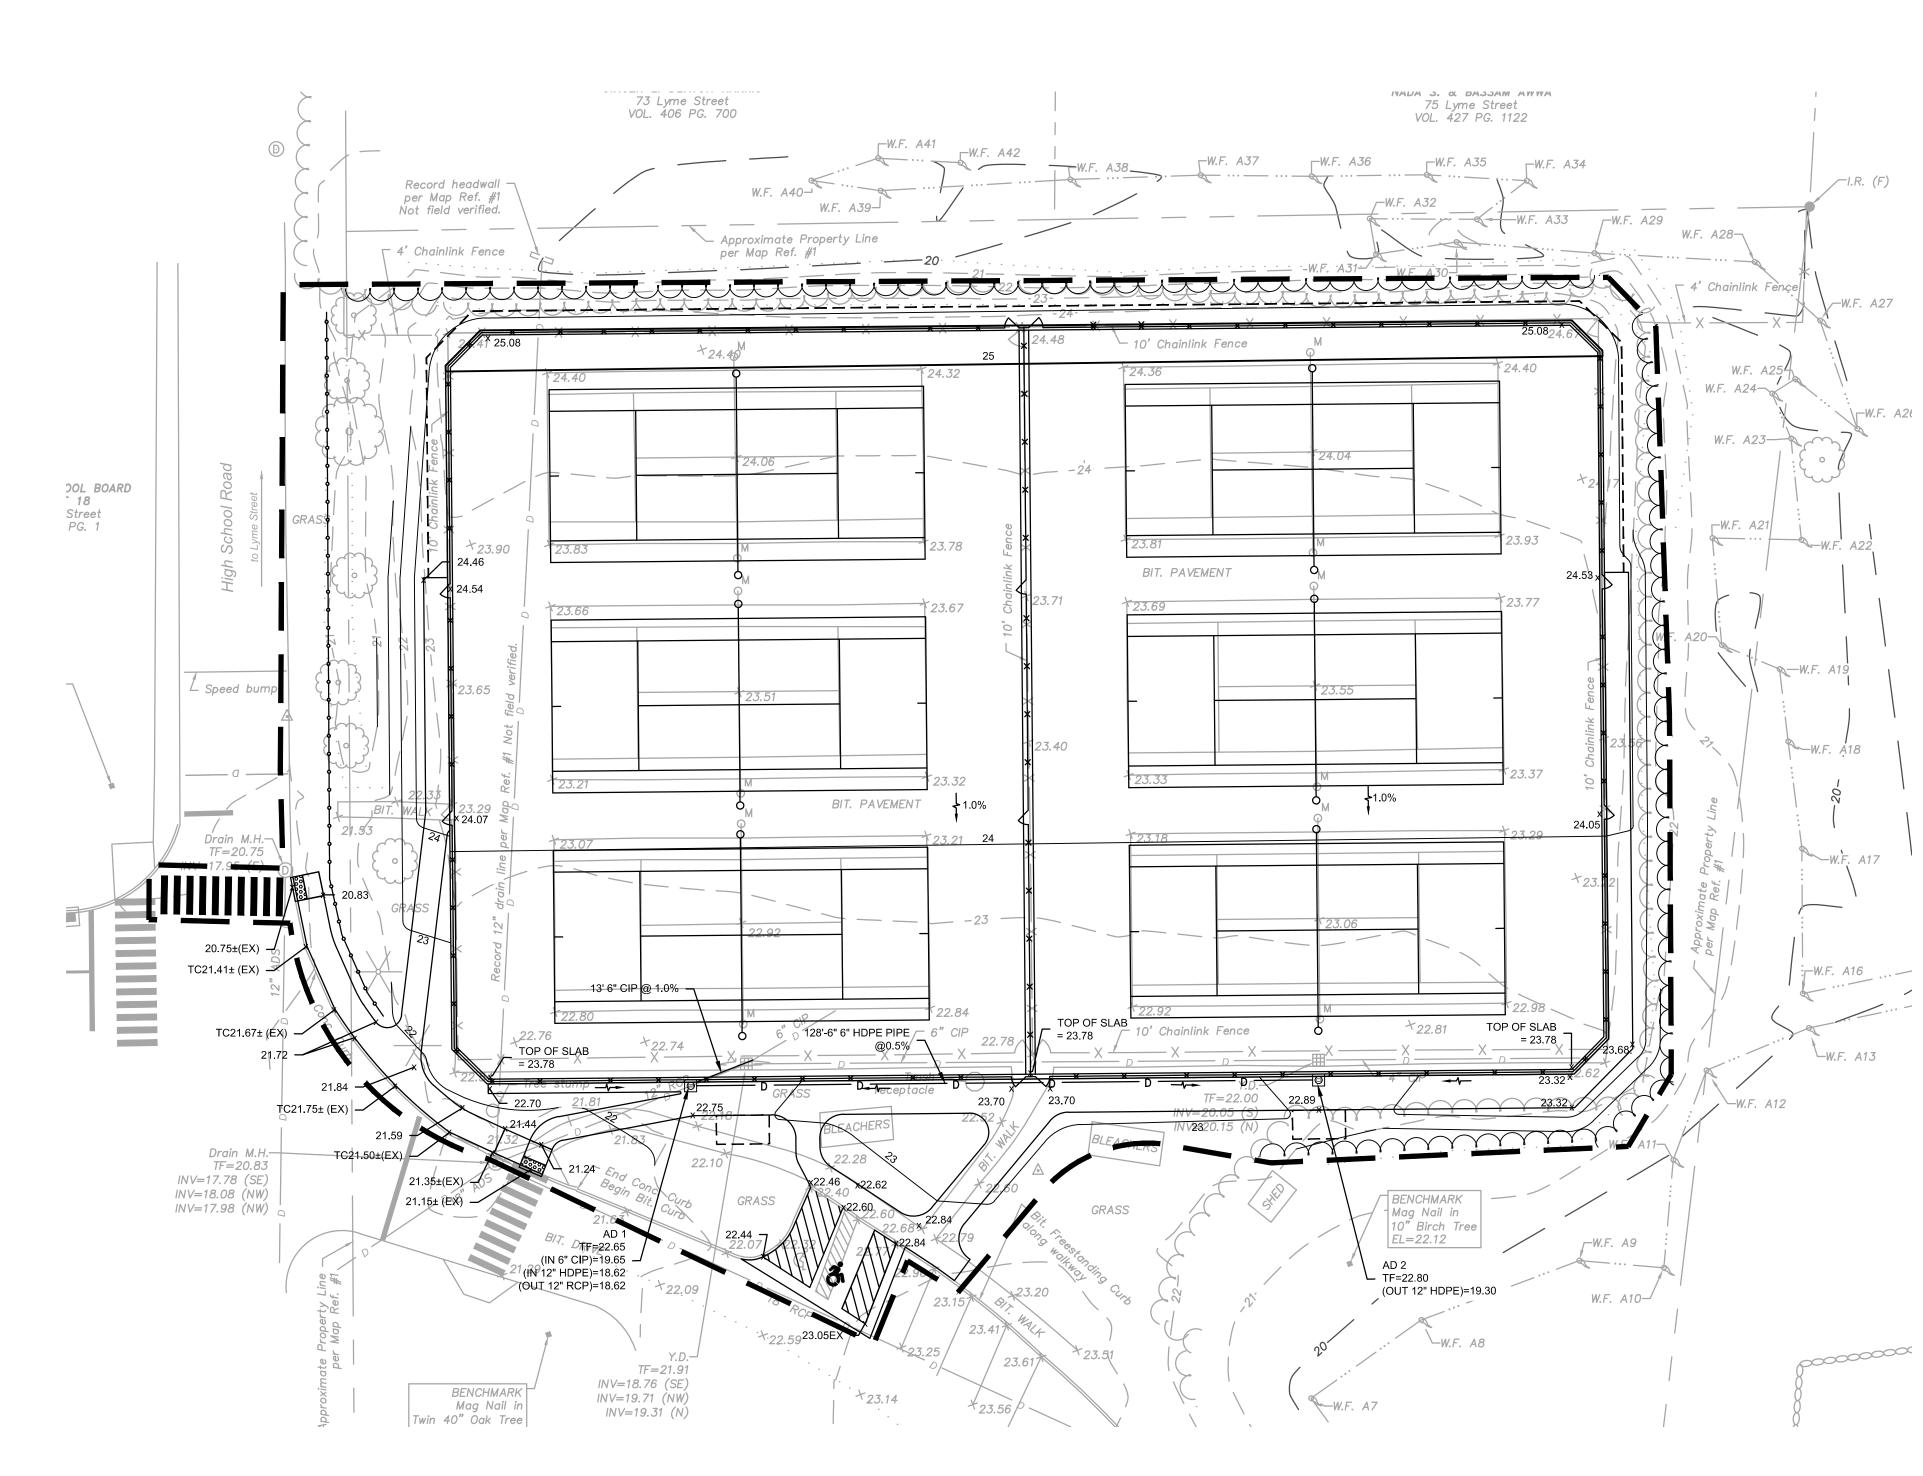

<u>LEGEND</u>

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_____ D _____ D _____

- PROPERTY LINE - LIMIT OF WORK

- WETLAND LIMIT - LIMIT OF CLEARING

- CHAIN LINK FENCE - WOOD GUIDE RAIL - TOPOGRAPHY: MAJOR INTERVAL - TOPOGRAPHY: MINOR INTERVAL - STORM DRAINAGE PIPE - AREA DRAIN (AD)

- DRAINAGE SLOPE DIRECTION


23.73 - SPOT GRADE


NOTES:

- 1. CONTRACTOR SHALL NOTIFY "CALL BEFORE YOU DIG" (1-800-922-4455) AND VERIFY UTILITY MARK-OUT WITH THE OWNER PRIOR TO THE INITIATION OF ANY SITE DISTURBANCE.
- 2. THE CONTRACTOR IS SOLELY RESPONSIBLE FOR VERIFICATION OF THE LOCATION AND NATURE OF ALL SUBSURFACE UTILITIES AT THE PROJECT WHICH MAY BE AFFECTED BY THE WORK. COORDINATE WITH RESPECTIVE UTILITY OWNERS AND PERFORM VERIFICATION OF TYPE, LOCATION AND INVERTS AS REQUIRED.
- BEFORE PROCEEDING WITH THAT PORTION OF THE WORK.
- 4. THE LOCATIONS OF EXISTING SITE FEATURES AS SHOWN HAVE BEEN OBTAINED FROM MAPS, SURVEYS, FIELD INSPECTIONS, AND OTHER AVAILABLE INFORMATION. THEY MUST BE CONSIDERED APPROXIMATE BOTH TO LOCATION, SIZE, AND AS-BUILT CONDITION AND ARE PROVIDED FOR INFORMATIONAL PURPOSES ONLY. THE CONTRACTOR IS SOLELY RESPONSIBLE FOR DETERMINING ACTUAL FIELD CONDITIONS.
- 5. THE DIMENSIONS SHOWN ON THE PLANS, INCLUDING THE INTENDED DIMENSIONS OF THE WORK, MAY VARY FROM ACTUAL EXISTING CONDITIONS IN THE FIELD. THE CONTRACTOR SHALL TAKE APPROPRIATE MEASUREMENTS TO VERIFY ALL DIMENSIONS SHOWN ON THE DRAWINGS AS WELL AS OTHER DIMENSIONS HE MAY DEEM APPROPRIATE TO FACILITATE THE COMPLETION OF THE WORK. DO NOT PROCEED WITH ANY ADJUSTMENT OR FIELD MODIFICATION UNTIL APPROVED BY THE ENGINEER. ENSURE COMPLIANCE WITH CONNECTICUT BUILDING CODE FOR ALL NEW CONSTRUCTION.
- 6. ENGAGE A CONNECTICUT-LICENSED LAND SURVEYOR TO PERFORM LAND-SURVEYING SERVICES REQUIRED, INCLUDING, BUT NOT LIMITED TO VERIFICATION AND LAYOUT OF PROPOSED IMPROVEMENTS, DIMENSIONS, AND ELEVATIONS. REPORT DISCREPANCIES TO THE ENGINEER.
- 7. UNLESS OTHERWISE INDICATED, ALL DISTURBED AREAS SHALL BE RESTORED WITH SIX (6) INCHES OF LOAM, SEEDED, FERTILIZED, AND MULCHED.
- 8. PROPOSED GRADES INDICATE DESIGN INTENT. VERIFY ELEVATIONS AND MAKE ADJUSTMENTS TO MEET FIELD CONDITIONS. DO NOT PROCEED WITH ANY ADJUSTMENT OR FIELD MODIFICATION UNTIL APPROVED BY THE ENGINEER.
- 3. THE CONTRACTOR SHALL NOTIFY THE ENGINEER OF ANY AND ALL DISCREPANCIES BETWEEN EXISTING CONDITIONS AND THE CONTRACT DOCUMENTS
- PROVIDE ADDITIONAL EROSION CONTROLS AS REQUIRED. BLEND RESTORED AREAS INTO ADJACENT UNDISTURBED AREAS.

- 9. VERIFY ALL GRADES AND SLOPES PRIOR TO CONCRETE PLACEMENT. REPORT DISCREPANCIES TO THE ENGINEER BEFORE PROCEEDING WITH THE
- 10. COMPLY WITH CONNECTICUT BUILDING CODE FOR ALL SITE CONSTRUCTION, INCLUDING HANDICAPPED ACCESSIBILITY. 11. THE CROSS-SLOPE OF ANY SIDEWALK, WALKWAY, OR OTHER PEDESTRIAN SURFACE SHALL NOT BE STEEPER THAN 1:48 (2%).
- 12. ACCESSIBLE ROUTES SHALL COMPLY WITH CONNECTICUT BUILDING CODE. THE RUNNING SLOPE OF WALKING SURFACES SHALL NOT BE STEEPER 1:20 (5%). THE CROSS SLOPE OF A WALKING SURFACE SHALL NOT BE STEEPER THAN 1:48 (2%). GRADING CONTOURS AND SPOT GRADES INDICATE I INTENT. CONFIRM THE GRADE AND SLOPE OF NEW WORK BASED ON ACTUAL FIELD CONDITIONS BEFORE PROCEEDING WITH INSTALLATION. BRING A DISCREPANCIES TO THE ATTENTION OF THE ENGINEER BEFORE PROCEEDING.
- 13. RAMPS SHALL COMPLY WITH CT BUILDING CODE, REF. 2012 IBC SECTION 1010 AND ICC/ANSI A117.1 2009 CHAPTER 4, SECTION 405 AND 406. GRADING CONTOURS AND SPOT GRADES INDICATE DESIGN INTENT. CONFIRM THE GRADE AND SLOPE OF NEW WORK BASED ON ACTUAL FIELD CONDITIONS BI PROCEEDING WITH INSTALLATION. BRING ALL DISCREPANCIES TO THE ATTENTION OF THE ENGINEER BEFORE PROCEEDING.
- 14. DETECTABLE WARNINGS SHALL BE A MINIMUM OF 24-INCHES IN DEPTH. AT CURB RAMPS, DETECTABLE WARNING SHALL EXTEND THE FULL WIDTH OF RAMP AND BE INSTALLED 6-INCHES FROM THE CURB LINE AT THE RAMP BASE.
- 15. GRADE TRANSITION BETWEEN TOPOGRAPHIC LINES AND SPOT GRADES SHALL BE UNIFORM UNLESS OTHERWISE INDICATED.
- 16. UNLESS OTHERWISE INDICATED, BLEND TRANSITIONS IN ELEVATION BETWEEN NEW WORK AND AREAS TO REMAIN AT A MAXIMUM SLOPE OF 1V:2H A RESTORE WITH SIX (6) INCHES OF LOAM AND SEED. PROVIDE ADDITIONAL EROSION CONTROLS AS REQUIRED. COORDINATE WITH ENGINEER IF DIMENSIONAL CONSTRAINTS REQUIRE STEEPER SLOPES.
- 17. THE TOPS, RIMS, FRAMES, GRATES, AND COVERS (AS APPLICABLE) OF ALL UTILITY STRUCTURES THAT ARE TO REMAIN SHALL BE ADJUSTED TO MAT FINAL GRADE IN A FLUSH CONDITION. ALL NEW UTILITY STRUCTURES SHALL BE INSTALLED WITH TOPS, RIMS, FRAMES, GRATES, AND COVERS (AS APPLICABLE) TO FINAL GRADE IN A FLUSH CONDITION.
- 18. AT THE CONCLUSION OF THE WORK, CONTRACTOR SHALL REMOVE ALL ACCUMULATED SEDIMENT MATERIAL FROM ALL PORTIONS OF THE STORM DRAINAGE SYSTEM. INCLUDING NEW WORK AND EXISTING WORK THAT REMAINS OR IS INCORPORATED INTO THE NEW SYSTEM.

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		GRA	DING AND PLA JANUARY 3	
			NS:	
		REG	PREPAREI GIONAL SCHOOL I 49 LYME ST	DISTRICT NO.18
WORK. THAN DESIGN ALL G BEFORE		300 W	OLD LYME, C BSC (Vinding Brook Di onbury, Connect	t 06371 GROUP rive
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A. ALUMINUM TIE
R HOG RINGS AT
VIN. 5 PER 8'

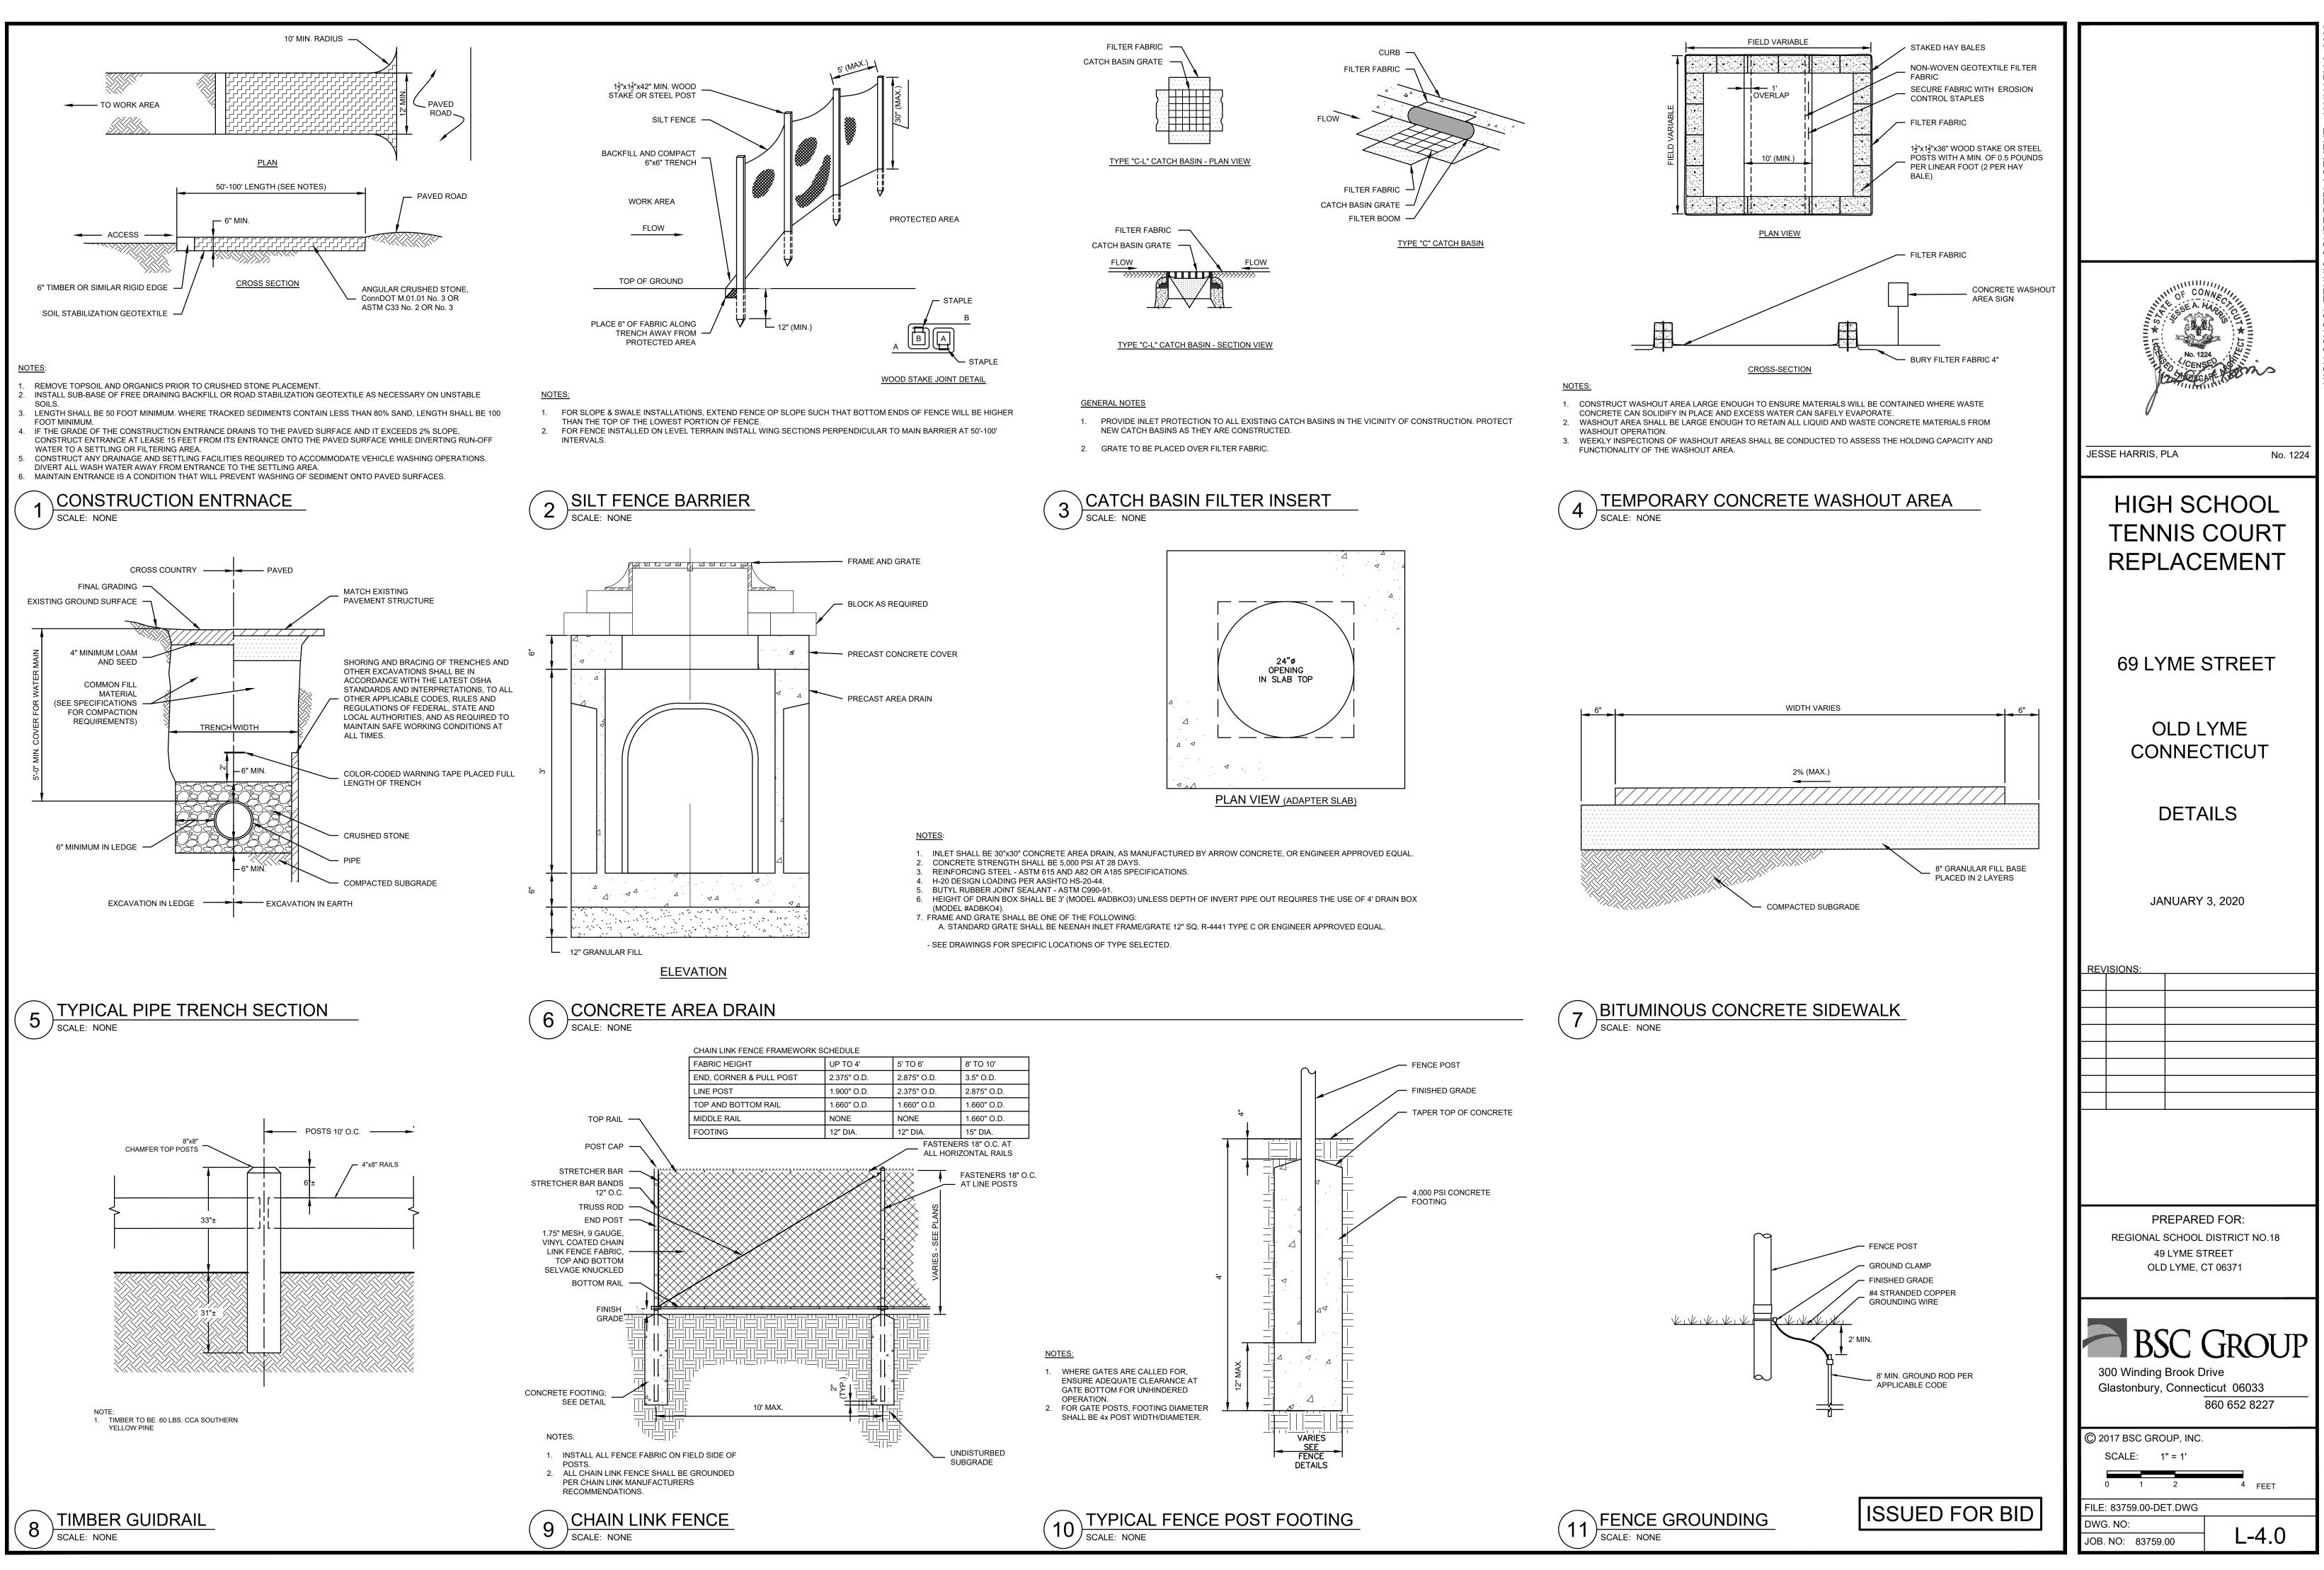- NO. 9 GA. ALUMINUM TIE WIRES OR HOG RINGS AT

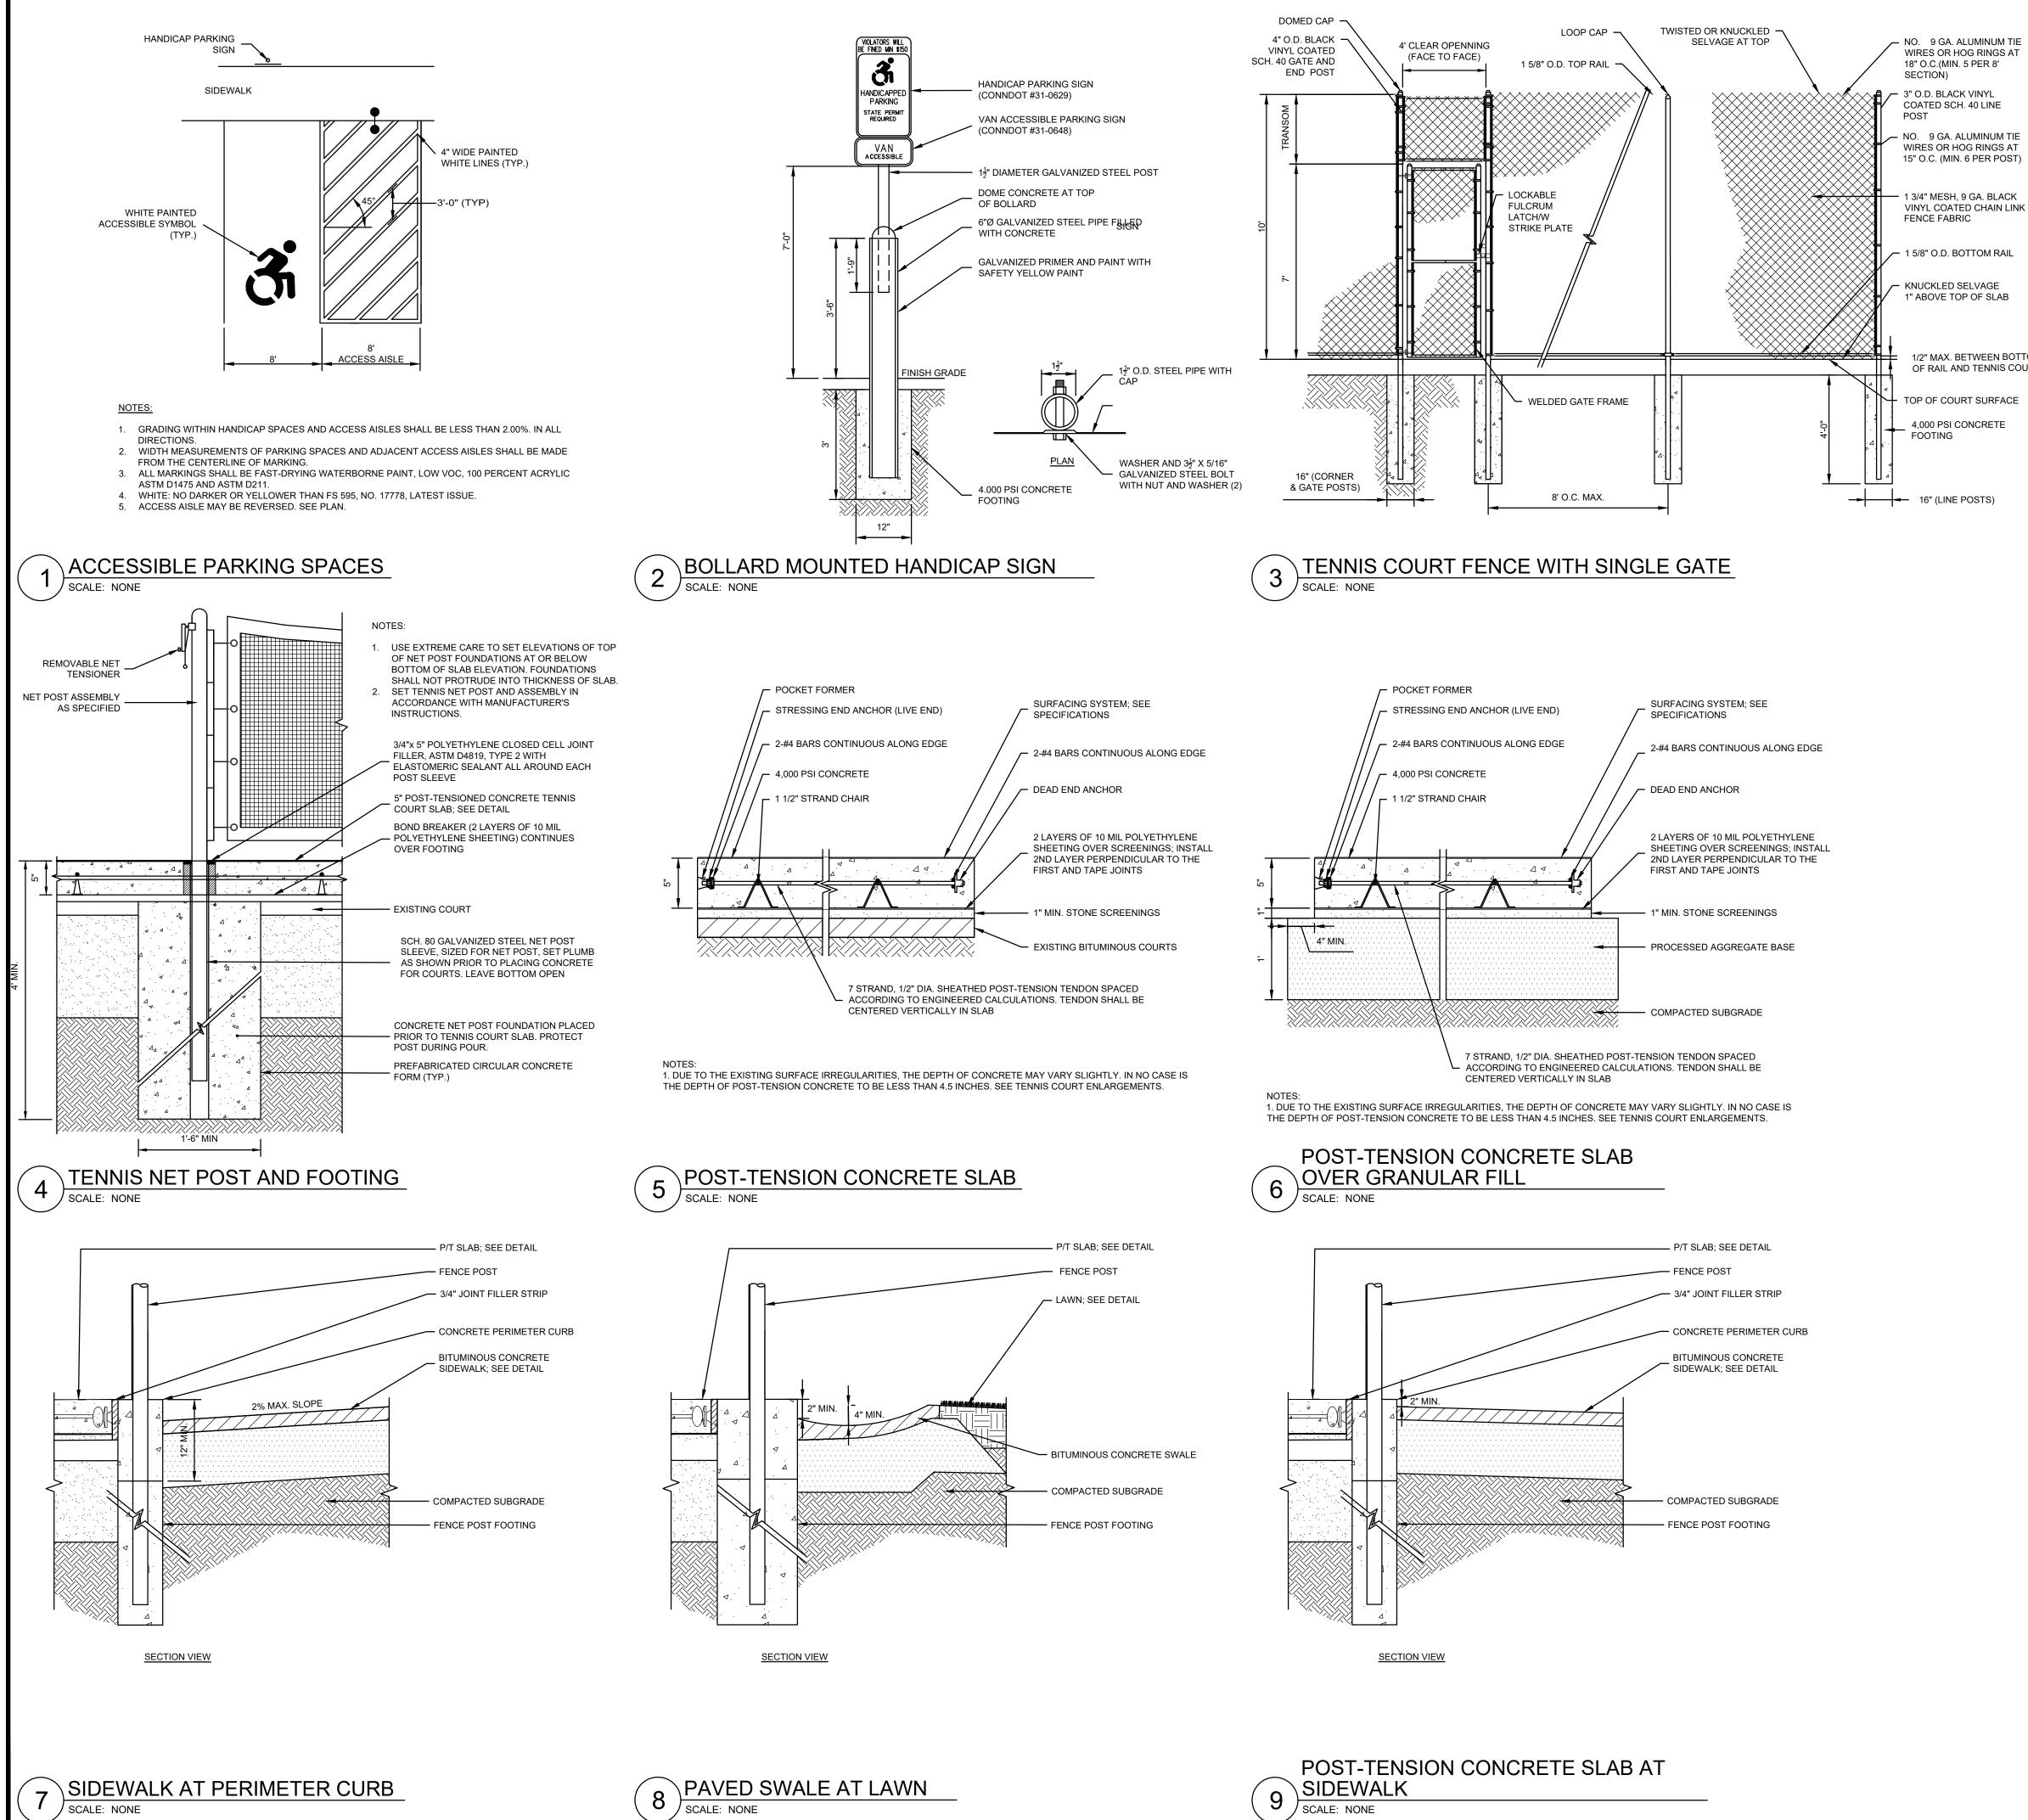— 1 3/4" MESH, 9 GA. BLACK


1/2" MAX. BETWEEN BOTTOM OF RAIL AND TENNIS COURT

- TOP OF COURT SURFACE

4,000 PSI CONCRETE

OF CONNECCIONING			
No. 1224			
TO NO. 1224 CENSED CONCERSED CONCERSED CONCERE			
JESSE HARRIS, PLA No. 1224			
HIGH SCHOOL			
TENNIS COURT			
REPLACEMENT			
69 LYME STREET			
OLD LYME			
CONNECTICUT			
DETAILS			
JANUARY 3, 2020			
REVISIONS:			
PREPARED FOR: REGIONAL SCHOOL DISTRICT NO.18			
49 LYME STREET OLD LYME, CT 06371			
BSC GROUP			
300 Winding Brook Drive Glastonbury, Connecticut 06033			
300 Winding Brook Drive Glastonbury, Connecticut 06033 860 652 8227			
300 Winding Brook Drive Glastonbury, Connecticut 06033			
300 Winding Brook Drive Glastonbury, Connecticut 06033 860 652 8227 © 2017 BSC GROUP, INC.			
300 Winding Brook Drive Glastonbury, Connecticut 06033 860 652 8227 © 2017 BSC GROUP, INC. SCALE: 1" = 1'			



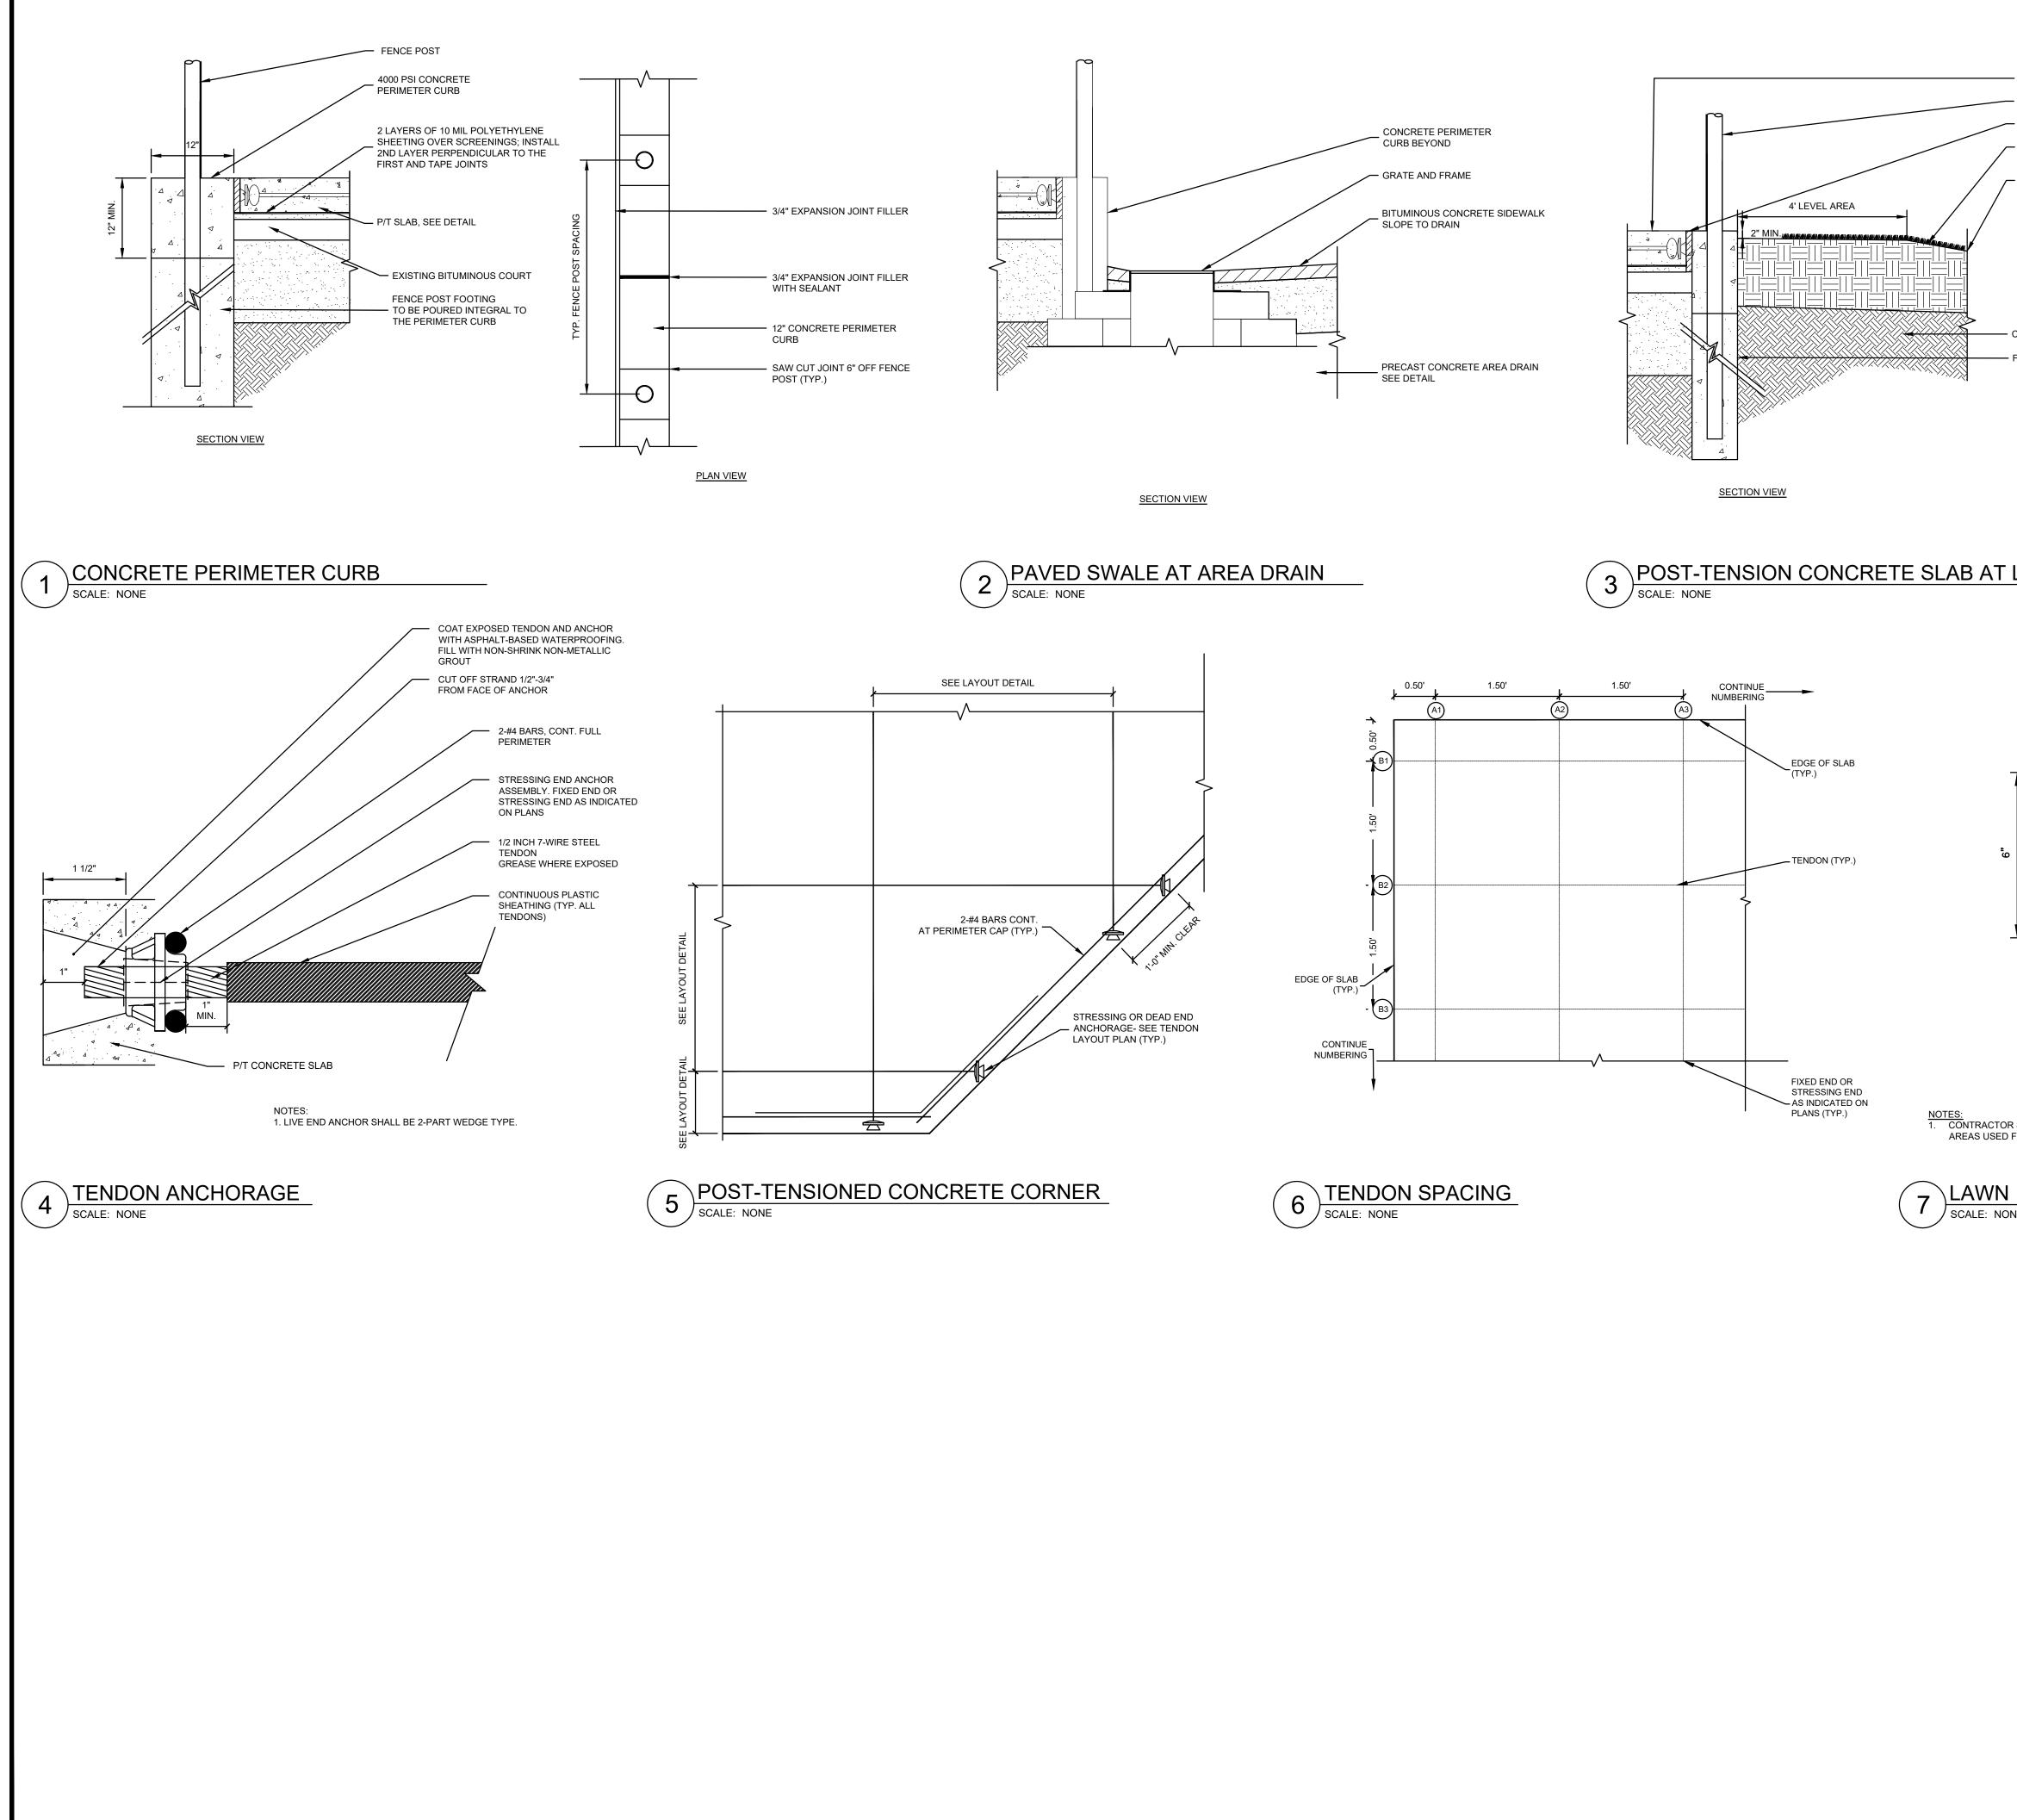

P/T SLAB; SEE DETAIL FENCE POST 3/4" JOINT FILLER STRIP		
LAWN; SEE DETAIL PROVIDE SMOOTH TRANSITION BETWEEN NEW AND EXISTING GRADES		
COMPACTED SUBGRADE FENCE POST FOOTING		No. 1224 No. 1224 No. 1224
<u>AT LAWN</u>		JESSE HARRIS, PLA No. 1224 HIGH SCHOOL TENNIS COURT REPLACEMENT
	SEEDED LAWN TOPSOIL	69 LYME STREET OLD LYME CONNECTICUT DETAILS
CTOR SHALL PREPARE SOILS IN ALL DISTURBED AREAS AND ISED FOR EQUIPMENT ACCESS.	PREPARED SUBGRADE	JANUARY 3, 2020
<u>VN</u> NONE		
		PREPARED FOR: REGIONAL SCHOOL DISTRICT NO.18 49 LYME STREET OLD LYME, CT 06371
		BSC GROUP, INC.
[ISSUED FOR BID	0 1 2 4 FEET FILE: 83759.00-DET.DWG DWG. NO: L-4.2