

BRIDGE NO.01218

52980 - NEWTOWN
INTERSTATE 84 EASTBOUND
over
HOUSATONIC RIVER

Underwater Inspection 7/18/2018

Inspected by: Infrastructure



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Report Title Page

Project No.:

170-3339 (Underwater Inspections – NHS)

Structure:

01218, Interstate 84 Eastbound over Housatonic River, Newtown

Inspected By:

Infrastructure Engineers, Inc. <u>Inspection Date:</u> 7/18/2018

Professional Certification:

I hereby certify that this report, including all of its contents, has been approved by me, and that I am a duly licensed professional engineer under the laws of the State of Connecticut.



Jeffrey Rowe, PE (Infrastructure Engineers, Inc.)

PM / QAQC: Jeffrey Rowe, PE

CT License No.: 27367

Date: 8/10/2018

Form: Location

Inspection type: Underwater **Inspection Date:** 7/18/2018


Inspected by: Infrastructure Engineers

Town: NEWTOWN Bridge No: 01218

Carried: INTERSTATE 84 EASTBOUND

Crossed: HOUSATONIC RIVER

Inventory Route: NHS

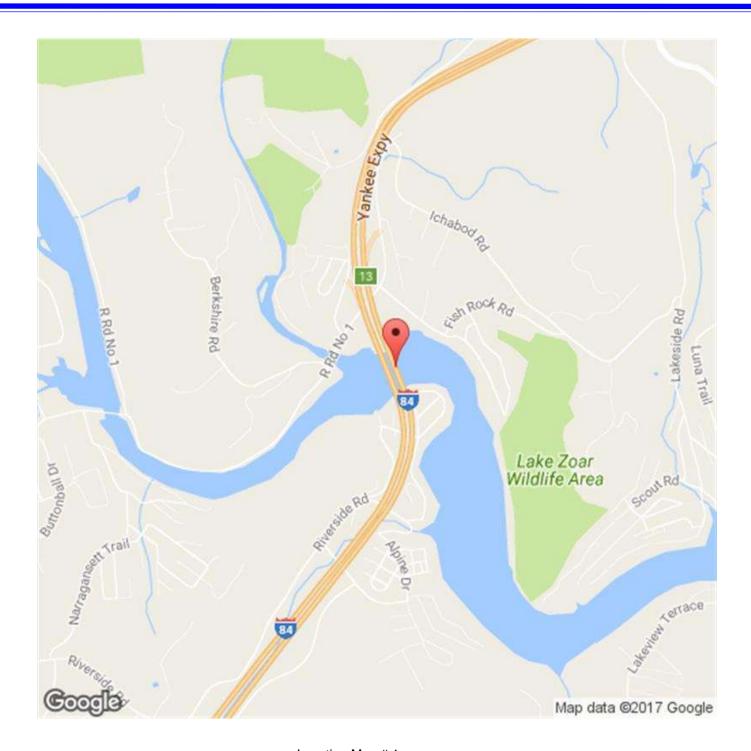

Location Map # 1 Bridge No. 01218 Interstate 84 Eastbound over Housatonic River Newtown, CT

Form: BRI-19, Rev. 2/15

Inspection type: Underwater **Inspection Date:** 7/18/2018

Inspected by: Infrastructure Engineers

Town: NEWTOWN Bridge No: 01218 Carried: INTERST.

Carried: INTERSTATE 84 EASTBOUND **Crossed:** HOUSATONIC RIVER

Inventory Route: NHS

STRUCTURE INVENTORY & APPRAISAL

INSPECTION	STRUCTURE TYPE & MATERIALS
Structurally Deficient Y Functionally Obsolete N	(43) Structure Type, Main
Sufficiency Rating 62.0	A) Material 4 - Steel continuous
(90) Inspection Date (91) Frequency 24	B) Design Type 03 - Girder and Floorbeam System
Indepth Insp No Proposed next Indepth Year	(44) Structure Type, Approach
Deck Survey Date Class 03	A) Material 0 - Other
Access 11 - Less than 40 Flagman 0	B) Design Type 00 - Other
Frequency Date Type	(45) Number of Spans, Main Unit 4
Fracture 24 D Two Girder System, riveted / bolted plate girders	(46) Number of Approach Spans 0
Underwater 24 07/18/2018 B Underwater Only	(107) Deck Structure Type 1 - Concrete Cast-in-Place
Special	(108) Wearing Surface/Protection Systems
IDENTIFICATION	A) Type of Wearing Surface 6 - Bituminous
Bridge Name ROCHAMBEAU BRIDGE	
Town Code - Name 52980 - NEWTOWN	B) Type of Membrane 2 - Preformed Fabric
(5) Inventory Route	C) Type of Deck Protection 0 - None
(A) Record Type 1: Route carried "on" the structure	Substructure
(B) Signing Prefix 1 - INTERSTATE HIGHWAY	A) Material 2 - CONCRETE
(C) Level of Service 1 - MAINLINE	B) Design Type 1 - FULL HEIGHT STEM
(D) Route Number. 00084	Paint
(E) Dir Suffix 2 - EAST	Type 2 - Overcoated Lead Paint
(6A) Featured Intersected HOUSATONIC RIVER	Year 1978
(6B) Critical Facility Indicator	Comment
(7) Facility Carried INTERSTATE 84 EASTBOUND	———— GEOMETRIC DATA ————
(9) Location OVER HOUSATONIC RIVER	(48) Length of Maximum Span 224 ft.
(11) Mile Post 18.42 Miles	(49) Structure Length 792 ft.
(16) Latitude 41 Deg. 26 Min. 21 Sec.	(50) Curb or Sidewalk Widths
(17) Longitude -73 Deg. 14 Min. 51 Sec.	A) Left 0 ft. 0 in. B) Right 5 ft. 0 in.
(98) Border Bridge	(51) Bridge Roadway Width Curb to Curb 60 ft. 0 in.
(A) State Code (B) Percent Responsibility %	(52) Deck Width, Out to Out 70 ft. 1 in.
(C) Border Town Name	(32) Approach Roadway Width 60 ft.
(99) Border Bridge Structure No.	, ,

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Crossed: HOUSATONIC RIVER

(33) Bridge Median	0 - No median			А	GE AND SERV	ICE	
Deck Area	55519 sq. ft.		Year Built	1953	(106) Year Red	constructed	1978
(34) Skew Angle	0 deg.		(42) Type of S	Service			
(35) Structure Flared	0 - No flare		A) On	5 - Highwa	ay-pedestrian		
(10) Inv. Rte. Min. Vert. Clea		in.	B) Under	5 - Waterw	vay		
(47) Inv. Rte. Total Horiz. C		in.	(28) Number of	of Lanes			
Log Inv. Rte. Total Hori		in.	A) On	02	B) Under	00	
RLog Inv. Rte. Total Ho		 ☐in.	(29) Average	Daily Traffic	34350		
(53) Min. Vert. Clearence O		in.	Is Above H	lalf ADT?	Yes		
(54) Log-Min. Vert. Undercle		ft. 0 in.	(109) Prec	ent Truck	9	%	
(55) Min. Lat Underclearance		ft. 0 in.	(30) Years	of ADT	2015		
(56) Min. Lat Underclearance			(19) Bypass, I	Detour Lengt	th 1	Miles	
	CONDITION ———				APPRAISALS		
(58) Deck	4		(67) Structural	Evaluation	4		
(59) Superstructure	4		(68) Deck Geo	ometry	9		
(60) Substructure	6		(69) Underclea	arances, Ver	t. & Horiz.		
(61) Channel & Channel Pro	otections 5		(71) Waterway	/ Adequacy	9		
(62) Culverts	N		(72) Approach	Roadway A	lignment 8		
(36) Traffic Safety Features			(113) Scour C	ritical	8		
A) Bridge Railing	s 0				<u>COMMENTS</u>		
B) Transitions	0		Rpt. dated 7/ New Section 28, 2010 rep	/12/10. ŔKI Loss inforr ort. This inf	nanged from 5 to D, 8/5/10. nation was subn ormation was fo aluation. Ralph	mitted by Bak rwarded to L	ker in July oad
C) Approach Gua	ardrail 1						
D) Approach Gua	ardrail Ends 1						
	WATERWAY —			CI	LASSIFICATIO	N ——	
Drainage Basin Waterway	6000 - Housatonic R	River	(112) NBIS Brid	dge Length	Yes		
(38) Navigation Control	0 - No navigation co on waterway (bridge not required)		(104) Highway	System	1 - Structure/Ro	ute is on NHS	3
(39) Navigation Vertical Cle	arance 0 ft.		(26) Functional	Class	01 - Rural - Prin	cipal Arterial -	Interstate
(40) Navigation Horiz. Clr.	O ft.		(100) Defense	Highway	1 - Is on an Inte	rstate STRAH	NET route
(111) Pier/Abutment Naviga	ation 2 - In place and fund	ctioning	(101) Parallel S	Structure	R - Right structu	ure (North or E	ast)
(116) Vert-Lift Brg Nav Min	0 ft. 0	In.	(102) Direction	of Traffic	1 - 1-way traffic		

Form: BRI-19, Rev. 2/15 **Inspection type:** Underwater **Inspection Date:** 7/18/2018

Inspected by: Infrastructure Engineers

Town: NEWTOWN Bridge No: 01218

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Crossed: HOUSATONIC RIVER

(103) Temporary Stru	cture			PROPOSEI	D IMPRO	VEMENTS —
(110) Designated Nat Network	ional 1 - Inven Network	ntory route on National T	ruck	(75A) Type of Work Proposed		35 - Rehabilitation - Deterioration
(20) Toll	3 - On F	ree Road		(75B) Work Done By		1 - Work to be done by
(21) Maintain	01 - Stat	te Highway Agency		(76) Length of Structure Improv	rement	ft.
(22) Owner	01 - Stat	te Highway Agency		(94) Bridge Improvement Cost	\$	
Report Class	S - STAT	TE		(95) Roadway Improvement Co	st \$	
(37) Historical Signific	cance 5 - Not e	eligible for National Regis	ster	(96) Total Project Cost	\$	30000
	- POSTED S	SIGNS —		(97) Year of Improvement Estim	nate	2014
Other Posted Sign 1				(114) Future ADT		51041
Other Posted Sign 2				(115) Year of Future ADT		2035
	,	Actual Recomende	ed	DOT Bridge Program List No		27
Posted Load Single U	Jnit Truck		tons	Project No		0096-0201
Posted Load Semi-Tr	ailer Truck		tons	Advertised Date		09/18/2019
Posted Load 4 Axle T	ruck		tons	——— LOAD RA	ATING & I	POSTING ———
Posted Load 3S2 Tru	ck [tons	(31) Design Load	5 - HS 2	0
All Vehicles			tons	(63) Operating Rating Type	1 - Load	Factor (LF)
Posted Vert. Clearand	ce on Bridge [ft. in.		(64) Operating Rating	62.3	
Posted Vert. Undercle	earance [ft. in.		(65) Inventory Rating Type	1 - Load	Factor (LF)
Posted Speed Limit of	on Bridge [m.p.h.		(66) Inventory Rating	37.4	
	OTHER FEA	TURES ———		Evaluation Code	L - Load	Factor
Fence Required	No			Year of Evaluation	2011	
Fence Present	Yes			(70) Bridge Posting	5 - Equa	I to or above legal loads
Fence Type	1			(41) Structure Status	A - Oper	ı
Fence Height	7.3					
Fence Material	1					
Fence Top Type	1					
Barrel Ladders	No					
Stand Pipes	No					
Catwalks	Yes					
Moveable Inspection	System	No				
Haunches Present ov	er Roadway	NO				
Utilities	N No Utilities p	present				

Form: BRI-19, Rev. 2/15 Inspection type: Underwater Inspection Date: 7/18/2018

Inspected by: Infrastructure Engineers

Town: NEWTOWN

Carried: INTERSTATE 84 EASTBOUND

Crossed: HOUSATONIC RIVER

Inventory Route: NHS

INSPECTOR'S SIGNATURES:

1)	9-7-11	Date: 08/14/2018	P.E. SIGNATURE:	Jeffy B. Rowe	Date:	08/17/2018
2)	Malister	Date: 08/16/2018	P.E. # Reviewed By:	27367	_ _ Date:	09/04/2018
3)		L Date:	-	Amy Estaba	_	
4)		Date:				

Bridge No: 01218

UNDERWATER INSPECTION (BRI-59)



Bridge: 01218 Town: 52980 - NEWTOWN Carried: INTERSTATE 84 EASTBOUND Crossed: HOUSATONIC RIVER

Total Number of Piers: 3

Piers in the Water: 3

Boat Used? Yes

Boat Size: 26'

Dive Station Used? Yes

Access to Bridge: Boat

Access/ Equipment Comments U/W:

Underwater Inspections performed in conjunction with Bridge No. 04180.

Boat ramp located at the end of Scout Road in Southbury.

Type of water: Fresh

Marine Growth: Minor aquatic growth

Max Water Depth: 27.2'

Max Water Depth at Pier Or

Abutment:

27.2

Current Strength: 1 fps

U/W Visibility: 8

Bottom Composition: Cobbles, river rock, and sand with up to 2.5' penetration into the channel bottom.

Form: BRI-58.

Inspection type: Underwater **Inspection Date:** 7/18/2018

Inspected by: Infrastructure Engineers

Town: NEWTOWN Bridge No: 01218

Carried: INTERSTATE 84 EASTBOUND

Crossed: HOUSATONIC RIVER

Inventory Route: NHS

UNDERWATER INSPECTION

ITEM	RATING	REMARKS
60. SUBSTRUCTURE	6	
ABUTMENT 1:	N	South Abutment. Located out of the channel.
STEM	N	
FOOTING	N	
EROSION	N	
SETTLEMENT	N	
SCOUR	N	
WINGWALLS	N	
General Remarks:		
ABUTMENT 2:	N	North Abutment. Located out of the channel.
		(See Photo 3)
STEM	N	
FOOTING	N	
EROSION	N	
SETTLEMENT	N	
SCOUR	N	
WINGWALLS	N	
General Remarks:		
PIER NO. 1	6	
PILES	N	There is no exposure of the steel H-piles.
STEM	7	The reinforced concrete pier has the following deficiencies:
STEW	,	 5' high band of abrasion up to 1/4" deep extending from 1' above to 4' below the water surface. There are steel H-piles intermittently extending out of the stem located above the step footing (formwork left in place from construction). Random areas of zebra mussels up to 50% coverage x 1" thick on underwater substructure.
FOOTING	7	(See UW Drawings 5 & 6 and Photos 4 & 5) The step footing and footing have the following deficiencies:
		 Step footing exposed up to 32' long x up to full-height (5.9' high) along both faces of the pier. Footing exposed up to 6.8' vertically (previously 5' high) over a length of 30' on the South face and 8' on the North face near the Upstream (West) end of the pier with no undermining. Exposed surfaces of the step footing and footing have abrasion up to 1/8" deep.
		(See UW Drawings 5 & 6 and Photos 6 & 7)

09/04/2018 Page 1 of 3 Form: BRI-58.

Inspection type: Underwater Inspection Date: 7/18/2018

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Inventory Route: NHS

SCOUR	5	 The channel bottom along Pier 1 primarily at the Upstream (West) nose and North face has had scour up to 4.1' high since the 2016 Underwater Inspection. Step footing exposed up to 32' long x up to full-height (5.9' high) along both faces of the pier. Footing exposed up to 6.8' vertically (previously 5' high) over a length of 30' on the south face and 8' on the north face near the Upstream (West) end of the pier with no undermining.
		(See UW Drawings 5 & 6 and Photos 6 & 7)
SETTLEMENT	8	No apparent settlement observed.
General Remarks:		
PIER NO. 2	6	
PILES	N	There is no exposure of the steel H-piles.
STEM	7	The reinforced concrete pier has the following defiencies:
		 5' high band of abrasion up to 1/4" deep with isolated areas up to 3/4" deep extending from 1' above to 4' below the water surface. Random areas of zebra mussels up to 50% coverage x 1" thick on underwater substructure.
		(See UW Drawings 7 & 8 and Photos 8 & 9)
FOOTING	7	 The step footing is exposed up to 26' long x 2.1' high (previously 2' high) on the South face of the pier and along the Upstream (West) Nose. Exposed surfaces of the step footings footing exhibit scaling up to 1/8" deep. Step footing has random chamfer spalls up to 6" long x 3" wide x 1" deep.
		(See UW Drawings 7 & 8 and Photo 10)
SCOUR	5	 The channel bottom along Pier 2 North face has had scour up to 5.6' high since the 2016 Underwater Inspection. The step footing is exposed up to 26' long x 2.1' high (previously 2' high) on the South face of the pier and along the Upstream (West) Nose The Southwest corner has exposed sheet piling 3' long x 1.2' high.
		(See UW Drawings 7 & 8 and Photo 10)
SETTLEMENT	8	No apparent settlement observed.
General Remarks:		
PIER NO. 3	6	
PILES	N	There is no exposure of the steel H-piles.
STEM	7	The reinforced concrete pier has the following deficiencies:
		 Band of abrasion up to 1/2" deep extending from 1' above the water surface down to the channel bottom. There are a few vertical hairline cracks up to 1.5' long near the water surface of the pier.
		(See UW Drawings 9 & 10 and Photos 11 & 12)
FOOTING	N	There is no exposure of the step footing or footing at the pier.
SCOUR	7	 The channel bottom along Pier 3 has remained relatively unchanged (less than 1.1' variations) as compared to the 2016 Underwater Inspection.
		(See UW Drawings 9 & 10)
SETTLEMENT	8	No apparent settlement observed.
General Remarks:		

09/04/2018 Page 2 of 3 Form: BRI-58.

Inspection type: Underwater Inspection Date: 7/18/2018

Inspected by: Infrastructure Engineers

Town: NEWTOWN

Carried: INTERSTATE 84 EASTBOUND

Crossed: HOUSATONIC RIVER

Inventory Route: NHS


61. CHANNEL & CHANNEL PROTECTION:

5 The Housatonic River is a fresh body of water that flows from West to East beneath the structure. **CHANNEL SCOUR** 5 • The channel bottom along Pier 1 primarily at the nose and North face has had scour up to 4.1' high since the 2016 Underwater Inspection. • The channel bottom along Pier 2 North face has had scour up to 5.6' high since the 2016 Underwater Inspection. • The channel bottom along Pier 3 has remained relatively unchanged (less than 1.1' variations) since the 2016 Underwater Inspection. • The channel bottom along the up and downstream fascias have had random areas of mostly aggradation up to 6.5' high since the 2016 Underwater Inspection. • At Pier 1, the step footing is exposed up to 32' long x up to full-height (5.9' high) along both faces of the pier and the footing has been exposed up to 6.8' high (previously 5.0' high) over a length of 30' on the South face and 8' on the North face near the Upstream (West) end of the pier. • At Pier 2, the step footing is exposed up to 26' long x 2.1' high (previously 2.0' high) on the South face of the pier and along the Upstream (West) nose. • There is no exposure of the footings at Pier 3. (See UW Drawings 1 - 10) **EMBANKMENT EROSION** 7 There is no significant erosion along the channel embankments. (See Photos 15 - 18) **DEBRIS** 6 • There are three 30' long x 1' diameter fallen trees in the channel South of Pier 3. • There is a 30' long x 12" high x 2' diameter area of timber debris on the Upstream (West) nose of Pier 1. (See UW Drawings 1 - 10) **VEGETATION** 7 The channel embankments are well vegetated. **CHANNEL CHANGE** 6 • There is no apparent change to the channel orientation. • Bridge No. 04180 is located approximately 40' Upstream (West) of the bridge. • There is approximately a 150' long x 20' wide x 3' high sandbar/area of aggradation located northwest of Pier 3 near Bridge No. 04180. (See UW Drawings 1 - 3 and Photos 13 - 14) FENDER SYSTEM N SPUR DIKES & JETTIES Ν RIP RAP General Remarks: There are navigational lights on Pier 1, center of Span 2 and Pier 2 on the Downstream (East) Fascia. The lights were not on during this inspection.

Bridge No: 01218

(Photos 19 - 21)

09/04/2018 Page 3 of 3

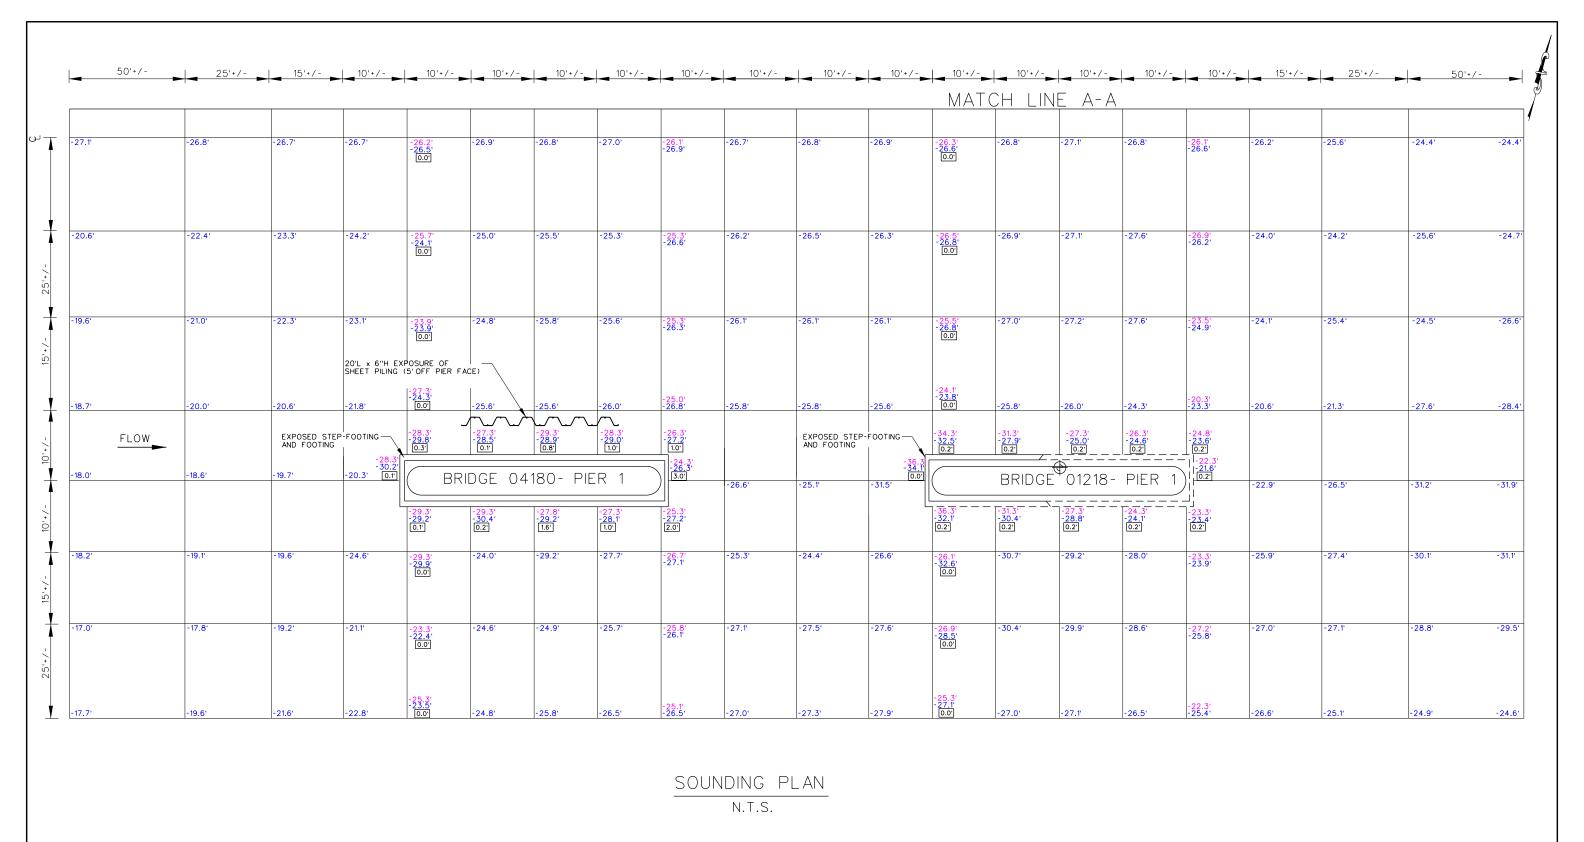

LEGEND FOR BOTTOM ELEVATIONS

JULY. 2018: -0.0' JULY. 2016: -0.0'

LEGEND FOR SYMBOLS

DATUM ELEV. 0.0' TAKEN FROM THE EASTBOUND BRIDGE 01218 AT THE SECOND CONSTRUCTION JOINT DOWN FROM THE TOP OF THE PIER AT THE CENTERLINE OF THE NORTH FACE OF PIER 1



O.O DEPTH OF PENETRATION



CONNECTICU	T DEP	ARTMENT C	F TRANSPOR	TATION	
ROUTF		IDGE NO. 012	218 OUSATONIC RIVER		WU
NEWTOWN				NNECTICUT	무
	SOL	JNDING P	LAN		DRAWING
INSPECTED BY: JK, MB, JW	SCALE: AS SHOWN	DATE OF INSPECTION	DRAWING NO. 01218	Α	

25'+/- 15'+/- 10' MATCH LINE B-B -14.9' -13.6' -11.5' - 11.4' 1.0' -20.1 -17.9' -17.9' -12.9' -12.6' -13.51 -14.5' -14.9' -13.3' -13.8' -16.2' 3.0' - 19.3' - 19.6' -12.0' -12.1' 0.0' -12.5' -12.5' - 19.1' 1.0' -13.5' -14.7' 0.0' -23.5' -24.1' -23.7' -22.1 -21.41 -21.61 -26.8' -25.8' 16.2 -16.5' -25.8' -27.7' 2.0' -25.3' -25.5' 2.0' -23.3' -23.8' 2.0' - 17.2' 0.3' EXPOSED STEP-FOOTING — FLOW -24.4' 5.0' BRIDGE 01218- PIER BRIDGE 04180- PIER 2 -22.8' -20.2' | -17.2' | 0.1' -28.5 -29.9' 0.0' -27.3° -29.5° 0.3° -21.3' -20.7' 0.4' -33.6' [0.0'] -30.3' |-30.3' -26.3° -27.8° 3.0° EXPOSED STEP-FOOTING — 0.2 0.3 -26.9' -29.6' -22.5' - 32.3 - 32.2 | 0.0 -25.3° -28.6° -21.2' -22.2' 0.0' -20.9' -21.2' -27.2' -27.8' -27.8' -23.8' -23.3' -23.3' -23.0' -22.3' -26.0' -27.6' -26.6' -25.3' -26.8' 0.0' -23.4' -27.4' -26.0' -23.7' 0.0' -24.4' -23.6' 25'+/-50'+/--28.6' -27.2' -27.0' -26.5' -25.1' -28.1 -26.9' -27.1' -26.8' -26.5' -26.6' -26.81 -26.3' -26.3' -26.0' -25.0' -24.6' -26.3' -26.6' 0.0' -26.1' -26.7' 0.0' -25.0' -26.1' -25.5' -26.5' MATCH LINE A-A

SOUNDING PLAN

N.T.S.

LEGEND FOR SYMBOLS

DATUM ELEV. 0.0' TAKEN FROM THE EASTBOUND BRIDGE 01218 AT THE SECOND CONSTRUCTION JOINT DOWN FROM THE TOP OF THE PIER AT THE CENTERLINE OF THE NORTH FACE OF PIER 1




LEGEND FOR BOTTOM ELEVATIONS

JULY. 2018: -0.0' JULY. 2016: -0.0'

O.O DEPTH OF PENETRATION



CONNECTICUT DEPARTMENT OF TRANSPORTATION	
BRIDGE NO. 01218 ROUTE 84 EASTBOUND OVER HOUSATONIC RIVER	\vee
NEWTOWN CONNECTICUT	R
SOUNDING PLAN	DRAWING 2
NSPECTED BY: JK, MB, JW SCALE: DATE OF INSPECTION REVISED BY: FH AS SHOWN 07 / 18 / 18 DRAWING NO. 01218 B	12

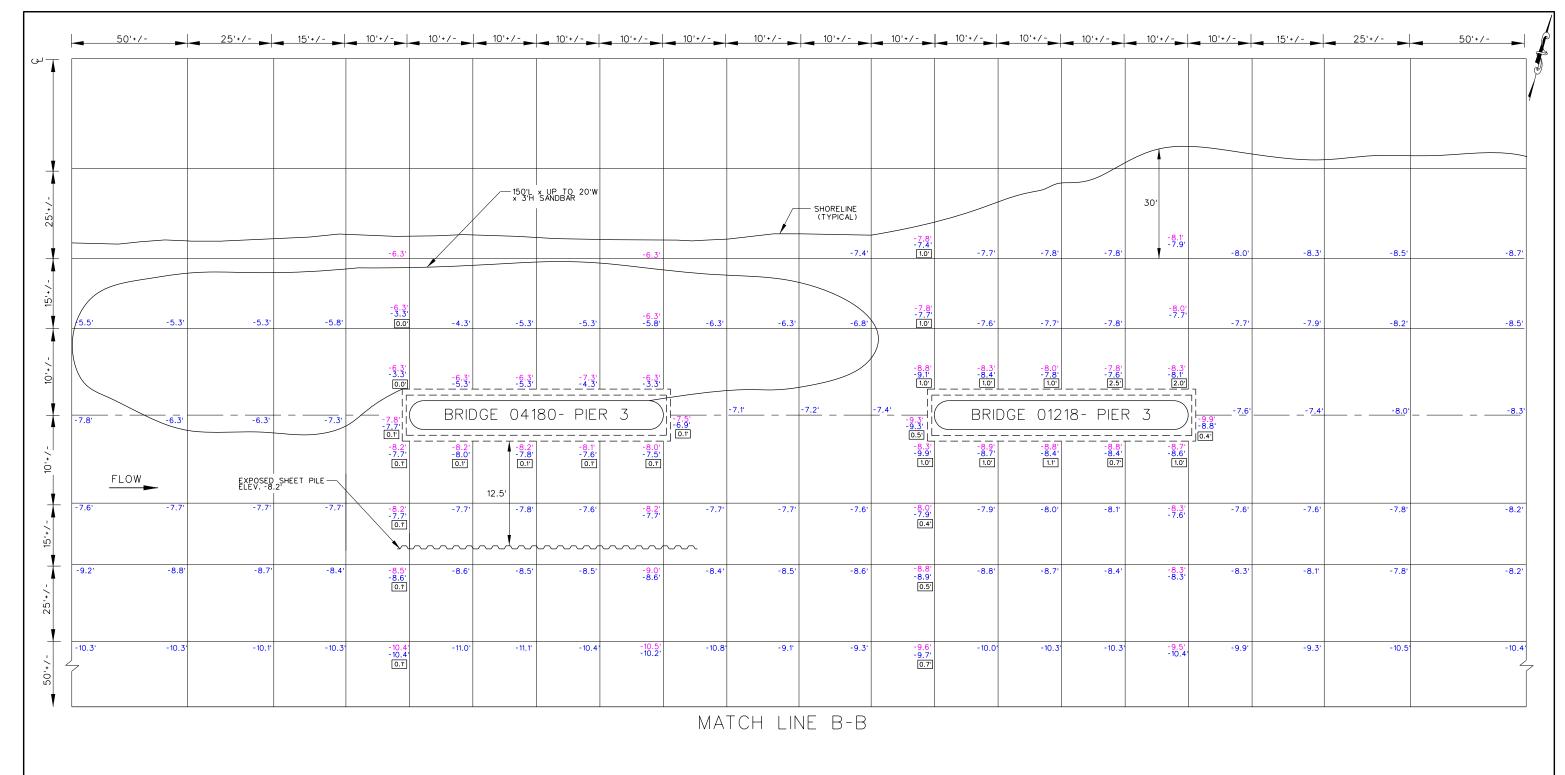

SOUNDING PLAN

N.T.S.

LEGEND FOR BOTTOM ELEVATIONS DATUM ELEV.

JULY. 2018: -0.0' JULY. 2016: -0.0'

LEGEND FOR SYMBOLS


DATUM ELEV. 0.0' TAKEN FROM THE EASTBOUND BRIDGE 01218 AT THE SECOND CONSTRUCTION JOINT DOWN FROM THE TOP OF THE PIER AT THE CENTERLINE OF THE NORTH FACE OF PIER 1


₩.S. ELEV. -7.3'
 -7.3'

O.O DEPTH OF PENETRATION



CONNECTICU	T DEP	ARTMENT C	F TRANSPORTATION	
POLITE	_	IDGE NO. 012	218 OUSATONIC RIVER	∀
NEWTOWN	04 LAS1	BOOND OVER TH	CONNECTICUT	┛ᆱ
	SOL	JNDING P	LAN	DRAWING 3
NSPECTED BY: JK, MB, JW REVISED BY: FH	SCALE: AS SHOWN	DATE OF INSPECTION 07 / 18 / 18	DRAWING NO. 01218 C	7 ~

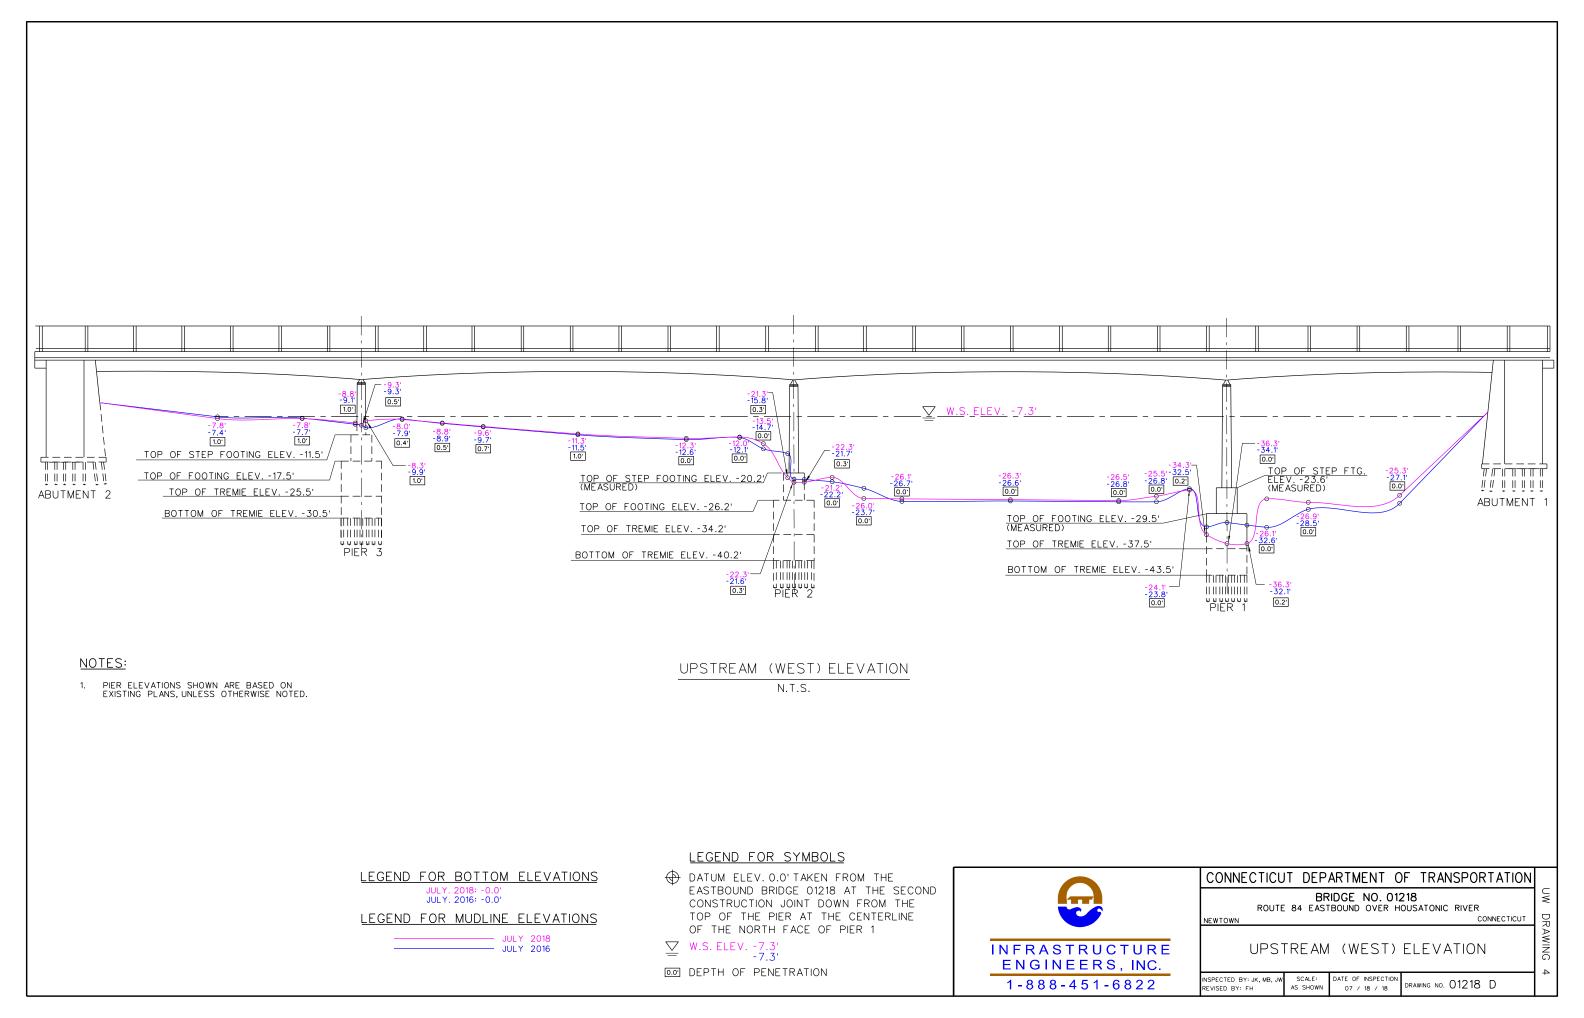

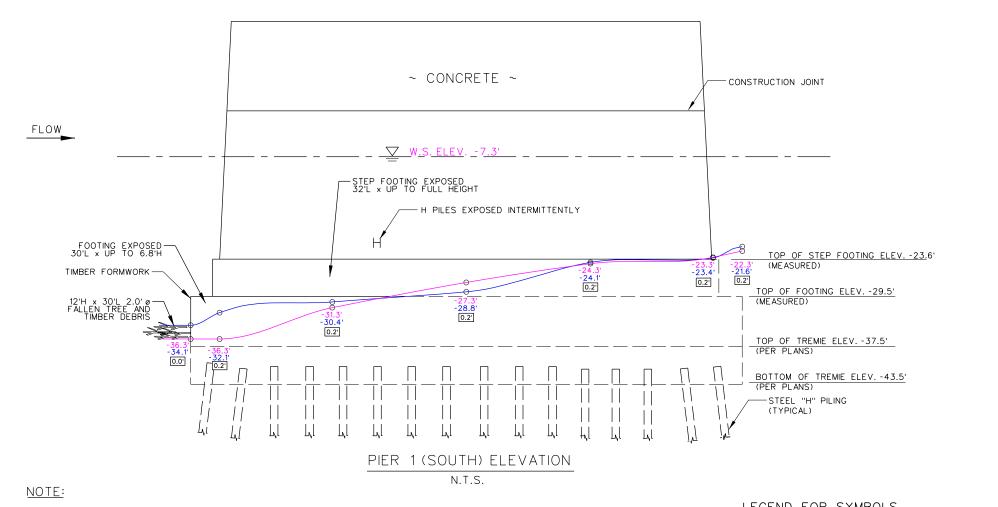

- BAND OF ABRASION UP TO 5'H x 1/4"D FROM 1' ABOVE WATERLINE TO 4' BELOW.
- ISOLATED AREAS OF ABRASION UP TO 1/8" DEEP ON EXPOSED STEP FOOTING AND FOOTING.
- RANDOM AREAS OF ZEBRA MUSSELS UP TO 50% COVERAGE x 1" THICK ON UNDERWATER SUBSTRUCTURE.
- FOOTING 1' WIDE.

LEGEND FOR BOTTOM ELEVATIONS

JULY. 2016: -0.0'

LEGEND FOR MUDLINE ELEVATIONS

JULY. 2016

LEGEND FOR SYMBOLS

DATUM ELEV. O.O' TAKEN FROM THE EASTBOUND BRIDGE 01218 AT THE SECOND CONSTRUCTION JOINT DOWN FROM THE TOP OF THE PIER AT THE CENTERLINE OF THE NORTH FACE OF PIER 1

O.O' DEPTH OF PENETRATION



CONNECTICUT DEPARTMENT OF TRANSPORTATION **BRIDGE NO. 01218** ROUTE 84 EASTBOUND OVER HOUSATONIC RIVER

NEWTOWN CONNECTICUT

PIER 1 (SOUTH) ELEVATION


INSPECTED BY: JK, MB, JW SCALE: DATE OF INSPECTION AS SHOWN 07 / 18 / 18 REVISED BY: FH

DRAWING NO. 01218 E

 $\subseteq \bigvee$

DRAWING

 Ω

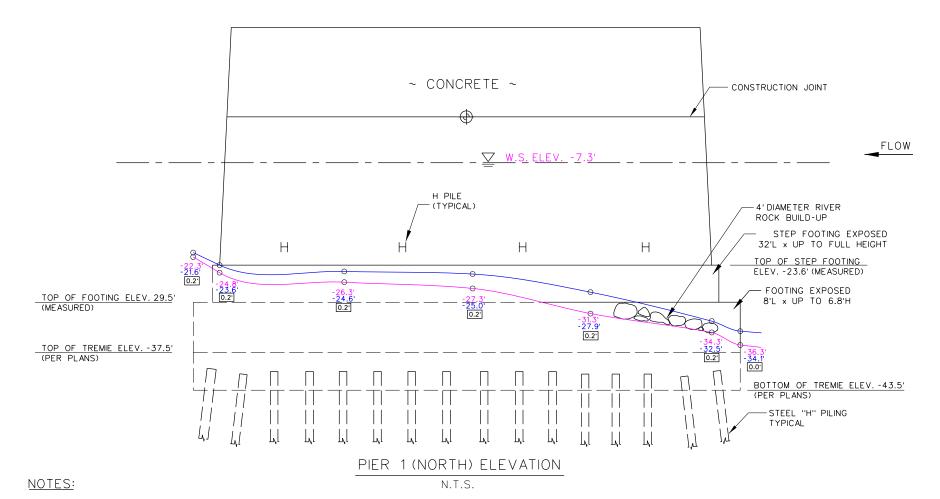

- BAND OF ABRASION UP TO 5'HIGH x 1/2" DEEP FROM 1'ABOVE THE WATERLINE TO 4'BELOW.
- ISOLATED AREAS OF ABRASION UP TO 1/8" DEEP ON EXPOSED STEP FOOTING AND FOOTING.
- RANDOM AREAS OF ZEBRA MUSSELS UP TO 50% COVERAGE x 1" THICK ON UNDERWATER SUBSTRUCTURE.
- 4. FOOTING 1' WIDE.

LEGEND FOR BOTTOM ELEVATIONS

JULY. 2016: -0.0'

LEGEND FOR MUDLINE ELEVATIONS

JULY. 2018 JULY. 2016

LEGEND FOR SYMBOLS

DATUM ELEV. 0.0' TAKEN FROM THE EASTBOUND BRIDGE 01218 AT THE SECOND CONSTRUCTION JOINT DOWN FROM THE TOP OF THE PIER AT THE CENTERLINE OF THE NORTH FACE OF PIER 1

DRAWING NO. 01218 F

₩.S. ELEV. -7.3'
 -7.3'

AS SHOWN


REVISED BY: FH

DEPTH OF PENETRATION



DEI III OI TENETIVATION		
CONNECTICUT DEPARTMENT OF TRANSPORT	ATION	
BRIDGE NO. 01218 ROUTE 84 EASTBOUND OVER HOUSATONIC RIVER		\vee
NEWTOWN CONN	NECTICUT	R
PIER 1 (NORTH) ELEVATION		AWING 6
INSPECTED BY: JK, MB, JW SCALE: DATE OF INSPECTION 04040 5		0

07 / 18 / 18

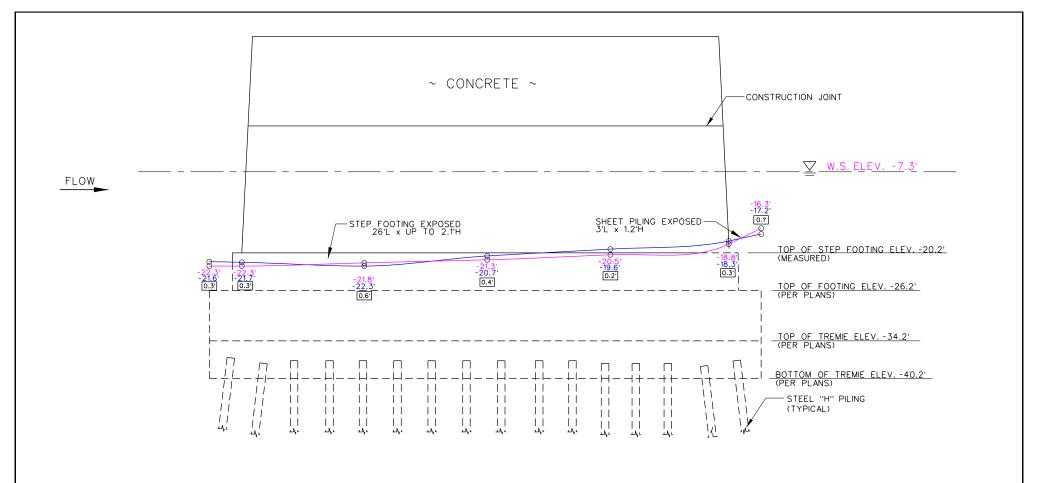

PIER 2 (SOUTH) ELEVATION N.T.S.

NOTES:

 BAND OF ABRASION 5' HIGH x UP TO 1/4" DEEP WITH ISOLATED AREAS UP TO 3/4" DEEP FROM 1' ABOVE WATERLINE TO 4' BELOW.

- RANDOM CHAMFER SPALLS ON EXPOSED STEP FOOTING UP TO 6" LONG x 3" WIDE x 1" DEEP.
- RANDOM AREAS OF ZEBRA MUSSELS UP TO 50% COVERAGE x 1" THICK ON UNDERWATER SUBSTRUCTURE.
- 4. FOOTING 1' WIDE.

LEGEND FOR BOTTOM ELEVATIONS

JULY. 2016: -0.0'

LEGEND FOR MUDLINE ELEVATIONS

JULY. 2018 JULY. 2016

LEGEND FOR SYMBOLS

DATUM ELEV. 0.0' TAKEN FROM THE EASTBOUND BRIDGE 01218 AT THE SECOND CONSTRUCTION JOINT DOWN FROM THE TOP OF THE PIER AT THE CENTERLINE OF THE NORTH FACE OF PIER 1

 $\subseteq \bigvee$

DRAWING

7

▼ W.S. ELEV. -7.3'

O.O DEPTH OF PENETRATION



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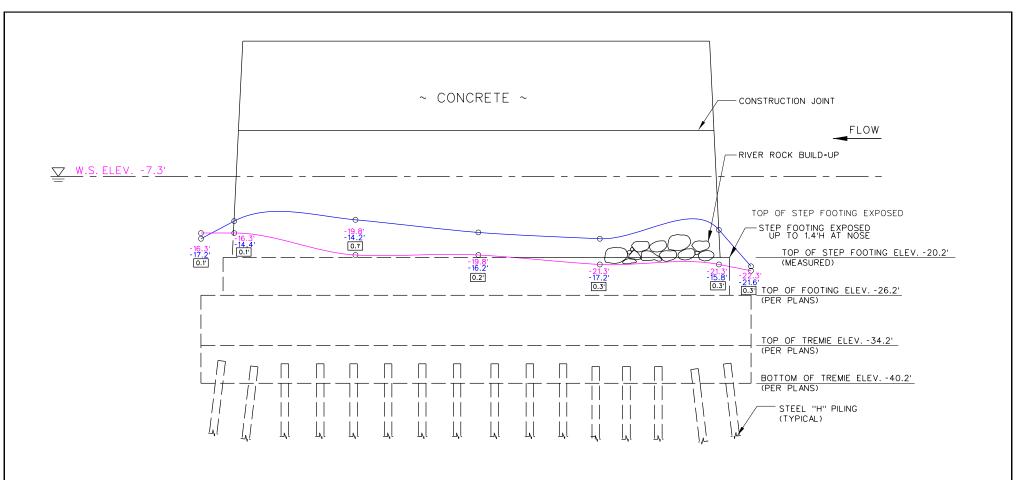
CONNECTICUT DEPARTMENT OF TRANSPORTATION BRIDGE NO. 01218

ROUTE 84 EASTBOUND OVER HOUSATONIC RIVER

NEWTOWN CONNECTICUT

PIER 2 (SOUTH) ELEVATION

INSPECTED BY: JK, MB, JW SCALE: DATE OF INSPECTION REVISED BY: FH AS SHOWN 07 / 18 / 18 DRAWING NO. 01218 G



PIER 2 (NORTH) ELEVATION

N.T.S.

NOTE:

- BAND OF ABRASION 5'HIGH x 1/2" DEEP WITH ISOLATED AREAS UP TO 3/4" DEEP FROM 1' ABOVE THE WATERLINE TO 4'BELOW.
- RANDOM AREAS OF ZEBRA MUSSELS UP TO 50% COVERAGE x 1" THICK ON UNDERWATER SUBSTRUCTURE.
- 3. FOOTING 1' WIDE.

LEGEND FOR BOTTOM ELEVATIONS

JULY. 2018: -0.0' JULY. 2016: -0.0'

LEGEND FOR MUDLINE ELEVATIONS

JULY. 2018 JULY. 2016

LEGEND FOR SYMBOLS

DATUM ELEV. 0.0' TAKEN FROM THE EASTBOUND BRIDGE 01218 AT THE SECOND CONSTRUCTION JOINT DOWN FROM THE TOP OF THE PIER AT THE CENTERLINE OF THE NORTH FACE OF PIER 1

 $\subseteq \bigvee$

DRAWING

 ∞

₩.S. ELEV. -7.3'
 -7.3'

O.O' DEPTH OF PENETRATION



INFRASTRUCTURE ENGINEERS, INC. 1-888-451-6822


CONNECTICUT DEPARTMENT OF TRANSPORTATION BRIDGE NO. 01218

ROUTE 84 EASTBOUND OVER HOUSATONIC RIVER

NEWTOWN CONNECTICUT

PIER 2 (NORTH) ELEVATION

INSPECTED BY: JK, MB, JW SCALE: DATE OF INSPECTION REVISED BY: FH AS SHOWN 07 / 18 / 18 DRAWING NO. 01218 H

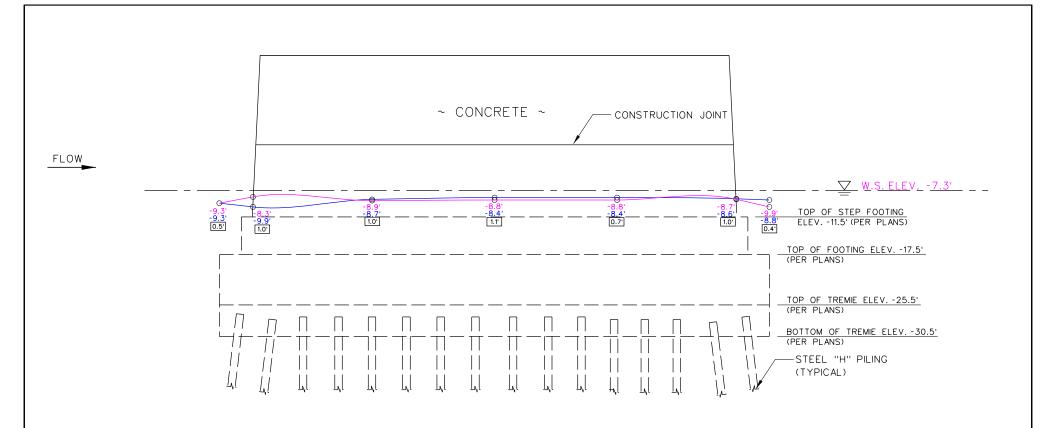

NOTE:

- ABRASION UP TO 1/2" DEEP FROM MUDLINE TO 1' ABOVE WATERLINE.
- A FEW RANDOM VERTICAL HAIRLINE CRACKS UP TO 1.5' LONG NEAR WATER SURFACE.

PIER 3 (SOUTH) ELEVATION

N.T.S.

LEGEND FOR SYMBOLS

DATUM ELEV. 0.0' TAKEN FROM THE EASTBOUND BRIDGE 01218 AT THE SECOND CONSTRUCTION JOINT DOWN FROM THE TOP OF THE PIER AT THE CENTERLINE OF THE NORTH FACE OF PIER 1

DRAWING NO. 01218 |

▼ W.S. ELEV. -7.3' -7.3'

AS SHOWN

REVISED BY: FH

O.O' DEPTH OF PENETRATION

LEGEND FOR BOTTOM ELEVATIONS


JULY. 2018: -0.0' JULY. 2016: -0.0'

LEGEND FOR MUDLINE ELEVATIONS


JULY. 2018

JULY. 2016



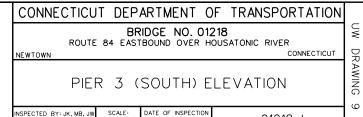

07 / 18 / 18

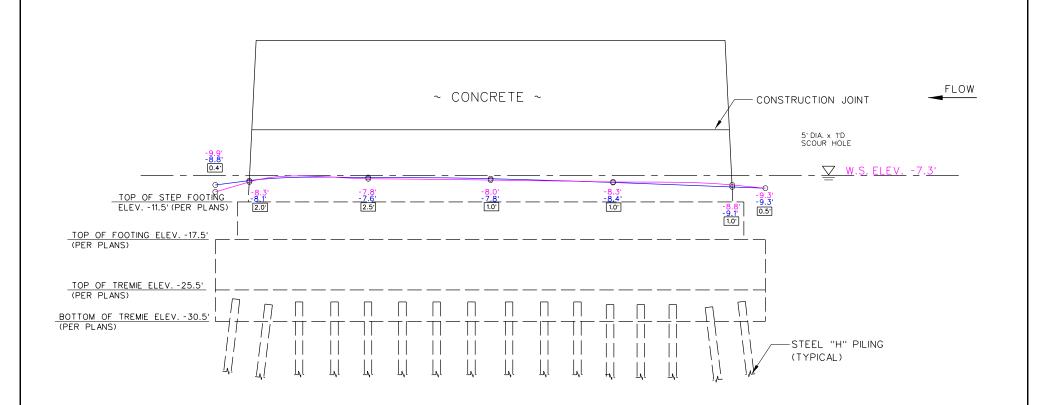

NOTES:

- ABRASION UP TO 1/2" DEEP FROM MUDLINE TO 1' ABOVE THE WATERLINE.
- 2. A FEW RANDOM VERTICAL HAIRLINE CRACKS UP TO 1.5'LONG NEAR WATER SURFACE.

PIER 3 (NORTH) ELEVATION

N.T.S.

LEGEND FOR BOTTOM ELEVATIONS

JULY. 2016: -0.0'

LEGEND FOR MUDLINE ELEVATIONS

JULY. 2016

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CONNECTICUT DEPARTMENT OF TRANSPORTATION **BRIDGE NO. 01218**

O.O DEPTH OF PENETRATION

LEGEND FOR SYMBOLS DATUM ELEV. 0.0' TAKEN FROM THE

> EASTBOUND BRIDGE 01218 AT THE SECOND CONSTRUCTION JOINT DOWN FROM THE TOP OF THE PIER AT THE CENTERLINE OF THE NORTH FACE OF PIER 1

> > $\subseteq \bigvee$

DRAWING

0

ROUTE 84 EASTBOUND OVER HOUSATONIC RIVER NEWTOWN CONNECTICUT

PIER 3 (NORTH) ELEVATION

INSPECTED BY: JK, MB, JW SCALE: DATE OF INSPECTION DRAWING NO. 01218 J AS SHOWN 07 / 18 / 18 REVISED BY: FH

Inspection type: Underwater **Inspection Date:** 7/18/2018

Inspected by: Infrastructure Engineers

Town: NEWTOWN Bridge No: 01218

Carried: INTERSTATE 84 EASTBOUND

Crossed: HOUSATONIC RIVER

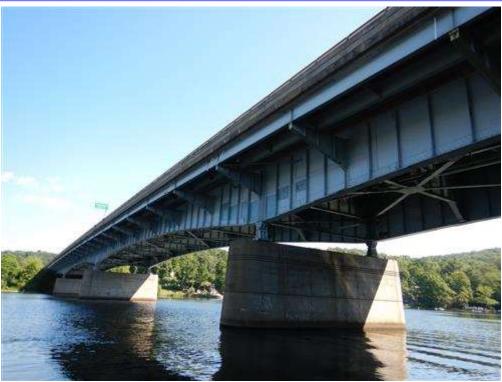


Photo Number: 1 Photo Taken: 07/18/2018 Upstream (North) Bridge Elevation



Photo Number: 2 Photo Taken: 07/18/2018

Inspection type: Underwater **Inspection Date:** 7/18/2018

Inspected by: Infrastructure Engineers

Town: NEWTOWN Bridge No: 01218

Carried: INTERSTATE 84 EASTBOUND

Crossed: HOUSATONIC RIVER

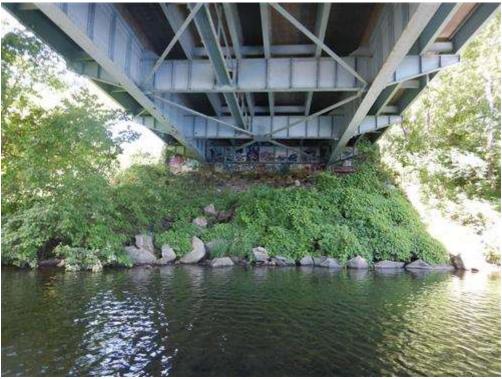


Photo Number: 3 Photo Taken: 07/18/2018

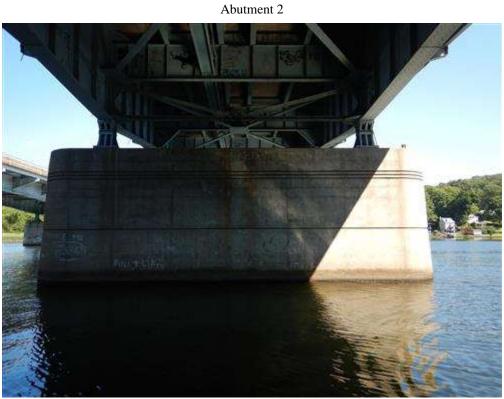


Photo Number: 4 Photo Taken: 07/18/2018

Inspection type: Underwater **Inspection Date:** 7/18/2018

Inspected by: Infrastructure Engineers

Town: NEWTOWN Bridge No: 01218

Carried: INTERSTATE 84 EASTBOUND

Crossed: HOUSATONIC RIVER

Inventory Route: NHS

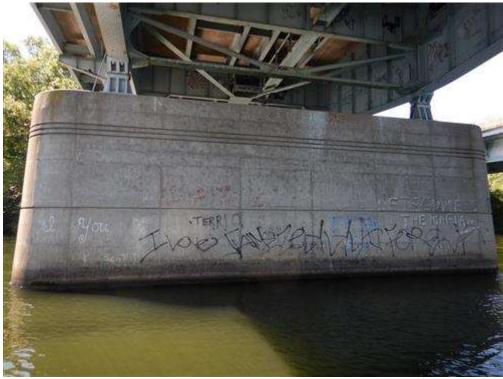


Photo Number: 5 Photo Taken: 07/18/2018



Pier 1 North Elevation

Photo Number: 6 Photo Taken: 07/18/2018 Pier 1 Footing

Note: Vertical exposure.

Inspection type: Underwater **Inspection Date:** 7/18/2018

Inspected by: Infrastructure Engineers

Town: NEWTOWN Bridge No: 01218

Carried: INTERSTATE 84 EASTBOUND

Crossed: HOUSATONIC RIVER

Inventory Route: NHS



Photo Number: 7 Photo Taken: 07/18/2018

Pier 1 Footing

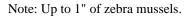




Photo Number: 8 Photo Taken: 07/18/2018

Inspection type: Underwater **Inspection Date:** 7/18/2018

Inspected by: Infrastructure Engineers

Town: NEWTOWN Bridge No: 01218

Carried: INTERSTATE 84 EASTBOUND

Crossed: HOUSATONIC RIVER

Inventory Route: NHS



Photo Number: 9 Photo Taken: 07/18/2018



Photo Number: 10 Photo Taken: 07/18/2018 Pier 2

Note: Sheet piles on top of step exposed 3' long x up to 1.2' high.

Inspection type: Underwater **Inspection Date:** 7/18/2018

Inspected by: Infrastructure Engineers

Town: NEWTOWN Bridge No: 01218

Carried: INTERSTATE 84 EASTBOUND

Crossed: HOUSATONIC RIVER

Inventory Route: NHS

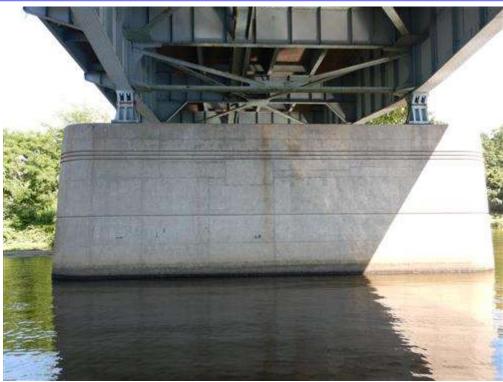


Photo Number: 11 Photo Taken: 07/18/2018

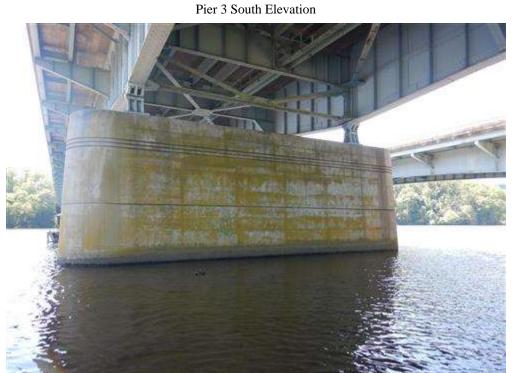


Photo Number: 12 Photo Taken: 07/18/2018 Pier 3 North Elevation

Inspection type: Underwater **Inspection Date:** 7/18/2018

Inspected by: Infrastructure Engineers

Town: NEWTOWN Bridge No: 01218

Carried: INTERSTATE 84 EASTBOUND

Crossed: HOUSATONIC RIVER



Photo Number: 13 Photo Taken: 07/18/2018

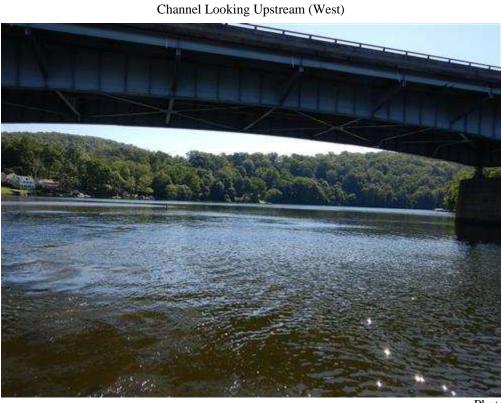


Photo Number: 14 Photo Taken: 07/18/2018

Inspection type: Underwater **Inspection Date:** 7/18/2018

Inspected by: Infrastructure Engineers

Town: NEWTOWN Bridge No: 01218

Carried: INTERSTATE 84 EASTBOUND

Crossed: HOUSATONIC RIVER



Photo Number: 15 Photo Taken: 07/18/2018

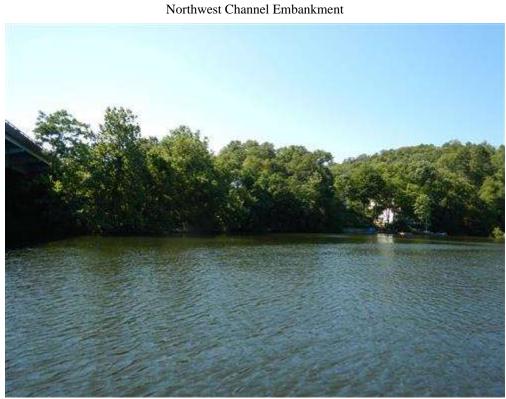


Photo Number: 16 Photo Taken: 07/18/2018 Southwest Channel Embankment

Inspection type: Underwater **Inspection Date:** 7/18/2018

Inspected by: Infrastructure Engineers

Town: NEWTOWN Bridge No: 01218

Carried: INTERSTATE 84 EASTBOUND

Crossed: HOUSATONIC RIVER



Photo Taken: 07/18/2018 Photo Number: 17

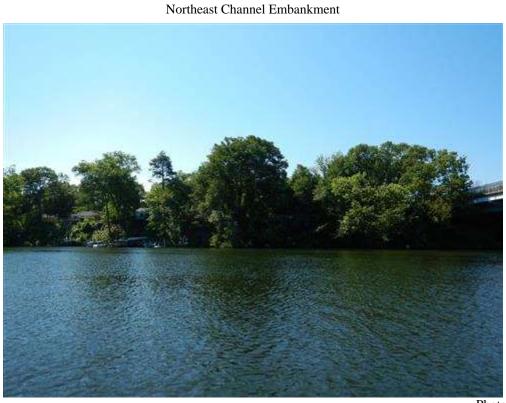


Photo Number: 18 Photo Taken: 07/18/2018 Southeast Channel Embankment

Inspection type: Underwater **Inspection Date:** 7/18/2018

Inspected by: Infrastructure Engineers

Town: NEWTOWN Bridge No: 01218

Carried: INTERSTATE 84 EASTBOUND

Crossed: HOUSATONIC RIVER

Inventory Route: NHS



Photo Number: 19 Photo Taken: 07/18/2018



Pier 1 Navigational Light (Downstream)

Photo Number: 20 Photo Taken: 07/18/2018

Inspection type: Underwater **Inspection Date:** 7/18/2018

Inspected by: Infrastructure Engineers

Town: NEWTOWN Bridge No: 01218

Carried: INTERSTATE 84 EASTBOUND

Crossed: HOUSATONIC RIVER



Photo Number: 21 Photo Taken: 07/18/2018

Pier 2 Navigatinoal Light (Downstream)



INFRASTRUCTURE ENGINEERS, INC.

BACK-UP MATERIAL

	NATIONAL BRIDGE ELEMENTS RECORDING SHEET *									
Structure No. 01218 By: Infrastructure Engineers Date: 7/18/2018								·-		
Element	Env Element/Structure Unit Description		Total	Units	Condition State Quantity					
/Str. Unit No.	EIIV	Element/structure offit Description	Qty.	Units	CS1	CS2	CS3	CS4		
SUBSTRUCTURE										
		Pier 1								
210	Mod.	Reinforced Concrete Pier Wall	42	LF	0	42	0	0		
1190		Abrasion / Wear (PSC/RC)	42	LF		42				
220	Mod.	Reinforced Concrete Pile Cap/Footing	32	LF	0	14	18	0		
6000		Scour	32	LF		14	18			

- 5' high band of abrasion up to 1/4" deep extending from 1' above to 4' below the water surface.
- There are steel H-piles intermittently extending out of the stem located above the step footing (formwork left in place from construction).
- Random areas of Zebra Mussels up to 50% x 1" thick on underwater substructure.
- Step Footing exposed up to 32' long x up to full-height (5.9' high) along both faces of the pier.
- Footing exposed up to 6.8' vertically (previously 5.0') over a length of 30' on the South face and 8' on the North face near the Upstream (West) end of the pier.
- Exposed surfaces of the step footing and footing have abrasion up to 1/8" deep.

Pier 2											
210	Mod.	Reinforced Concrete Pier Wall	42	EA	0	42	0	0			
1190		Abrasion / Wear (PSC/RC)	42	LF		42					
220	Mod.	Reinforced Concrete Pile Cap/Footing	21	LF	0	21	0	0			
6000		Scour	21	LF		21					

- 5' high band of abrasion up to 1/4" deep with isolated areas up to 3/4" deep extending from 1' above to 4' below the water surface.
- Random areas of Zebra mussels up to 50% coverage x 1" thick on the underwater substructure.
- The step footing is exposed up to 26' long x 2' high (previously 2' high) on the South face of the pier and along the Upstream (West) nose.
- Exposed surfaces of the step footings footing exhibit scaling up to 1/8" deep.
- Step footing has random chamfer spalls up to 6" long x 3" wide x 1" deep.

Pier 3											
210	Mod.	Reinforced Concrete Pier Wall	42	LF	0	42	0	0			
1190		Abrasion / Wear (PSC/RC)	42	LF		42					

- Band of abrasion up to 1/2" deep extending from 1' above the water surface down to the channel bottom.
- There are a few vertical hairline cracks up to 1.5' long near the water surface of the pier.
- Random areas of Zebra mussels up to 50% coverage x 1" thick on the underwater substructure.
- There is no exposure of the step footing or footing at the pier.

^{*} Includes only defects on Piers 1 through 3 from the high water mark to the channel bottom.