

Additions and Renovations Platt Technical High School

Milford, CT

ADDENDUM NO. 3

November 22, 2019

The original Specifications and Drawings dated October 11, 2019, Addendum No.1 dated November 8, 2019 and Addendum No.2 dated November 15, 2019 for the above-captioned project are amended as stated in this Addendum. This Addendum consists of 4 (four) pages, plus the following attachments.

ATTACHMENTS

CIVIL DRAWINGS

C-304, C-305 (2 pages)

ARCHITECTURAL SKETCHES

RA3-01 thru RA3-06 (6 pages)

STRUCTURAL SKETCHES

RS3-001, RA3-002 (2 pages)

STRUCTURAL DRAWING

S2-1-3 (1 page)

ATTENDANCE LOG FOR PRE-BID CONFERENCE THAT OCCURRED ON NOVEMBER 19, 2019 (SEE ATTACHMENT).

BIDDER QUESTION LOG (SEE ATTACHMENT), dated 11-22-2019.

AMENDMENTS TO PROJECT MANUAL

The web link below is to Joseph Merritt & Company's Electronic Plan Room. Bid Documents for Additions and Renovations Platt Technical High School are available for viewing.

https://www.merrittplanroom.com/jobs/54/details/rebid-additions-and-renovations-platt-technical-high-school

<u>DIVISION 00 – PROCUREMENT AND CONTRACTING REQUIREMENTS</u>

ADD 3-001 SECTION 00 41 10 – BID PACKAGE SUBMITTAL REQUIREMENTS

BID PACKAGE No.10R, Acoustical:

DELETE Bid Package Item 45, regarding Illuminated Perforated Metal Screens.



DIVISION 05 – METALS

ADD 3-002 SECTION 05 12 04 – STRUCTURAL STEEL

Page 4, Part 3, Revise the following Section:

"3.4 ARCHITECTURALLY EXPOSED STRUCTURAL STEEL (AESS)

- Fabrication and tolerances shall conform to the requirements of Section 10 of the 2016 AISC Code of Standard Practice for AESS category 3.
- All members shall be straight and true <u>and mill marks shall not be</u> <u>visible.</u>
- Welds shall be smooth and uniform.
- Field modifications to AESS members are not permitted.
- All AESS members shall receive a blast cleaning.
- All structural steel scheduled to receive intumescent paint shall be fabricated as AESS.
 - All AESS shall receive a shop applied primer coat in accordance with the requirements of the intumescent paint supplier."
 - A scaled mock-up of a welded connection assembly shall be provided at the job site for review.

DIVISION 09 - FINISHES

ADD 3-003 SECTION 09 77 30 - INTERIOR WALL PANELS

Page 1, Article 1.3, Paragraph D, DELETE Subparagraph 2 in its entirety.

ADD 3-004 SECTION 09 77 30 - INTERIOR WALL PANELS

Page 3, Article 2.3, Paragraph A, DELETE Subparagraph 1 in its entirety and renumber paragraphs 2 thru 8 to be 1 thru 7.

AMENDMENTS TO DRAWINGS

CIVIL

ADD 3-005 C-304 – SITE DRAINAGE PLAN

Drawing revised to show the limit of the drainage sand layer.

ADD 3-006 C-305 – SITE DRAINAGE PLAN

Drawing revised to show the limit of the drainage sand layer.



ARCHITECTURAL

ADD 3-007 A1-1-1B - FIRST FLOOR PLAN - AREA B

At Vestibule, B162, add Door Tag "B162.3" at doors located in Curtain Wall, CW12.

ADD 3-008 A1-1-1G – BUS GARAGE FLOOR PLAN – ALTERNATE No.2

Revised Storefront Tag, at Floor Plan, from SF27 to SF32. Refer to Sketch RA3-02.

ADD 3-009 A2-1-7 – BUS GARAGE ELEVATIONS – ALTERNATE No.2

Elevation 4: Revised Storefront Tag from SF27 to SF32. Refer to Sketch RA3-03.

ADD 3-010 A6-2-1 – DOOR SCHEDULE

Door S1.2: Revise Frame Type to SF3. Refer to Sketch RA3-04.

ADD 3-011 A6-2-1 – DOOR SCHEDULE

Under Fire Rating, DELETE column "GLASS" from the Schedules For Openings. From the Abbreviations Key, DELETE descriptions for "IG", "SG", and "TG." Refer to Specifications and Architectural A6 Series drawings for Glass Types.

ADD 3-012 A6-2-2 – DOOR SCHEDULE (CONT.)

Under Fire Rating, DELETE column "GLASS" from the Schedules For Openings. From the Abbreviations Key, DELETE descriptions for "IG", "SG", and "TG." Refer to Specifications and Architectural A6 Series drawings for Glass Types.

ADD 3-013 A6-3-2 – CURTAIN WALL TYPES

Curtain Wall Type CW12:

The Abbreviation "SG" refers to Glass Type "Security Glazing – Exterior."

ADD 3-014 A6-3-3 – CURTAIN WALL TYPES

Curtain Wall Type CW21:

The Abbreviation "SG" refers to Glass Type "Security Glazing – Exterior."

Curtain Wall Type CW22:

The Abbreviation "SG" refers to Glass Type "Security Glazing – Exterior."

ADD 3-015 A6-3-5 – STOREFRONT TYPES

ADD Storefront Type SF18. Refer to Sketch RA3-01.

ADD 3-016 A6-3-7 – INTERIOR STOREFRONT TYPES

Interior Storefront Type ISF 14:

The Abbreviation "SG" refers to Glass Type "Security Glazing – Interior."

<u>Interior Storefront Type ISF 15</u>:

The Abbreviation "SG" refers to Glass Type "Security Glazing – Interior."

Interior Storefront Type ISF 16:

The Abbreviation "SG" refers to Glass Type "Security Glazing – Interior."

ADD 3-017 A6-3-8 – INTERIOR STOREFRONT TYPES

Interior Storefront Type ISF 27:

The Abbreviation "SG" refers to Glass Type "Security Glazing – Interior."

Interior Storefront Type ISF 28:

The Abbreviation "SG" refers to Glass Type "Security Glazing – Interior."

Interior Storefront Type ISF 29:

The Abbreviation "SG" refers to Glass Type "Security Glazing – Interior."

ADD 3-018 A8-1-1B - FIRST FLOOR REFLECTED CEILING PLAN - Area B

Added GWB soffits at the perimeter of Kitchen Equipment Hoods, Walk-in Coolers and Freezers at Rooms B105, B124, B124A, B124B, B124C, B137, B138 & B139. Refer to Sketches RA3-05 and RA3-06.

STRUCTURAL

ADD 3-019	DRAWING S1-1-2A- SECOND FLOOR FRAMING PLAN - AREA A Plan notes are revised – Refer to Sketch RS3-001.
ADD 3-020	DRAWING S1-1-2B- SECOND FLOOR FRAMING PLAN - AREA B Add plan note to read "FOR PLAN NOTES SEE DRAWING S1-1-2A"
ADD 3-021	DRAWING S1-1-2C- SECOND FLOOR FRAMING PLAN – AREA C Plan notes are revised – Refer to Sketch RS3-001.
ADD 3-022	DRAWING S1-1-2D- SECOND FLOOR FRAMING PLAN – AREA D Plan notes are revised – Refer to Sketch RS3-001.
ADD 3-023	DRAWING S1-1-3A- ROOF FRAMING PLAN - AREA A Plan notes are revised - Refer to Sketch RS3-002.
ADD 3-024	DRAWING S1-1-3B- ROOF FRAMING PLAN - AREA B Plan notes are revised - Refer to Sketch RS3-002.

ADD 3-025 DRAWING S1-1-2C- ROOF FRAMING PLAN - AREA C

Plan notes are revised - Refer to Sketch RS3-002.


ADD 3-026 DRAWING S1-1-2D- ROOF FRAMING PLAN - AREA D


Plan notes are revised – Refer to Sketch RS3-002.


ADD 3-027 DRAWING S2-1-3- COLUMN SCHEDULE C


Four columns are added as shown per Revision RS3-001.

END OF ADDENDUM NO. 3

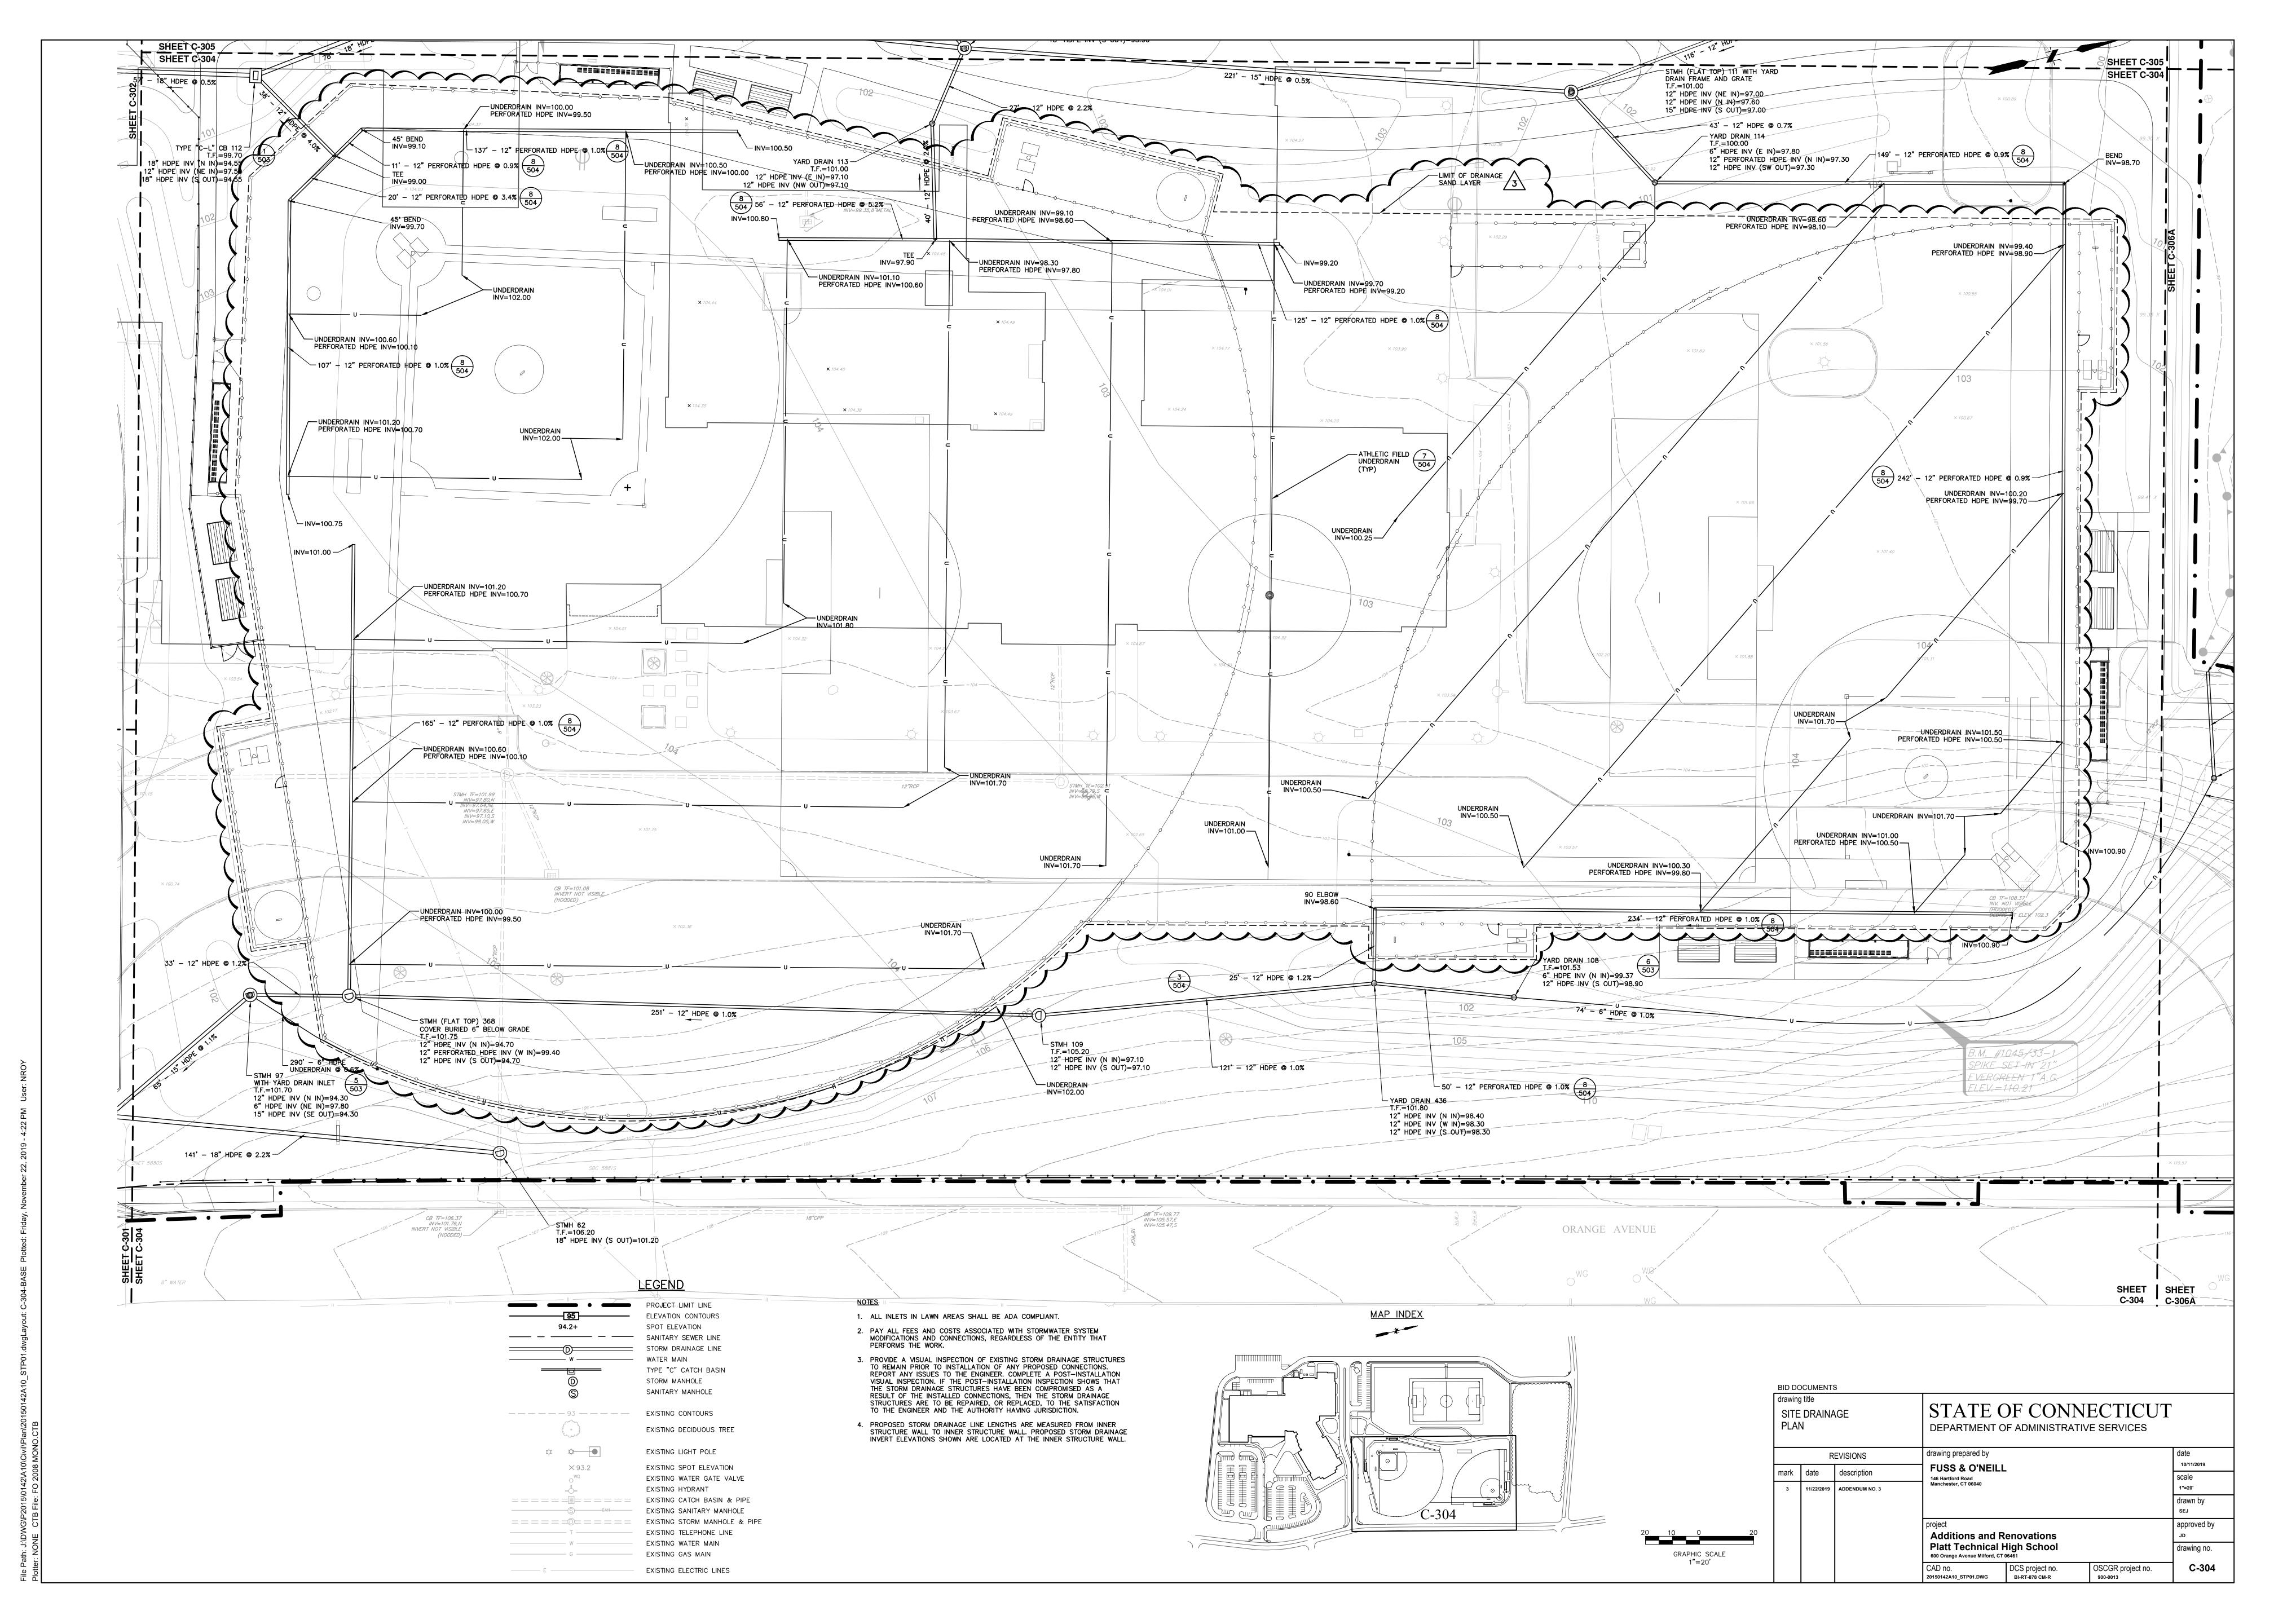

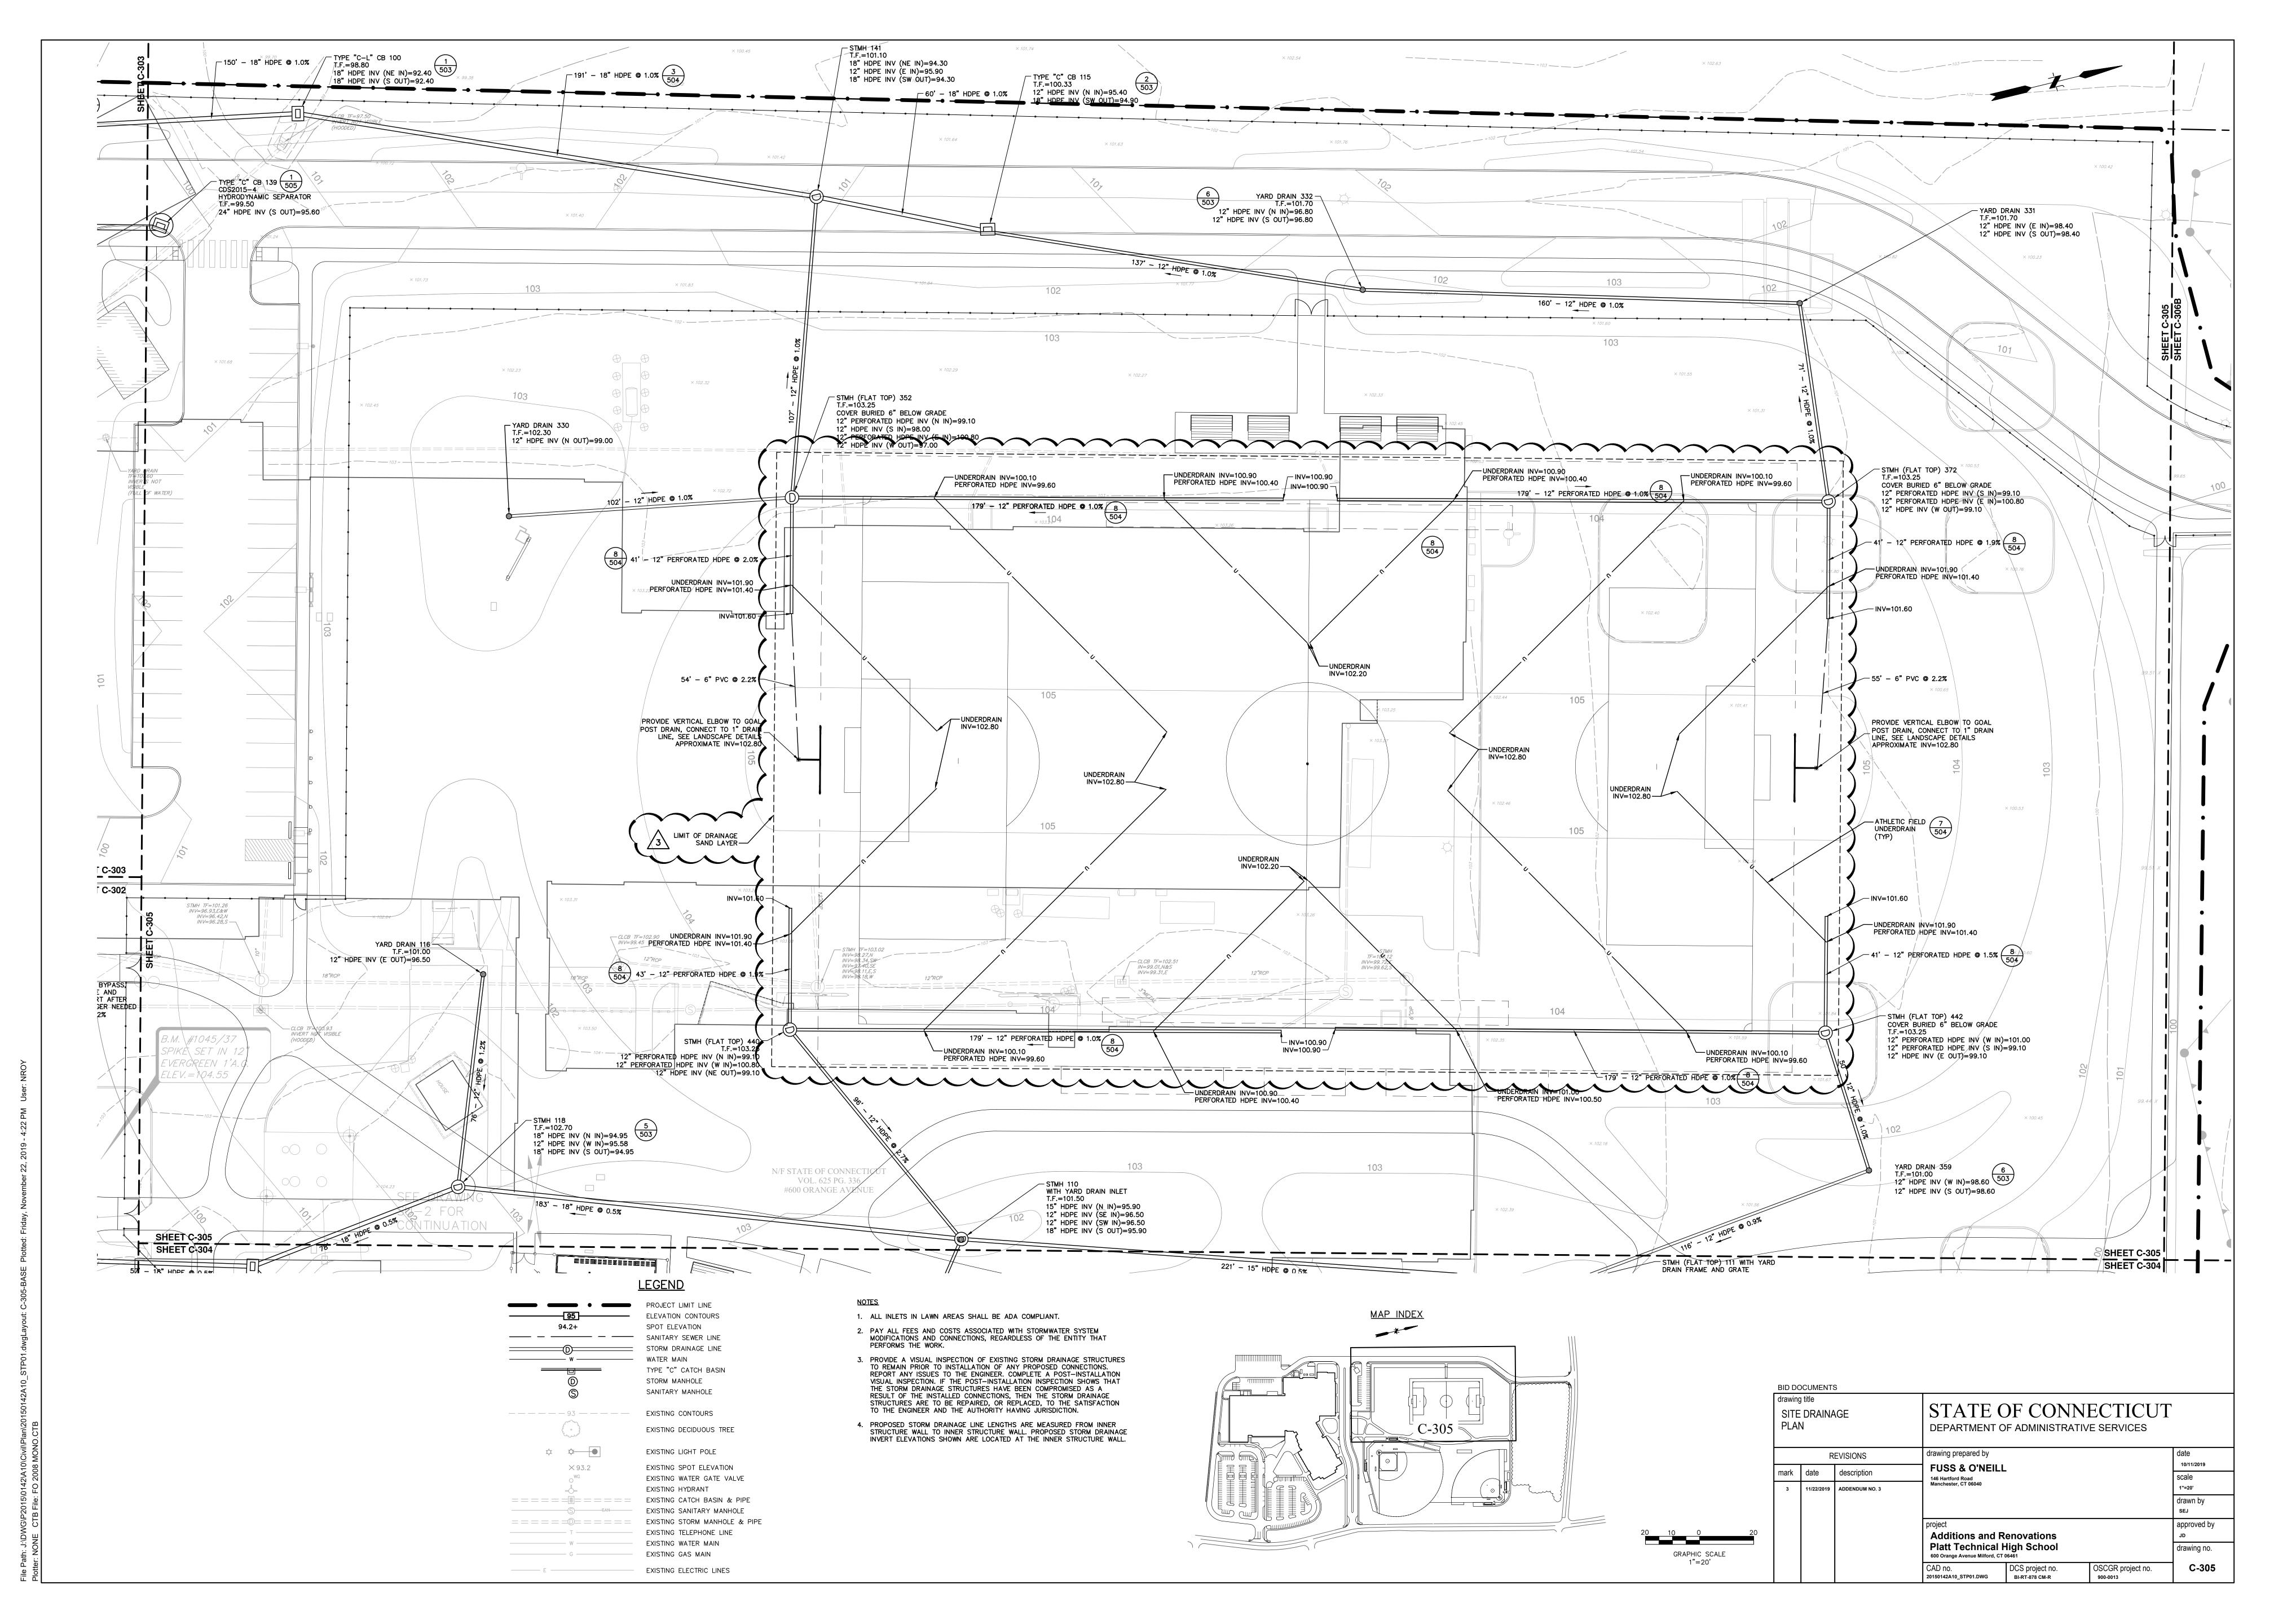

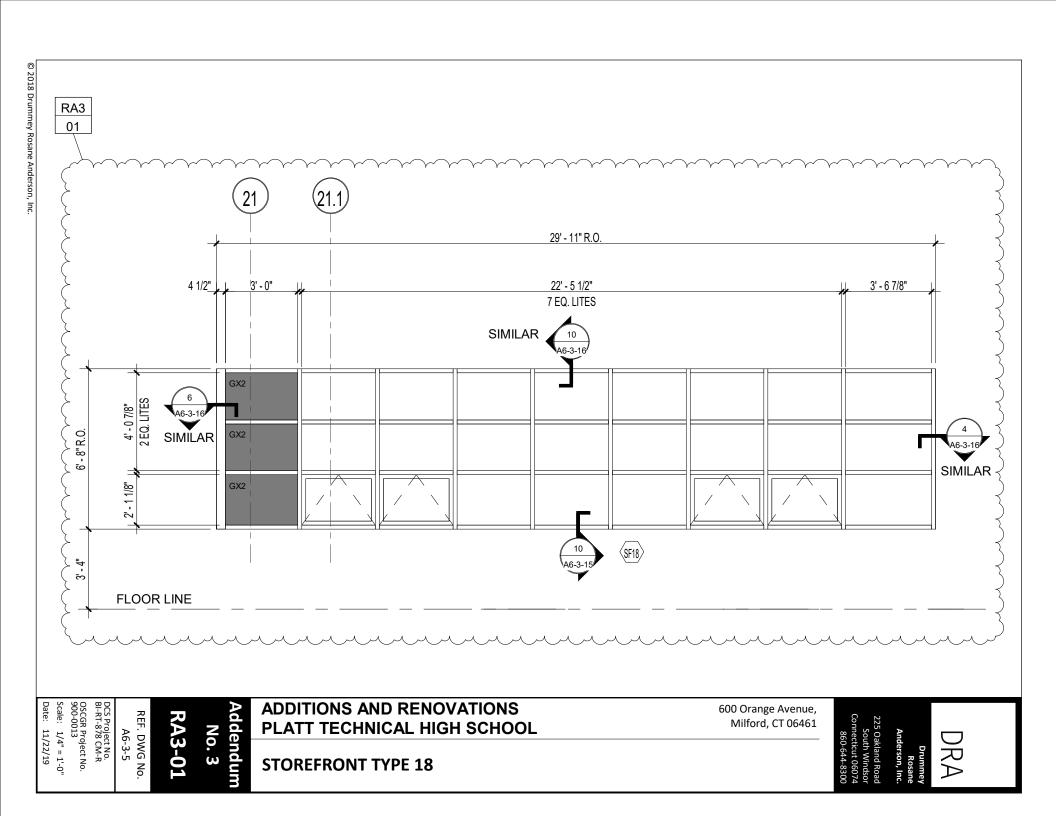

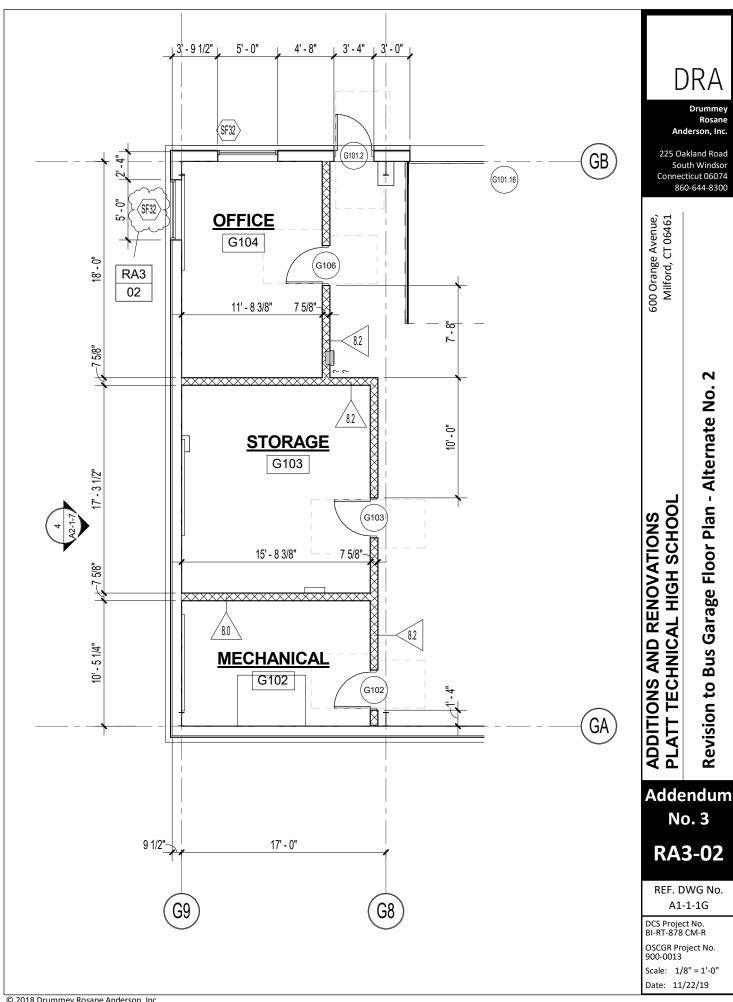

© 2018 Drummey Rosane Anderson, Inc.

REF. DWG No.

A2-1-7

DCS Project No.
BI-RT-878 CM-R

OSCGR Project No.
900-0013

Scale: 1/8" = 1'-0"

Date: 11/22/19

No. 3 RA3-03

ADDITIONS AND RENOVATIONS PLATT TECHNICAL HIGH SCHOOL

600 Orange Avenue, Milford, CT 06461

Revision to Bus Garage North Elevation - Alternate No. 2

225 Oakland Road South Windsor Connecticut 06074

Drummey Rosane Anderson, Inc.

Drummey Rosane Anderson, Inc.

225 Oakland Road South Windsor Connecticut 06074 860-644-8300

600 Orange Avenue, Milford, CT 06461

ADDITIONS AND RENOVATIONS PLATT TECHNICAL HIGH SCHOOL

Revision to Door Schedule


RA3-04

REF. DWG No. A6-2-1

DCS Project No. BI-RT-878 CM-R OSCGR Project No. 900-0013

Scale: Date:

																					ì				
						4/A6-2-4	4/A6-2-4	4/A6-2-4			2/A6-2-4			2/A6-2-4	ı	2/A6-2-4	16/A6-2-4	16/A6-2-4	ı	ı	•	ı		ı	
						3/A6-2-4	3/A6-2-4	3/A6-2-4	RA3	04	2/A6-2-4			2/A6-2-4	ı	2/A6-2-4	15/A6-2-4	15/A6-2-4		ı	-	ı		ı	
			,			_	_	_	1	-	-{	SF3	SF3	-	CW19	_	-	_	SF1	ı	-	1			
MTL	MTL	MTL	MTL	ALUM (ALUM	MTL	ALUM	MTL	MTL	MTL	ALUM	ALUM	ALUM	ALUM	ALUM	ALUM	ALUM								
OH1	OH1	OH1	OH1	OH1	OH1	ш	ш	ш	œ	œ	FV1	AL2	AL2	FV1	AL2	FV1	ш	FV1	AL2	MM	MM	ΜM	MM	MM	MM
MTL	MTL	MTL	MD	ALUM	ALUM	MD	ALUM	MD	MTL	MTL	ALUM	ALUM	ALUM	ALUM	ALUM	ALUM	ALUM								
2"	2"	2	2"	2"	2"	1 3/4"	1 3/4"	1 3/4"	3"	3"	1 3/4"	2"	2"	1 3/4"	2"	1 3/4"	1 3/4"	1 3/4"	1 3/4"	1 3/4"	1 3/4"	1 3/4"	1 3/4"	1 3/4"	1 3/4"
14' - 0"	14' - 0"	14' - 0"	14' - 0"	14' - 0"	14' - 0"	7' - 0"	7' - 0"	7' - 0"	7' - 0"	7' - 0"	7' - 0"	7' - 0"	7' - 0"	7' - 0"	8' - 0"	7' - 0"	7' - 2"	7' - 0"	7' - 0"	6' - 11"	89	.9 - 9	.9 - 9	7' - 0"	.9 - 9
											3' - 6"	3' - 6"	3' - 6"	3' - 6"	3' - 0"	3' - 0"	3' - 0"	3' - 6"	3' - 6"						
12' - 0"	12' - 0"	12' - 0"	12' - 0"	12' - 0"	12' - 0"	3' - 0"	3' - 0"	3' - 0"	.09	.09	3' - 6"	3' - 6"	3' - 6"	3' - 6"	3' - 0"	3' - 0"	3' - 0"	3' - 6"	3' - 6"	3' - 0"	3' - 0"	3' - 0"	3' - 0"	3' - 0"	3' - 0"
											•	•	•	•	•	•	•	•	•						
						•	•	•												•	•	•	•	•	•
A1-1-1G	A1-1-1H	A1-1-1H	A1-1-1D	A1-1-1D	A1-1-1D	A1-1-1D	A1-1-1C	A1-1-1C	A1-1-1B	A1-1-1E	A1-1-1E	A1-1-MF	A1-1-ME	A1-1-ME	A1-1-ME	A1-1-ME	A1-1-ME								
G101.11	G101.12	G101.13	G101.14	G101.15	G101.16	G102	G103	G106	GS101	GS102	S1.1	S1.2	S2.1	S2.2	83.1	83.2	S4.1	S5.1	S5.2	M103	M104	M105 ,	M106	M107	M108

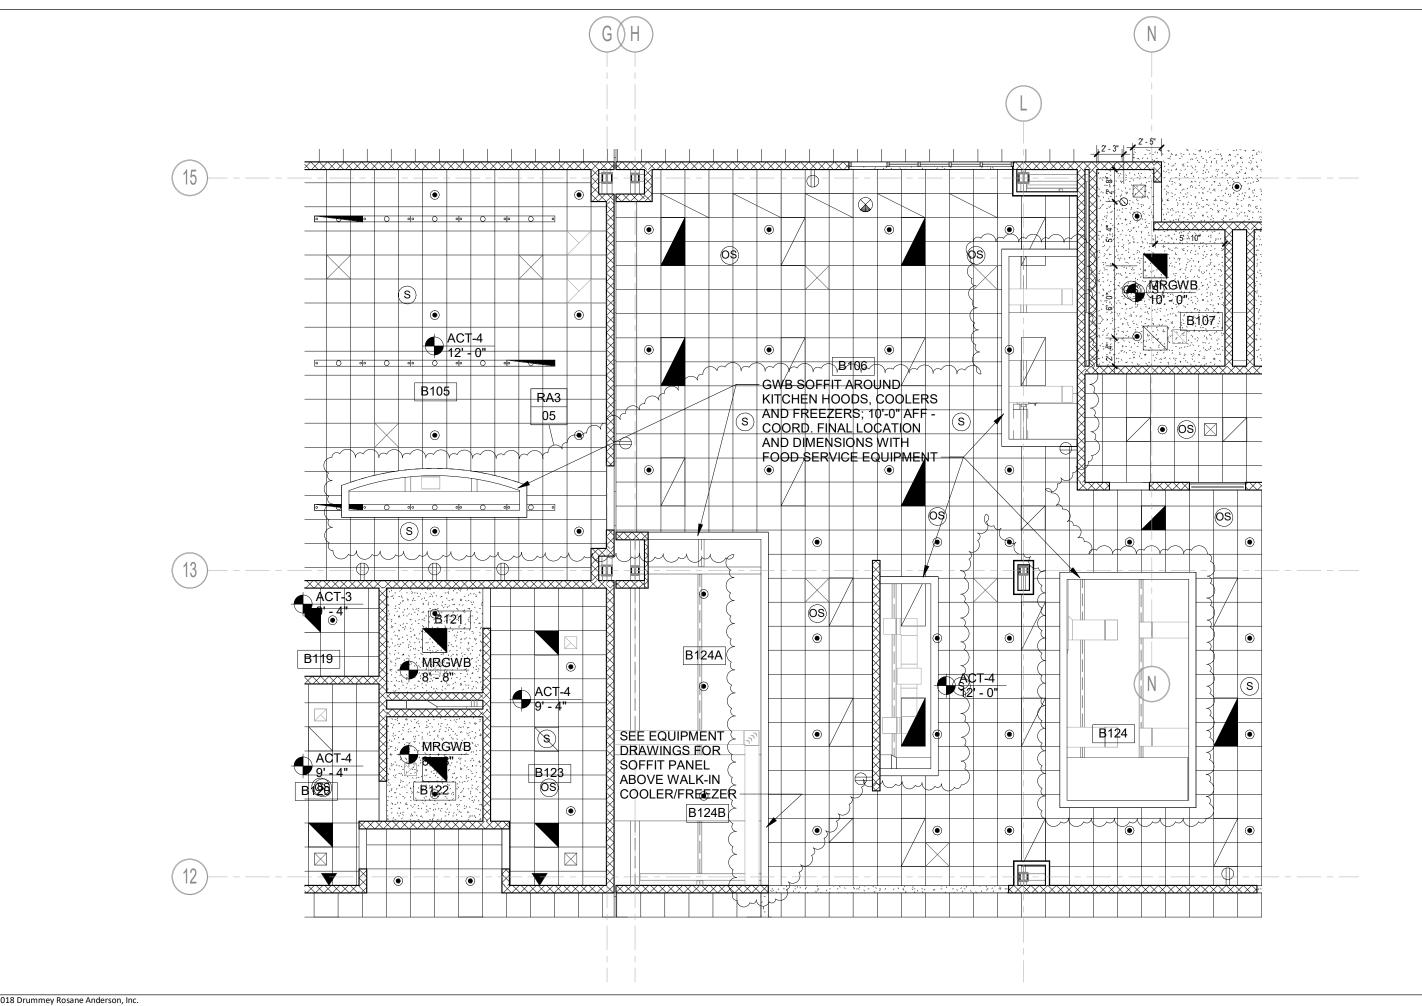

DRA

Rosane Anderson, Inc.

225 Oakland Road South Windsor Connecticut 06074 860-644-8300

600 Orange Avenue, Milford, CT 06461

 \mathbf{B} Area Revision to Reflected Ceiling Plan -ADDITIONS AND RENOVATIONS PLATT TECHNICAL HIGH SCHOOL

Addendum No. 3

RA3-05

REF. DWG No. A8-1-1B

DCS Project No. BI-RT-878 CM-R OSCGR Project No. Scale: 1/8" = 1'-0"

Date: 11/22/19

Addendum
No. 3

RA3-06

REF. DWG No.
A8-1-1B

DCS Project No.
BI-RT-878 CM-R
OSCGR Project No.
900-0013

Scale: 1/8" = 1'-0"
Date: 11/22/19

ADDITIONS AND RENOVATIONS PLATT TECHNICAL HIGH SCHOOL

600 Orange Avenue, Milford, CT 06461

25 Oakland Road South Windsor nnecticut 06074

Rosane Anderson, Inc.

Revision to Reflected Ceiling Plan - Area B

SECOND FLOOR FRAMING PLAN NOTES:

- 1. TOP OF SLAB SHALL BE AT ELEVATION 117'-0" (+18'-0" A.F.F.).
- 2. TOP OF STEEL SHALL BE AT ELEVATION 116'-6" (+17'-6"), UNLESS OTHERWISE SHOWN THUS (...+) OR (...-) INDICATING DISTANCE ABOVE OR BELOW ELEVATION 116'-6".
- 3. [+....] INDICATES TOP OF ROOF STEEL GIRDER ELEVATION AT CETER LINE OF COLUMN. ALL ELEVATIONS ARE REFERENCED TO TOP OF STEEL ELEVATION INDICATED.
- INDICATES SPAN OF 6" CONCRETE SLAB (TOTAL DEPTH) COMPRISED OF 4 1/2" CONCRETE TOPPING REINF. WITH 6X6-W2.9XW2.9 ON 1 1/2" DEEP, 20 GAUGE, GALVANIZED COMPOSITE METAL DECK. SEE SLAB SCHEDULE ON DRAWING S1-1-2 FOR MORE INFORMATION.
- 5. NUMBER SHOWN AFTER BEAM SIZE (I.E. +20 S.C.) INDICATES THE NUMBER OF 3/4" DIAMETER X 4" HIGH, STUD TYPE, HEADED SHEAR CONNECTORS TO BE SPACED UNIFORMLY ALONG THE TOP FLANGE OF BEAM, UNLESS OTHERWISE SHOWN.
- PROVIDE FLOOR OPENING FRAME (F.O.F.) FOR ALL OPENINGS IN CONCRETE SLAB LAREGER THAN 12" IN ANY DIRECTION PER DETAIL ON DRAWING S1-1-2.
- INDICATES 1-1/2" DEEP, 20 GAGE, WIDE RIB (TYPE B), GALVANIZED METAL 7. ROOF DECK.
- 8. INDICATES 1-1/2" DEEP, 20 GAGE, WIDE RIB (TYPE "BA"), GALVANIZED ACOUSTICAL METAL ROOF DECK.
- PROVIDE ROOF OPENING FRAME (R.O.F.) FOR ALL OPENINGS IN METAL ROOF DECK LARGER THAN 12" IN ANY DIRECTION PER DETAIL RT1/S1-1-3. REINFORCE DECK OPENINGS FROM 6" TO 12" IN SIZE WITH L2"x2"x1/4" STEEL ANGLE. EXTEND A MIN. OF 2 FLUTES EACH SIDE OF OPENING AND WELD TO DECK.
- 10. LOCATION OF BEAM WEB OPENING, G.C. TO COORDINATE EXACT SIZE AND LOCATION WITH MECHANICAL CONTRACTOR. SEE STEEL BEAM WEB OPENING SCHEDULE ON DRAWING S0-0-2 FOR REINFORCEMENT REQUIREMENTS - TYPICAL.
- 11. INDICATES MOMENT CONNECTION WHICH SHALL DEVELOP THE FLEXURAL CAPACITY OF THE MEMBER.
- 12. EXPOSED TUBULAR STEEL TO BE FABRICATED AND ERECTED IN ACCORDANCE WITH THE REQUIREMENTS FOR ARCHITECTURALLY EXPOSED STRUCTURAL STEEL (AESS 3). ALL EXPOSED CORNERS TO BE BEVELED AND FULLY WELDED ALL AROUND. ALL EXPOSED TUBE-TO-TUBE CONNECTIONS TO BE WELDED ALL AROUND AND GROUND SMOOTH, G.C. TO COORDINATE EXTENTS WITH ARCHITECTURAL DRAWINGS TYPICAL.
- 13. ALL CONDUITS OR PIPING SHALL BE PLACED OUTSIDE OF THE STRUCTURAL SLAB, NO CONDUIT OR PIPING SHALL BE PLACED WITHIN THE STRUCTUAL SLAB.

14. LINTELS AT ALL CONCRETE MASONRY WALLS (6" AND GREATER) SHALL CONSIST OF REINFORCED GROUTED BOND BEAMS. TYPICAL BOND BEAM SHALL BE "ML-4" FOR A MAXIMUM CLEAR OPENING OF 8'-0". SEE CMU LINTEL SCHEDULE ON DRAWING "S0-0-2" FOR ADDITIONAL REQUIREMENTS.

Rosane

225 Oakland Road Connecticut 06074 860-644-8300

600 Orange Avenue Milford, CT 06461

REVISED SECOND FLOOR FRAMING PLAN NOTES

Additions and Renovations Platt

Technical High Schoo

RS3-001

REF. DWG No. S1-1-2A,B &C

OSCGR Project No.

Scale: 1/8" = 1'-0" Date: 11/22/19

© 2018 Drummey Rosane Anderson, Inc.

ROOF FRAMING PLAN NOTES:

- 1. TOP OF STEEL SHALL BE AT ELEVATION 131'-0" (+14'-0" A.F.F.) UNLESS OTHERWISE SHOWN THUS (+...) OR (-...) INDICATING THE DISTANCE ABOVE OR BELOW ELEVATION 131'-0" .
- 2. [±.....] INICATES TOP OF STEEL GIRDER ELEVATION AT CENTER LINE OF COLUMN. ALL ELEVATIONS ARE REFERENCED TO TOP OF STEEL ELEVATION 131'-0" (+14'-0" A.F.F.).
- INDICATES 1 1/2" DEEP, 20 GAGE, WIDE RIB (TYPE "B"), GALVANIZED METAL ROOF DECK.
- INDICATES 1-1/2" DEEP, 20 GAGE, WIDE RIB (TYPE "BA"), GALVANIZED ACOUSTICAL METAL ROOF DECK.
- 5. PROVIDE ROOF OPENING FRAME (R.O.F.) FOR ALL OPENINGS IN METAL ROOF DECK LARGER THAN 12" IN ANY DIRECTION PER DETAIL R1 ON DRAWING S1-1-3. REINFORCE DECK OPENINGS FROM 6" TO 12" IN SIZE W/ L2x2x1/4 STEEL ANGLE. EXTEND A MINIMUM OF 2 FLUTES EACH SIDE OF OPENING AND WELD TO DECK.
- INDICATES MOMENT CONNECTION WHICH SHALL DEVELOP THE FLEXURAL CAPACITY OF THE MEMBER.
- 7. PROVIDE DIAGONAL JOIST BRIDGING WITH BOLTED CONNECTIONS IN ACCORDANCE WITH SJI REQUIREMENTS. JOIST DESIGNER SHALL PROVIDE BRIDGING AS REQUIRED TO ADEQUATELY BRACE THE JOISTS AGAINST LATERAL MOVEMENT UNDER FULL LOAD. PROVIDE BOTTOM CHORD UPLIFT BRIDGING AS REQUIRED.
- 8. ALL JOISTS SHALL BE DESIGNED FOR NET MINIMUM WIND UPLIFT OF 15 PSF. JOISTS AND PERIMETER LOCATED WITHIN 10' OF EXTERIOR WALL SHALL BE DESIGNED FOR NET UPLIFT OF 25 PSF.
- 9. "T.J" INDICATES STEEL TIE JOIST TO HAVE BOTTOM CHORD EXTENSIONS AT STEEL COLUMN LOCATIONS.
- 10. BRACING "VB-*" INDICATES VERTICAL BRACING. SEE BRACING ELEVATIONS ON DRAWING S2-2-1 FOR REQUIREMENTS.

- 11. OPEN WEB STEEL ROOF JOISTS TO BE DESIGNED TO SUPPORT ADDITIONAL POINT LOADS INDICATED AT LOCATION OF ALL MECHANICAL ROOF TOP UNITS AND EQUIPMENT. COORD. ACTUAL LOCATION WITH MECHANICAL DRAWINGS AND SUPPLIER. ADDITIONAL POINT LOADS:
- 12. ALL CONDUITS OR PIPING SHALL BE PLACED BELOW THE STRUCTURAL SLAB, NO CONDUIT OR PIPING SHALL BE PLACED WITHIN THE STRUCTUAL SLAB.
- 13. EXPOSED TUBULAR STEEL TO BE FABRICATED AND ERECTED IN ACCORDANCE WITH THE REQUIREMENTS FOR ARCHITECTURALLY EXPOSED STRUCTURAL STEEL (AESS 3). ALL EXPOSED CORNERS TO BE BEVELED AND FULLY WELDED ALL AROUND. ALL EXPOSED TUBE-TO-TUBE CONNECTIONS TO BE WELDED ALL AROUND AND GROUND SMOOTH. G.C. TO COORDINATE EXTENTS WITH ARCHITECTURAL DRAWINGS TYPICAL.
- 14. LINTELS AT ALL CONCRETE MASONRY WALLS (6" AND GREATER) SHALL CONSIST OF REINFORCED GROUTED BOND BEAMS. TYPICAL BOND BEAM SHALL BE "ML-4" FOR A MAXIMUM CLEAR OPENING OF 8'-0". SEE CMU LINTEL SCHEDULE ON DRAWING "S0-0-2" FOR ADDITIONAL REQUIREMENTS.

Connecticut 0607

500 Orange Avenue Milford, CT 06461

PLAN NOTES Additions and Renovations Platt Technical High School **FRAMING** REVISED


RS3-002

REF. DWG No. S1-1-3A,B,C & D


DCS Project No. BI-RT-878 CM-R OSCGR Project No.

Scale: 1/8" = 1'-0" Date: 11/22/19

© 2018 Drummey Rosane Anderson, Inc.

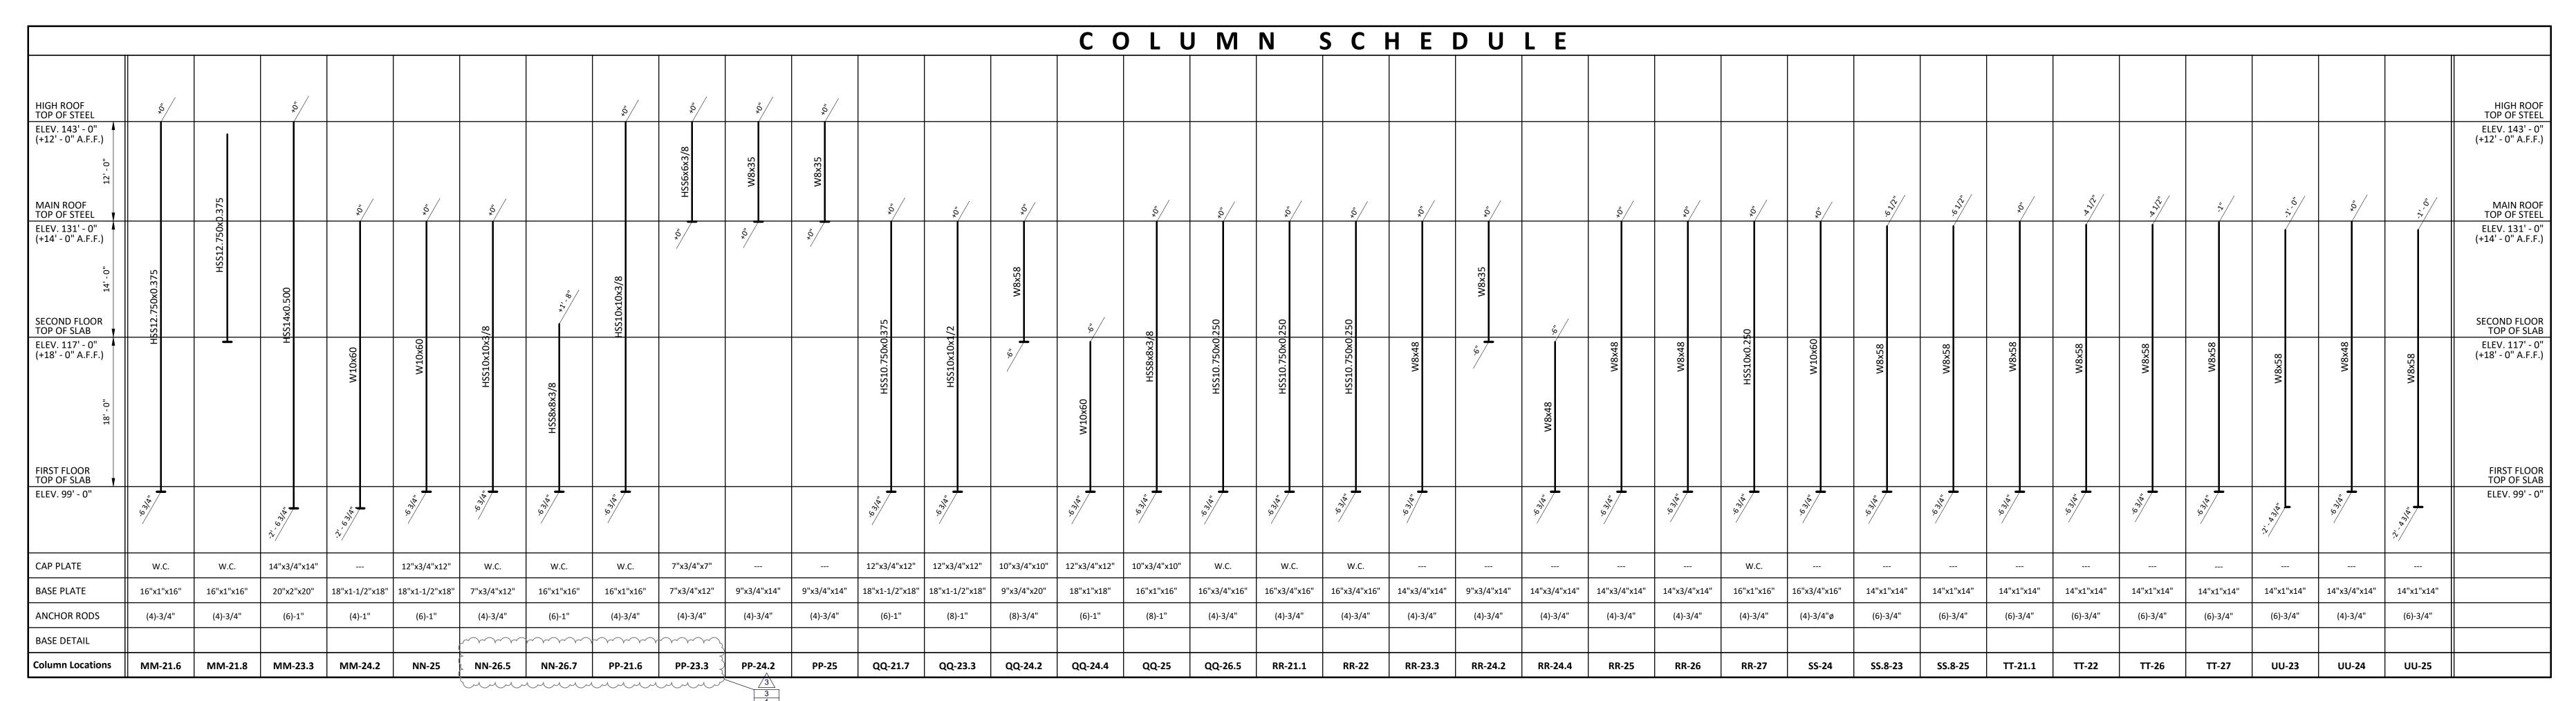

										1																											
															C	O L	U M	N	S C	H E	D U	LE															
MAIN ROOF TOP OF STEEL ELEV. 131' - 0" (+14' - 0" A.F.F.)		\$\displaystyle{\	\$\$	***/	,,,,,,,,,,,,,,,,,,,,,,,,,,,,,,,,,,,,,,	,,,,,,,,,,,,,,,,,,,,,,,,,,,,,,,,,,,,,,	,',',',',',',',',',',',',',',',',',','			,,,,,,,,,,,,,,,,,,,,,,,,,,,,,,,,,,,,,,	*\$0/	***	""		, , , , , , , , , , , , , , , , , , ,	"0 _*	****	,7. ,0,	, ', ', ', ', ', ', ', ', ', ', ', ', ',	, jo	**/									,,,,,,,,,,,,,,,,,,,,,,,,,,,,,,,,,,,,,,	Ž.	****	%	""."	"\!\!\	, , , , , , , , , , , , , , , , , , ,	MAIN ROOF TOP OF STEEL ELEV. 131' - 0" (+14' - 0" A.F.F.)
SECOND FLOOR TOP OF SLAB								Š	Ś					375	375			375	375			<u> </u>		ů,	***	<i>"</i>	<u>, , , , , , , , , , , , , , , , , , , </u>	, jo/									SECOND FLOOR TOP OF SLAB
ELEV. 117' - 0" (+18' - 0" A.F.F.)	W8x48	W8x48	W8x48	W8x48	W8x48	W8x48	W8x48	W8x35	W8x35	W8x48	W8x48	W8x48	W8x48	HSS8.625x0.3	HSS8.625x0.3	W8x58	W8x58	HSS8.625x0.3	HSS8.625x0.3	W8x58	W8x58	HSS6x6x1/4	SS6x6x1/4	HSS6x6x1/4	*9',>" HSS4x4x1/4	HSS6x6x1/4	HSS6x6x1/4	HSS6x6x1/4	*9, *, HSS4x4x1/4	W8x48	W8x48	W8x48	W8x48	W8x48	W8x48	W8x48	ELEV. 117' - 0" (+18' - 0" A.F.F.)
FIRST FLOOR TOP OF SLAB ELEV. 99' - 0"		, , , , , , , , , , , , , , , , , , ,	, i. j.		**************************************	\$ \$ \$ \$ \$ \$ \$ \$ \$ \$ \$ \$ \$ \$ \$ \$ \$ \$ \$			\$ 50 miles		63,000			1. P. S.	\$ 8.50 m	9,	, p	, p. 2.	, b	**************************************	9. S.	9,		\$5,000		, p & 2	, p & d &	9,9		\$ \$ \$ \$ \$ \$ \$ \$ \$ \$ \$ \$ \$ \$ \$ \$ \$ \$ \$		9. 3. 3. 3. 3. 3. 3. 3. 3. 3. 3. 3. 3. 3.	9,	\$3.00 m	, p. 25		FIRST FLOOR TOP OF SLAB ELEV. 99' - 0"
CAP PLATE																		W.C.	W.C.			W.C.	W.C.	W.C.	W.C.	W.C.	W.C.	W.C.	W.C.								
BASE PLATE	14"x1"x14"	14"x1"x14"	14"x1"x14"	14"x1"x14"	14"x1"x14"	14"x1-1/4"x1	14" 14"x1"x14"	12"x3/4"x12	2" 12"x3/4"x	(12" 14"x1"x14"	14"x1"x14"	14"x1"x14"	14"x1"x14"	14"x1"x14"	14"x1"x14"	14"x1"x14"	14"x1"x14'	' 14"x1"x14"	14"x1"x14"	14"x1"x14"	14"x1"x14"	12"x3/4"x12"	12"x3/4"x12"	12"x3/4"x12"	' 5"x3/4"x10"	12"x3/4"x12"	12"x3/4"x12"	12"x3/4"x12'	" 5"x3/4"x10"	14"x1"x14"	14"x1"x14"	14"x1"x14"	14"x1"x14"	14"x1"x14"	14"x1"x14"	14"x1"x14"	
ANCHOR RODS	(4)-3/4"	(4)-3/4"	(4)-3/4"	(4)-3/4"	(4)-3/4"	(4)-3/4"	(4)-3/4"	(4)-3/4"	(4)-3/4	" (4)-3/4"	(4)-3/4"	(4)-3/4"	(4)-3/4"	(4)-3/4"	(4)-3/4"	(6)-3/4"	(6)-3/4"	(4)-3/4"	(4)-3/4"	(6)-3/4"	(6)-3/4"	(4)-3/4"	(4)-3/4"	(4)-3/4"	(4)-3/4"	(4)-3/4"	(4)-3/4"	(4)-3/4"	(4)-3/4"	(4)-3/4"	(4)-3/4"	(4)-3/4"	(4)-3/4"	(4)-3/4"	(4)-3/4"	(4)-3/4"	
BASE DETAIL																																					
Column Locations	VV-21.1	VV-22	VV-26	VV-27	WW-23	WW-24	WW-25	XX-23.4	XX-24.	6 YY-21.1	YY-22	YY-26	YY-27	ZZ-23	ZZ-25	AAA-21.1	AAA-22	AAA-23	AAA-25	AAA-26	AAA-27	BBB-23.2	BBB-24	BBB-24.7	BBB.5-23.2	BBB.5-23.6	BBB.5-24	BBB.5-24.3	BBB.5-24.7	CCC-21	CCC-21.1	CCC-22	CCC-26	CCC-27	CCC-27.1	CCC.3-23	

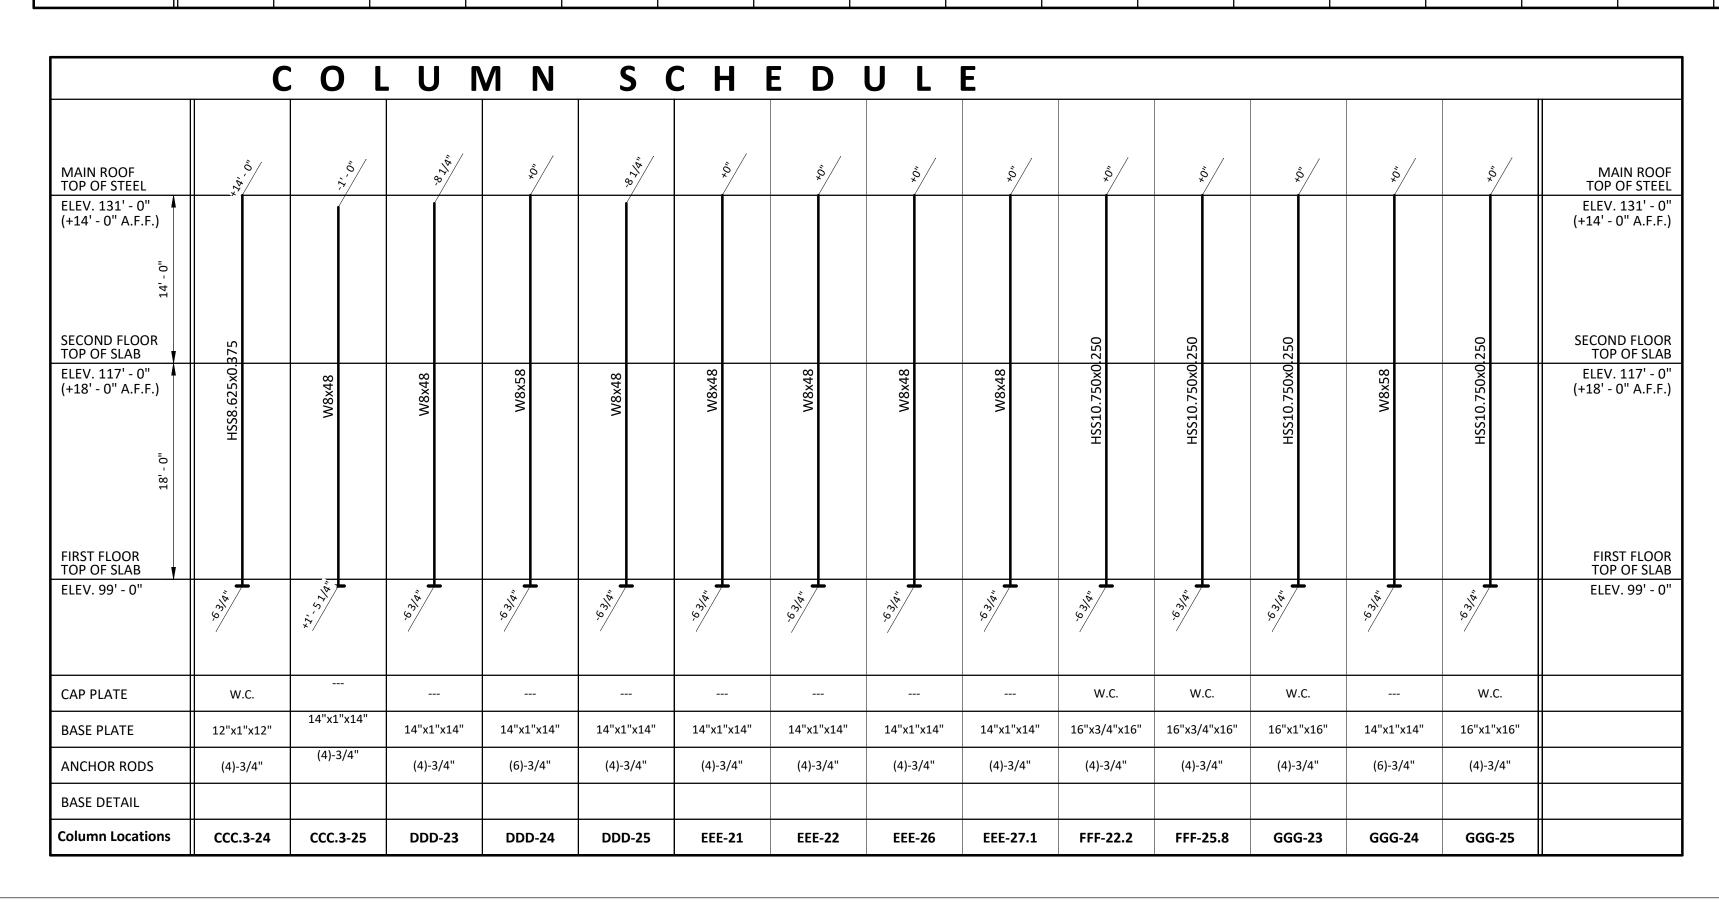

COLUMN SCHEDULE NOTES

- 1. AT EACH COLUMN PROVIDE A 1/4" THICK LEVELING PLATE (SAME SIZE AS BASE PLATE) ON MINIMUM OF 1" NON-SHRINK GROUT
- 2. PROVIDE MIN. (4) ANCHOR RODS AT EACH COLUMN SEE COLUMN SCHEDULE AND ANCHOR ROD SCHEDULES FOR QUANTITY, SIZE AND ADDITIONAL DETAILS.
- 3. ALL DIMENSIONS SHOWN ARE GIVEN TO TOP OF CAP PLATES AND TO BOTTOM OF BASE PLATES.
- 4. W.C. INDICATES 1/4" THICK WEATHER CAP.
- 5. PROVIDE MINIMUM 1/4" FILLET WELD ALL AROUND AT TYPICAL COLUMN TO BASE PLATE CONNECTIONS.
- 6. PROVIDE 3"x3/8"x3" PLATE WASHERS AT ALL ANCHOR BOLTS. FIELD WELD PLATE WASHERS TO BASE PLATE AT BRACED FRAME COLUMNS.
- 7. AT MOMENT CONNECTION PROVIDE 8"x8"x1/2" MIN. CAP PLATE AND THROUGH PLATE AT BEAM BOTTOM FLANGE.
- 8. WHERE COLUMNS BEAR ON SUPPORTING STEEL BEAMS PROVIDE
 (4)-3/4" DIA. A325 BOLTED CONNECTION FROM COLUMN BASE
- WHERE BEAMS ARE CONTINUOUS OVER/BELOW COLUMNS PROVIDE 3/8" FITTED WEB STIFFENERS ALIGNED WITH COLUMN CENTER BOTH SIDES OF BEAM WEB.

PLATE TO BEAM TOP FLANGE U.O.N.

Α	NCH	OR ROD SCH	IEDULE
DIAMETER	1,	REMARKS	TOD OF
3/4"ø	1'-0"		TOP OF CONCRETE
1"ø	1'-2"	ASTM F-1554 GR. 55	PROJECTION AS REQUIRED
GRADE 36 M 2. PROVIDE ANCHOR RO	ATERIAL - WASHERS DS. HOR RODS	SAND NUTS FOR ALL SHALL BE FREE OF SCALE,	EMBEDDED NUT TYPE 1



BID	DOCUM	ENTS			"uni	SONAL EMILIA
drawi CO	•	SCHEDULE C		OF CON	NECTICU	T
	RI	EVISIONS	drawing			dat
mar	date	description	SZEWCZAK AS	SSOCIATES		10/11/2019
3	11/22/2019	ADDENDUM #3	200 Fisher Drive Avon, CT 06001			scale 1/8" = 1'-0" drawn
						Author
			projec Additions and	Renovations		approved Approver
			Platt Technica 600 Orange Avenue Milf	High School ord, CT 06461		drawing
			CAD	DCS project	OSCGR project	S2-1-3

			DWG REF in Question and/or	SPEC REF in Question	
Addendum	Item	Question / Assumption	Answer	and/or Answer	RESPONSE
		I just wanted to let you know that the link in the DAS invitation to bid to the plans and specs for Platt HS results in the following error message: This transfer expired on Nov 12, 2019. If you need additional access to			
ADD-3	3-01	the files, please contact the person who sent them to you.			Refer to Addendum No.3.
ADD-3	3-02	The following columns are not listed in the column schedule. Grids NN-26.5 & NN-26.7	S2-1-3		Refer to Addendum No.3.
					Insurance answers:
					The Construction Manager is carrying the Builders Risk Insurance
					Insurance the sub are carrying is outlined below:
ADD-3	3-03	Is the Construction Manager requiring you to carry the builders risk/installation floater?			Commercial General liability Commercial Automobile liability Workers Compensation Umbrella liability.
7,000	3 03	instantion notice.			ombreila nability.
ADD-3	3-04	Is the Construction Manager requiring you to carry the Owners & contractors Protective Liability policy?			See response to items 3-03, above.
ADD-3	3-05	Are you doing any design or professional services that would require professional liability? Exhibit F does no list specific limit.			Professional liability insurance is required for certain specifications sections that require professional design and/or engineering services. Refer to the bid documents for these requirements.
ADD-3	3-06	Storefront frame SF18 is missing from Storefront types drawing A6-3-5. Please review and provide SF18.	A6-3-5		Refer to Addendum No.3.
ADD-3	3-07	Drawing A1-1-1G, Alt #2 drawing. SF 27 does not reflect SF27 in SF types. Please confirm this is a misprint and frame should read SF32.	A1-1-1G		Refer to Addendum No.3.

			DWG REF in	SPEC REF in Question	
Addendum	Item	Question / Assumption	Answer	and/or Answer	RESPONSE
		CW12 on A6-3-2 shows frame to be security glazing. Door schedule, drawing A6-2-1 shows door B162.3 frame CW12 to have IG glazing.	A6-2-1		
ADD-3	3-08	Please advise correct glazing type for CW12.	A6-3-2		Refer to Addendum No.3.
ADD-3	3-09	Door schedule A6-2-2 door #S1.2 shows door to be in frame SF5. SF5 has no door in frame. Please confirm this door should be in Storefront frame SF3.			Potento Addondum No 2
ADD-3	3-09	513.	A0-2-2		Refer to Addendum No.3.
ADD-3	3-10	Do the exterior frost pads get epoxy doweled into the foundation wall? Dowels are not shown on the detail.	S3-1-1		Provide dowels at all exterior door pads similar to section F1/S3-1-1 "Typical Exterior Foundation Wall - Variation at Door"
		I believe the spec on this project calls for the pipe bollard tops to be formed by hand. We manufacture a precast concrete bollard cap that makes this process faster, less expensive and completely uniform.			
ADD-3	3-11	If you get a second visit us at www.topgardcap.com. There are some installation videos on the site that demonstrate how easy the product is to install and the uniform profile that is achieved.			This project does not call for "concrete filled" bollards. Refer to project manual for bollard specifications.
		Please verify the interior exposed HSS beams on S1-1-3C are not AESS,			
ADD-3	3-12	since there are no notes to that affect on the structural plans or architectural sections?	S1-1-3C S4-1-4		Refer to Addendum No.3.
ADD-3	3-13	Bid Package #05RB Reference SOW Trade Specific Item #41 Will a schedule of lintels required be supplied prior to bidding for ductwork, banks of piping, and conduit runs?			Refer to all Construction Documents to determine penetration locations, quantities and dimensions.
ADD-3	3-14	Bid Package #05RA Reference S4/S4-2-2 and similar conditions Please clarify which bid package provides the continuous angle which is acting as a pour stop and toe kick.	S4-2-2		The structural steel package owns the pour stop and toe kick as referenced on S4/S4-2-2.

			DWG REF in		
				SPEC REF in Question	
Addendum	Item	Question / Assumption	Answer	and/or Answer	RESPONSE
		Did Dookson MOCDD			
		Bid Package #05RB Reference SOW General Item #13			
ADD-3	3-15	Please confirm daily cleanup is at that bid package area of work only.			Daily clean-up is for your work only.
7.2.5	0 10	Trease committee and accuracy to accuracy to accuracy passings area or more only.			July Great up to for your troncomy.
		Bid Package #05RB			
		Reference SOW General Item #3, #4			
		Please clarify that submittals are to be completed as to meet the project			Agreed submittals will be processed to meet the
		schedule, knowing that all items will not be detailed and approved in a			schedule requirements and we realize it will take
ADD-3	3-16	five week time period.			longer than five weeks.
		Bid Package #05RA			
		Reference SOW General Item #18			There are two Morganti Site Logistics Plan under the
ADD-3	3-17	Please provide logistics plan as referenced.			Site Drawings MG1 and MG2.
					,
		Bid Package #05RB			
ADD 2	2.40	Reference SOW General Item #7			The Cite Control to will provide the control line.
ADD-3	3-18	Please confirm that Morganti will be providing control lines.			The Site Contractor will provide the control lines.
		Bid Package #05RA			
		Reference: SOW Item #51			
		Please provide architectural tolerances to be adhered to, and specific			
		details showing what members have to be field installed as opposed to			
		shop welded. Structural steel specification lists no tolerances, and AISC			
		tolerances will be used. Please confirm if this means that			Tolerances per Spec. 051204-1.4-A-1. Exact sequence
		members will need to be shipped loose, as opposed to bolted in the			of fabrication and erection are contractors means and
ADD-3	3-19	shop with final adjustment in the field.		05 12 04	methods
		Bid Package #05RB			
		Reference: 11/A7-1-10, S1/S4-2-2	A7-1-10		
ADD-3	3-20	Please provide detail of how guardrail post is attached at mezzanine.	S4-2-2		Detailing by railing supplier/misc metals.

ltem	Question / Assumption	DWG REF in Question and/or Answer	SPEC REF in Question and/or Answer	RESPONSE
2-21	Please advise if Nelson could be added as an approved manufacturer for the heat trace if they can meet the spec? Currently only 1 of 3 approved		22.07.00	If a substitution request form is provided, we will consider this substitution.
3-21	inanufacturers typicany quotes projects in C1.		23 07 00	Consider this substitution.
3-22	Trane has requested to be added as an approved contractor for the controls, please advise if this is acceptable?		23 09 23	Specification to remain with the three manufactures as specified.
3-23	Are there any associated CAD fees with signing over the release forms from the Architect to start our 3D coordination?		HVAC & FP	Division 21 and 23 specifications do not call for fees for the electronic files such as CAD.
				Fuel oil tank: Refer to Spec Section 231113, paragraph 3.5. Owner will fill the tank upon Project turn over. Contractor shall be responsible for fuel oil used for testing and startup.
3-24	Who owns filling the fuel oil tanks with fuel oil? Will this be by the owner?		HVAC	Propane Tank: Refer to Spec Section 221123, paragraph 3.7. Contractor shall fill the tank upon Project turn over. Contractor shall be responsible for propane used for testing and startup.
2.25				The construction fence must be 6'-0" high therefore the existing fence would not be acceptable.
3-25	sides of the site per note 2 on C-101?	C-101		Assumptions will have to be made by the Site Contractors based on the geotechnical report.
3-26	Reference Sitework Scope of Work Item #60, please clarify the quantity of onsite material to be reused.			
2 27	Please clarify the extent/limit for the 12" sand layer shown in the site details. Does it extend beneath all athletic areas? The Geotech report states that the sand layer should extend 25' past the athletic fields in all directions but this is not shown on the plans. A drawing showing the			Refer to Addendum No.3
	3-21 3-22 3-23	Please advise if Nelson could be added as an approved manufacturer for the heat trace if they can meet the spec? Currently only 1 of 3 approved manufacturers typically quotes projects in CT. Trane has requested to be added as an approved contractor for the controls, please advise if this is acceptable? Are there any associated CAD fees with signing over the release forms from the Architect to start our 3D coordination? Sitework Scope of Work #46 states the construction fence is to be 6' tall, note 2 on C-101 states to reuse the existing fence to all extents possible. Is it acceptable to reuse the existing 4' high existing fence as a construction fence on the East, South & West sides of the site per note 2 on C-101? Reference Sitework Scope of Work Item #60, please clarify the quantity of onsite material to be reused. Please clarify the extent/limit for the 12" sand layer shown in the site details. Does it extend beneath all athletic areas? The Geotech report states that the sand layer should extend 25' past the athletic fields in all directions but this is not shown on the plans. A drawing showing the	Question Assumption Please advise if Nelson could be added as an approved manufacturer for the heat trace if they can meet the spec? Currently only 1 of 3 approved manufacturers typically quotes projects in CT. Trane has requested to be added as an approved contractor for the controls, please advise if this is acceptable? Are there any associated CAD fees with signing over the release forms from the Architect to start our 3D coordination? Who owns filling the fuel oil tanks with fuel oil? Will this be by the owner? Sitework Scope of Work #46 states the construction fence is to be 6' tall, note 2 on C-101 states to reuse the existing fence to all extents possible. Is it acceptable to reuse the existing 4' high existing fence as a construction fence on the East, South & West sides of the site per note 2 on C-101? Reference Sitework Scope of Work Item #60, please clarify the quantity of onsite material to be reused. Please clarify the extent/limit for the 12" sand layer shown in the site details. Does it extend beneath all athletic areas? The Geotech report states that the sand layer should extend 25' past the athletic fields in all directions but this is not shown on the plans. A drawing showing the	Question / Assumption Question and/or Answer Answer

			DWG REF in Question and/or	SPEC REF in Question	
Addendum	Item	Question / Assumption	Answer	and/or Answer	RESPONSE
ADD-3	3-28	Equal or Substitution Request: Section 09 64 60, Wood Athletic Flooring Action Floor Systems Anchor Flex-Din - PUR certified floor system submitted for consideration as an equal to Robbins Bio-Channel Star system.		09 64 60 Wood Athletic Flooring	Specification to remain with the three manufactures as specified.
ADD-3	3-29	Drawing A2-2-4/A2-2-5 show two scoreboards 8'-0" x 6'-0". Spec section 116643 Scoreboards 2.3 A. 1 calls for a 10'-0" x 6'-0" scoreboard. Please confirm that we are to carry the scoreboard called out in the specifications.	A2-2-4 A2-2-5	11 66 43	Refer to Specifications.
ADD-3	3-30	Drawing EQ 2.10 shows a note calling for anchors to be set in concrete for the Twin Vanity Units to be installed. Which bid package owns these anchors?	EQ 2.10		The concrete anchors shown for the Twin Vanity shall be furnished by the General Trades Contractor and installed by the Concrete Bid Package.
ADD-3	3-31	Drawing AF1-1-1A shows interior and exterior grille at Vestibule A131. These are not shown on the architectural floor plans. Please confirm whether there are entrance grilles at this location or not.	AF1-1-1A		Provide grills as indicated on AF1-1-1A.
ADD-3	3-32	Who is responsible for the wood framing shown on S1-1-ME?	S1-1-ME		The wood framing for the Carpentry Shop is provided by the General Trades Contractor.
ADD-3	3-33	In the Scope of Work Bid Package #10R Acoustical its states "45. This bid package subcontractor shall provide all illuminated perforated metal screens required by contract documents but not limited to 2/A221." Please confirm this is in the wrong section and the acoustical package is not responsible for this.	A2-2-1	Bid Package No. 10R Acoustical Bid Package No. 06R General Trades	Refer to Addendum No.3. The Illuminated Perforated Metal Screen is described under Section 101400.3, Signage Drawings, Sign Type 41. This Specification Section is under the General Trades scope of work (Bid Package No. 06R)
ADD-3	3-34	Spec Section 097730 Interior Wall Panels, Part 1, Section 1.3, Letter D, Number 2. Please clarify where the "graphics" are and what/where the "HPS panels printed in color".		09 77 30 Interior Wall Panels	Refer to Addendum No.3

ltem	Question / Assumption	DWG REF in Question and/or Answer		RESPONSE
3-35	Spec Section 097730 Interior Wall Panels, Part 2, Section 2.3, Letter A. It calls for "Pixel-Celebration Wall Panels". Pixels are an image made from perforations. Please show where those are located on the drawings and provide an image.		09 77 30 Interior Wall Panels	Refer to Addendum No.3
	for one type of glass where as the frames shown on A6-3-1 through A6-3-10 contradict the glass schedule and shows other glass. A couple examples being CW12 on A6-3-2 is calling for SG glass in the frame. Door schedule shows this as IG. Another one is CW3 shown on A6-3-1 shows door glass to be GX1 (not labeled per general notes glass would then be GX1 for exterior) however this glass on the door schedule is shown as	A6-2-1, A6-2-2		
3-36	Bold are in question.	A6-3-10		Refer to Addendum No.3
	3-35	Spec Section 097730 Interior Wall Panels, Part 2, Section 2.3, Letter A. It calls for "Pixel-Celebration Wall Panels". Pixels are an image made from perforations. Please show where those are located on the drawings and provide an image. The glass shown in the door schedule openings drawings A6-2-1 & A6-2-2 do not match up with what the CW, SF & ISF types shown on drawings A6-3-1 through A6-3-10. Doors in question are A105.1, B162.3, B157.1, B157.2, B157.3, S5.2, A101.2, A105.2, B106, B126.1, B126.2, B155, B157.4, B157.5, B157.6, C109, C134, B162.2 & C219. Door schedule calls for one type of glass where as the frames shown on A6-3-1 through A6-3-10 contradict the glass schedule and shows other glass. A couple examples being CW12 on A6-3-2 is calling for SG glass in the frame. Door schedule shows this as IG. Another one is CW3 shown on A6-3-1 shows door glass to be GX1 (not labeled per general notes glass would then be GX1 for exterior) however this glass on the door schedule is shown as SG. Please review and advise on the glass types for these doors. Doors in	Question / Assumption Spec Section 097730 Interior Wall Panels, Part 2, Section 2.3, Letter A. It calls for "Pixel-Celebration Wall Panels". Pixels are an image made from perforations. Please show where those are located on the drawings and provide an image. The glass shown in the door schedule openings drawings A6-2-1 & A6-2-2 do not match up with what the CW, SF & ISF types shown on drawings A6-3-1 through A6-3-10. Doors in question are A105.1, B162.3, B157.1, B157.2, B157.3, S5.2, A101.2, A105.2, B106, B126.1, B126.2, B155, B157.4, B157.5, B157.6, C109, C134, B162.2 & C219. Door schedule calls for one type of glass where as the frames shown on A6-3-1 through A6-3-10 contradict the glass schedule and shows other glass. A couple examples being CW12 on A6-3-2 is calling for SG glass in the frame. Door schedule shows this as IG. Another one is CW3 shown on A6-3-1 shows door glass to be GX1 (not labeled per general notes glass would then be GX1 for exterior) however this glass on the door schedule is shown as SG. Please review and advise on the glass types for these doors. Doors in	Question Assumption Spec Section 097730 Interior Wall Panels, Part 2, Section 2.3, Letter A. It calls for "Pixel-Celebration Wall Panels". Pixels are an image made from perforations. Please show where those are located on the drawings and provide an image. The glass shown in the door schedule openings drawings A6-2-1 & A6-2-2 do not match up with what the CW, SF & ISF types shown on drawings A6-3-1 through A6-3-10. Doors in question are A105.1, B162.3, B157.1, B157.2, B157.3, S5.2, A101.2, A105.2, B106, B126.1, B126.2, B155, B157.4, B157.5, B157.6, C109, C134, B162.2 & C219. Door schedule calls for one type of glass where as the frames shown on A6-3-1 through A6-3-10 contradict the glass schedule and shows other glass. A couple examples being CW12 on A6-3-2 is calling for SG glass in the frame. Door schedule shows this as IG. Another one is CW3 shown on A6-3-1 shows door glass to be GX1 (not labeled per general notes glass would then be GX1 for exterior) however this glass on the door schedule is shown as SG. Please review and advise on the glass types for these doors. Doors in A6-3-1 thru



6020 **Bid Phase Meeting** Attendance Log

DCS Project No.:	BI RT 878 CMR	Meeting Purpose:	
Date:	11.19.19	☑ Pre-Bid Meeting	
Meeting Start Time:	10:00a.m.	☐ Post Bid Review Meeting	
Meeting Location:	Platt Technical High School 600 Orange Ave Milford Ct	☐ Other:	
lame: Tony Logobic Company/Department:	10	Title: ASSISTANT PROJECT MANA	GER
company/Department: THE MORGANTI GRO	JP, INC ASSIST PM	E-mail: al ogodicio Emorganti.	
Street:		Phone:	Mina (Size
City/State/Zip DANBURY, CT 064); SUITE 0 210; ZHO FL	FAX: 830 3324	
Name: Ed Hellauar		Title: Chief Estimator	
Company/Department:	rrera Const.	E-mail:	ageta.
Street: 154 Christi	The strength of the state of the strength of t	E-mail: EdH@querrerace Phone: 203-888-500	10
011 101 1 171	CT 0648	FAX:	1111111111
Name:	New Assessment of the second o	Title:	
Tsakela VIII amil		Estimator E-mail:	6156 14 100 0
Pt T (leaning Serv	ice	isabela a pandickaningser	vice lon
Street: 19 D Andower Di		Phone:	
Pity/State/7in		860-216-9155 FAX:	
West Hartford,	CT 06110.		
Name: MONTE R	USSO.	Title:	
Company/Department:	J CONSTRUCTION	E-mail: WONTE DAJPAVING	com
Street: 150 LAURE	LHILL RA	Phone: 203-775-1385	15 4 11.75
City/State/Zip BROOKF	ELD CT 06804	FAX: 203.775-5816	A CONTRACTOR OF THE CONTRACTOR
Name: ROGER WAR!		Title:	
Company/Department:		E-mail:	
MAPHON COR		Phone:	cong
21 00550 20308	y Town RD	860 242 0743	M. P. STORES
City/State/Zip BL>>M FIELD	CT	FAX: 86> 242 1493	
lame: Kalph Vavala		Title: Project Manager	174 30 13.65
company/Department:	Manager No.	E-mail:	
treet:	impenies	Phone:	i'on .com
185 Pepper St	reet	213-8386-0123	
ity/State/Zip		FAX:	



6020 Bid Phase Meeting Attendance Log

Page __ of _

DCS Project No.:	BI RT 878 CMR	Meeting Purpose:
Date:	11.19.19	☑ Pre-Bid Meeting
Meeting Start Time:	10:00a.m.	☐ Post Bid Review Meeting
Meeting Location:	Platt Technical High School 600 Orange Ave Milford Ct	☐ Other:
Name: BRAN Sm	1)774	Title: PM
Company/Department:	NC	
Street:	100	Phone:
Street: (43 Russe) Sy City/State/Zip	L.	203-469-7487
NEW Haven C	T 06513	FAX:
-Name:		Title:
Robert Howard		ODS Mgr.
Company/Department:		E-mail: INITO ENEROSLICONET
Street:		Phone
50 BUDILTY PD		(206) 571-3800 FAX:
NEWINGTON, CT	06111	FAA.
Name: VIN GIRDANO	`	Title: Pm
Company/Department:	1	E-mail:
Company/Department:	ONSTRUCTION	IMS Pringle a facility
Street: 721 MOUNT AL 18	그 사람들은 그리고 있는데 아니라 가장 하나 아니라 하는데 하는데 하는데 되었다.	Phone: 203-498-7264
City/State/Zip BRANFORD	CT. 06405	FAX: 203-491-57/4
NAME OF TAXABLE PARTY OF TAXABLE PARTY.	CI. 06 (05	23 (01)10
Name: Carlos Szvill	Q	Title: Estimating
Company/Department:		E-mail:
CT Corpentry (co	reporation	Phone:
1850 Silas Dean	e Highway	860-571-8812
City/State/Zip Rocky Hill, CT	. 06067	FAX: 860 - 571-8891
Name: herin Go	ertin	Title:
Company/Department:	^	E-mail:
Roofers 2 Wate	14	Kevina noolers loval 12
19 Dern how	d Rd	Phone: 203-707-4424
	aven CT 0647.	
Name:		Title:
Company/Department:		E-mail:
Street:		Phone:
City/State/Zip		FAX:

Bid Phase Meeting Attendance Log Page of

DCS Project No.:	BI RT 878 CMR	Meeting Purpose:
Date:	11.19.19	☑ Pre-Bid Meeting
Meeting Start Time:	10:00a.m.	☐ Post Bid Review Meeting
Meeting Location:	Platt Technical High School 600 Orange Ave Milford Ct	☐ Other:
Name: Gary BA	bodeuck	Title: PM
Company/Department:	0	E-mail: gbrodericko a secondino and son. Con
Street: 21 apon 16	d	Hone: 3-481-3496
City/State/Zip Blanford 04465		FAX: 203-483-8804
Name: Joe Nuzzvillo,		Title: PM
Company/Department:		E-mail: NUZZOLillo emanafor Co
Street: 44 Kew British Ase		Phone: 860 - 229 - 4853
City/State/Zip Planuill	e CT 06062	FAX: 860.747-4861
	ughlin (For Sumi oldn	Title: PE
Company/Department: Construction Company		y Soldman @ banton construction
339 Washing	aton Ave	Phone: 303 234 3353
City/State/Zip North Have	n CT 06473.	FAX: 203 234 0010
Name: Ru CAR	Roll	Title: Sellor PK
Company/Department:	Electric	E-mail: VCLEROLLE Custon Electrica
Street: 52 Mai	o, St	Phone: 860 - 643 - 7110
City/State/Zip	tee Ct 06042	FAX:
Name: Marco Haha		Title:
Company/Department:	struction. Inc.	E-mail: Mhahn@allstate constructionine com
Street: 449 Cooke St	The state of the s	Phone: 860-515-1296
City/State/Zip	332	FAX:
Name: Pablo Uillari	rcol	Title:
Company/Department:	2	E-mail: confortational I don' 952 vic
Street:	ver Dr.	Phone: 260, 216- 9155
City/State/Zip	Hord et derio	FAX: 860 - 308, 7566
A	ud on (welson	



6020 Bid Phase Meeting Attendance Log

Page of

DCS Project No.:	BI RT 878 CMR	Meeting Purpose:
Date:	11.19.19	☑ Pre-Bid Meeting
Meeting Start Time:	10:00a.m.	☐ Post Bid Review Meeting
Meeting Location:	Platt Technical High School 600 Orange Ave Milford Ct	Other:
Name: MIKE GERA	ng nya	Title: ESTIMATOR E-mail: MikeGa Sillctown you
Company/Department: \$\int \int \int \int \int \int \int \int		E-mail: Mike G @ Sille town you
Street:		Filone.
City/State/Zip h = P V S		203-735-0552
City/State/Zip DERBY	CF	FAX:
Name:		Title: Estimator
Evan Gerber Company/Department:	Constitution and suppose and suppose	
Gerber Co	nstruction Inc.	E-mail: evancaerberconstruction inc.com
Street:		Phone:
City/State/Zip		860 604 7548 FAX:
Ellington,	CT 06029	The second secon
Name: TLE F	ries	Title: DM
Company/Department:	ries	E mail:
company/Department.	Duterso	E-mail: Thries@Camputercondson
Street: Cote	Crise Dr	Phone: 203 887 1972
City/State/Zip \ 1	13130	FAX:
N. Bra	mord CT OG 471	1700
Name: MATT PEACE	20/1	Title: PN
Company/Department:		E-mail:
KBE BUILDING	(CA FOR STOTE OF CT)	MPEACOCK CKBEBUILDING COM
Street: 76 Batterson P		Phone:
City/State/Zip	arcic Roas)	860-878-5015 FAX:
FARMINGTON, CT		1740
Name: Slo		Title: VP Uperations
Company/Department:		VY Operations
CT Temperature	Controls	E-mail: MSullo Oct Tenpentrols con
Street:		Phone:
500 Corporate	Kow	800 850 2022
06416		FAX:
Name:		Title:
Leff Buckly		Es Lm. W
Company/Department:	w natel To-	E-mail:
Stroet:		Phone:
18 N. CLNO S	> —	Phone: (413) 727-2170 FAX:
City/State/Zip		FAX:

Bid Phase Meeting Attendance Log Page of

	DCS Project No.:	BI RT 878 CMR	Meeting Purpose:
	Date:	11.19.19	□ Pre-Bid Meeting
	Meeting Start Time:	10:00a.m.	☐ Post Bid Review Meeting
	Meeting Location:	Platt Technical High School 600 Orange Ave Milford Ct	☐ Other:
25	Name: COARY CLEVERY	Ю	Title: PROJECT MANAGER
	Company/Department:		E-mail: Golevelandemproanti.com
	Street:	SUITE D 210	Phone: 8 56 - 813 - 02-16
	City/State/Zip DANBURY CT 00		FAX:
26	Name: JOHN AMBRA		Title: SUPERINTENDENT
	Company/Department: MORGANT) Street:		E-mail: jambora emorganti. com Phone: 203.994-2432
	600 ORTNGE AVE City/State/Zip MILFOLD CT 06		203.994-2432 FAX:
77	Name:		Title:
27	STEVE LONG Company/Department: OAS CONSTRUCT		PROJECT MANAGER
	Street: 450 COWMBUS		Phone: 860.713-5751
	City/State/Zip HARTFORD, CT		FAX:
28		LESCA	Title: PRINCIPAL
	Company/Department: 日のヒ かにFo Street:		E-mail: david, telesca ect.gov
	GOO ORANGE , City/State/Zip		Phone: 203 - 783 - 5304 FAX:
20	MLFORD , CT		Title:
29	VLADIMIR LYC	BETSKY	ARCHITECT
	Street: 225 OAKLAND R	Oko	Phone: 860-644. 8300
	City/State/Zip 5 OUTH WINDSOR		FAX:
30	Name:		Title:
	Company/Department:		E-mail:
	Street:		Phone:
ŀ	City/State/Zip		FAX: