
Hebron Elementary School Contaminated Water Piping Replacement

92 Church Street
Hebron, Connecticut 06248



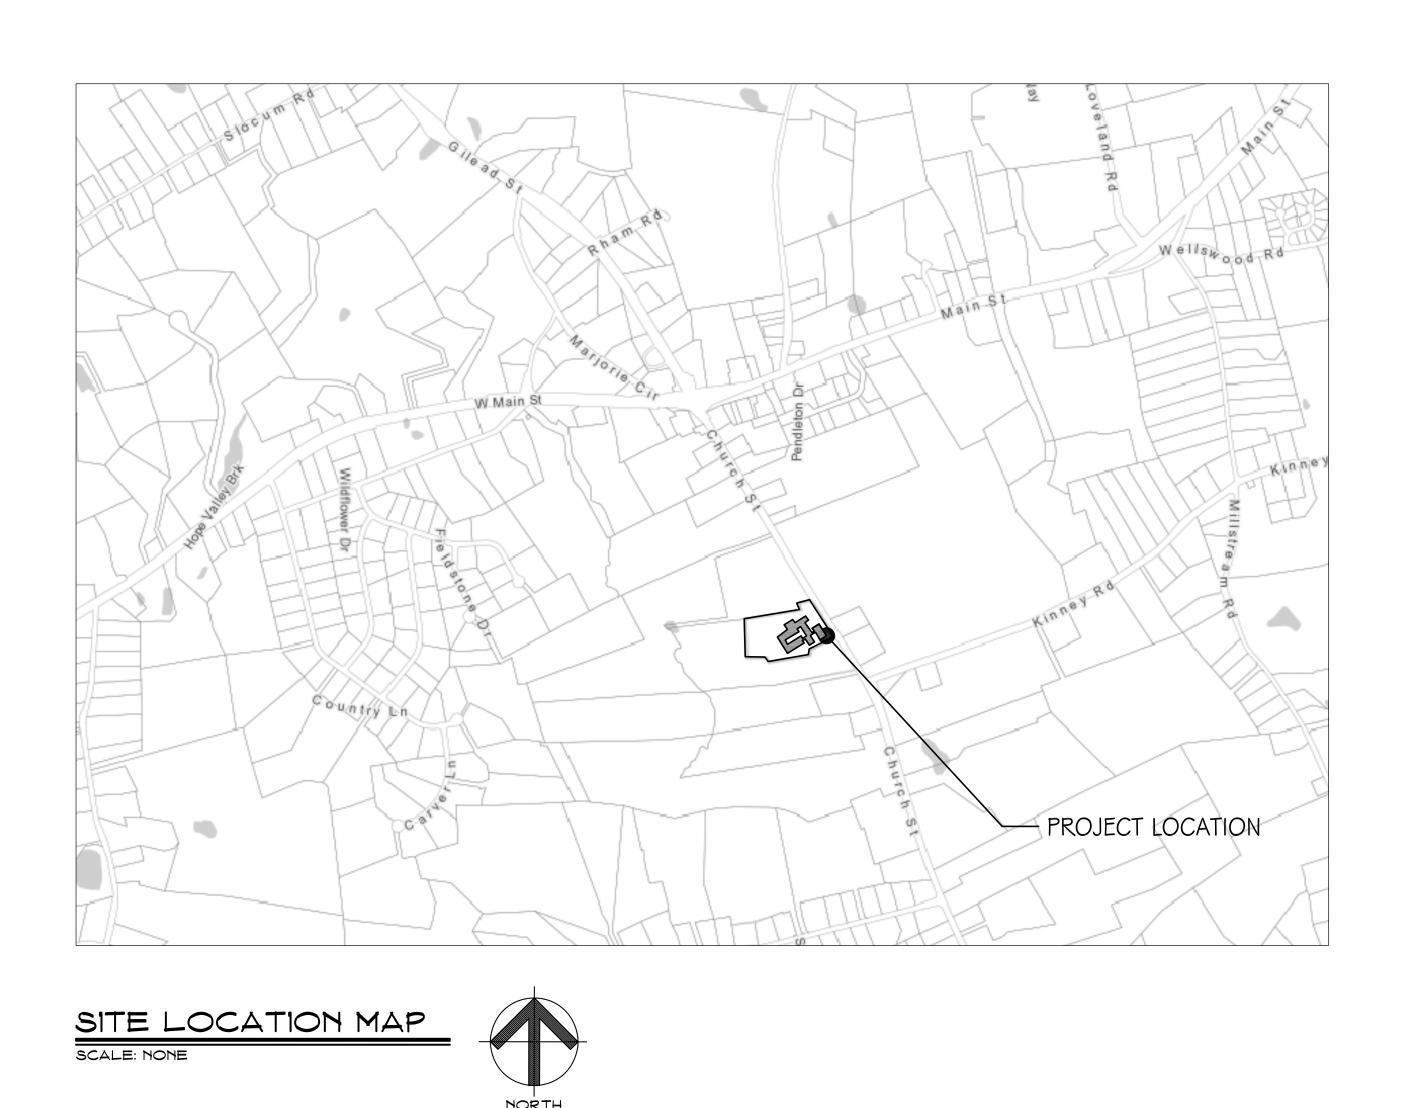




SILVER / PETRUCELLI + ASSOCIATES


Architects / Engineers / Interior Designers

3190 Whitney Avenue, Hamden, CT 06518-2340 One Post Hill Place, New London, CT 06320 Tel. 203 230 9007 Fax. 203 230 8247 silverpetrucelli.com

State Project Number: 067-0042 CV

August 16, 2019

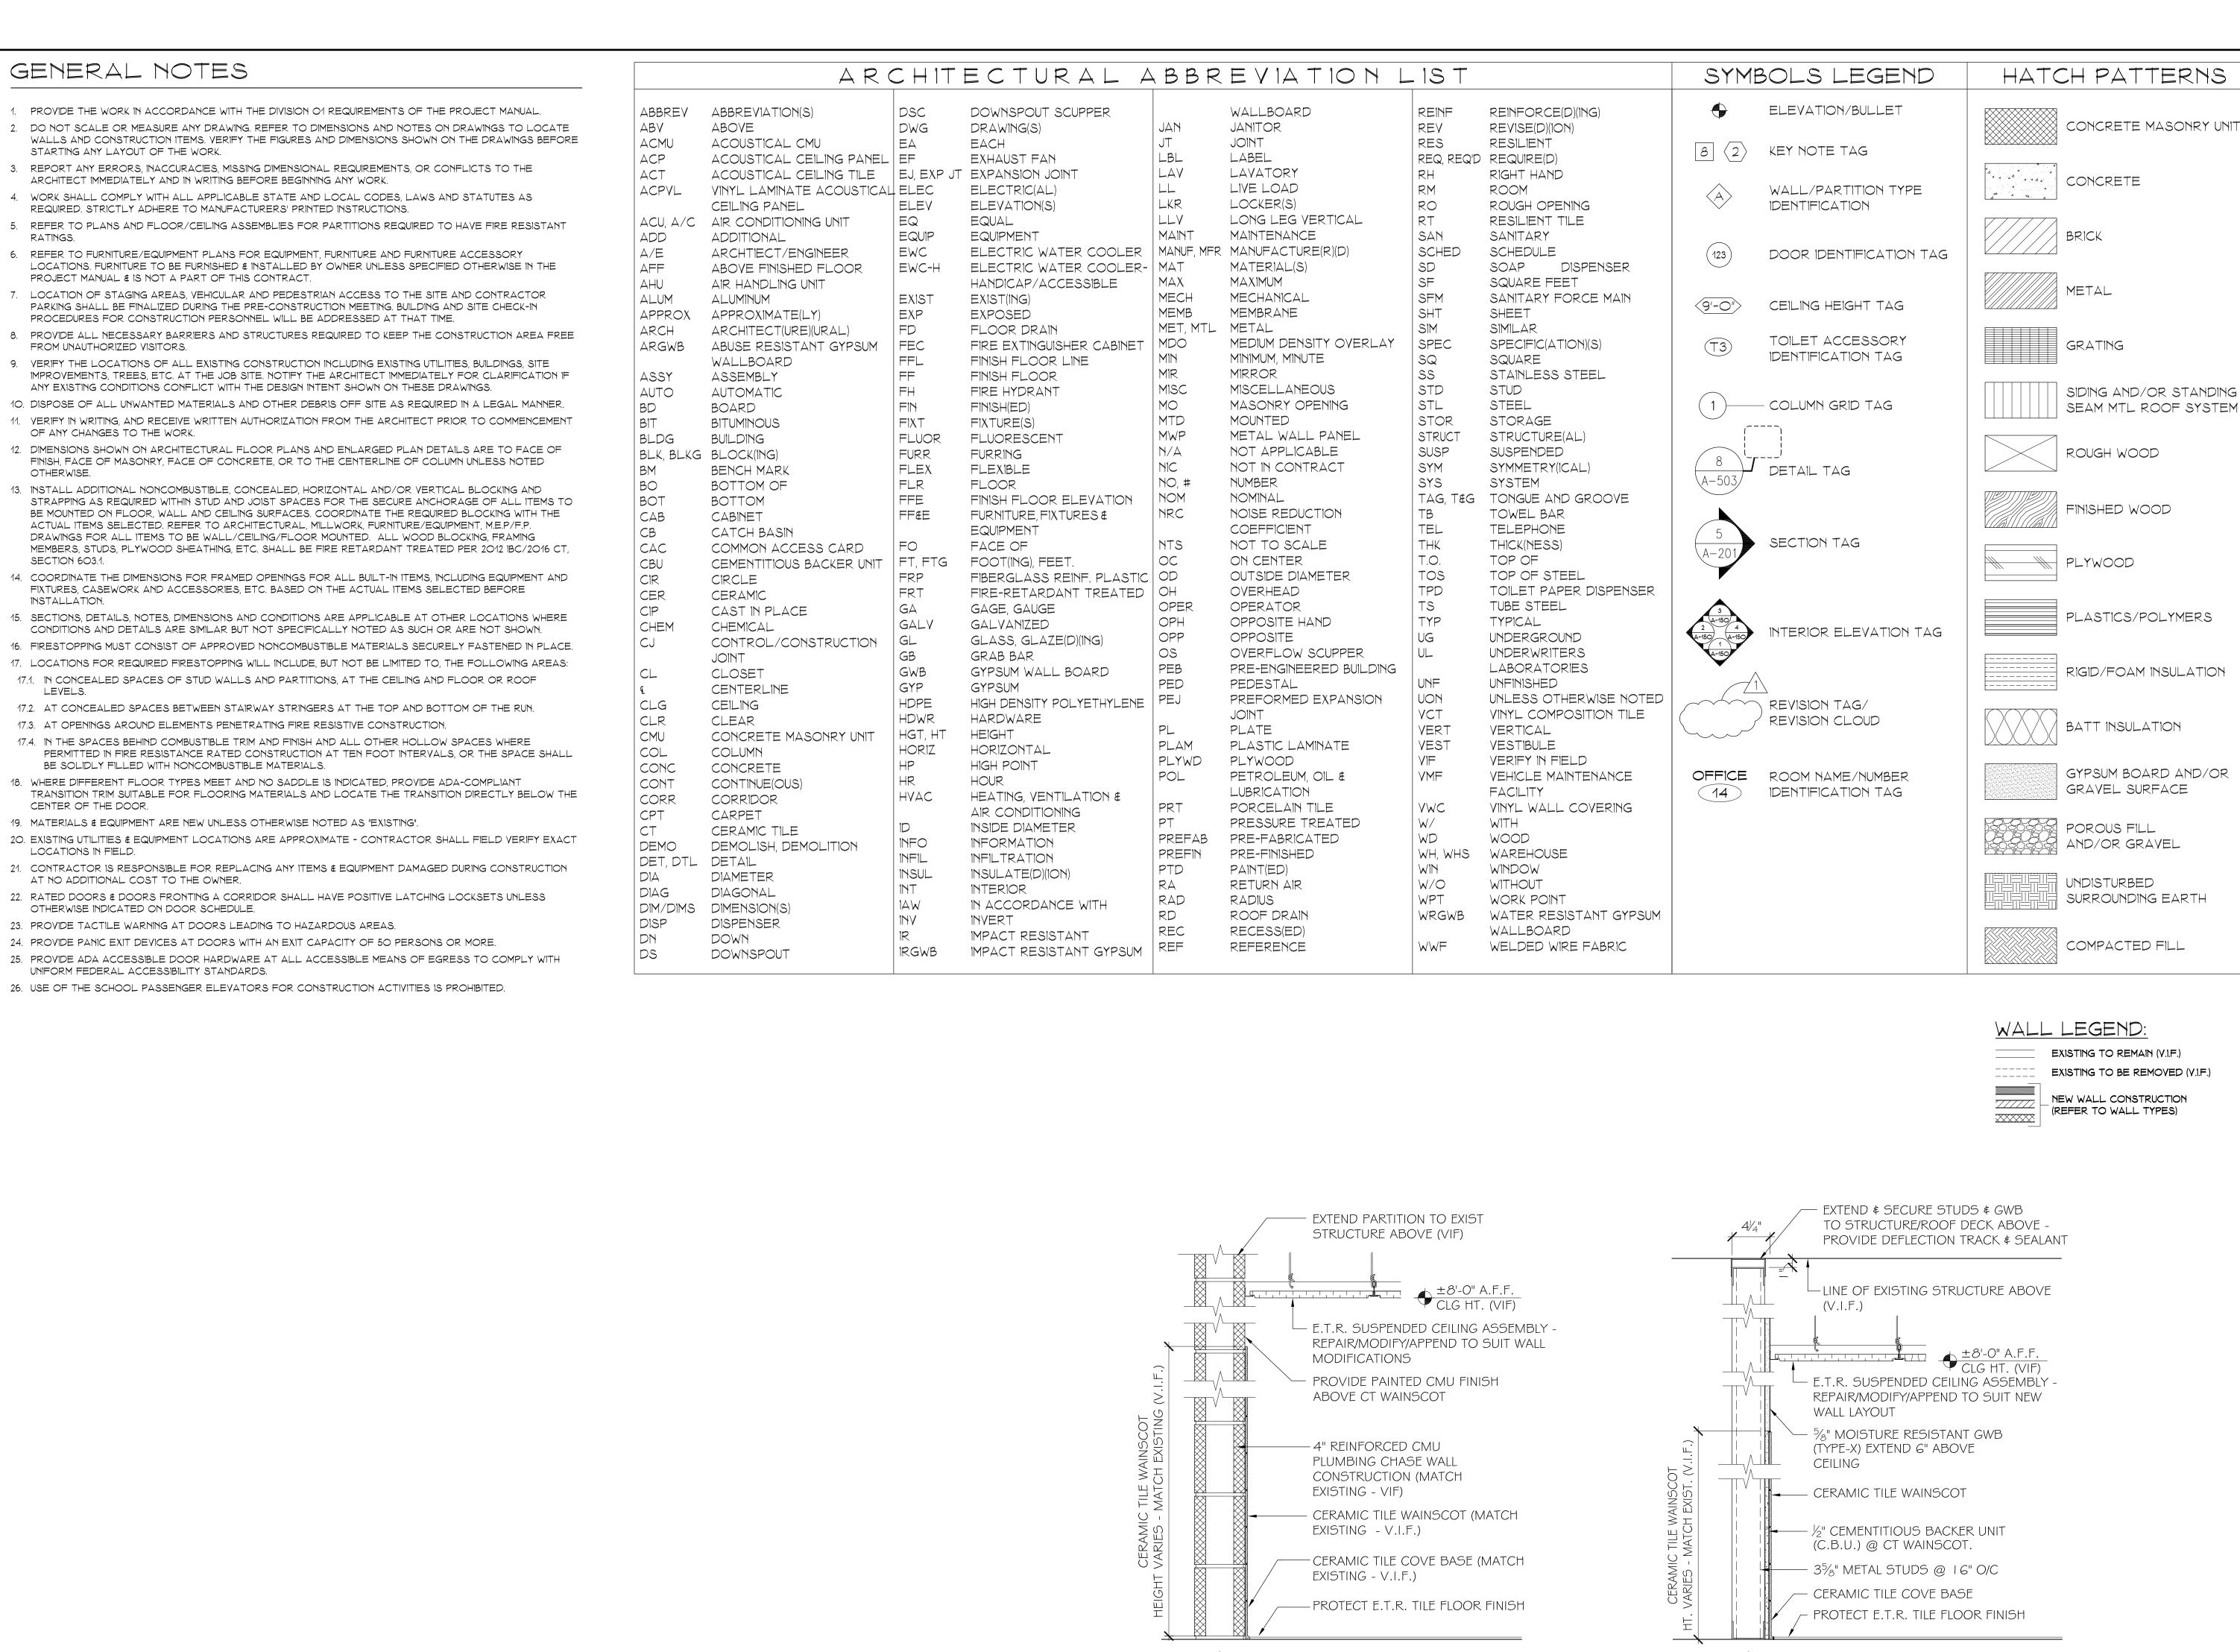

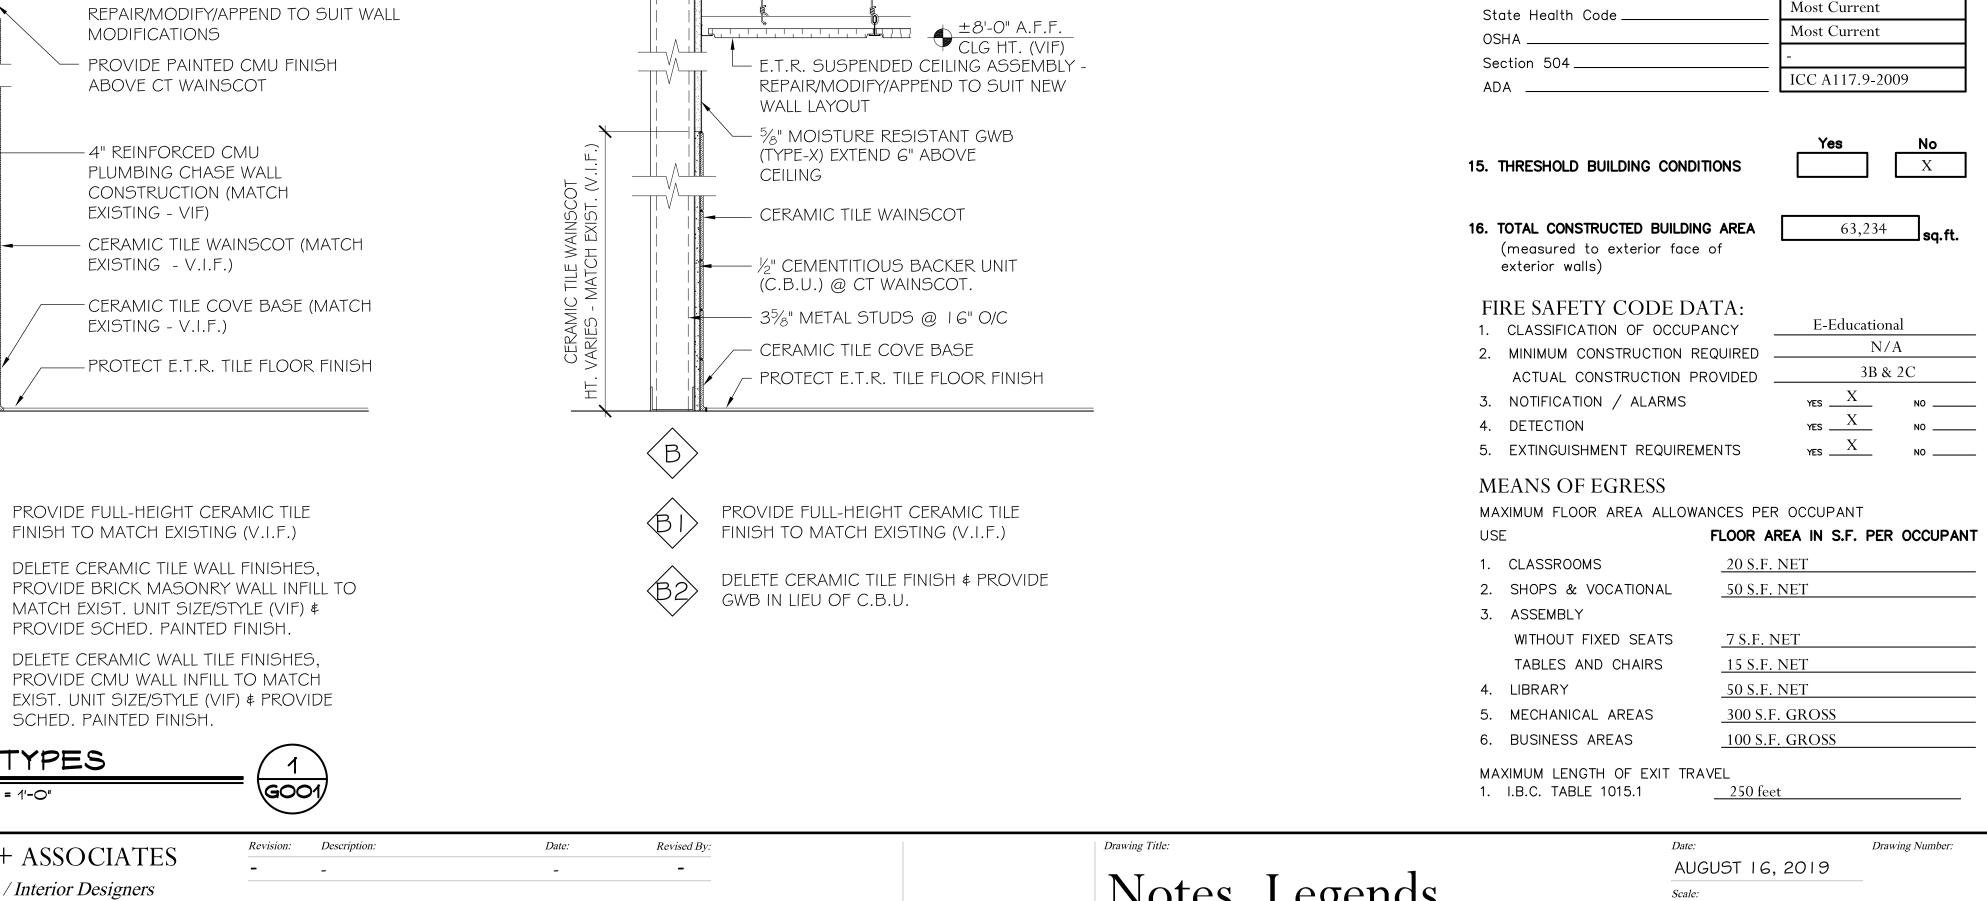

Hebron Elementary School

Contaminated Water Piping Replacement

92 Church Street
Hebron, Connecticut 06248



SILVER / PETRUCELLI + ASSOCIATES

Architects / Engineers / Interior Designers

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One Post Hill Place, New London, CT 06320
Tel. 203 230 9007 Fax. 203 230 8247
silverpetrucelli.com

WALL TYPES

SCALE: 1-1/2" = 1'-0"



Notes, Legends, Wall Types & Code Info.

Date:

AUGUST 16, 2019

Scale:

AS NOTED

Drawn By:

RH

S/P+A Project No: State Project No:

067-0042 CV

19.003

CODE INFORMATION

DATE OF ORIGINAL CONSTRUCTION

DATES OF ADDITIONS

(Primary

(Incidental).

USE GROUP CLASSIFICATION

2. CONSTRUCTION TYPE (Chapter 6)

Actual Type Provided (new)_

Allowable Height (story/feet) —

(Stories Above Grade)_

Actual Height (story/feet) __

a) Building Area (Basement)

Existing construction____

New construction_____

b) Building Area (1st Floor)

Existing construction_____

New construction_____

Existing construction_____

New construction____

Existing construction_____

6. CASE 1 - SINGLE OCCUPANCY OR NONSEPARATED USES (302.3.1)

8. FIRE-RESISTANCE RATED REQUIREMENTS FOR BUILDING ELEMENTS

(Table 601, See Code Plans for specific designations)

7. CASE 2 - MIXED OCCUPANCY SEPARATED USES (302.3.2)

Total floor _____

c) Building Area (2nd Floor)

Total floor _____

d) Building Area (all floors)

Total floor .

New construction_____

5. AREA MODIFICATIONS TO TABLE 503

1 Structural frame: including

2 Bearing walls:

Exterior ____

Table 602

beams & joists) __

beams & joists) __

9. OCCUPANCY LOAD N/A

10. MODIFICATIONS

N/A

11. ACCESSIBLE BUILDING

13. SPRINKLER PROTECTION

columns, girders, trusses _____

3 Nonbearing walls & partitions (Exterior)

4 Nonbearing walls & partitions (Interior

5 Floor Construction (including supportin

6 Roof Construction (including supporting

14. CODES TO WHICH THIS PROJECT WAS DESIGNED

State Building Code w/Supplement _

State Building Code w/Supplement _

State Fire Code w/Supplement _

State Fire Code w/Supplement _

Minimum Type Required

3. BUILDING HEIGHT (Chapter 5)

4. BUILDING AREA (Chapter 5)

Total floor _____

1943

1953, 1987, 1999

E-Educational

A3

3B

2B & 3B (N/A)

2/30'-0"

1/18'-0"+7

2,440 sq.ft.

2,440 sq.ft.

60,455 sq.ft.

60,455 sq.ft.

0 sq.ft.

0 sq.ft.

0 sq.ft.

0 sq.ft.

0 sq.ft.

sq.ft.

62.895 sq.ft.

62,895 sq.ft.

(Allowable Area 506.4)

0 / 0

0 / 0

0 / 0

0 / 0

0 / 0

0 / 0

Designated

Non Designated

Entire Building

Limited Area

2015 IEBC/2018 CT

2015 IFC/2018 CSFSC

2018 CT

2018 CSFPC

(Allowable Area 506.4)



GENERAL NOTES

- CONTRACTOR IS REQ'D TO VISIT THE SITE \$ BECOME FULLY FAMILIAR WITH THE EXISTING CONDITIONS AND THE SCOPE OF WORK PRIOR TO SUBMITTING A BID.
- 2. COORD. WORK WITH HAZMAT REPORT. REFER TO PROJECT MANUAL FOR ADDITIONAL INFORMATION.
- CONTRACTOR IS RESPONSIBLE FOR PROVIDING NEGATIVE AIR DUST CONTROL MEASURES AND TEMPORARY DUST CONTROL BARRIERS AT AREAS OF WORK AS REQ'D TO PREVENT DUST FROM ESCAPING THE WORK AREA & CONTAMINATING ADJACENT AREAS BEYOND THE SCOPE OF WORK.
- CONTRACTOR IS RESPONSIBLE FOR PROTECTING EXISTING FURNITURE, FIXTURES, EQUIPMENT, AND FURNISHINGS FROM DUST & CONSTRUCTION ACTIVITY. TEMPORARILY REMOVE ITEMS AS REQ'D TO PROVIDE THE WORK & REINSTALL UPON COMPLETION OF WORK. PROTECT \$ TEMPORARILY RELOCATE ITEMS WITHIN THE ROOM FROM WHICH THEY ORIGINATE.
- CUTTING & PATCHING WORK SHOWN ON ARCHITECTURAL DRAWINGS IS LIMITED TO PROJECT SCOPE OF WORK LOCATIONS WHERE MORE EXTENSIVE CUTTING & PATCHING AND/OR MODIFICATIONS/REMOVAL OF EXISTING PLUMBING CHASE WALLS ARE REQUIRED. CONTRACTOR IS RESPONSIBLE FOR CUTTING \$ PATCHING AS REQUIRED TO COMPLETE THE WORK BASED ON FULL SCOPE OF PLUMBING WORK SHOWN ON THE PLUMBING DRAWINGS AT ALL LOCATIONS WITHIN THE BUILDING.
- REFER TO M/E/P/FP DRAWINGS FOR ADDITIONAL SCOPE OF WORK. COORDINATE WORK WITH ALL TRADES.

5

DEMOLITION KEY NOTES

- REMOVE PORTION OF EXISTING CMU PLUMBING CHASE WALL CONSTRUCTION AS REQUIRED TO PROVIDE PLUMBING WORK -COORDINATE REMOVAL WITH PLUMBING \$ HAZMAT. PROTECT ADJACENT FINISHES, CONSTRUCTION & COMPONENTS THAT ARE EXISTING TO REMAIN.
- .A. REMOVE PORTION OF EXISTING BRICK MASONRY PLUMBING CHASE WALL CONSTRUCTION AS REQUIRED TO PROVIDE PLUMBING WORK - COORDINATE REMOVAL WITH PLUMBING \$ HAZMAT. PROTECT ADJACENT FINISHES, CONSTRUCTION \$ COMPONENTS THAT ARE EXISTING TO REMAIN.
- .B. REMOVE PORTION OF EXISTING MASONRY PLUMBING CHASE WALL CONSTRUCTION AT ONE SIDE OF EXISTING PLUMBING CHASE AS REQUIRED TO PROVIDE PLUMBING WORK. (NOTE: EXISTING CHASE IS ACCESSIBLE VIA FULL HEIGHT ACCESS DOOR LOCATED IN FEMALE TOILET #09, HOWEVER SPACE IS CONFINED AND ADDITIONAL ACCESS MAY BE REQUIRED VIA PARTIAL REMOVAL OF CHASE WALL CONSTRUCTION @ MALE TOILET #08 TO PROVIDE THE WORK.
- 2. REMOVE CERAMIC TILE FINISHES FROM CMU PLUMBING CHASE WALL & PREP SUBSTRATE TO RECEIVE SCHEDULE TILE FINISHES.
- TEMPORARILY REMOVE EXISTING TOILET PARTITION \$ URINAL SCREEN ASSEMBLIES. STORE, PROTECT AND PREP TOILET PARTITION \$ URINAL SCREEN ASSEMBLIES FOR REINSTALLATION IN EXISTING LOCATIONS & CONFIGURATIONS (V.I.F.).
 - 3.A. TEMPORARILY REMOVE EXISTING WALL-MOUNTED TOILET ACCESSORIES WITHIN TOILET ROOMS/COMPARTMENTS WHERE AN EXIST. TOILET ACCESSORY IS MOUNTED ON WALL CONST. TO BE REMOVED (V.I.F.) - STORE, PROTECT & PREP FOR REINSTALLATION IN EXISTING LOCATIONS.
- 1. TEMPORARY REMOVE EXISTING PLUMBING FIXTURES SALVAGE, STORE & PROTECT FOR REINSTALLATION. COORDINATE WITH PLUMBING DRAWINGS.
- 4.A. TEMPORARILY REMOVE EXISTING VANITY CASEWORK & LAVATORY -SALVAGE, STORE & PROTECT FOR REINSTALLATION. COORDINATE WITH PLUMBING DRAWINGS.
- REMOVE EXISTING LAVATORY COUNTERTOP ASSEMBLY \$ ASSOCIATED PLUMBING FIXTURES (COORD. WITH PLUMBING DRAWINGS).
- DISPENSERS & SOAP DISPENSERS STORE, PROTECT & PREP FOR REINSTALLATION.
- REMOVE EXISTING SINK/STOVE/FRIDGE COMBINATION APPLIANCE AND PREP SUBSTRATES TO RECEIVE NEW WORK.

CONSTRUCTION KEY NOTES

- INSTALL EXISTING SALVAGED TOILET PARTITION ASSEMBLIES IN EXISTING LOCATIONS & CONFIGURATIONS. PROVIDE NEW HARDWARE & FASTENERS AS REQ'D TO SECURELY ANCHOR. INSTALL EXISTING SALVAGED TOILET ACCESSORIES WITHIN EXISTING TOILET COMPARTMENTS - MATCH EXISTING LOCATIONS \$ CONFIGURATIONS (V.I.F.).
- I.A. INSTALL EXISTING PLUMBING FIXTURES IN EXISTING LOCATIONS (REFER TO PLUMBING DRAWINGS).
- I.B. INSTALL EXISTING PLUMBING FIXTURES IN NEW LOCATIONS (REFER TO PLUMBING DRAWINGS).
- .C. PROVIDE WASHSTATION ASSEMBLIES, REFER TO PLUMBING DWG'S. 2. INSTALL EXISTING, SALVAGED TOILET ACCESSORIES (MIRRORS \$ DISPENSERS) AT NEW WALL CONSTRUCTION ADJACENT TO LAVATORIES - REFER TO TYPICAL INTERIOR ELEVATION FOR MOUNTING HEIGHTS & CONFIGURATIONS.
- 2.A.INSTALL EXISTING, SALVAGED TOILET ACCESSORIES (MIRRORS \$ DISPENSERS) AT EXISTING LOCATIONS & MOUNTING HEIGHTS ON NEW WALL CONSTRUCTION.
- . MODIFY & EXTEND EXISTING SUSPENDED CEILING ASSEMBLY TO SUIT LAYOUT OF MODIFIED WALL CONSTRUCTION. PROVIDE SUSPENDED CEILING ASSEMBLY COMPONENTS (GRID, PERIMETER TRIM, TILES, ETC.) TO MATCH EXISTING (V.I.F.).
- PROVIDE CMU WALL INFILL (PAINTED) AT LOCATION OF FORMER RECESSED DRINKING FOUNTAIN & PREP FOR INSTALLATION OF NEW DRINKING FOUNTAIN. REFER TO PLUMBING DRAWINGS.
- PROVIDE PREFAB SOFFIT PIPE CHASE ASSEMBLY AT CEILING -REFER TO SOFFIT DETAILS & CORR. SECTION FOR MORE INFO.
- PROVIDE SOLID SURFACE COUNTERTOP ASSEMBLY WITH SINK \$ WALL CABINETS ABOVE - REFER TO CASEWORK DETAILS \$ PLUMBING DRAWINGS.
- PROVIDE 8" DEEP BY 24" WIDE PIPE CHASE WALL CONSTRUCTION AT CORNER OF OFFICE #07 BEHIND E.T.R. DOOR - REFER TO WALL TYPE "B2" \$ COORD. WITH PLUMBING DRAWINGS. DEPTH OF CHASE SHALL NOT EXTEND BEYOND EDGE OF E.T.R. DOOR FRAME.

Contaminated Water Piping Replacement
92 Church Street

Hebron, Connecticut 06248



3190 Whitney Avenue, Hamden, CT 06518-2340 One Post Hill Place, New London, CT 06320 Tel. 203 230 9007 Fax. 203 230 8247


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Main Level Floor Plan

Drawing Number: AUGUST 16, 2019 AS NOTED Drawn By:

067-0042 CV

S/P+A Project No: State Project No:

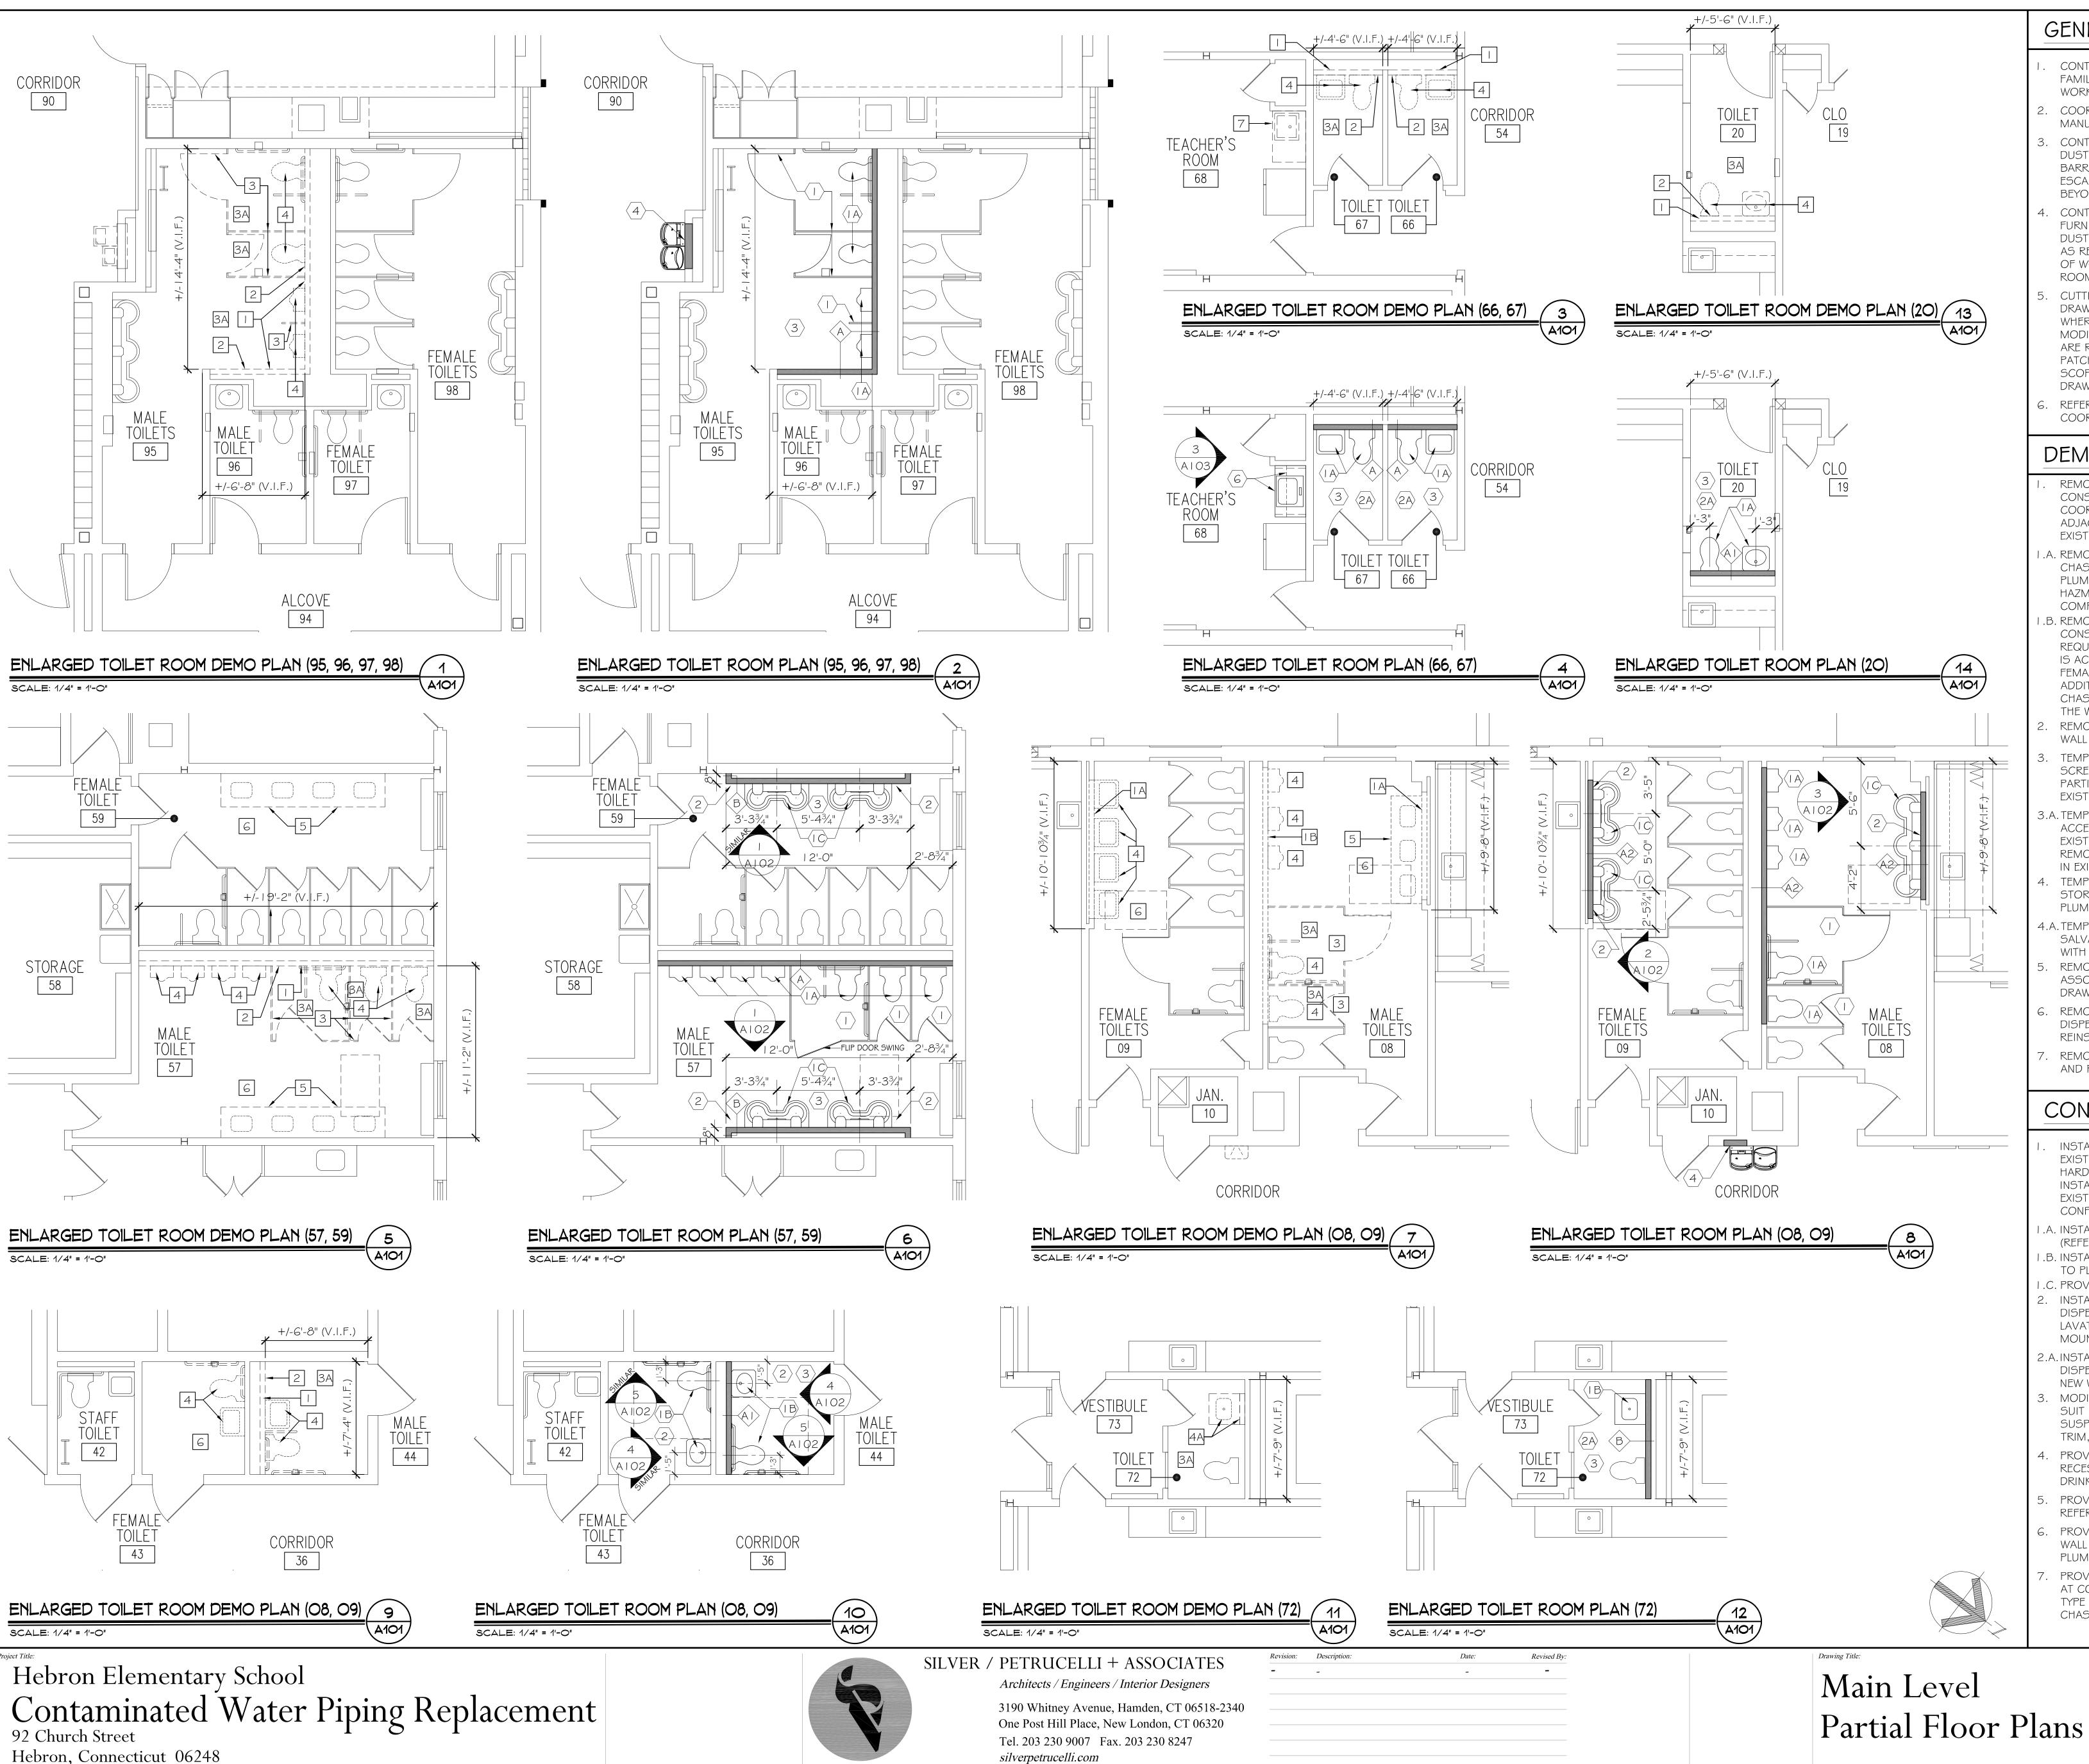

GENERAL NOTES

- CONTRACTOR IS REQ'D TO VISIT THE SITE & BECOME FULLY FAMILIAR WITH THE EXISTING CONDITIONS AND THE SCOPE OF WORK PRIOR TO SUBMITTING A BID.
- 2. COORD. WORK WITH HAZMAT REPORT. REFER TO PROJECT MANUAL FOR ADDITIONAL INFORMATION.
- CONTRACTOR IS RESPONSIBLE FOR PROVIDING NEGATIVE AIR DUST CONTROL MEASURES AND TEMPORARY DUST CONTROL BARRIERS AT AREAS OF WORK AS REQ'D TO PREVENT DUST FROM ESCAPING THE WORK AREA & CONTAMINATING ADJACENT AREAS BEYOND THE SCOPE OF WORK
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- REFER TO M/E/P/FP DRAWINGS FOR ADDITIONAL SCOPE OF WORK COORDINATE WORK WITH ALL TRADES.

DEMOLITION KEY NOTES

REMOVE PORTION OF EXISTING CMU PLUMBING CHASE WALL CONSTRUCTION AS REQUIRED TO PROVIDE PLUMBING WORK COORDINATE REMOVAL WITH PLUMBING \$ HAZMAT. PROTECT ADJACENT FINISHES, CONSTRUCTION & COMPONENTS THAT ARE EXISTING TO REMAIN.

5

- A. REMOVE PORTION OF EXISTING BRICK MASONRY PLUMBING CHASE WALL CONSTRUCTION AS REQUIRED TO PROVIDE PLUMBING WORK - COORDINATE REMOVAL WITH PLUMBING \$ HAZMAT. PROTECT ADJACENT FINISHES, CONSTRUCTION \$ COMPONENTS THAT ARE EXISTING TO REMAIN
- B. REMOVE PORTION OF EXISTING MASONRY PLUMBING CHASE WALI REQUIRED TO PROVIDE PLUMBING WORK. (NOTE: EXISTING CHASE IS ACCESSIBLE VIA FULL HEIGHT ACCESS DOOR LOCATED IN FEMALE TOILET #09. HOWEVER SPACE IS CONFINED AND ADDITIONAL ACCESS MAY BE REQUIRED VIA PARTIAL REMOVAL OF CHASE WALL CONSTRUCTION @ MALE TOILET #08 TO PROVIDE THE WORK.
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- TEMPORARILY REMOVE EXISTING TOILET PARTITION & URINAL SCREEN ASSEMBLIES. STORE, PROTECT AND PREP TOILET PARTITION & URINAL SCREEN ASSEMBLIES FOR REINSTALLATION IN EXISTING LOCATIONS & CONFIGURATIONS (V.I.F.).
- .A. TEMPORARILY REMOVE EXISTING WALL-MOUNTED TOILET ACCESSORIES WITHIN TOILET ROOMS/COMPARTMENTS WHERE AN EXIST. TOILET ACCESSORY IS MOUNTED ON WALL CONST. TO BE REMOVED (V.I.F.) - STORE, PROTECT & PREP FOR REINSTALLATION IN EXISTING LOCATIONS.
- TEMPORARY REMOVE EXISTING PLUMBING FIXTURES SALVAGE, STORE & PROTECT FOR REINSTALLATION. COORDINATE WITH PLUMBING DRAWINGS.
- 1.A. TEMPORARILY REMOVE EXISTING VANITY CASEWORK & LAVATORY SALVAGE, STORE & PROTECT FOR REINSTALLATION. COORDINATE WITH PLUMBING DRAWINGS.
- REMOVE EXISTING LAVATORY COUNTERTOP ASSEMBLY \$ ASSOCIATED PLUMBING FIXTURES (COORD. WITH PLUMBING DRAWINGS).
- REMOVE EXISTING WALL-MOUNTED MIRRORS, PAPER TOWEL DISPENSERS & SOAP DISPENSERS - STORE, PROTECT & PREP FOR REINSTALLATION.
- REMOVE EXISTING SINK/STOVE/FRIDGE COMBINATION APPLIANCE AND PREP SUBSTRATES TO RECEIVE NEW WORK.

CONSTRUCTION KEY NOTES


- INSTALL EXISTING SALVAGED TOILET PARTITION ASSEMBLIES IN EXISTING LOCATIONS & CONFIGURATIONS. PROVIDE NEW HARDWARE & FASTENERS AS REQ'D TO SECURELY ANCHOR. INSTALL EXISTING SALVAGED TOILET ACCESSORIES WITHIN EXISTING TOILET COMPARTMENTS - MATCH EXISTING LOCATIONS & CONFIGURATIONS (V.I.F.).
- .A. INSTALL EXISTING PLUMBING FIXTURES IN EXISTING LOCATIONS (REFER TO PLUMBING DRAWINGS).
- .B. INSTALL EXISTING PLUMBING FIXTURES IN NEW LOCATIONS (REFER TO PLUMBING DRAWINGS).
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- PROVIDE PREFAB SOFFIT PIPE CHASE ASSEMBLY AT CEILING .
- REFER TO SOFFIT DETAILS & CORR. SECTION FOR MORE INFO. PROVIDE SOLID SURFACE COUNTERTOP ASSEMBLY WITH SINK \$ WALL CABINETS ABOVE - REFER TO CASEWORK DETAILS \$
- PLUMBING DRAWINGS. PROVIDE 8" DEEP BY 24" WIDE PIPE CHASE WALL CONSTRUCTION AT CORNER OF OFFICE #07 BEHIND E.T.R. DOOR - REFER TO WALL


TYPE "B2" \$ COORD. WITH PLUMBING DRAWINGS. DEPTH OF CHASE SHALL NOT EXTEND BEYOND EDGE OF E.T.R. DOOR FRAME.


Drawing Number: AUGUST 16, 2019 A101 AS NOTED Drawn By:


067-0042 CV

S/P+A Project No: State Project No:

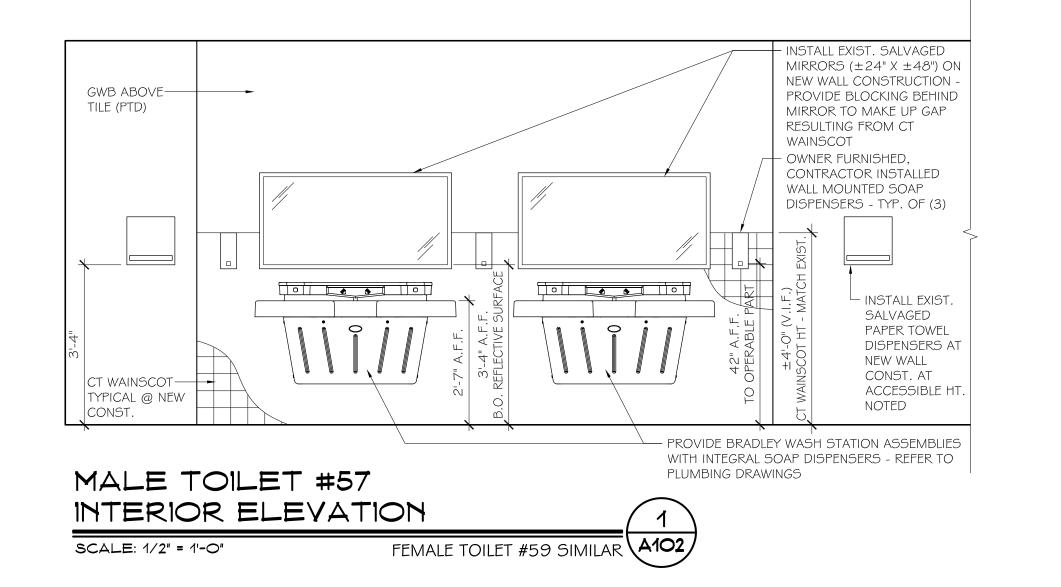

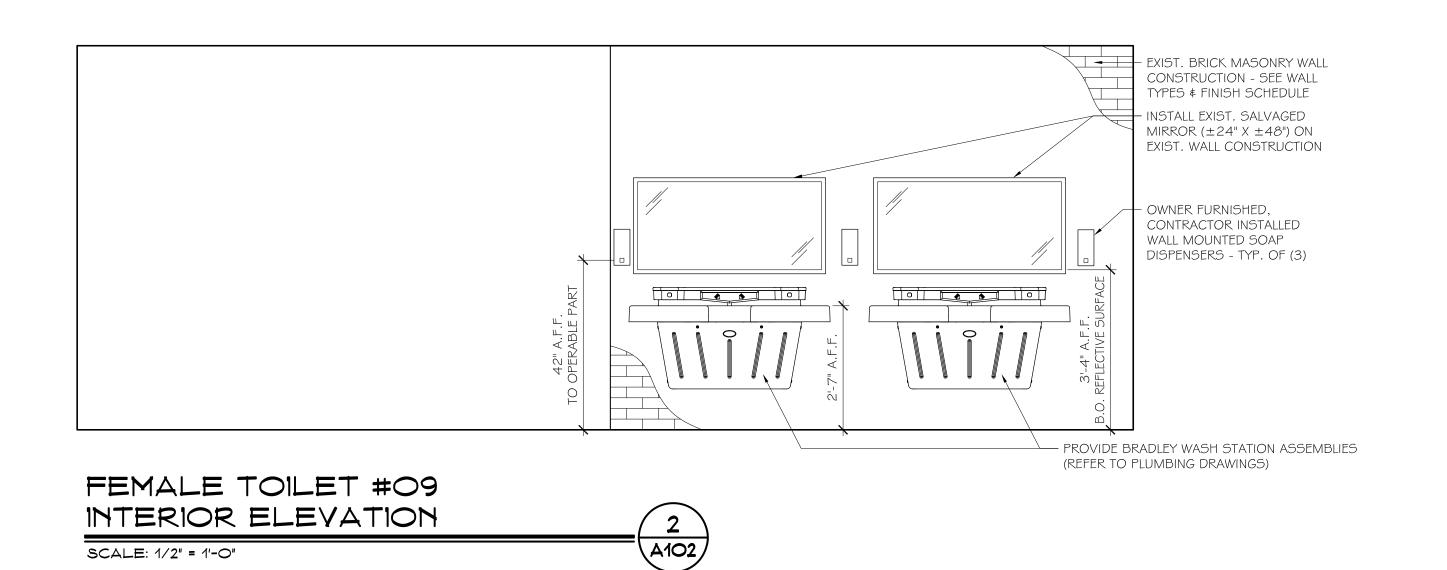

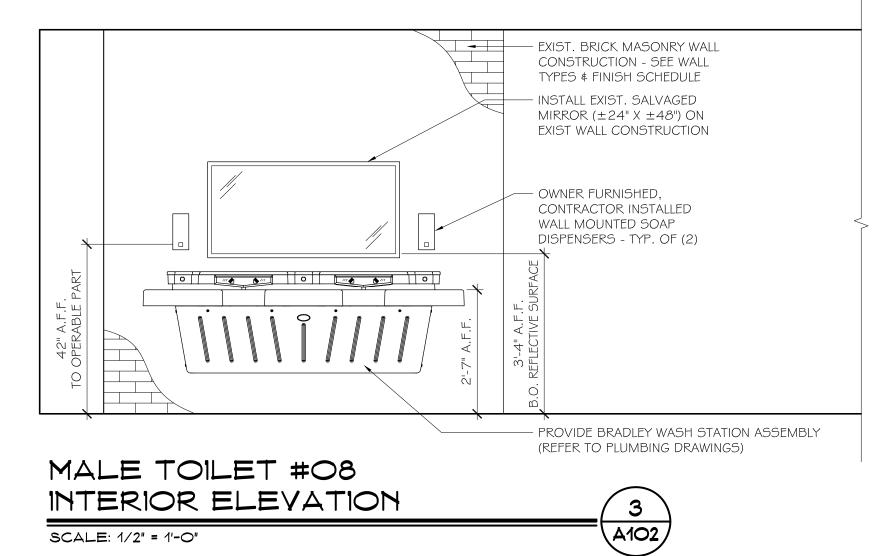


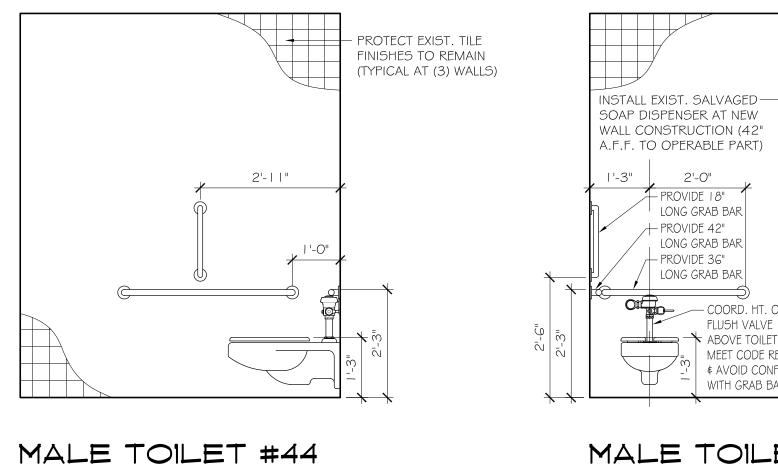

FEMALE TOILET #43 SIMILAR (A102)

INTERIOR ELEVATION

SCALE: 1/2" = 1'-0"

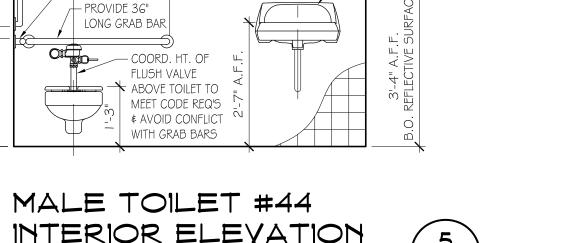

— SCHEDULED TILE WALL FINISH

TO MATCH EXISTING (PLUMBING

CHASE WALL ONLY - REFER TO

- INSTALL EXIST. SALVAGED

MIRROR (\pm 18" X \pm 24") ON

NEW WALL CONSTRUCTION

— INSTALL EXIST. SALVAGED


LOCATION ON NEW WALL


PLAN & WALL TYPES)

LAVATORY AT NEW

CONSTRUCTION



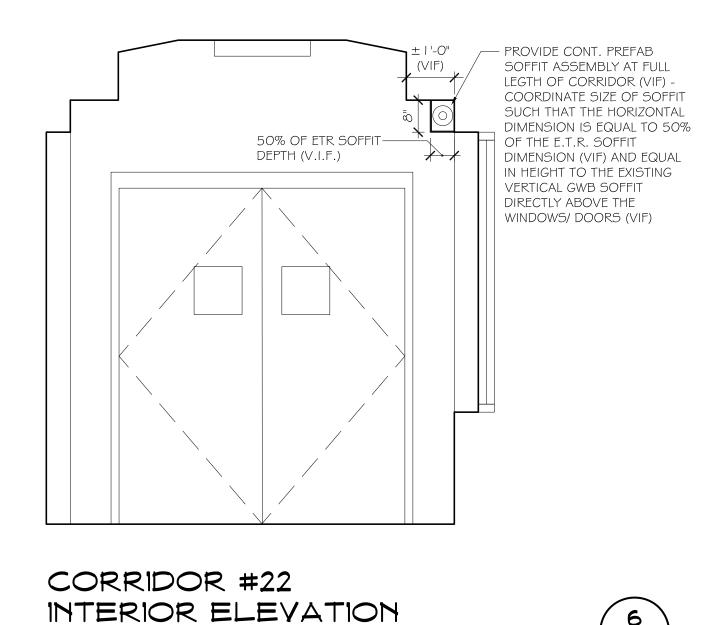

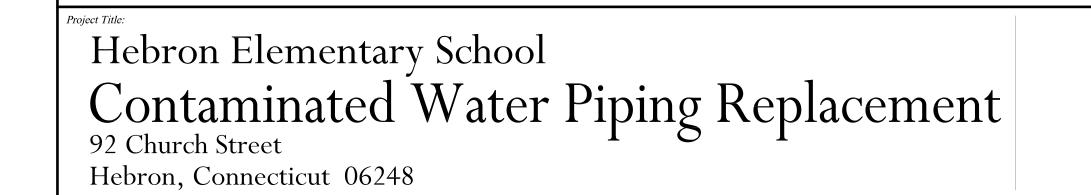



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Revision: Date: Revised By:

Details &
Interior Elevations

SCALE: 1/2" = 1'-0"

Date:

AUGUST 16, 2019

Scale:

AS NOTED

Drawn By:


RH


S/P+A Project No: State Project No:

067-0042 CV

19.003

A102

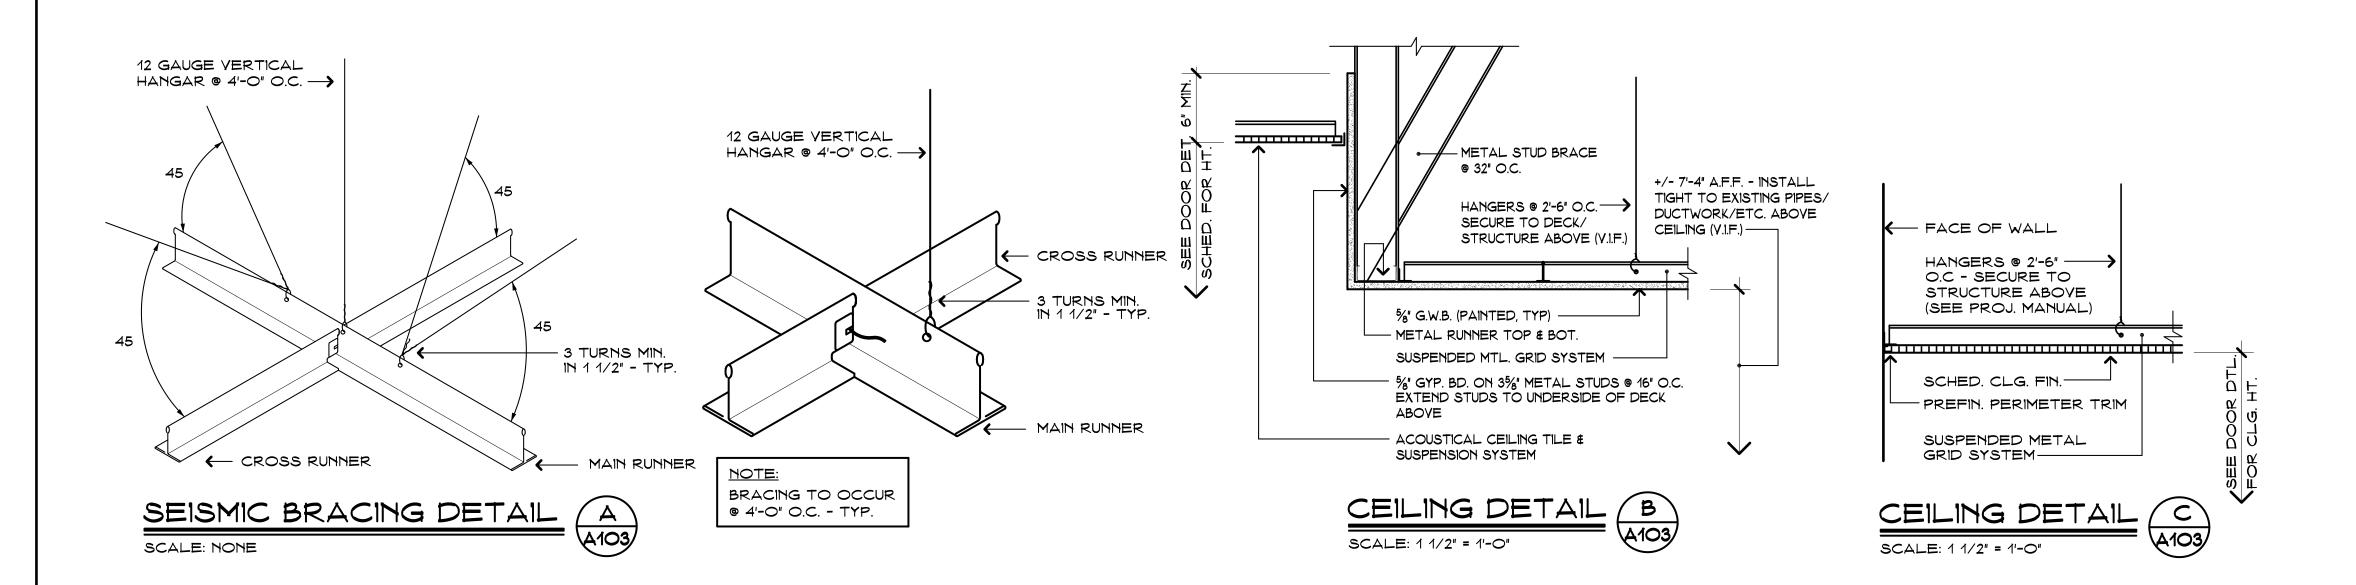

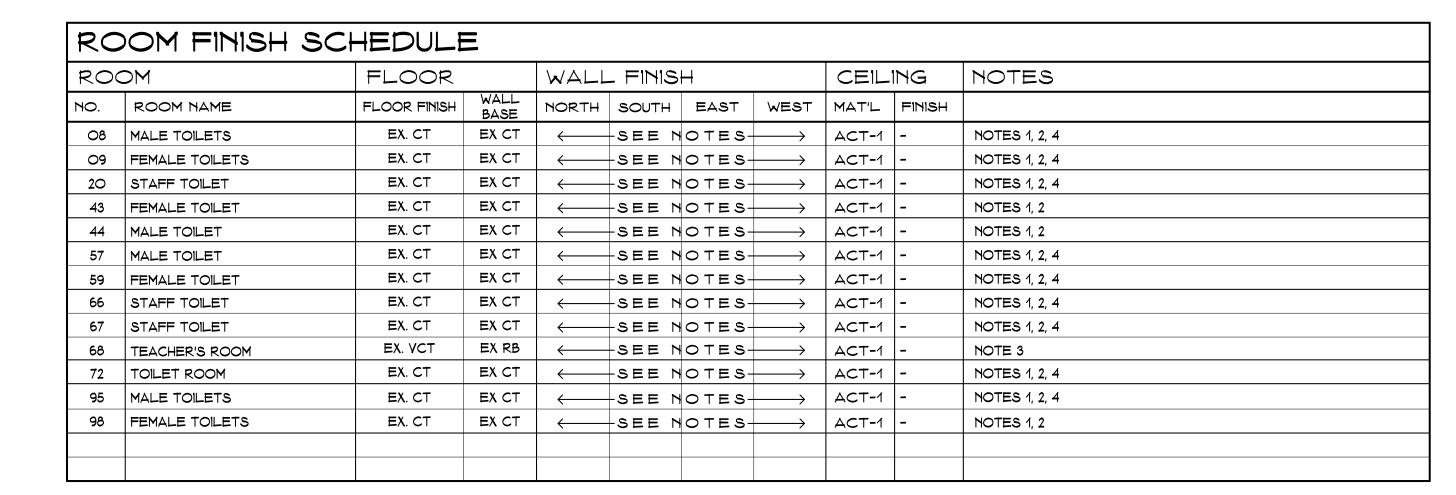

GENERAL FINISH NOTES

- 1. CONTRACTOR SHALL FIELD VERIFY ALL CONDITIONS & DIMENSIONS AND NOTIFY ARCHITECT IMMEDIATELY OF ANY DISCREPANCIES.
- 2. FINISH MATERIALS PROVIDED ADJACENT TO E.T.R. FINISHES, ARE REQUIRED TO MATCH THE E.T.R. MATERIAL SIZE, STYLE, PATTERN, ETC. WHERE COLOR SELECTIONS ARE REQUIRED, ARCHITECT WILL SELECT COLOR FROM MANUFACTURER'S FULL RANGE OF AVAILABLE COLORS. REFER TO THE PROJECT MANUAL FOR ADDITIONAL INFORMATION.
- 3. COORDINATE REPLACEMENT OF DAMAGED SUSPENDED CEILING TILES WITH OWNER TO HARVEST MATCHING CEILING TILES FROM OTHER AREAS WITHIN THE BUILDING FOR PATCHING USE AT AREAS OF HIGH VISIBILITY OR WHERE ONLY A SMALL AREA OF TILES ARE BEING REPLACED IN A LARGE ROOM/CORRIDOR. PROVIDE NEW CEILING TILES TO MATCH EXISTING AT HARVESTING SOURCE LOCATIONS, AND PROVIDE NEW CEILING TILES TO MATCH EXISTING AT LOCATIONS WHERE HARVESTED TILES ARE NOT AVAILABLE. THIS NOTE IS APPLIES TO ALL AREAS OF WORK WITHIN THE PROJECT SCOPE, INCLUDING BUT NOT LIMITED TO SPACES NOTED IN THE ABOVE FINISH SCHEDULE.

FINISH SCHEDULE LEGEND: ACT - ACOUSTICAL CEILING TILE


- ACT ACOUSTICAL CEILING TILE GWB GYPSUM WALL BOARD


 ETR EXISTING TO REMAIN CMU CONCRETE MASONRY UNIT

 VCT VINYL COMPOSITION TILE CT CERAMIC TILE
- RB RUBBER BASE EX EXISTING

FINISH SCHEDULE NOTES


- PROVIDE TILE WALL FINISH TO MATCH EXISTING SIZE/STYLE (V.I.F.) COLOR TO BE SELECTED BY ARCHITECT FROM MANUFACTURER'S FULL RANGE. PROVIDE PAINTED FINISH ON NEW/EXISTING CMU/MASONRY/GWB SUBSTRATE ABOVE TILING TO MATCH EXISTING.
- 2. MODIFY/APPEND & REPAIR EXISTING SUSPENDED CEILING ASSEMBLIES WITHIN AREAS OF WORK PROVIDE REPLACEMENT COMPONENTS TO MATCH EXISTING (V.I.F.)
- 3. PATCH, PREP & PAINT CMU WALL SURFACES BEHIND FORMER SINK/RANGE/FRIDGE APPLIANCE & PREPARE TO RECEIVE CABINETRY & COUNTERTOP WORK. ASSUME PATCH & REPLACEMENT OF EXISTING VCT & RUBBER WALL BASE AT FOOTPRINT OF REMOVED APPLIANCE (V.I.F.) MATCH EXISTING COLOR.
- 4. PATCH, PREP, PRIME & PAINT EXISTING PAINTED WALL SURFACES WITHIN ROOM.

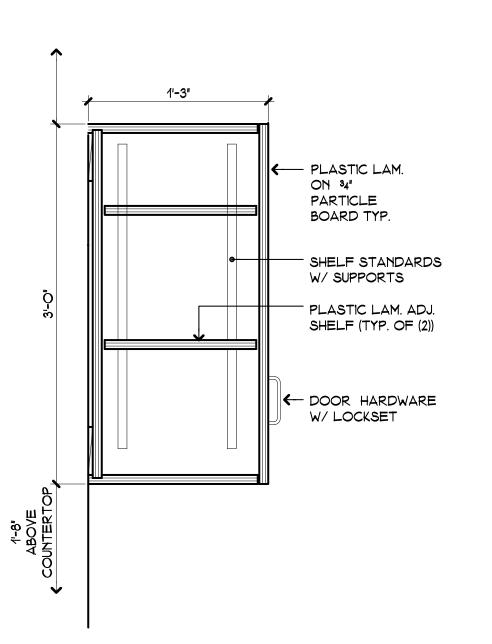

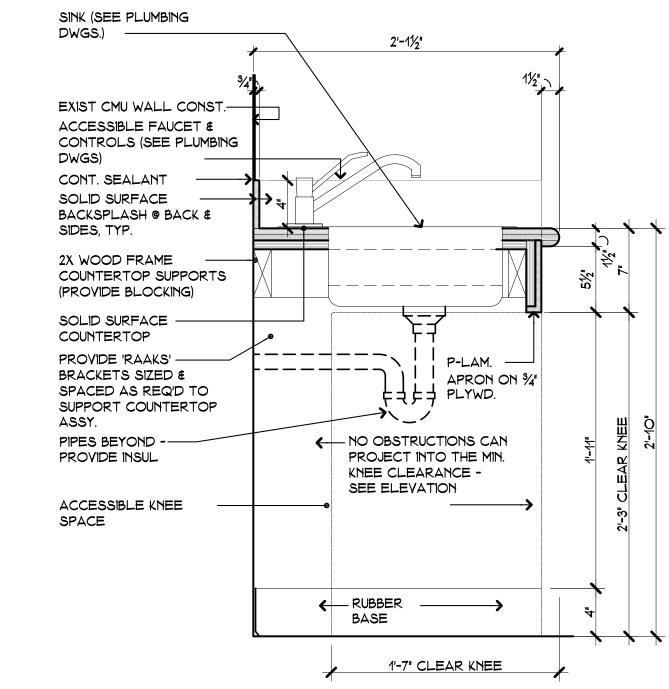





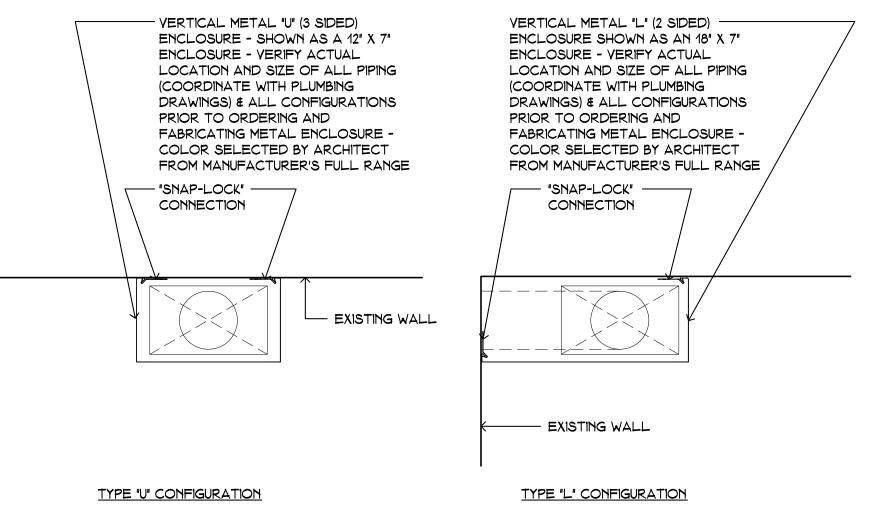


A103


Revised By:

TYPICAL PRE-FABRICATED METAL PIPE ENCLOSURE DETAILS

SCALE: 1 1/2" = 1'-0"

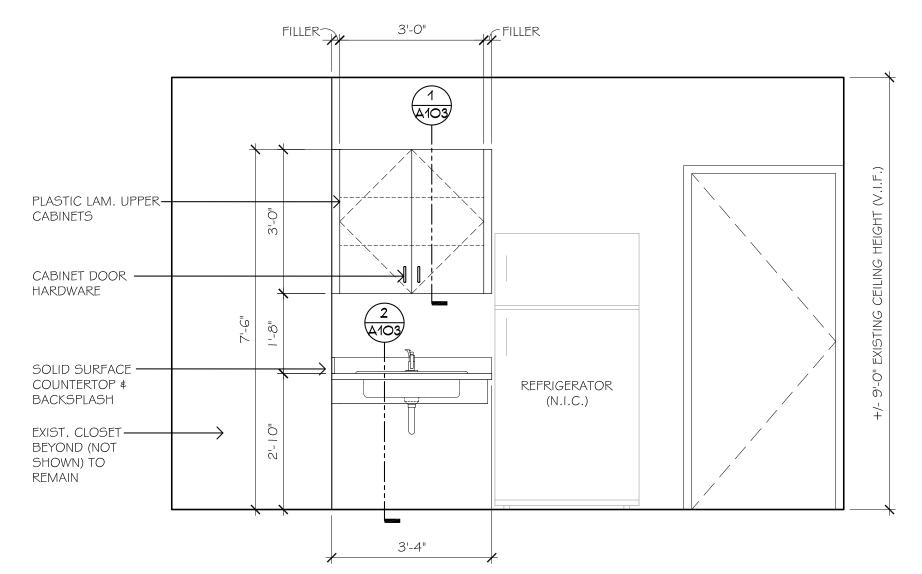

TEACHER'S ROOM INTERIOR ELEV.

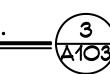

A103

Hebron Elementary School

Contaminated Water Piping Replacement

92 Church Street
Hebron, Connecticut 06248



SILVER / PETRUCELLI + ASSOCIATES

Architects / Engineers / Interior Designers

3190 Whitney Avenue, Hamden, CT 06518-23

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Finish Schedule & Details

Date:

AUGUST 16, 2019

Scale:

AS NOTED

Drawn By:

RH

ΚΠS/P+A Project No: State Project No:19.003 067-0042 CV

PLUMBING GENERAL NOTES

INSTALLED.

THE INTENT OF THESE CONTRACT DOCUMENTS (SPECIFICATIONS AND DRAWINGS) IS FOR THE CONTRACTOR TO FURNISH AND INSTALL COMPLETE PLUMBING SYSTEMS. ALL SYSTEMS SHALL BE COMPLETE IN ALL RESPECTS. OPERATING, TESTED, ADJUSTED, APPROVED BY THE AUTHORITIES HAVING JURISDICTION AND READY FOR BENEFICIAL USE BY

WHEN A CONFLICT BETWEEN THE DRAWINGS, NOTES AND/OR SPECIFICATIONS OCCUR, THE MORE STRINGENT, AND/OR LARGER QUANTITY AND/OR MORE EXPENSIVE SHALL APPLY. THE REQUIREMENTS PROVIDE ALL NECESSARY STRUCTURAL MEMBERS INCLUDING LISTED WITHIN NOTES OR SPECIFICATIONS SHALL BE REQUIRED, PROVIDED AND INSTALLED WHETHER SPECIFICALLY INDICATED ON THE DRAWINGS

ITEMS AND SERVICES NOT SHOWN ON DRAWINGS OR SPECIFICATIONS BUT REQUIRED TO RENDER THE WORK COMPLETE AND READY FOR OPERATION, SHALL BE PROVIDED WITHOUT ADDITIONAL COST.

WORK OF THIS SECTION SHALL BE GOVERNED BY THE CONTRACT DOCUMENTS. PROVIDE MATERIALS, LABOR, EQUIPMENT AND SERVICES NECESSARY TO FURNISH, DELIVER AND INSTALL ALL WORK AS SPECIFIED AND AS REQUIRED BY JOB CONDITIONS. WHERE A CONFLICT EXISTS BETWEEN THESE NOTES, THE DRAWINGS AND THE SPECIFICATIONS, THE MORE STRINGENT REQUIREMENT SHALL APPLY.

DRAWINGS ARE DIAGRAMMATIC AND INDICATE A GENERAL ARRANGEMENT OF WORK AND ARE NOT TO BE CONSIDERED SUB-CONTRACTOR DOCUMENTS. IT IS THE INTENT OF THESE DOCUMENTS TO INCLUDE THE PROVISION AND INSTALLATION OF ALL NECESSARY WORK AND MATERIALS FOR COMPLETE, OPERATIONAL AND CODE COMPLIANT SYSTEMS BY THE CONTRACTOR. GENERAL DESIGN CONCEPTS INDICATED MUST BE FOLLOWED OR BETTERED. THE BID SHALL INCLUDE OFFSETS, ADDITIONAL PIPING, VALVES AND EQUIPMENT AND COMPONENTS AS REQUIRED TO MEET CONSTRUCTION CONDITIONS FOR PROPER OPERATION. DO NOT SCALE DRAWINGS. CONSULT ARCHITECTURAL AND STRUCTURAL DRAWINGS FOR SPACE CONDITIONS

PERFORM THE WORK IN ACCORDANCE WITH THE REQUIREMENTS OF THE CONTRACT GENERAL CONDITIONS AND WITH THE PROVISIONS OF ALL APPLICABLE LOCAL, STATE, AND FEDERAL CODES AND LAWS.

AND ADDITIONAL REQUIREMENTS.

WORK SHALL INCLUDE ALL INCIDENTALS, LABOR, MATERIAL, EQUIPMENT, APPLIANCES, SERVICES, HOISTING, SCAFFOLDING, SUPPORTS, TOOLS, CONSUMABLE ITEMS, FEES, LICENSES, AND ADMINISTRATIVE TASKS REQUIRED TO COMPLETE AND MAKE OPERABLE WORK SHOWN ON THE DRAWINGS, SPECIFIED HEREIN AND AS REQUIRED FOR A COMPLETE AND OPERATIONAL SYSTEM..

ALL EQUIPMENT, MATERIALS AND RELATED SYSTEMS COMPONENTS SHALL BE NEW UNLESS SPECIFICALLY NOTED OTHERWISE.

STORE MATERIALS INSIDE AND PROTECTED FROM DEBRIS, WEATHER AND MOISTURE.

THIS CONTRACTOR SHALL PROVIDE AND INSTALL ALL POWER AND CONTROL WIRING REQUIRED FOR EQUIPMENT OPERATION REQUIRED FOR A COMPLETE AND OPERATIONAL SYSTEM.

PROVIDE AND INSTALL ALL MAKE-UP WATER DISTRIBUTION TO HVAC EQUIPMENT INCLUDING BACKFLOW PREVENTER.

REPAIR AND/OR REPLACE AT NO COST TO OWNER ALL EQUIPMENT AND MATERIALS DAMAGED DURING CONSTRUCTION.

THE CONTRACTOR SHALL OBTAIN AND REVIEW ALL CONTRACT DOCUMENTS, INCLUDING PROJECT MANUAL, PLANS AND SPECIFICATIONS OF ALL TRADES BEFORE SUBMITTING BID. REFER TO SPECIFICATIONS, PROJECT MANUAL AND PLANS, INCLUDING ALL EQUIPMENT SCHEDULES FOR INFORMATION. CONTRACTOR SHALL WALK THROUGH BUILDING PRIOR TO SUBMITTING BID WHEN AVAILABLE.

ALL OF THE CONTRACT DRAWINGS AND SPECIFICATIONS ARE COMPLIMENTARY TO FORM A TOTAL DESIGN PACKAGE. IT IS THE RESPONSIBILITY OF THE GENERAL CONTRACTOR/CONSTRUCTION MANAGER TO DETERMINE WHICH TRADE CONTRACTOR IS RESPONSIBLE FOR VARIOUS PORTIONS OF THE WORK.

ALL WORK AND ACTION DEPICTED AND DESCRIBED SHALL BE PERFORMED BY THE CONTRACTOR UNLESS SPECIFICALLY NOTED

THE PLUMBING CONTRACTOR SHALL VERIFY THESE DRAWINGS WITH EXISTING FIELD CONDITIONS BEFORE PROCEEDING WITH CONSTRUCTION.

THE DRAWINGS ARE DIAGRAMMATIC AND INDICATE THE GENERAL ARRANGEMENT OF SYSTEMS AND WORK INCLUDED IN THE CONTRACT. THE CONTRACTOR SHALL COORDINATE LOCATIONS OF EQUIPMENT WITH ALL TRADES BEFORE STARTING CONSTRUCTION. ANY MODIFICATIONS TO THE EQUIPMENT LAYOUT REQUIRED FOR INSTALLATION ARE TO BE PERFORMED AT NO ADDITIONAL COST TO THE OWNER. LOCATION AND SIZES OF ALL FLOOR, WALL AND ROOF PENETRATIONS SHALL BE COORDINATED WITH ALL OTHER TRADES INVOLVED.

SHOP DRAWINGS

CONTRACTOR SHALL SUBMIT SHOP DRAWINGS TO BE APPROVED, REVISED, OR RESUBMITTED AS PER THE ENGINEERS COMMENTS, PRIOR TO CONSTRUCTION. INCLUDING BUT NOT LIMITED TO THE FOLLOWING:

-PLUMBING FIXTURES -PIPING -PIPE SEALS -FITTINGS -BRAZING -HANGERS/SUPPORTS -WATER HEATERS -INSULATION -MIXING VALVES -EXPANSION TANKS -VALVES -PUMPS

AS BUILT DRAWINGS

PROVIDE A COMPLETE SET OF AS-BUILT DRAWINGS REFLECTING AS INSTALLED CONDITIONS. AS-BUILT DRAWINGS SHALL INDICATE ALL INSTALLED CONDITIONS OF SYSTEMS WITHIN THIS DISCIPLINE. DRAWINGS LEFT. SHALL BE OF SIMILAR SCALE AS THE CONSTRUCTION DOCUMENTS AND INCLUDE DETAILS AS NECESSARY TO CLEARLY REFLECT THE INSTALLED CONDITION. DRAWINGS SHALL BE BOUND IN A COMPLETE AND CONSECUTIVE SET. SUPPLEMENTAL SKETCHES AND LOOSE PAPERWORK COORDINATED WITH THE ARCHITECT. CONTACT ARCHITECT FOR WILL NOT BE ACCEPTABLE AND WILL BE RETURNED FOR REVISION. THE CONTRACTOR SHALL COMPLY WITH THE ENGINEERS COMMENTS TO PRODUCE A CLEAR AND CONCISE SET OF DRAWINGS. DRAWINGS SHALL BE SUBMITTED IN BOTH HARD COPY AND ELECTRONIC (AUTO-CAD VERSION AS REQUIRED BY THE OWNER) VERSION. NUMBER OF COPIES OF ALL EQUIPMENT, VALVES, STRAINERS, UNIONS, TRAPS, FLANGES AND EACH AS REQUESTED BY THE OWNER.

PROVIDE "AS-BUILT DRAWINGS" INDICATING IN A NEAT AND ACCURATE MANNER A COMPLETE RECORD OF ALL REVISIONS OF THE ORIGINAL DESIGN OF THE WORK. INDICATE THE FOLLOWING INSTALLED CONDITIONS:

INCLUDE ALL CHANGES AND AN ACCURATE RECORD, ON REPRODUCTIONS OF THE CONTRACT DRAWINGS OR APPROPRIATE SHOP DRAWINGS, OF ALL DEVIATIONS, BETWEEN THE WORK SHOWN AND

DEVICES LOCATED AND NUMBERED, CONCEALED UNIONS LOCATED, AND WITH ITEMS REQUIRING MAINTENANCE LOCATED (I.E., TRAPS, STRAINERS, EXPANSION COMPENSATORS, TANKS, ETC.). VALVE LOCATION DIAGRAMS, COMPLETE WITH VALVE TAG CHART. EQUIPMENT LOCATIONS (EXPOSED AND CONCEALED), DIMENSIONED FROM PROMINENT BUILDING LINES.

APPROVED SUBSTITUTIONS, CONTRACT MODIFICATIONS, AND ACTUAL EQUIPMENT AND MATERIALS INSTALLED.

CONTRACT MODIFICATIONS, ACTUAL EQUIPMENT AND MATERIALS

SUBMIT FOR REVIEW BOUND SETS OF THE REQUIRED DRAWINGS, MANUALS AND OPERATING INSTRUCTIONS.

SUBMIT A COMPLETE MAINTENANCE MANUAL OF ALL EQUIPMENT INSTALLED UNDER THIS CONTRACT.

HANGERS AND SUPPORT

ADDITIONAL STRUCTURAL SUPPORT TO SUPPORT PIPING AND EQUIPMENT. HANGERS AND SUPPORTS SHALL BE OF AN APPROVED DESIGN NECESSARY TO SUPPORT PIPING, EQUIPMENT AND TO KEEP PIPING IN PROPER ALIGNMENT AND PREVENT TRANSMISSION OF INJURIOUS THRUSTS AND VIBRATIONS. IN ALL CASES WHERE HANGERS, BRACKETS, ETC., ARE SUPPORTED FROM CONCRETE CONSTRUCTION, DO NOT WEAKEN CONCRETE OR PENETRATE WATERPROOFING. ALL HANGERS AND SUPPORTS SHALL BE CAPABLE OF SCREW ADJUSTMENT AFTER PIPING IS ERECTED. HANGERS SUPPORTING PIPING EXPANDING INTO LOOPS, BENDS AND OFFSETS SHALL BE SECURED TO THE BUILDING STRUCTURE IN SUCH A MANNER THAT HORIZONTAL ADJUSTMENT PERPENDICULAR TO THE RUN OF PIPING SUPPORTED MAY BE MADE TO ACCOMMODATE DISPLACEMENT DUE TO EXPANSION. ALL SUCH HANGERS SHALL BE FINALLY ADJUSTED BOTH IN THE VERTICAL AND HORIZONTAL DIRECTION, AS REQUIRED. HANGERS IN CONTACT WITH COPPER OR BRASS PIPE SHALL BE DIELECTRIC, COMPATIBLE WITH COPPER AND BRASS ALLOY OR PROVIDED WITH FELT SLEEVE.

PROVIDE ADDITIONAL SUPPORT FOR PIPING AND EQUIPMENT WHEN DECK IS NOT CAPABLE OF SUPPORT.

BEAM CLAMPS - HANGERS SUPPORTED FROM STEEL SHALL BE CENTER LOADING BEAM CLAMPS FOR HANGERS SUPPORTING PIPING 2 INCHES. FOR PIPING 2-L/2 INCHES AND LARGER, I BEAM CLAMPS SHALL BE FORGED STEEL. "C" CLAMPS ARE NOT TO BE USED.

SUBMIT PLANS, CALCULATIONS AND EQUIPMENT DATA.

PROVIDE AND INSTALL EXPANSION COMPENSATION FOR ALL PIPING.

BAND IRON, TIE WIRE, METAL STRAPPING OR WIRE STRAPPING SHALL NOT BE PERMITTED TO SUPPORT PIPING OR EQUIPMENT.

SEAL ALL PIPING PASSING THROUGH ALL FIRE AND/OR SMOKE RATED PARTITIONS AND WALLS WITH A UL LISTED, APPROVED AND TESTED FIRE AND/OR SMOKE SEALING MATERIAL INSTALLED IN ACCORDANCE WITH MANUFACTURERS RECOMMENDATIONS.

FURNISH AND SET STEEL PIPE SLEEVES OF SCHEDULE 40 BLACK STEEL FOR ALL LOCATIONS OF INTERIOR PARTITIONS, WALLS AND FLOORS PROVIDING AT LEAST 1/2" CLEARANCE BETWEEN PIPE INSULATION AND SLEEVE OR PIPE AND SLEEVE. WALL SLEEVES SHALL BE SMOOTH CUT AND SET FLUSH WITH FINISHED WALLS. FLOOR SLEEVES SHALL EXTENDED 2" ABOVE THE FINISHED FLOOR.

ALL PIPING THROUGH WALLS. FLOORS OR CEILINGS SHALL HAVE SLEEVES AND ESCUTCHEONS. PROVIDE A TWO PIECE CHROME ESCUTCHEON WHERE PIPING PASSES THROUGH WALLS OR FLOORS OF FINISHED SPACES.

PLUMBING FIXTURES (AS INDICATED ON DRAWINGS) SHALL BE NEW, COMPLETE WITH TRIMMINGS AND FITTINGS, INCLUDING FAUCETS, CARRIERS, SUPPLIES, STOPS, TRAPS, TAILPIECES, WASTE PLUGS, CASINGS, HANGERS, PLATES, BRACKETS, ANCHORS, SUPPORTS, HARDWARE AND FASTENING DEVICES. NOTE: ALL FIXTURES SHALL BE OF DIELECTRIC FITTING SHALL BE USED. THE DIELECTRIC FITTING SHALL BE A SAME MANUFACTURER. TRIMMINGS AND FITTINGS SHALL BE CONSTRUCT LISTED ASSEMBLY. OF FORGED, CAST, ROLLED OR EXTRUDED BRASS OR BRONZE WITH MONEL AND OTHER SUITABLE NON-CORROSIVE PARTS: DESIGNED WITH EASILY RENEWABLE PARTS THAT ARE SUBJECT TO WEAR OR DETERIORATION. NO DIE CASTINGS AND STAMPINGS OTHER THAN BRASS OR STAINLESS STEEL. PROVIDE PLUMBING FIXTURES AND TRIM WITH ALL NECESSARY TRIM, DEVICES AND ACCESSORIES REQUIRED FOR PROPER OPERATIONS SPECIFICALLY NOTED OR NOT

ESCUTCHEONS SHALL BE ONE-PIECE CHROME PLATED CAST BRASS OR STAINLESS STEEL.

EXAMINE ROUGHING-IN WORK OF POTABLE WATER AND WASTE PIPING SYSTEMS TO VERIFY ACTUAL LOCATIONS OF PIPING CONNECTIONS PRIOR TO INSTALLING FIXTURES. CORRECT ANY INCORRECT LOCATION OF PIPING, AND UNSATISFACTORY CONDITIONS FOR INSTALLATION OF PLUMBING FIXTURES. DO NOT PROCEED WITH WORK UNTIL UNSATISFACTORY CONDITIONS HAVE BEEN CORRECTED IN A MANNER ACCEPTABLE TO THE ENGINEER. ALL ROUGH-IN TO PLUMBING FIXTURES SHALL CONFORM TO FIXTURE MANUFACTURER PUBLISHED ROUGH-IN DIMENSIONS, AND REQUIREMENTS.

UPON COMPLETION OF INSTALLATION OF PLUMBING FIXTURES AND AFTER UNITS ARE WATER PRESSURIZED, TEST FIXTURES TO DEMONSTRATE CAPABILITY AND COMPLIANCE WITH REQUIREMENTS. CORRECT MALFUNCTIONING UNITS AT SITE, THEN RETEST TO DEMONSTRATE COMPLIANCE; OTHERWISE, REMOVE AND REPLACE WITH NEW UNITS AND PROCEED WITH RETESTING.

CLEAN PLUMBING FIXTURES, TRIM, AND STRAINERS OF DIRT AND DEBRIS UPON COMPLETION OF INSTALLATION.

ADJUST WATER PRESSURE AT DRINKING FOUNTAINS, FAUCETS, AND FLUSH VALVES TO PROVIDE PROPER FLOW STREAM AND SPECIFIED GPM.

SET FIXTURES LEVEL AND UNIFORMLY, WITH CONNECTIONS AT RIGHT ANGLES TO WALL AND PROPERLY CENTERED. LAY OUT ROUGHING ACCURATELY AND IN COORDINATION WITH SPACE AND FINISH REQUIREMENTS.

LOCATE WASTE OUTLETS AND WATER SUPPLIES AT CONSTANT HORIZONTAL LEVELS, WITH WASTE OUTLET CENTERED ON FIXTURE DRAIN CONNECTION AND WATER SUPPLIES SPACED EQUALLY TO RIGHT AND

REFER TO THE ARCHITECTURAL DRAWINGS FOR THE EXACT LOCATION AND MOUNTING HEIGHTS OF EQUIPMENT. COLORS SHALL BE CLARIFICATION IF INFORMATION IS NOT CONTAINED IN THE DRAWINGS.

MISCELLANEOUS SPECIALTIES

OTHER APPURTENANCES REQUIRING ACCESS SHALL BE LOCATED IN ACCESSIBLE LOCATIONS. WHEN A PIECE OF EQUIPMENT MUST BE LOCATED ABOVE AN INACCESSIBLE CEILING OR WALL THEN THE APPROPRIATE ACCESS DOOR SHALL BE PROVIDED. SUCH EQUIPMENT INCLUDES, BUT IS NOT LIMITED TO CLEANOUTS, WATER HAMMER ARRESTORS AND VALVES. THESE SHALL BE COORDINATED WITH THE ARCHITECT. ACCESS DOORS SHALL BE RIGID CONSTRUCTION WITH TWO HINGES AND A LATCH. IN PLENUM CEILINGS, PROVIDE FELT BETWEEN THE DOOR AND FRAME TO MAKE AN AIR TIGHT SEAL. ACCESS DOORS SHALL BE RATED TO THE SAME OR GREATER RATING OF THE PARTITION IN WHICH THEY ARE INSTALLED. ACCESS DOORS SHALL BE FLUSH MOUNTED, PRIME COATED WITH RUST INHIBITIVE PAINT, CONCEALED FRAME, FLUSH MAINS AND BRANCHES OF PIPING SYSTEMS, WITH VALVES AND CONTROL SCREW DRIVER OPERATED LOCKS WITH METAL CAMS AND ANCHORS AS

> ACCESS DOOR SIZES SHALL BE: 12" X 12" AT EASILY ACCESSIBLE ITEMS 16" X 16" WHERE PARTIAL BODY ACCESS IS REQUIRED 24" X 24" WHERE FULL BODY ACCESS IS REQUIRED

PROVIDE AND INSTALL DRIP PANS WITH WATER DETECTOR AND DRAIN FOR PIPING REQUIRED BY ACTUAL FIELD CONDITIONS WHERE PIPING PASSES OVER INCLUDING AREA WITHIN 3'-0" OF ELECTRICAL EQUIPMENT.

DO NOT INSTALL AIR GAP BACKFLOW PREVENTERS IN CONCEALED SPACES OR IN AREAS WHERE SPLASHING WATER WILL DAMAGE FINISHES. PROVIDE AND INSTALL AN OVERSIZED COPPER FUNNEL WITH AIR GAP DIRECTLY BELOW RPD PRESSURE RELIEF PORT. PIPE FUNNEL TO

PROVIDE FLEXIBLE CONNECTIONS IN ALL PIPING SYSTEMS CONNECTED TO PUMPS AND OTHER EQUIPMENT WHICH REQUIRES VIBRATION ISOLATION, EXCEPT WATER COILS. FLEXIBLE CONNECTIONS SHALL BE PROVIDED AS CLOSE TO THE EQUIPMENT AS POSSIBLE.

SPILL AS AN INDIRECT WASTE TO AN APPROVED DRAIN LOCATION.

PIPING GENERAL

NO PIPING SHALL BE COVERED UNTIL TESTED APPROVED BY THE AUTHORITIES HAVING JURISDICTION.

ALL PIPING SHALL BE RUN PERPENDICULAR AND/OR PARALLEL TO FLOORS, INTERIOR WALLS, ETC. PIPING AND VALVES SHALL BE GROUPED NEATLY AND SHALL BE RUN AS TO MAXIMIZE HEADROOM OR PASSAGE CLEARANCE. ALL VALVES, CONTROLS AND ACCESSORIES CONCEALED IN FURRED SPACES AND REQUIRING ACCESS FOR OPERATION AND MAINTENANCE SHALL BE ARRANGED TO ASSURE THE USE OF A MINIMUM NUMBER OF ACCESS DOORS.

ALL PIPE LINES MADE WITH SCREWED FITTINGS MUST BE PROVIDED WITH A SUFFICIENT NUMBER OF FLANGES AND/OR UNIONS TO ALLOW FOR EASY AND CONVENIENT DISMANTLING OF THE SYSTEM WITHOUT BREAKING FITTINGS.

AREAS OR CHASES. CONTRACTOR SHALL OBTAIN PERMISSION TO RUN ANY EXPOSED PIPES.

ALL PIPING SHALL RUN CONCEALED IN FURRED SPACES OF OCCUPIED

CAP ALL PIPE AND EQUIPMENT OUTLETS DURING CONSTRUCTION AND KEEP LINES AND INSIDE OF EQUIPMENT FREE OF FOREIGN MATERIALS.

PROVIDE FOR EXPANSION WITHOUT WARPING OR DISLOCATING LINES OR STRAINING CONNECTED EQUIPMENT. INSTALL PIPING TO CLEAR BUILDING CONSTRUCTION AND TO AVOID INTERFERENCE WITH OTHER WORK. THE CONTRACTOR SHALL PROVIDE AND INSTALL COMPLETE PIPING EXPANSION SYSTEM (INCLUDING SEISMIC JOINT EXPANSION) AND DEVICES AS REQUIRED FOR PROPER EXPANSION COMPENSATION STAMPED BY A PROFESSIONAL ENGINEER LICENSED IN THE STATE OF THE

THE DRAWINGS INDICATE SCHEMATICALLY THE SIZE AND LOCATION OF PIPING. PIPING SHALL BE SET UP AND DOWN AND OFFSET AS REQUIRED TO MEET CONSTRUCTION CONDITIONS.

THIS CONTRACTOR SHALL INFORM HIMSELF FROM THE GENERAL CONSTRUCTION SPECIFICATIONS AND PLANS, OF THE EXACT DIMENSION OF FINISHED WORK AND OF THE HEIGHT OF FINISHED CEILINGS IN ALL ROOMS WHERE EQUIPMENT OR PIPES ARE TO BE PLACED AND ARRANGE HIS WORK IN ACCORDANCE WITH THE SCHEDULE OF INTERIOR FINISHES, AS INDICATED ON THE ARCHITECTURAL DRAWINGS.

WATER PIPING SHALL BE RUN FREE OF TRAPS AND UNNECESSARY BENDS. ANY TRAPS FORMED SHALL BE PROVIDED WITH HOSE END DRAIN VALVES WITH THREADED CAP AND CHAIN TO COMPLETELY DRAIN THE SYSTEM.

PROVIDE SECTION CUT-OFF VALVES ON ALL MAINS AND BRANCHES. PITCH AND VALVE ALL WATER PIPING FOR CONVENIENT DRAINAGE.

UNIONS AND/OR FLANGES SHALL BE INSTALLED AT EACH PIECE OF

EQUIPMENT, IN BYPASSES AND IN LONG PIPING RUNS (100 FEET OR MORE) TO PERMIT DISASSEMBLY FOR ALTERATION AND REPAIRS. WHEREVER DISSIMILAR METALS ARE JOINED TOGETHER AN APPROVED

PLUMBING ABBREVIATIONS ABBREVIATION DESCRIPTION ADA AMERICAN DISABILITIES ACT A.F.F. ABOVE FINISHED FLOOR A.F.G. ABOVE FINISHED GRADE BELOW FINISHED FLOOR B.F.F. BFP BACKFLOW PREVENTER BIV BUTTERFLY INDICATING VALVE BLDG BUILDING BTU BRITISH THERMAL UNIT BTUH BRITISH THERMAL UNITS PER HOUR C.E. CIVIL ENGINEER CONT CONTINUED CO CLEANOUT PLUG CPVC CHLORINATED POLYVINYL CHLORIDE CVCHECK VALVE CWCOLD WATER D.F.U. DRAINAGE FIXTURE UNITS DIA. DIAMETER DN DOWN DWG DRAWING EΑ EACH E.C. ELECTRICAL CONTRACTOR

ELECTRIC WATER HEATER

FLOOR DRAIN WITH FUNNEL

FINISHED FLOOR ELEVATION

FIRE PROTECTION CONTRACTOR

FLOOR SINK WITH HALF GRATE

FLOOR SINK WITH SEDIMENT BUCKET

FLOOR SINK WITH THREE-QUARTER GRATE

FLOOR DRAIN WITH ROUND FUNNEL

EXISTING

FLOOR CLEANOUT

FLOOR DRAIN

FINISHED FLOOR

FLOOR

FLOOR SINK

FIXTURE UNITS

GENERAL CONTRACTOR

GALLONS PER FLUSH

GALLONS PER HOUR

GALLONS PER MINUTE

GAS WATER HEATER

HOT WATER RECIRCULATION

THOUSANDS OF BTU PER HOUR

MECHANICAL CONTRACTOR

GALLONS

HUB DRAIN

HOUR

HORSEPOWER

HOT WATER

KILOWATTS

MAXIMUM

MINIMUM

MISCELANNEOUS

NORMALLY CLOSED

NOT IN CONTRACT

NORMALLY OPEN

NOT TO SCALE

PLUMBING CONTRACTOR

PROJECTED ROOF AREA

POLYVINYL CHLORIDE

RADIUS

ROOF DRAIN

ROOF OVERFLOW

RAINWATER LEADER

SANITARY SEWER STACK

UNLESS OTHERWISE NOTED

SITE CONTRACTOR

SQUARE FEET

THRUST BLOCK

TRENCH DRAIN

TRAP PRIMER

VACUUM BREAKER

VENT THROUGH ROOF

FREEZE PROOF HOSE BIB

VERIFY IN FIELD

WALL CLEANOUT

WALL HYDRANT

YARD CLEANOUT

NOTE: SOME SYMBOLS AND ABBREVIATIONS SHOWN MAY NOT PERTAIN TO

DIAMETER

VENT STACK

TYPICAL

POUNDS PER SQUARE INCH

REDUCED PRESSURE BACKFLOW PREVENTER

EWH

EX.

FCO

FD

FDF

FDF-R

F.F.

F.F.E.

FLR.

F.P.C.

FS

FSB

FSH

FSQ

FT

F.U.

GAL

G.C.

GPF

HP

HR

HW

HWR

MAX.

MBTUH

M.C.

MIN.

MISC.

N.I.C.

NTS

PRA

PVC

RAD.

RD

RPBFP

S.C.

55

TYP.

U.O.N.

VB

V.I.F.

VTR

WCO

HB

FPHB

YCO

THIS PROJECT.

PLUMBING DEMOLITION NOTES

ALL EQUIPMENT, FIXTURES, PIPING ETC. TO BE REMOVED SHALL BE DISPOSED OF, TURNED OVER TO THE OWNER, OR SALVAGED AS DIRECTED BY THE OWNER. EQUIPMENT, FIXTURES, PIPING, DEVICES, ETC. SHALL NOT BE REMOVED FROM THE PREMISES WITH OUT THE OWNERS APPROVAL.

ALL ABANDONED PIPING TO REMAIN SHALL BE PROPERLY PLUGGED. VALVED. CAPPED AND/OR BY PASSED SUCH THAT UPON COMPLETION OF WORK ALL ABANDONED SYSTEMS ARE PROPERLY CONCEALED, AND

THAT EXISTING SYSTEMS TO REMAIN, REMAIN OPERATIONAL.

ALL SYSTEMS SHALL BE LEFT IN PERFECT WORKING ORDER UPON COMPLETION OF ALL NEW WORK.

WORK AS REQUIRED BY THE PROPOSED ALTERATIONS.

ALL EXISTING EXPOSED, UNNECESSARY PIPING RELATED TO NEW WORK SHALL BE COMPLETELY REMOVED.

REROUTE OR REMOVE ALL EXISTING PIPING, AND SYSTEMS WHERE NECESSARY TO AVOID NEW EQUIPMENT, STRUCTURAL, OR MASONRY

COORDINATE PLUMBING SERVICES SHUT DOWNS (HECW. GAS. WASTE. VENT & STORM SYSTEMS) WITH THE BUILDING MANAGER AND UTILITY COMPANY.

	LIN	IETYPE	ELEGE	END
EXISTING	D	EMO	NEW	DESCRIPTION
cw=	—×	XCW=		COLD WATER (CW)
===HW===	—×	XHW=		HOT WATER (HW)
HWR	—×	X_HWR=		HW RETURN (HWR)
FC	—×	——————————————————————————————————————		FIRE/CW (FC)
FP	—×	—X— FP =		FIRE PROTECTION (FP)
PLU	MB	ING DI	RAWIN	IG LIST
DRAWING NUME	BER		DRAWING D	ESCRIPTION
POO1		PLUMBING CO	OVER SHEET	
P100		OVERALL PLL	IMBING DEMO	LITION PLAN
P101		ENLARGED PA	ARTIAL SUPPL	Y PLAN - AREA 'A'
P102		ENLARGED PA	ARTIAL SUPPL	Y PLAN - AREA 'B'
P103		ENLARGED PA	ARTIAL SUPPL	Y PLAN - AREA 'C'
P104		ENLARGED PA	ARTIAL SUPPL	Y PLAN - AREA 'D'
P105		ENLARGED PA	ARTIAL SUPPL	Y PLAN - AREA 'E'
P106		ENLARGED PA	ARTIAL SUPPL	Y PLAN - AREA 'F'
P107		ENLARGED PA	ARTIAL SUPPL	Y PLAN - AREA 'G'
P108		ENLARGED PA	ARTIAL SUPPL	Y PLAN - AREA 'H'
P201		SUPPLY ISOM	ETRIC AREAS	A & B
P202		SUPPLY ISOM	ETRIC AREAS	C & D
P203		SUPPLY ISOM	ETRIC AREAS	E&F
P204		SUPPLY ISOM	ETRIC AREAS	G, TUNNEL & BASEMENT
P8 <i>0</i> 1		PLUMBING DE	TAILS	
P802		PLUMBING DE	TAILS	
P901		PLUMBING SC	HEDULES	

Hebron Elementary School Contaminated Water Piping Replacement 92 Church St Hebron, CT 06248



SILVER / PETRUCELLI + ASSOCIATES Architects / Engineers / Interior Designers


> 3190 Whitney Avenue, Hamden, CT 06518-2340 One Post Hill Place, New London, CT 06320 Tel. 203 230 9007 Fax. 203 230 8247 silverpetrucelli.com

Revised By:

PLUMBING COVER SHEET

Drawing Number: AUGUST 16, 2019 NOT TO SCALE Drawn By: S/P+A Project No: State Project No:

067-0042 CV

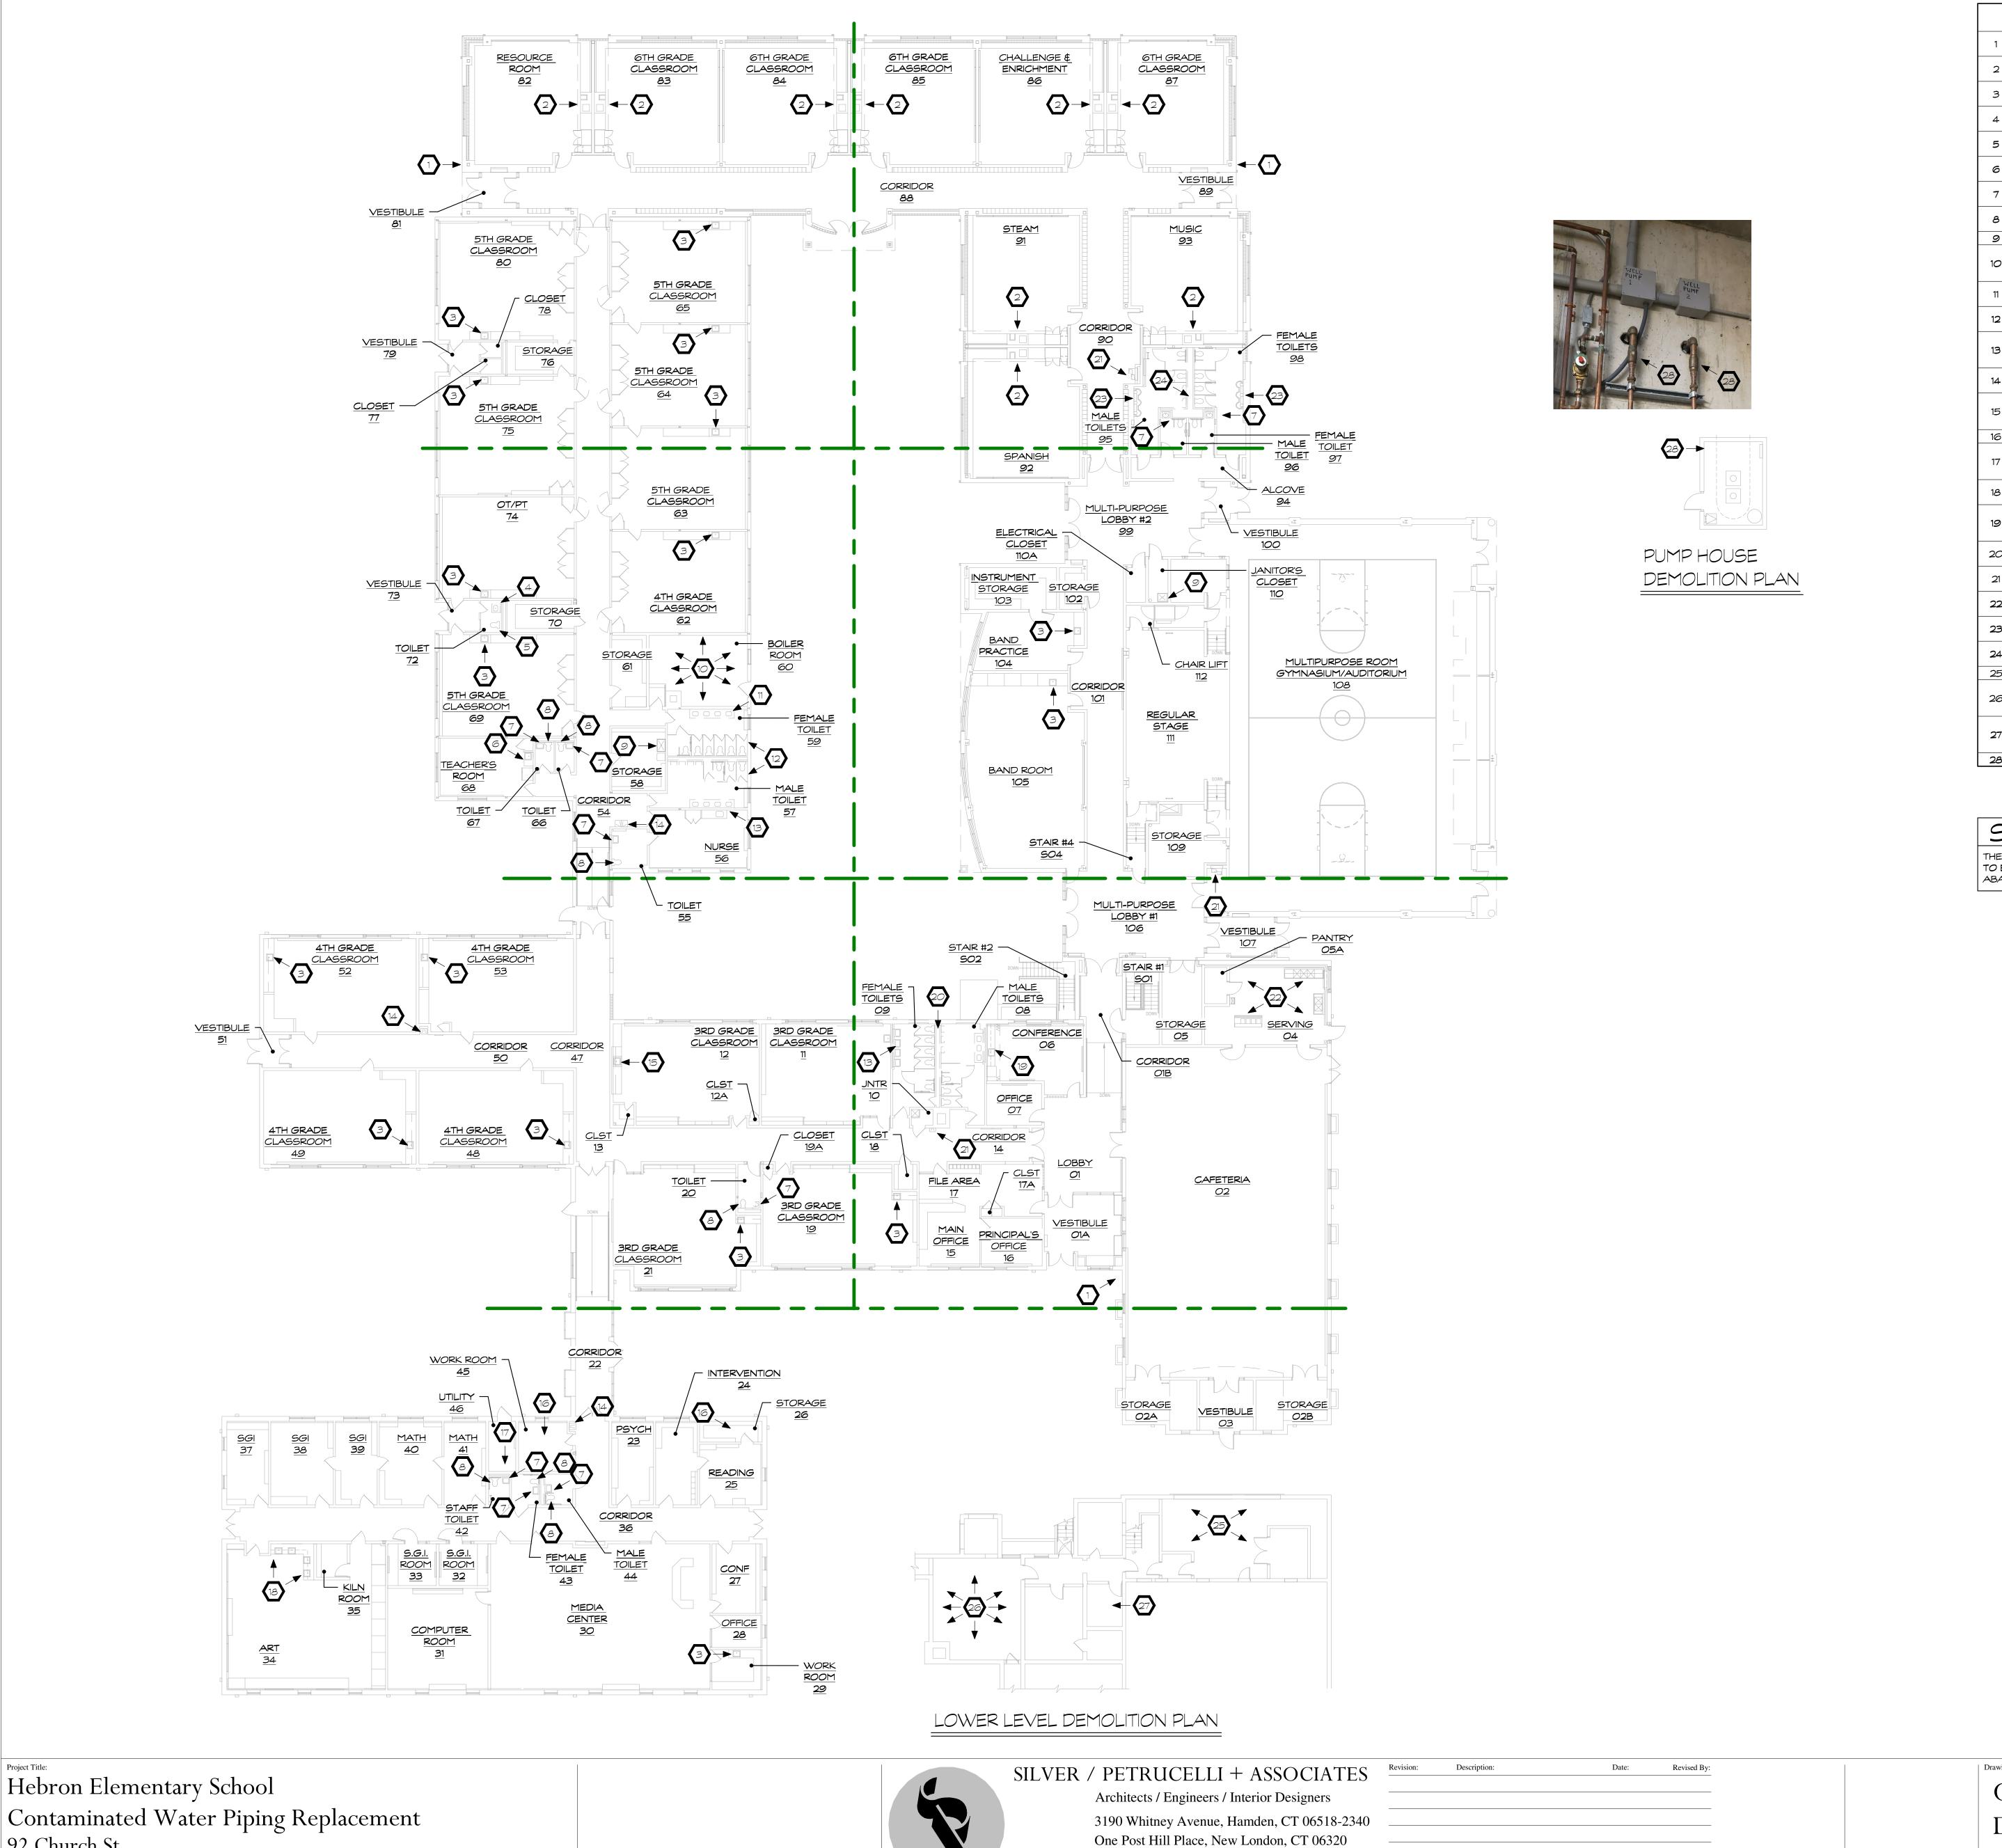

Tel. 203 230 9007 Fax. 203 230 8247

silverpetrucelli.com

92 Church St

Hebron, CT 06248

O PLUMBING DEMOLITION KEY NOTES O

REMOVE EXISTING SINK FAUCET, DRINKING FOUNTAIN AND ALL EXPOSED WATER SUPPLY PIPING BELOW COUNTER. CAP EXISTING SUPPLY PIPING AS CLOSE TO WALL AS POSSIBLE. REMOVE EXISTING SINK FAUCET AND ALL EXPOSED WATER SUPPLY PIPING BELOW COUNTER. CAP EXISTING SUPPLY

PIPING AS CLOSE TO WALL AS POSSIBLE.

REMOVE EXISTING VANITY AND SET ASIDE FOR REUSE. REMOVE EXISTING SINK FAUCET AND ALL EXPOSED WATER

SUPPLY PIPING BELOW COUNTER. CAP EXISTING SUPPLY PIPING AS CLOSE TO WALL AS POSSIBLE. REMOVE EXISTING WATER CLOSET AND SET ASIDE FOR REUSE. REMOVE EXISTING FLUSH VALVE AND ALL EXPOSED

WATER SUPPLY PIPING. CAP EXISTING SUPPLY PIPING AS CLOSE TO WALL AS POSSIBLE. REMOVE EXISTING ALL-IN ONE KITCHENETTE UNIT AND ALL EXPOSED WATER SUPPLY PIPING BELOW COUNTER. CAP

EXISTING SUPPLY PIPING AS CLOSE TO WALL AS POSSIBLE. REMOVE EXISTING WALL MOUNTED LAVATORY AND SET ASIDE FOR REUSE. DISPOSE OF EXISTING FAUCET. REMOVE

WATER SUPPLY PIPING BELOW LAVATORY. CAP EXISTING SUPPLY PIPING AS CLOSE TO WALL AS POSSIBLE.

REMOVE EXISTING FLUSH VALVE AND ASSOCIATED WATER PIPING IN CHASE. SEE ARCHITECTURAL PLANS FOR DEMOLTION ALLOWING ACCESS TO CHASE.

9 REMOVE EXISTING WALL MOUNTED FAUCET AND WATER SUPPLY PIPING ALONG WALL

10 MAKE-UP WATER CONNECTION TO MECHANICAL EQUIPMENT. REMOVE ALL DOMESTIC WATER PIPING THAT WILL NO LONGER BE USED. REMOVE EXISTING FIRE SPRINKLER SYSTEM THAT IS FED OFF OF DOMESTIC WATER MAIN.

DISCONNECT AND REMOVE EXISTING GAS WATER HEATER AND ACCESSORIES. DISCONNECT AND REMOVE EXISTING

REMOVE EXISTING WALL MOUNTED LAVATORY (TYP OF 4). REMOVE WATER SUPPLY PIPING BELOW LAVATORIES. CAP EXISTING SUPPLY PIPING AS CLOSE TO WALL AS POSSIBLE.

REMOVE EXISTING FLUSH VALVES (TYP OF 13) AND ASSOCIATED WATER PIPING IN CHASE. SEE ARCHITECTURAL PLANS FOR DEMOLTION ALLOWING ACCESS TO CHASE.

REMOVE EXISTING WALL MOUNTED LAVATORY (TYP OF 4). REMOVE WATER SUPPLY PIPING BELOW LAVATORIES. REMOVE EXISTING SINK FAUCET AND ALL EXPOSED WATER SUPPLY PIPING BELOW COUNTER. CAP EXISTING SUPPLY PIPING AS CLOSE TO WALL AS POSSIBLE.

REMOVE EXISTING WALL MOUNTED ELECTRIC WATER COOLER. REMOVE WATER SUPPLY PIPING FEEDING WATER COOLER. CAP EXISTING SUPPLY PIPING AS CLOSE TO WALL AS POSSIBLE.

REMOVE EXISTING SINK FAUCET AND ALL EXPOSED WATER SUPPLY PIPING BELOW COUNTER. CAP EXISTING SUPPLY 15 PIPING AS CLOSE TO WALL AS POSSIBLE. CUT AND PATCH SHEET ROCK AS REQUIRED TO REMOVE EXISTING PIPING AND INSTALL NEW PIPING.

16 REMOVE EXISTING FIRE SPRINKLER SYSTEM THAT IS FED OFF OF DOMESTIC WATER MAIN. DISCONNECT AND REMOVE EXISTING ELECTRIC WATER HEATER AND ACCESSORIES. REMOVE ALL DOMESTIC WATER

PIPING THAT WILL NO LONGER BE USED. REMOVE EXISTING FIRE SPRINKLER SYSTEM THAT IS FED OFF OF DOMESTIC WATER MAIN. REMOVE EXISTING SINK FAUCETS (TYP OF 4) AND ALL EXPOSED WATER SUPPLY PIPING BELOW COUNTER. CAP

EXISTING SUPPLY PIPING AS CLOSE TO WALL AS POSSIBLE. REMOVE EXISTING WALL MOUNTED LAVATORY (TYP OF 3). REMOVE WATER SUPPLY PIPING BELOW LAVATORIES.

19 REMOVE EXISTING SINK FAUCET AND ALL EXPOSED WATER SUPPLY PIPING BELOW COUNTER. CAP EXISTING SUPPLY PIPING AS CLOSE TO WALL AS POSSIBLE.

REMOVE EXISTING FLUSH VALVES (TYP OF 11) AND ASSOCIATED WATER PIPING IN CHASE. SEE ARCHITECTURAL PLANS FOR DEMOLTION ALLOWING ACCESS TO CHASE.

REMOVE EXISTING RECESSED ELECTRIC WATER COOLER. REMOVE WATER SUPPLY PIPING FEEDING WATER COOLER. CAP EXISTING SUPPLY PIPING AS CLOSE TO WALL AS POSSIBLE. REMOVE ALL EXPOSED WATER SUPPLY PIPING. CAP EXISTING SUPPLY PIPING AS CLOSE TO FLOOR THAT LEADS TO

TUNNEL AS POSSIBLE. REMOVE EXISTING WALL MOUNTED LAVATORY (TYP OF 4). REMOVE WATER SUPPLY PIPING BELOW LAVATORIES.

CAP EXISTING SUPPLY PIPING AS CLOSE TO WALL AS POSSIBLE. REMOVE EXISTING FLUSH VALVES (TYP OF 10) AND ASSOCIATED WATER PIPING IN CHASE. SEE ARCHITECTURAL

PLANS FOR DEMOLTION ALLOWING ACCESS TO CHASE. 25 REMOVE ALL EXPOSED WATER SUPPLY PIPING. CAP EXISTING SUPPLY PIPING AS CLOSE TO WALL AS POSSIBLE.


DISCONNECT AND REMOVE EXISTING MAKE-UP WATER CONNECTION TO MECHANICAL EQUIPMENT. REMOVE ALL 26 DOMESTIC WATER PIPING THAT WILL NO LONGER BE USED. REMOVE EXISTING FIRE SPRINKLER SYSTEM THAT IS FED

DISCONNECT AND REMOVE EXISTING ELECTRIC WATER HEATERS AND ACCESSORIES. REMOVE ALL DOMESTIC 27 WATER PIPING THAT WILL NO LONGER BE USED. REMOVE EXISTING FIRE SPRINKLER SYSTEM THAT IS FED OFF OF DOMESTIC WATER MAIN.

28 REMOVE EXISTING BRASS CHECK VALVES (TYP OF 2) ON PIPING FROM WELL PUMP INTO PUMP HOUSE.


SUPPLY PIPING GENERAL DEMOLITION NOTES


THE INTENT OF THIS PROJECT IS TO REPLACE ALL OF THE SUPPLY PIPING IN THE ENTIRE BUILDING. ALL EXISTING PIPING IS TO BE REMOVED WHEN FEASIBLE AND IF NOT FEASIBLE, PIPING IS TO BE CAPPED AS FAR BACK AS POSSIBLE AND ABANDONED IN PLACE.

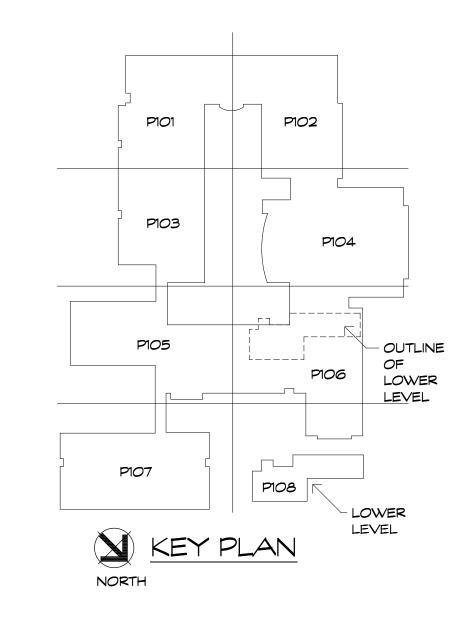



OVERALL PLUMBING DEMOLITION PLAN


Drawing Number: AUGUST 16, 2019 1/16" = 1'-0" Drawn By: S/P+A Project No: 067-0042 CV

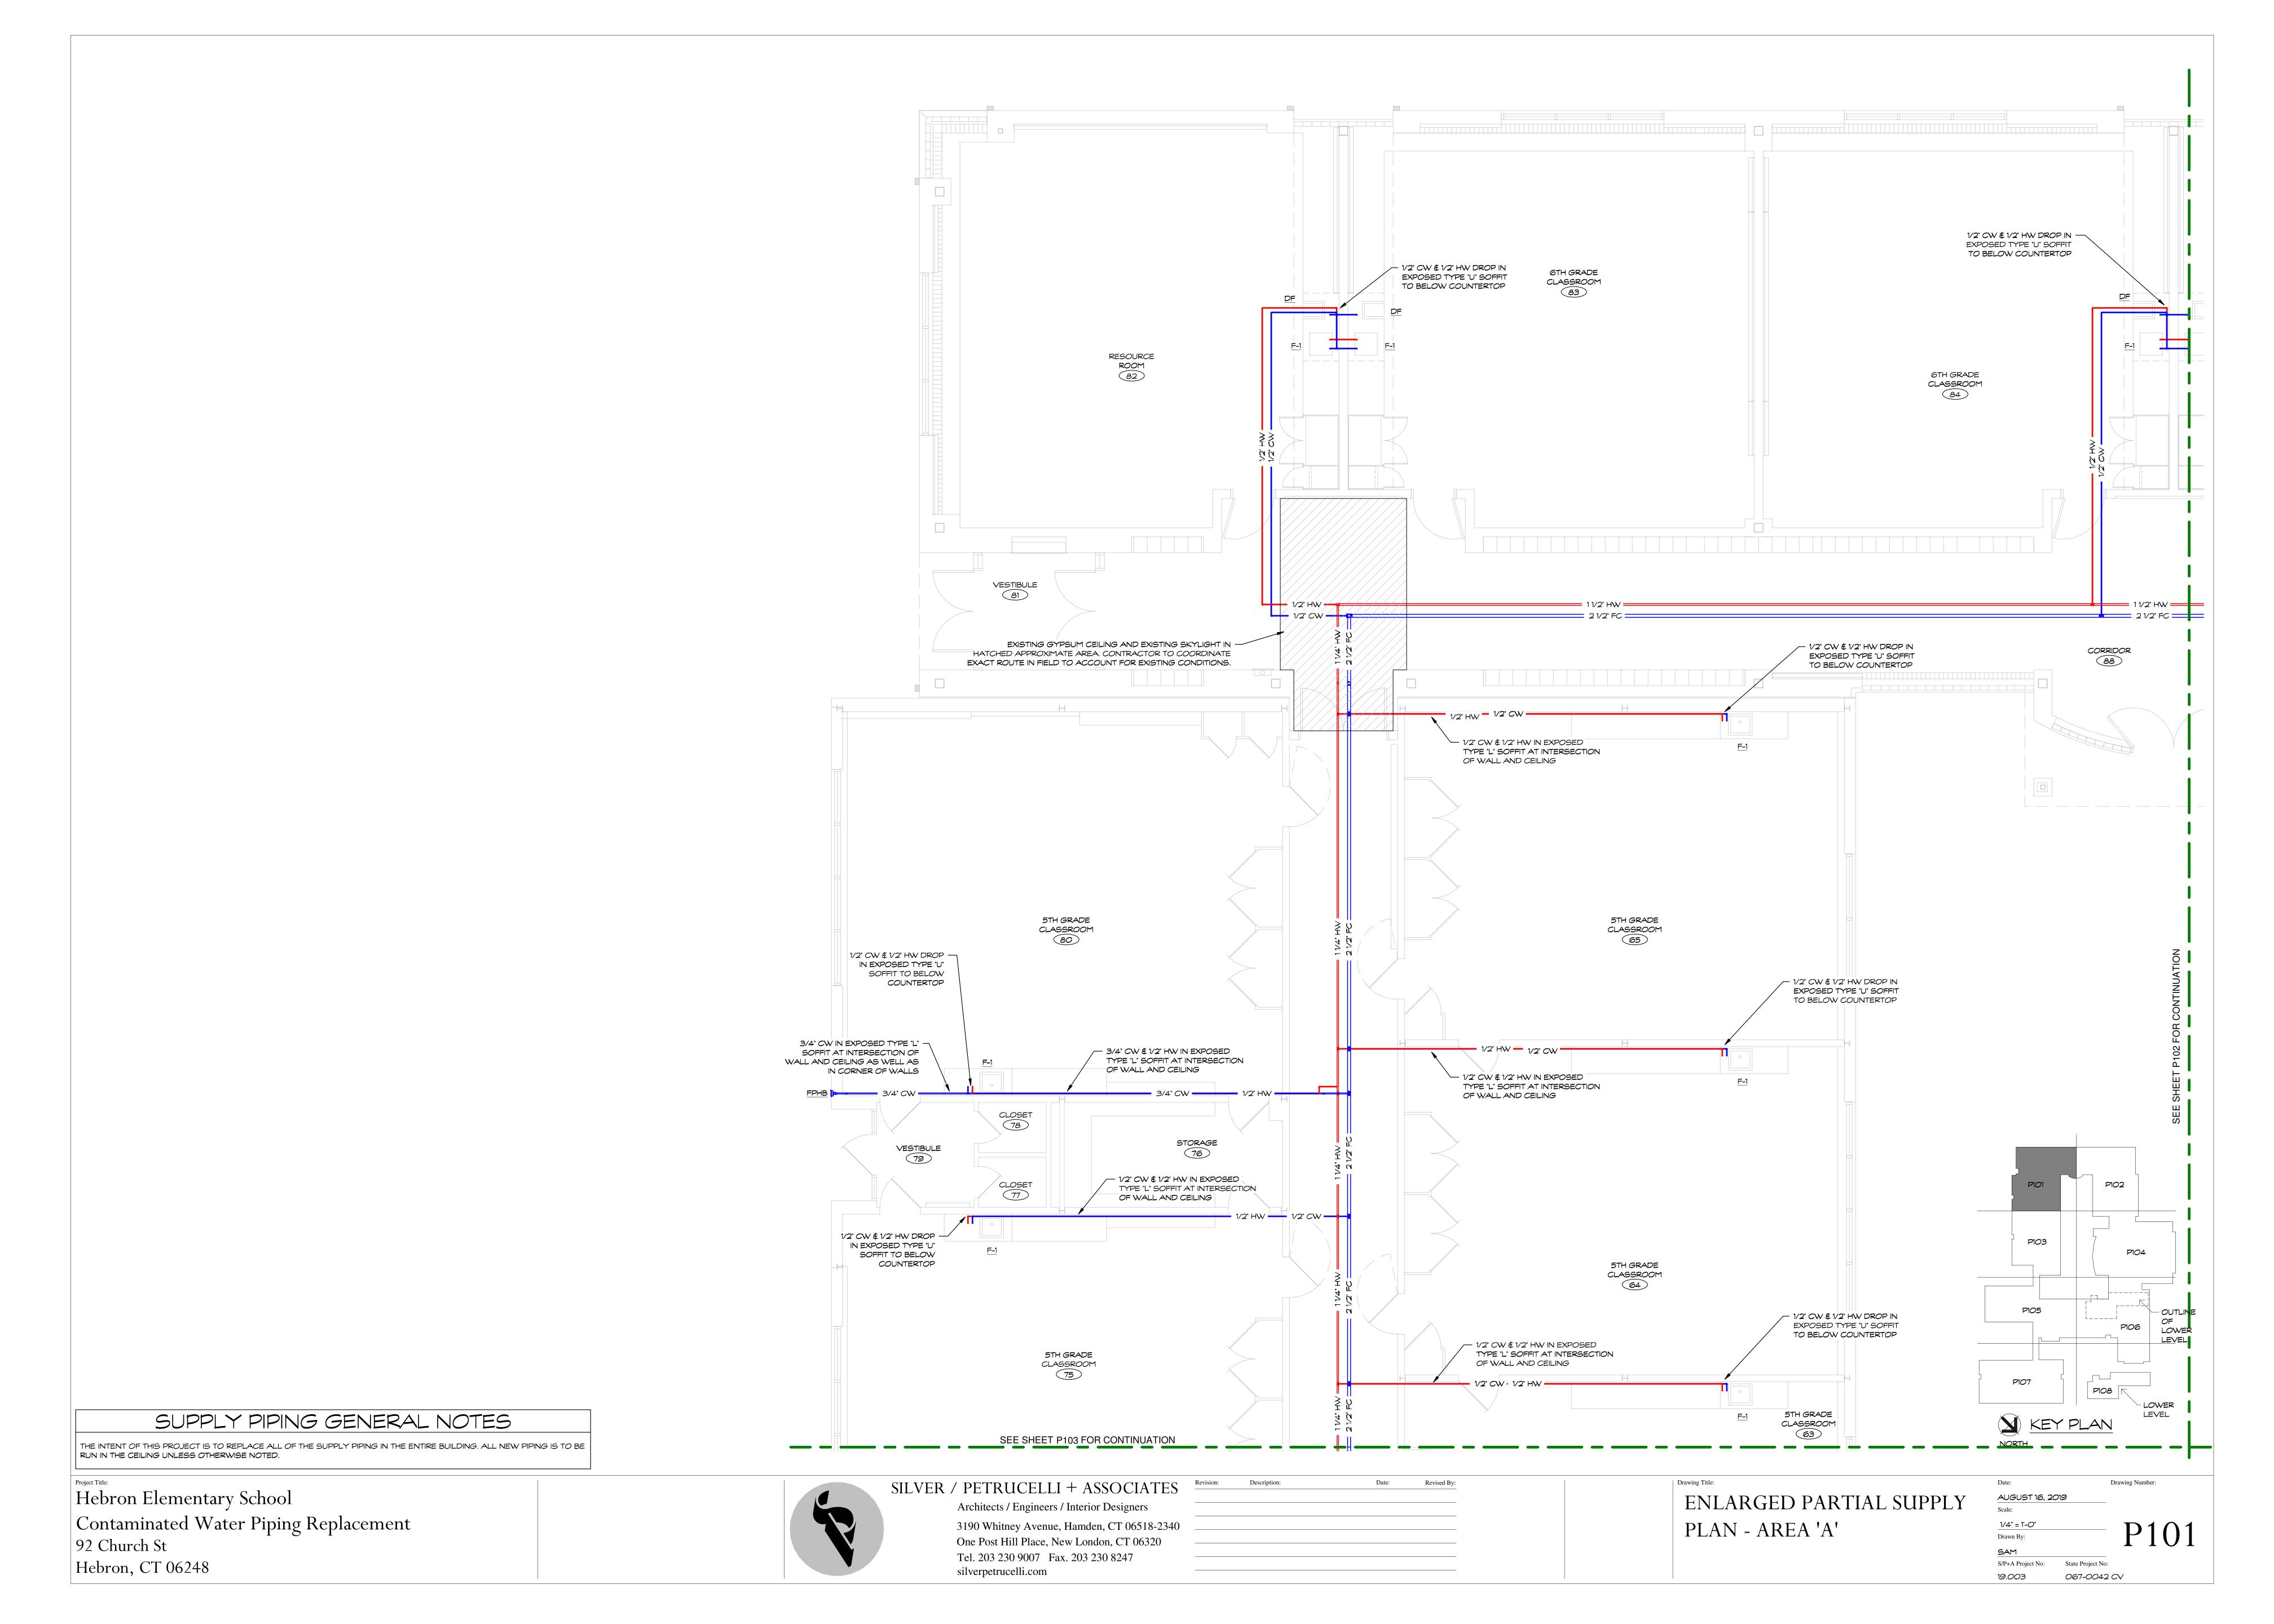


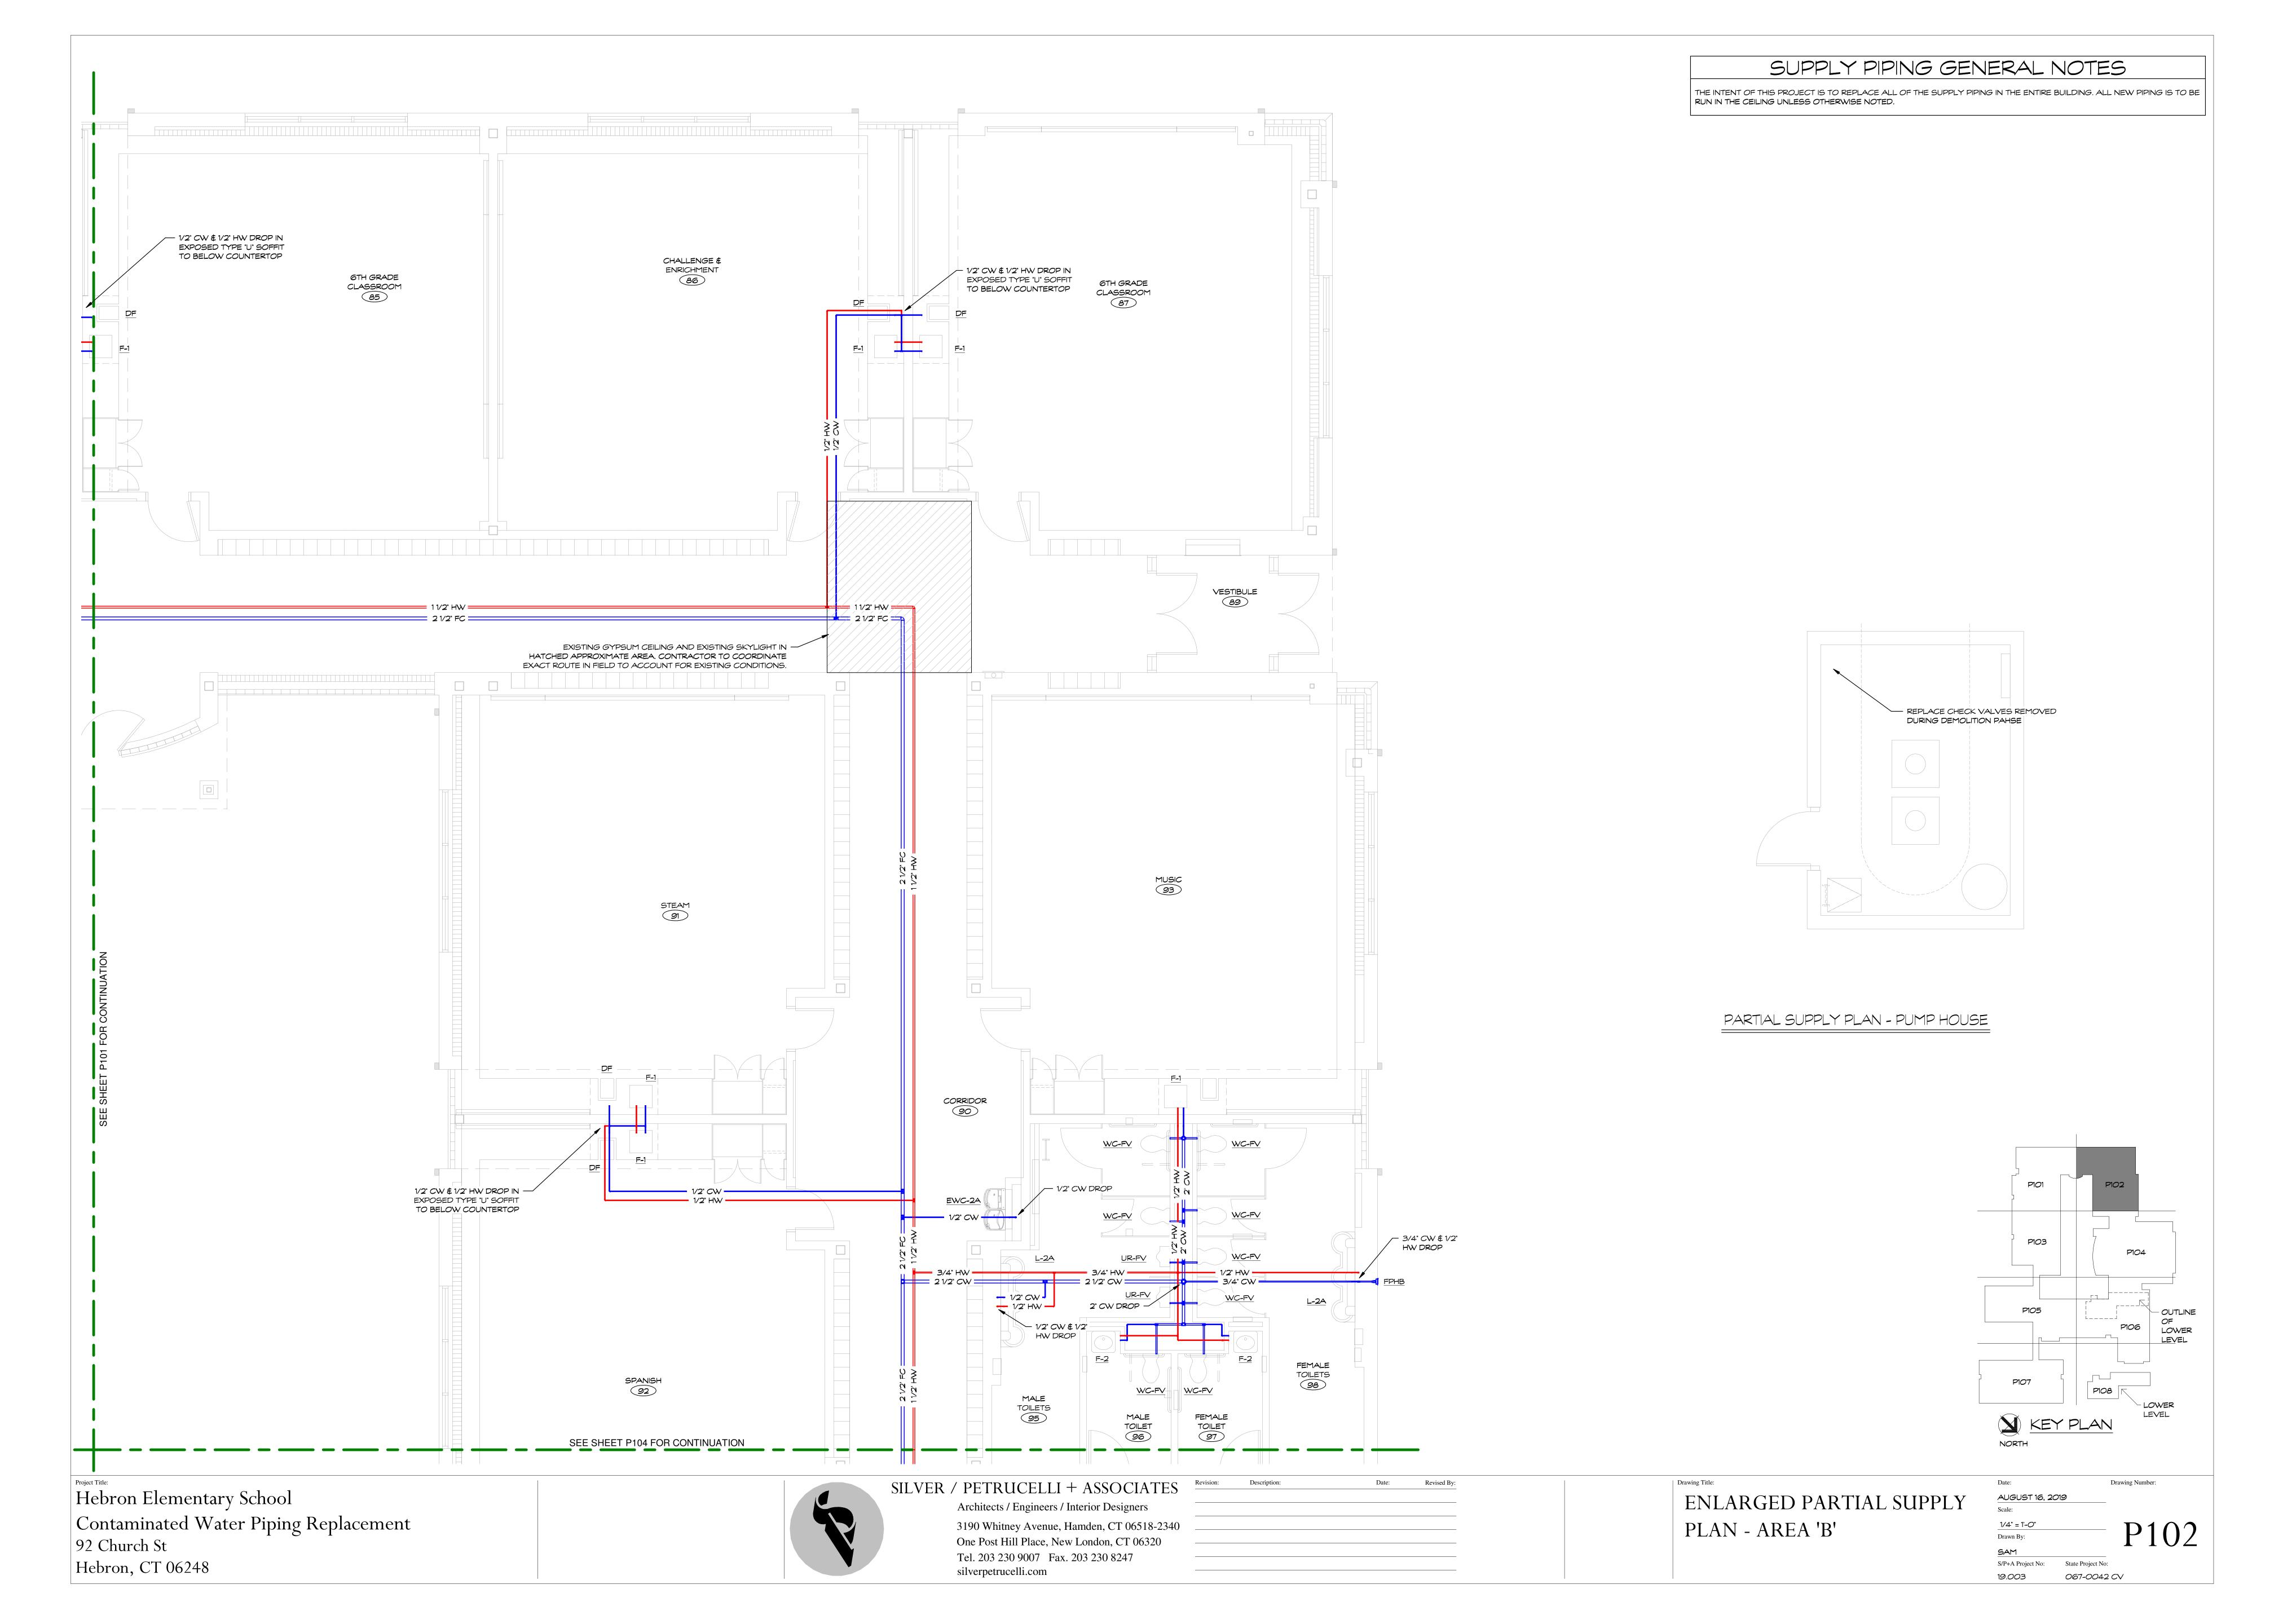


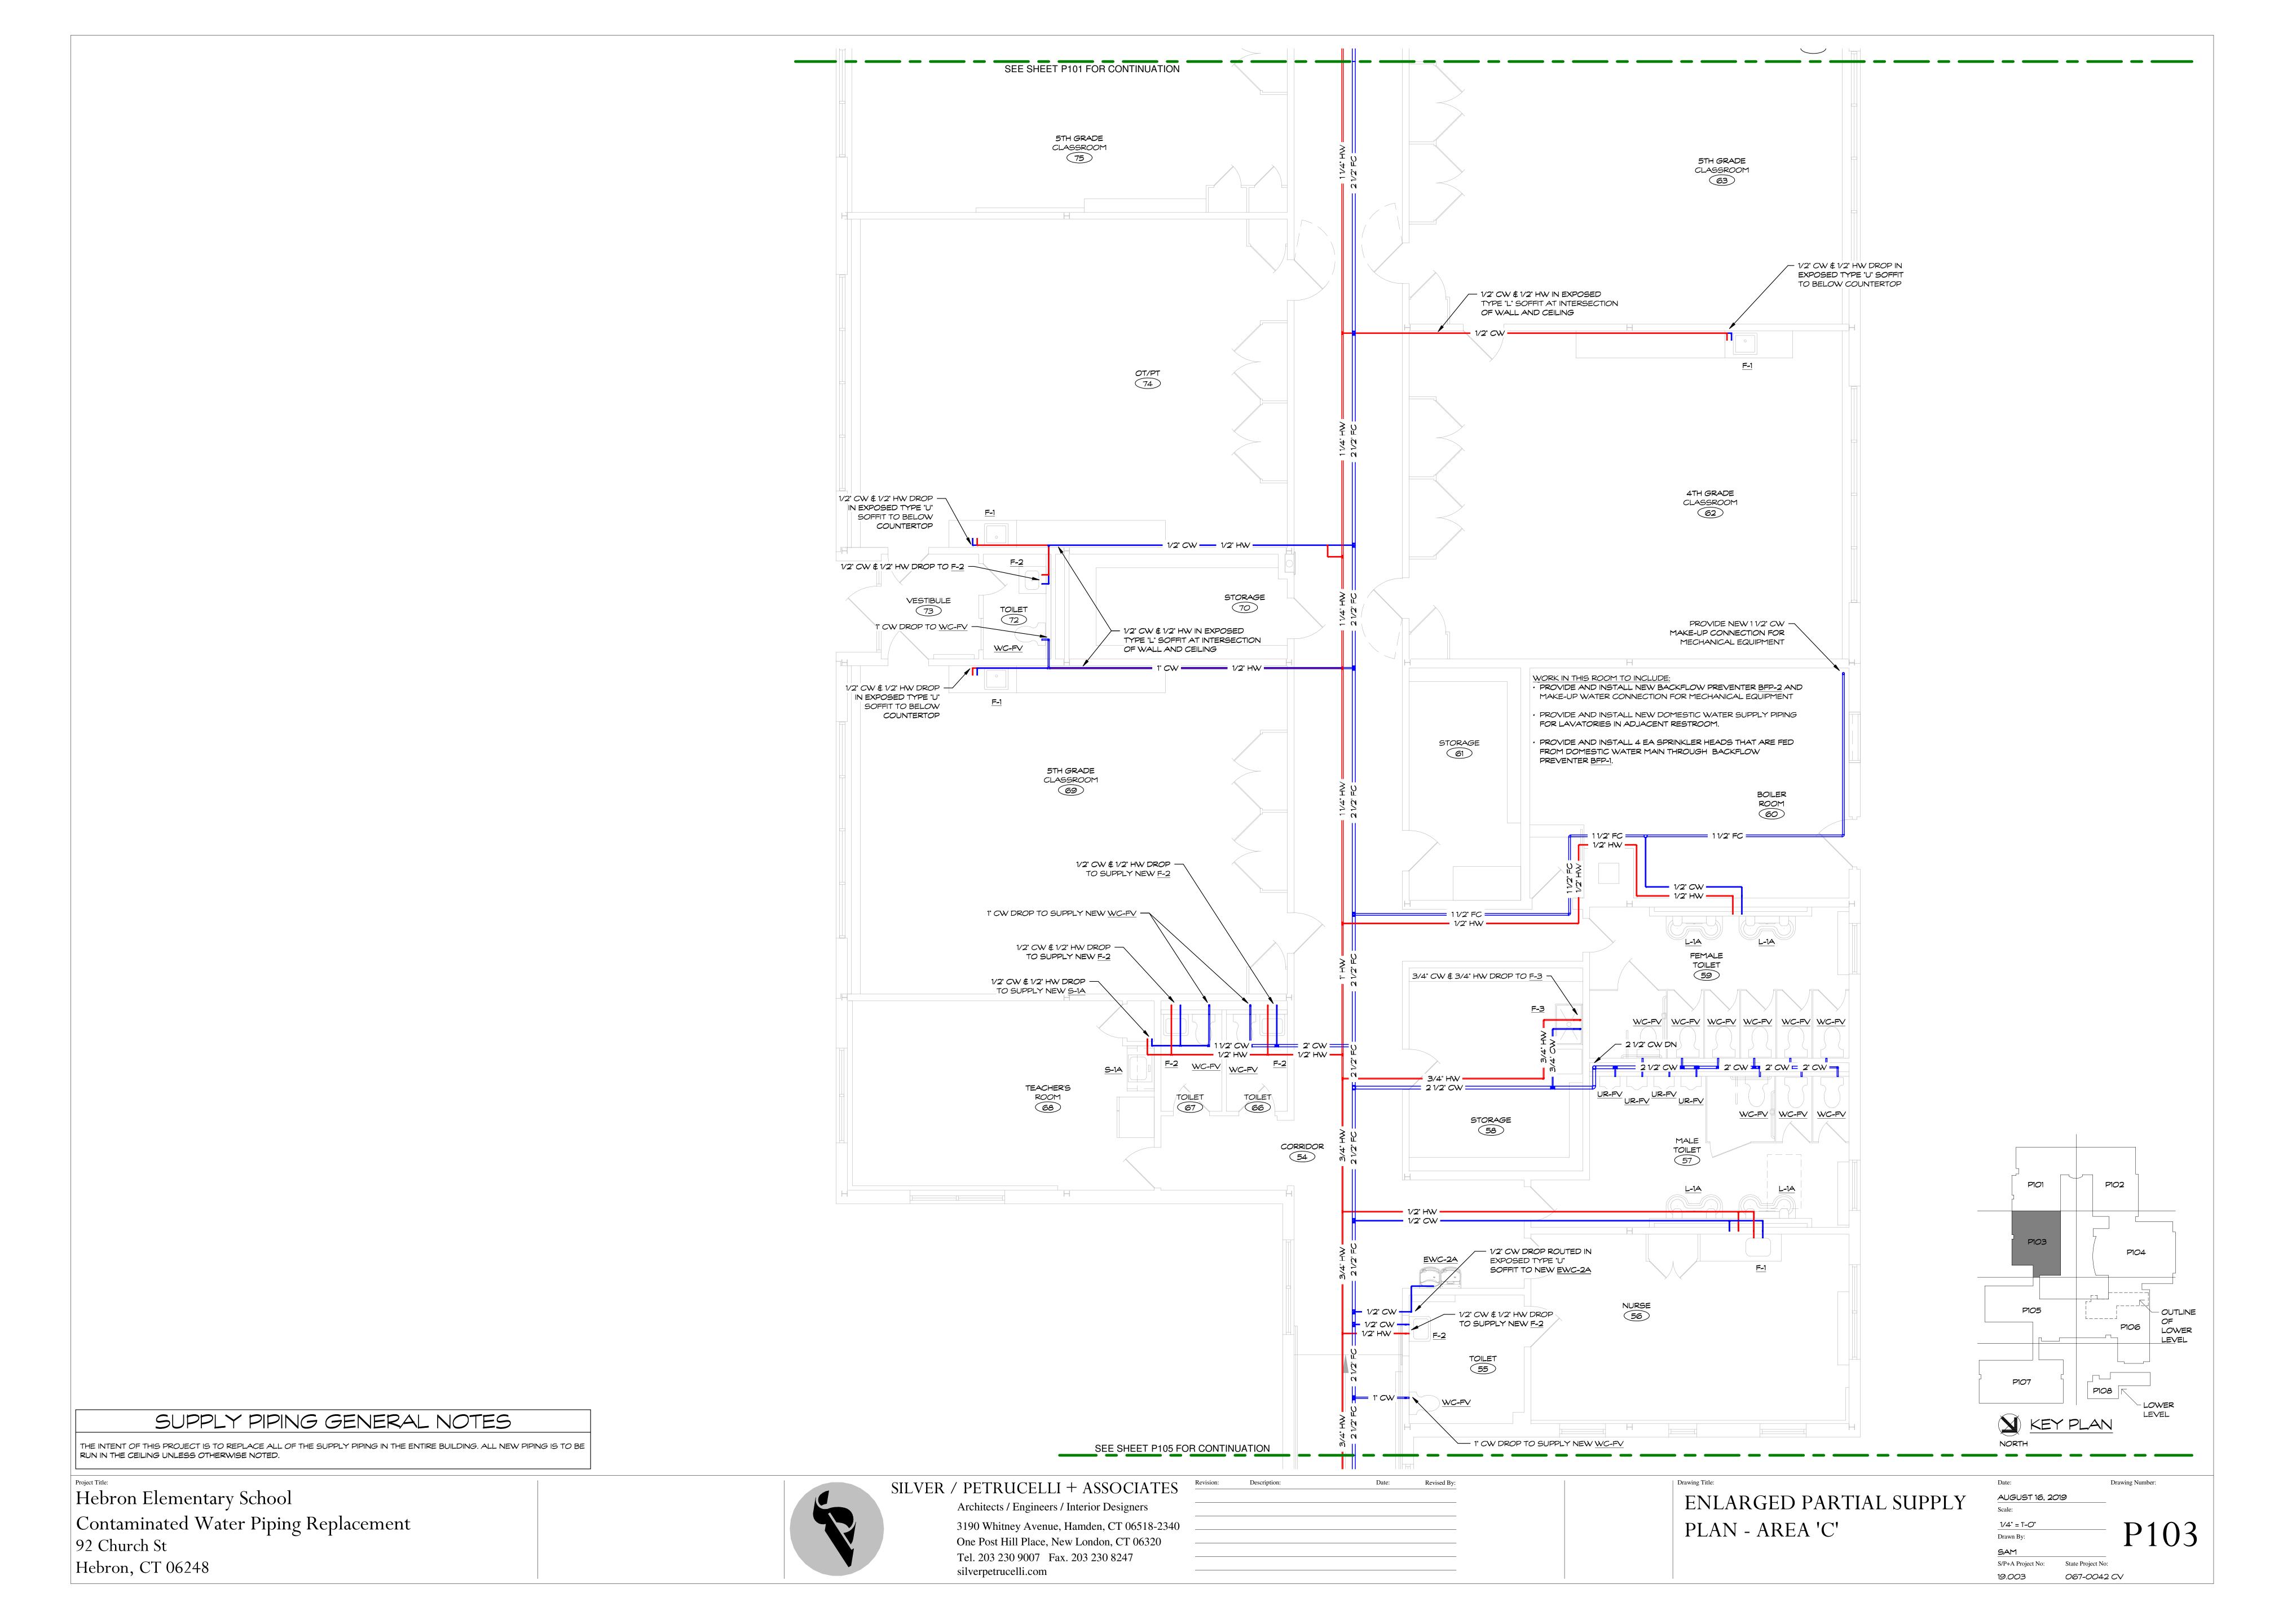


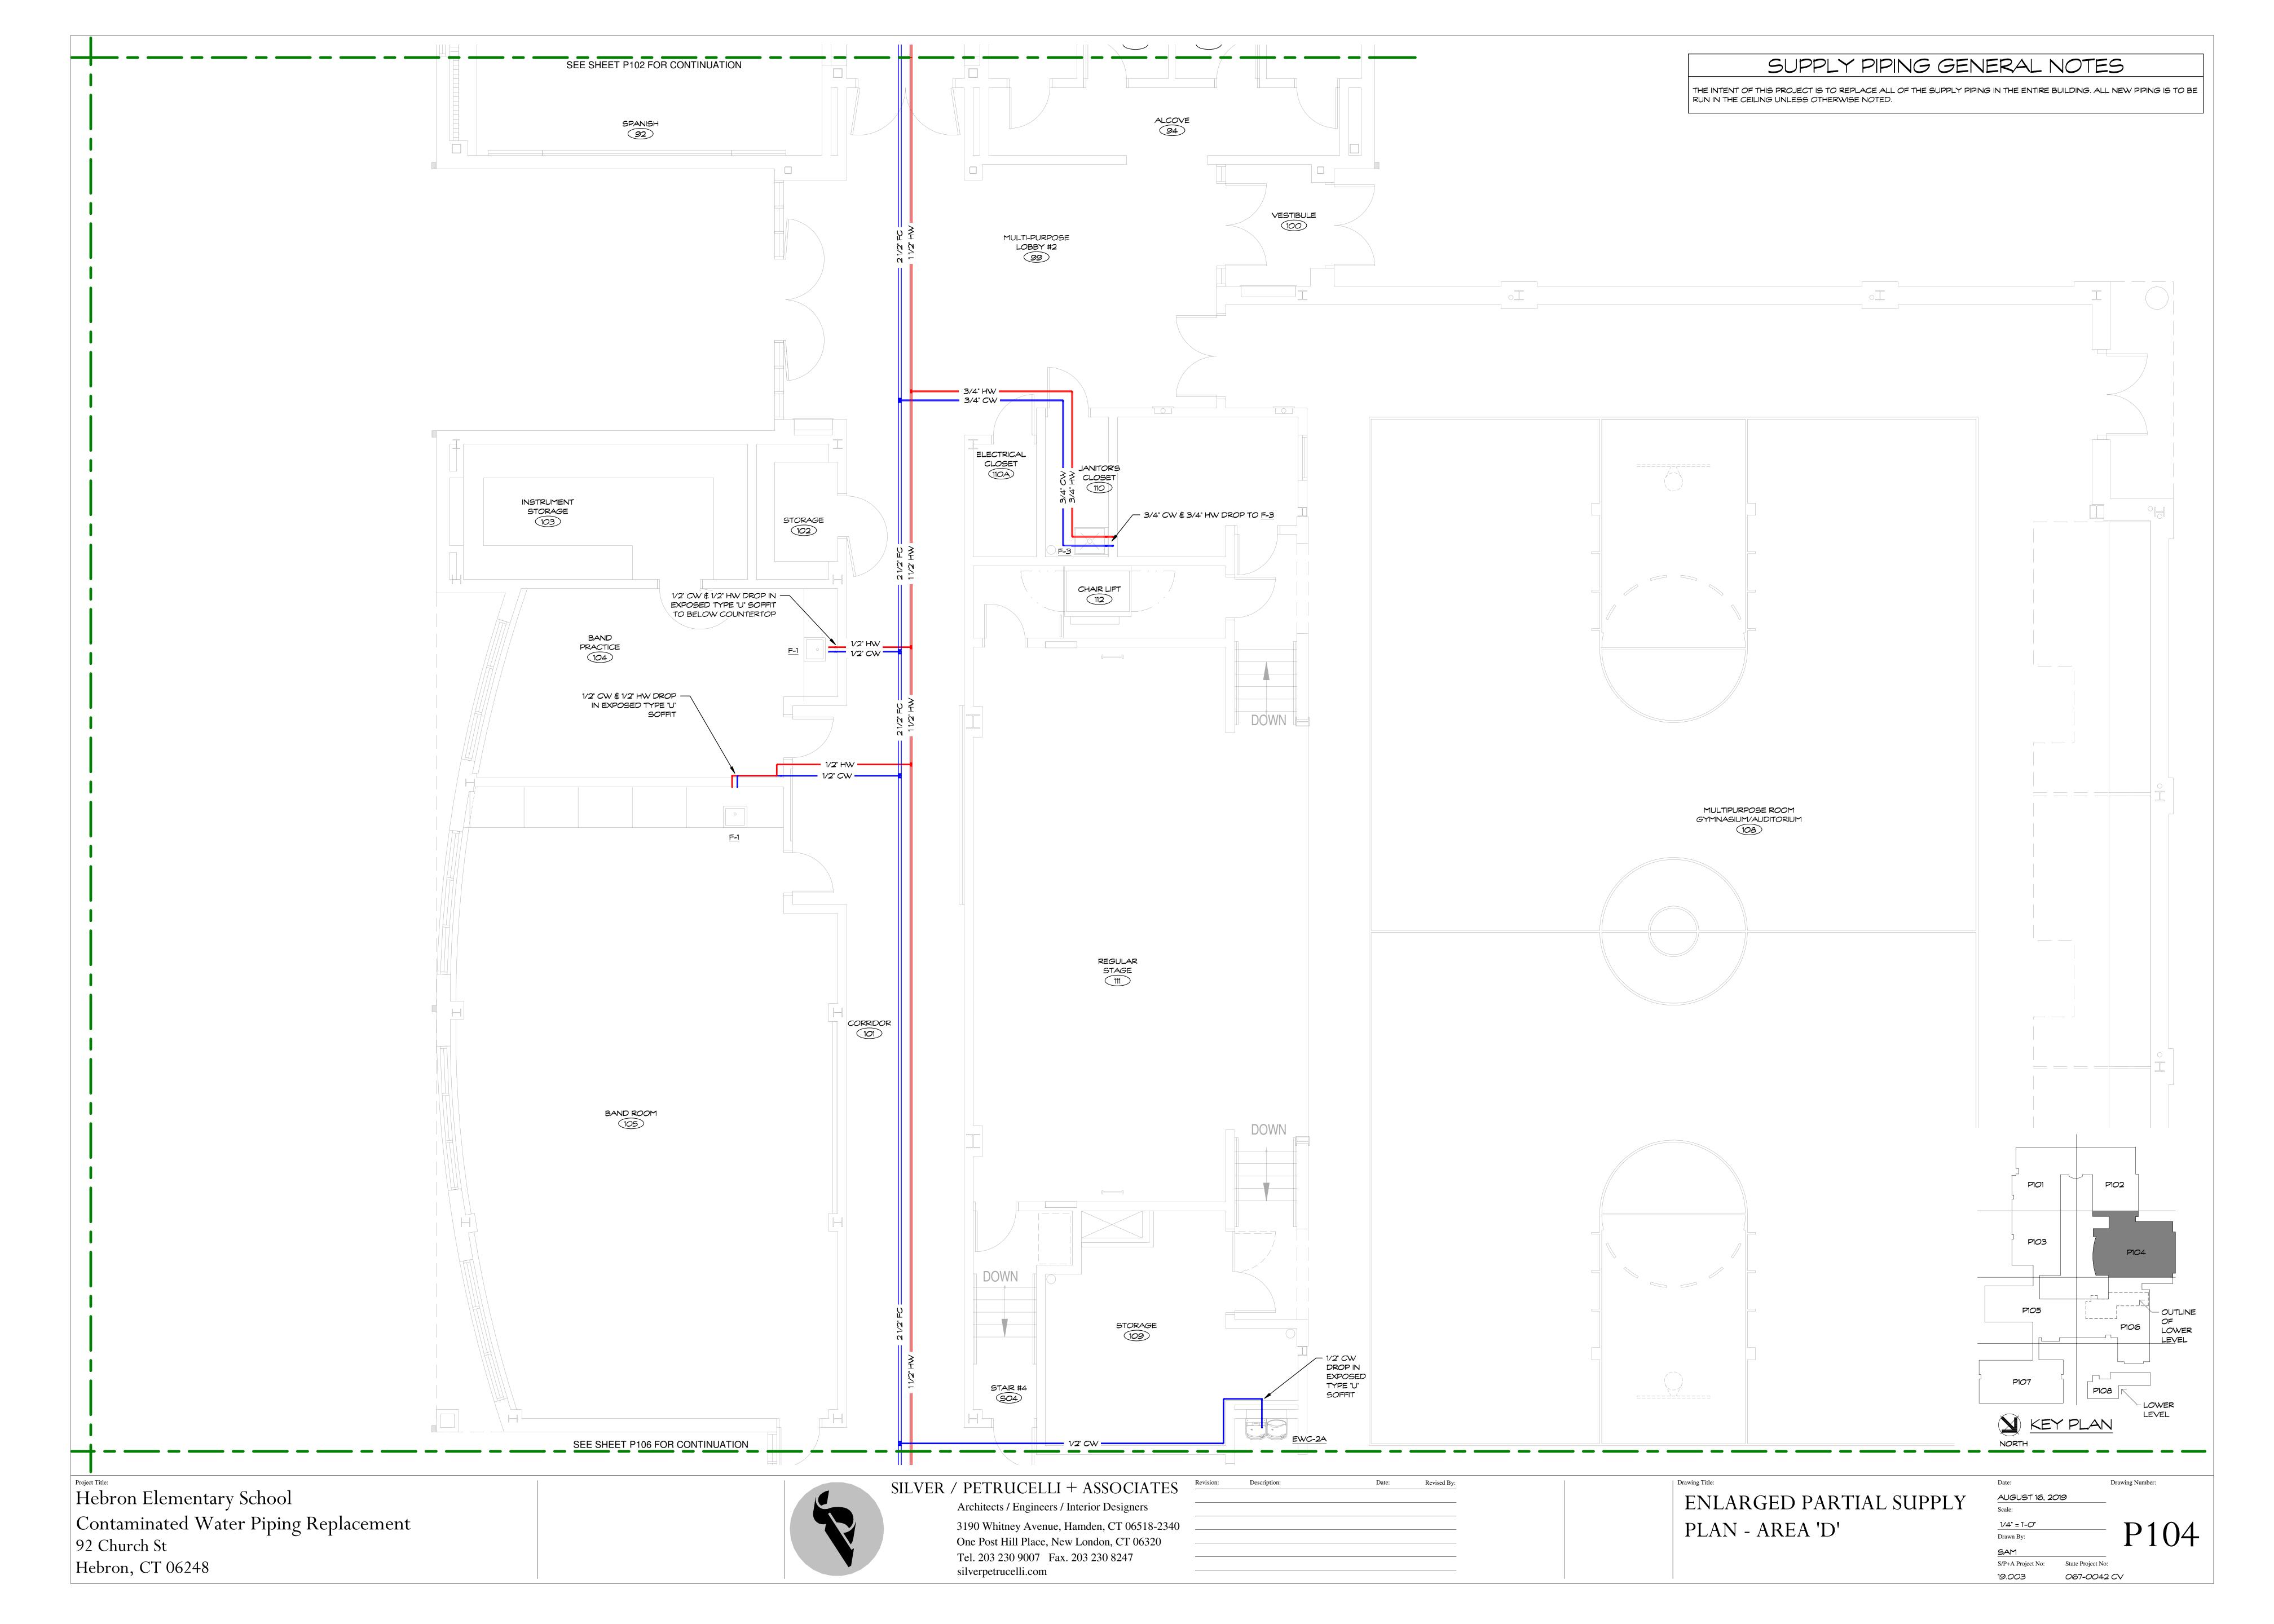


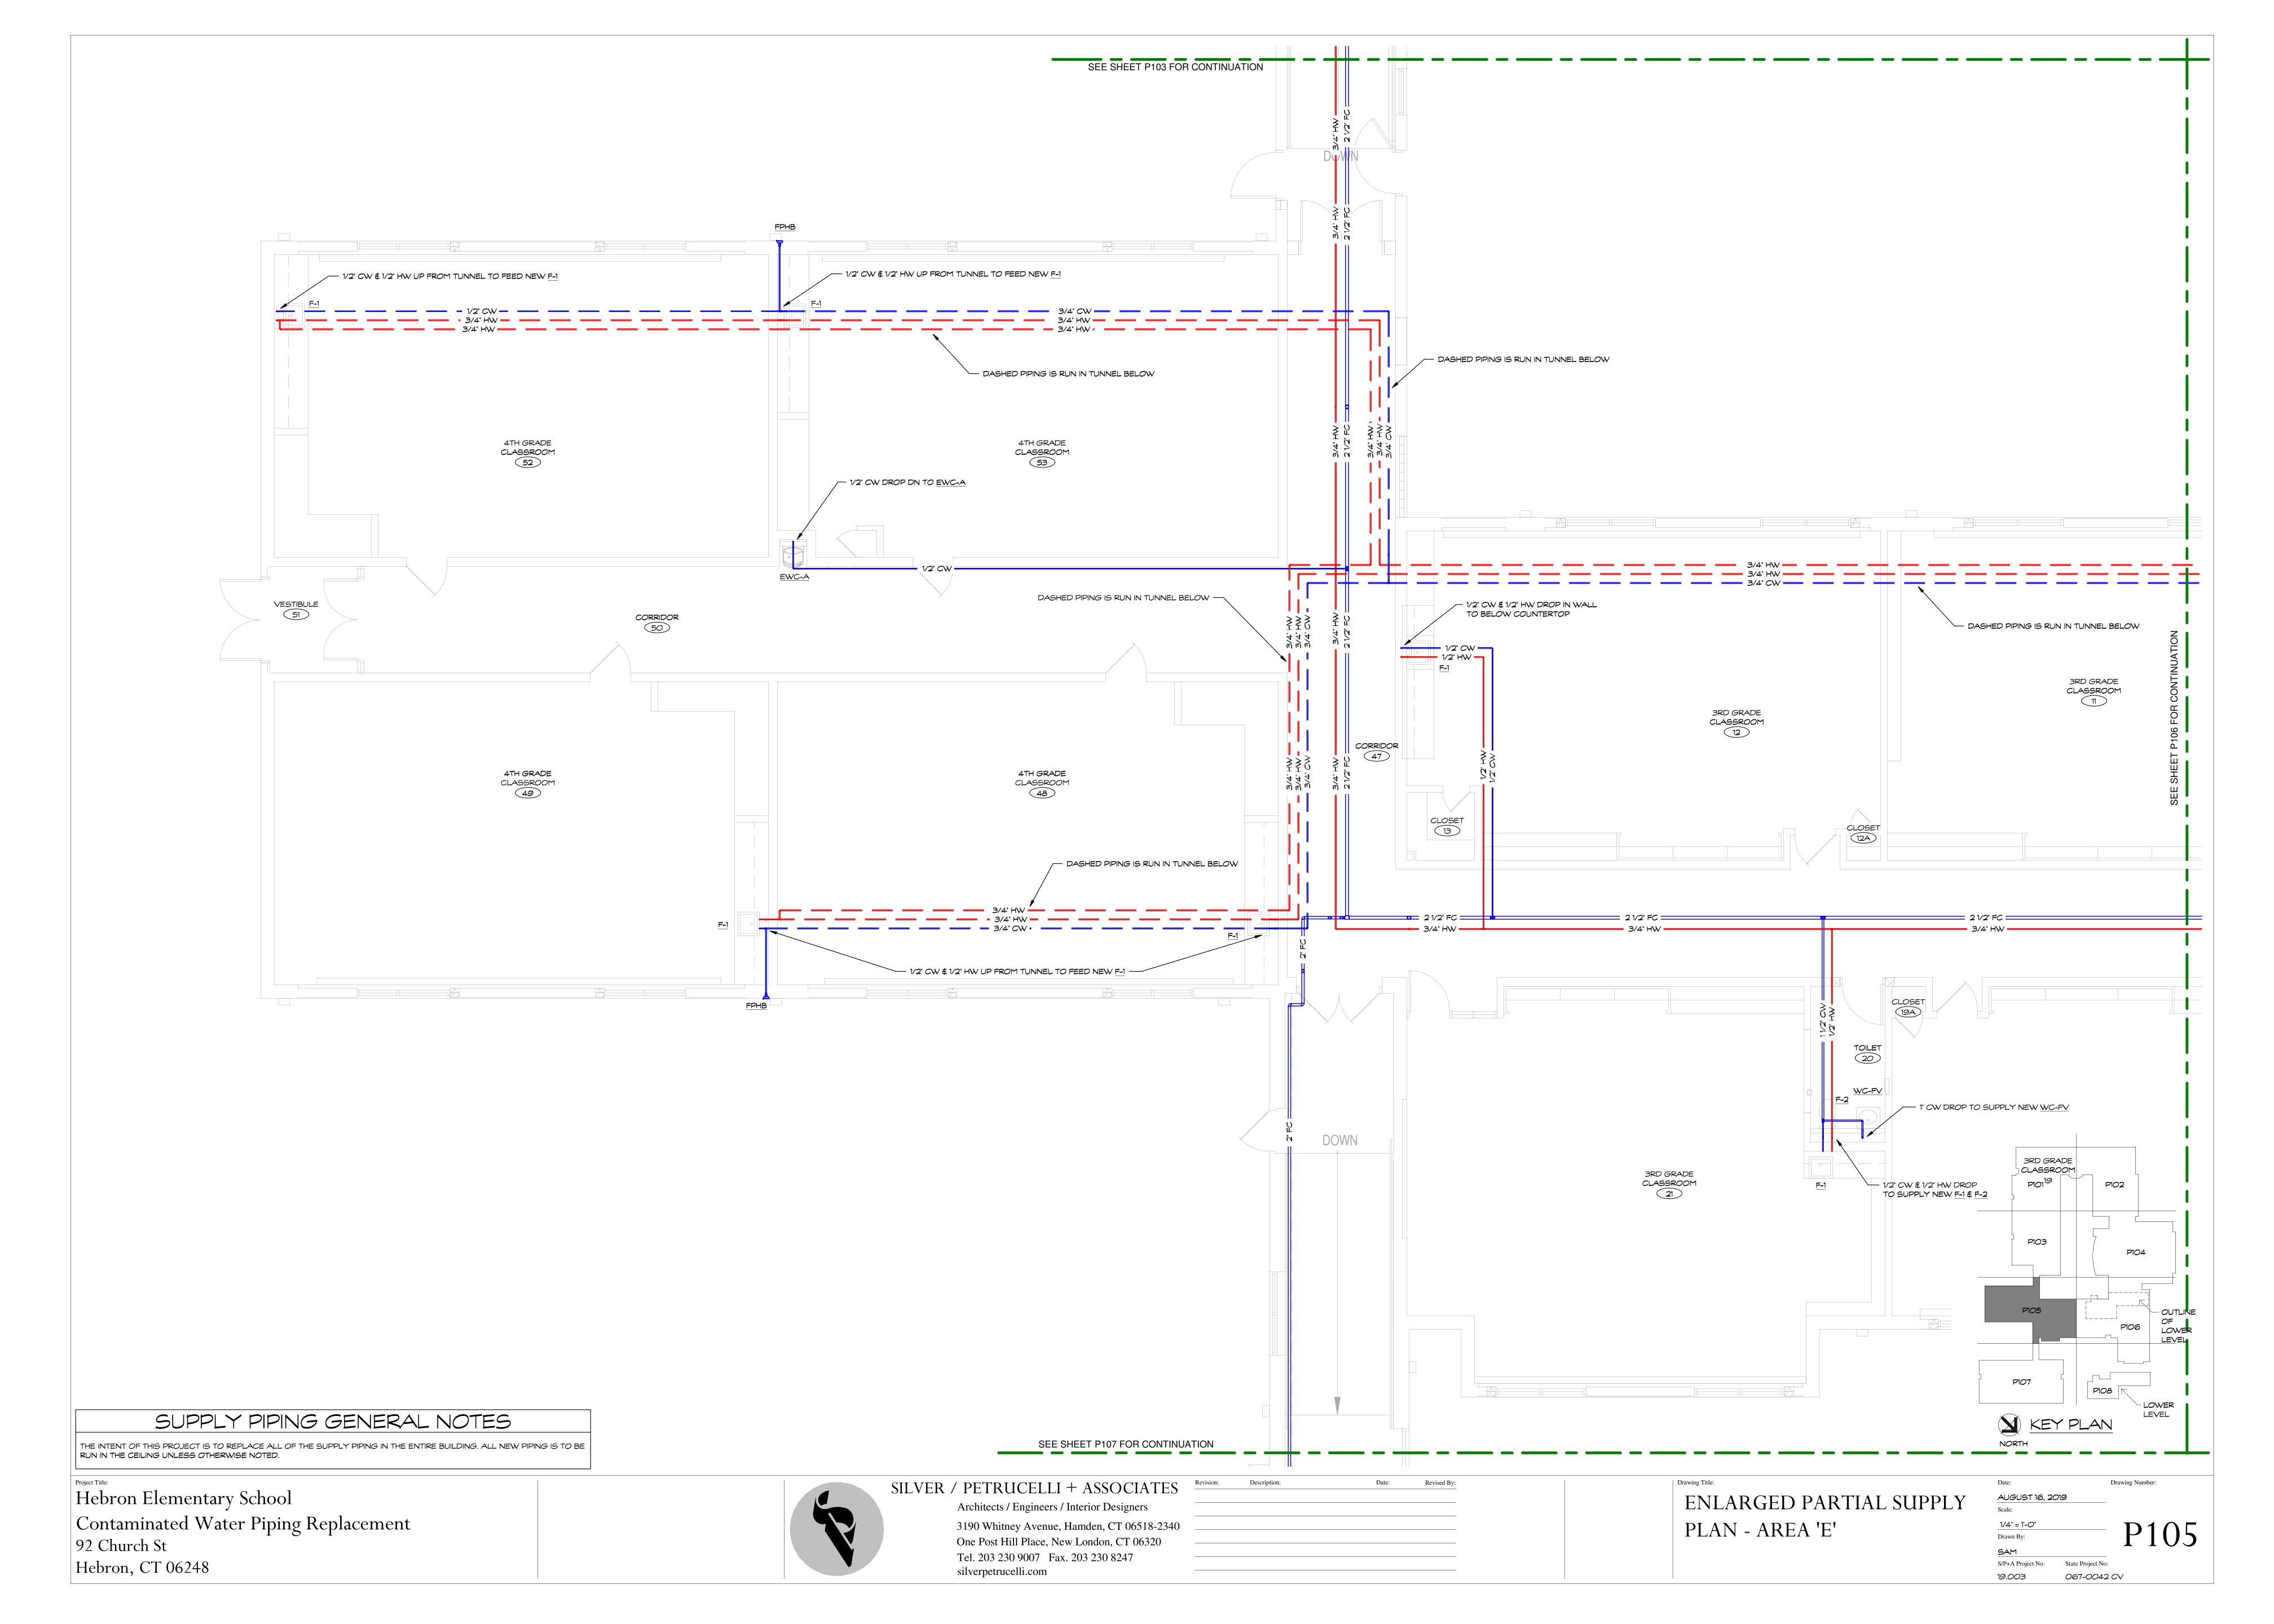

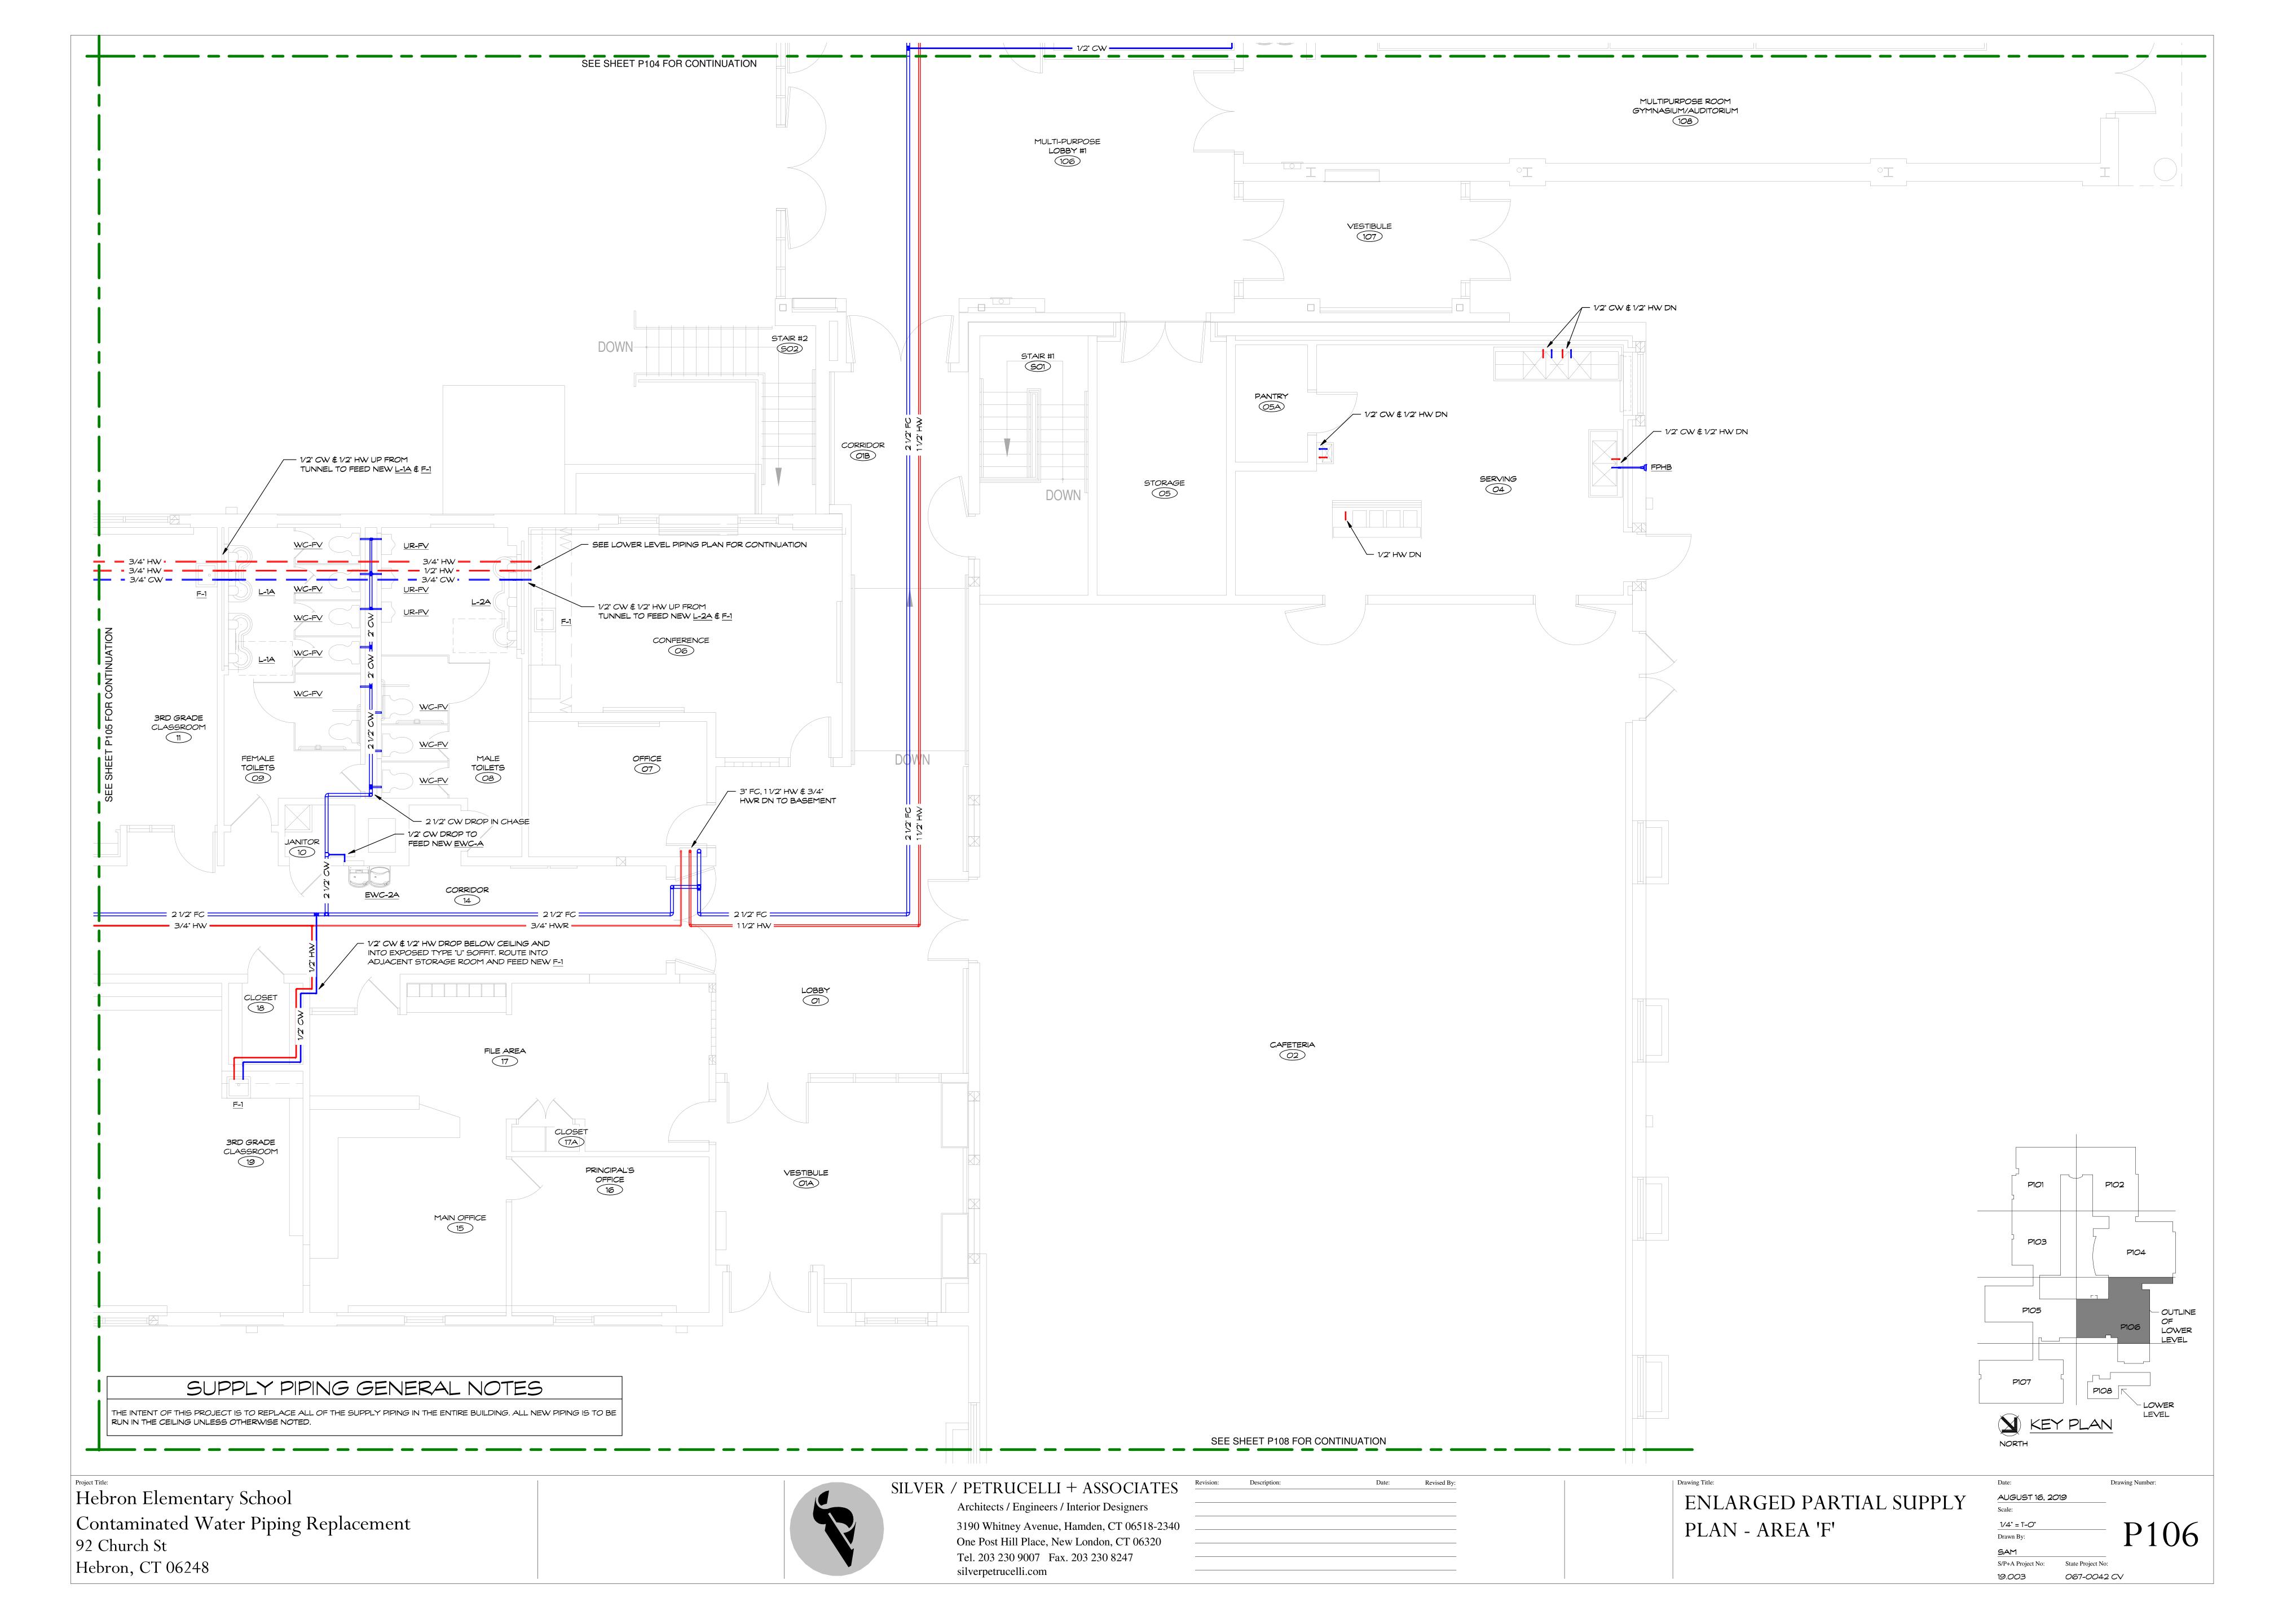

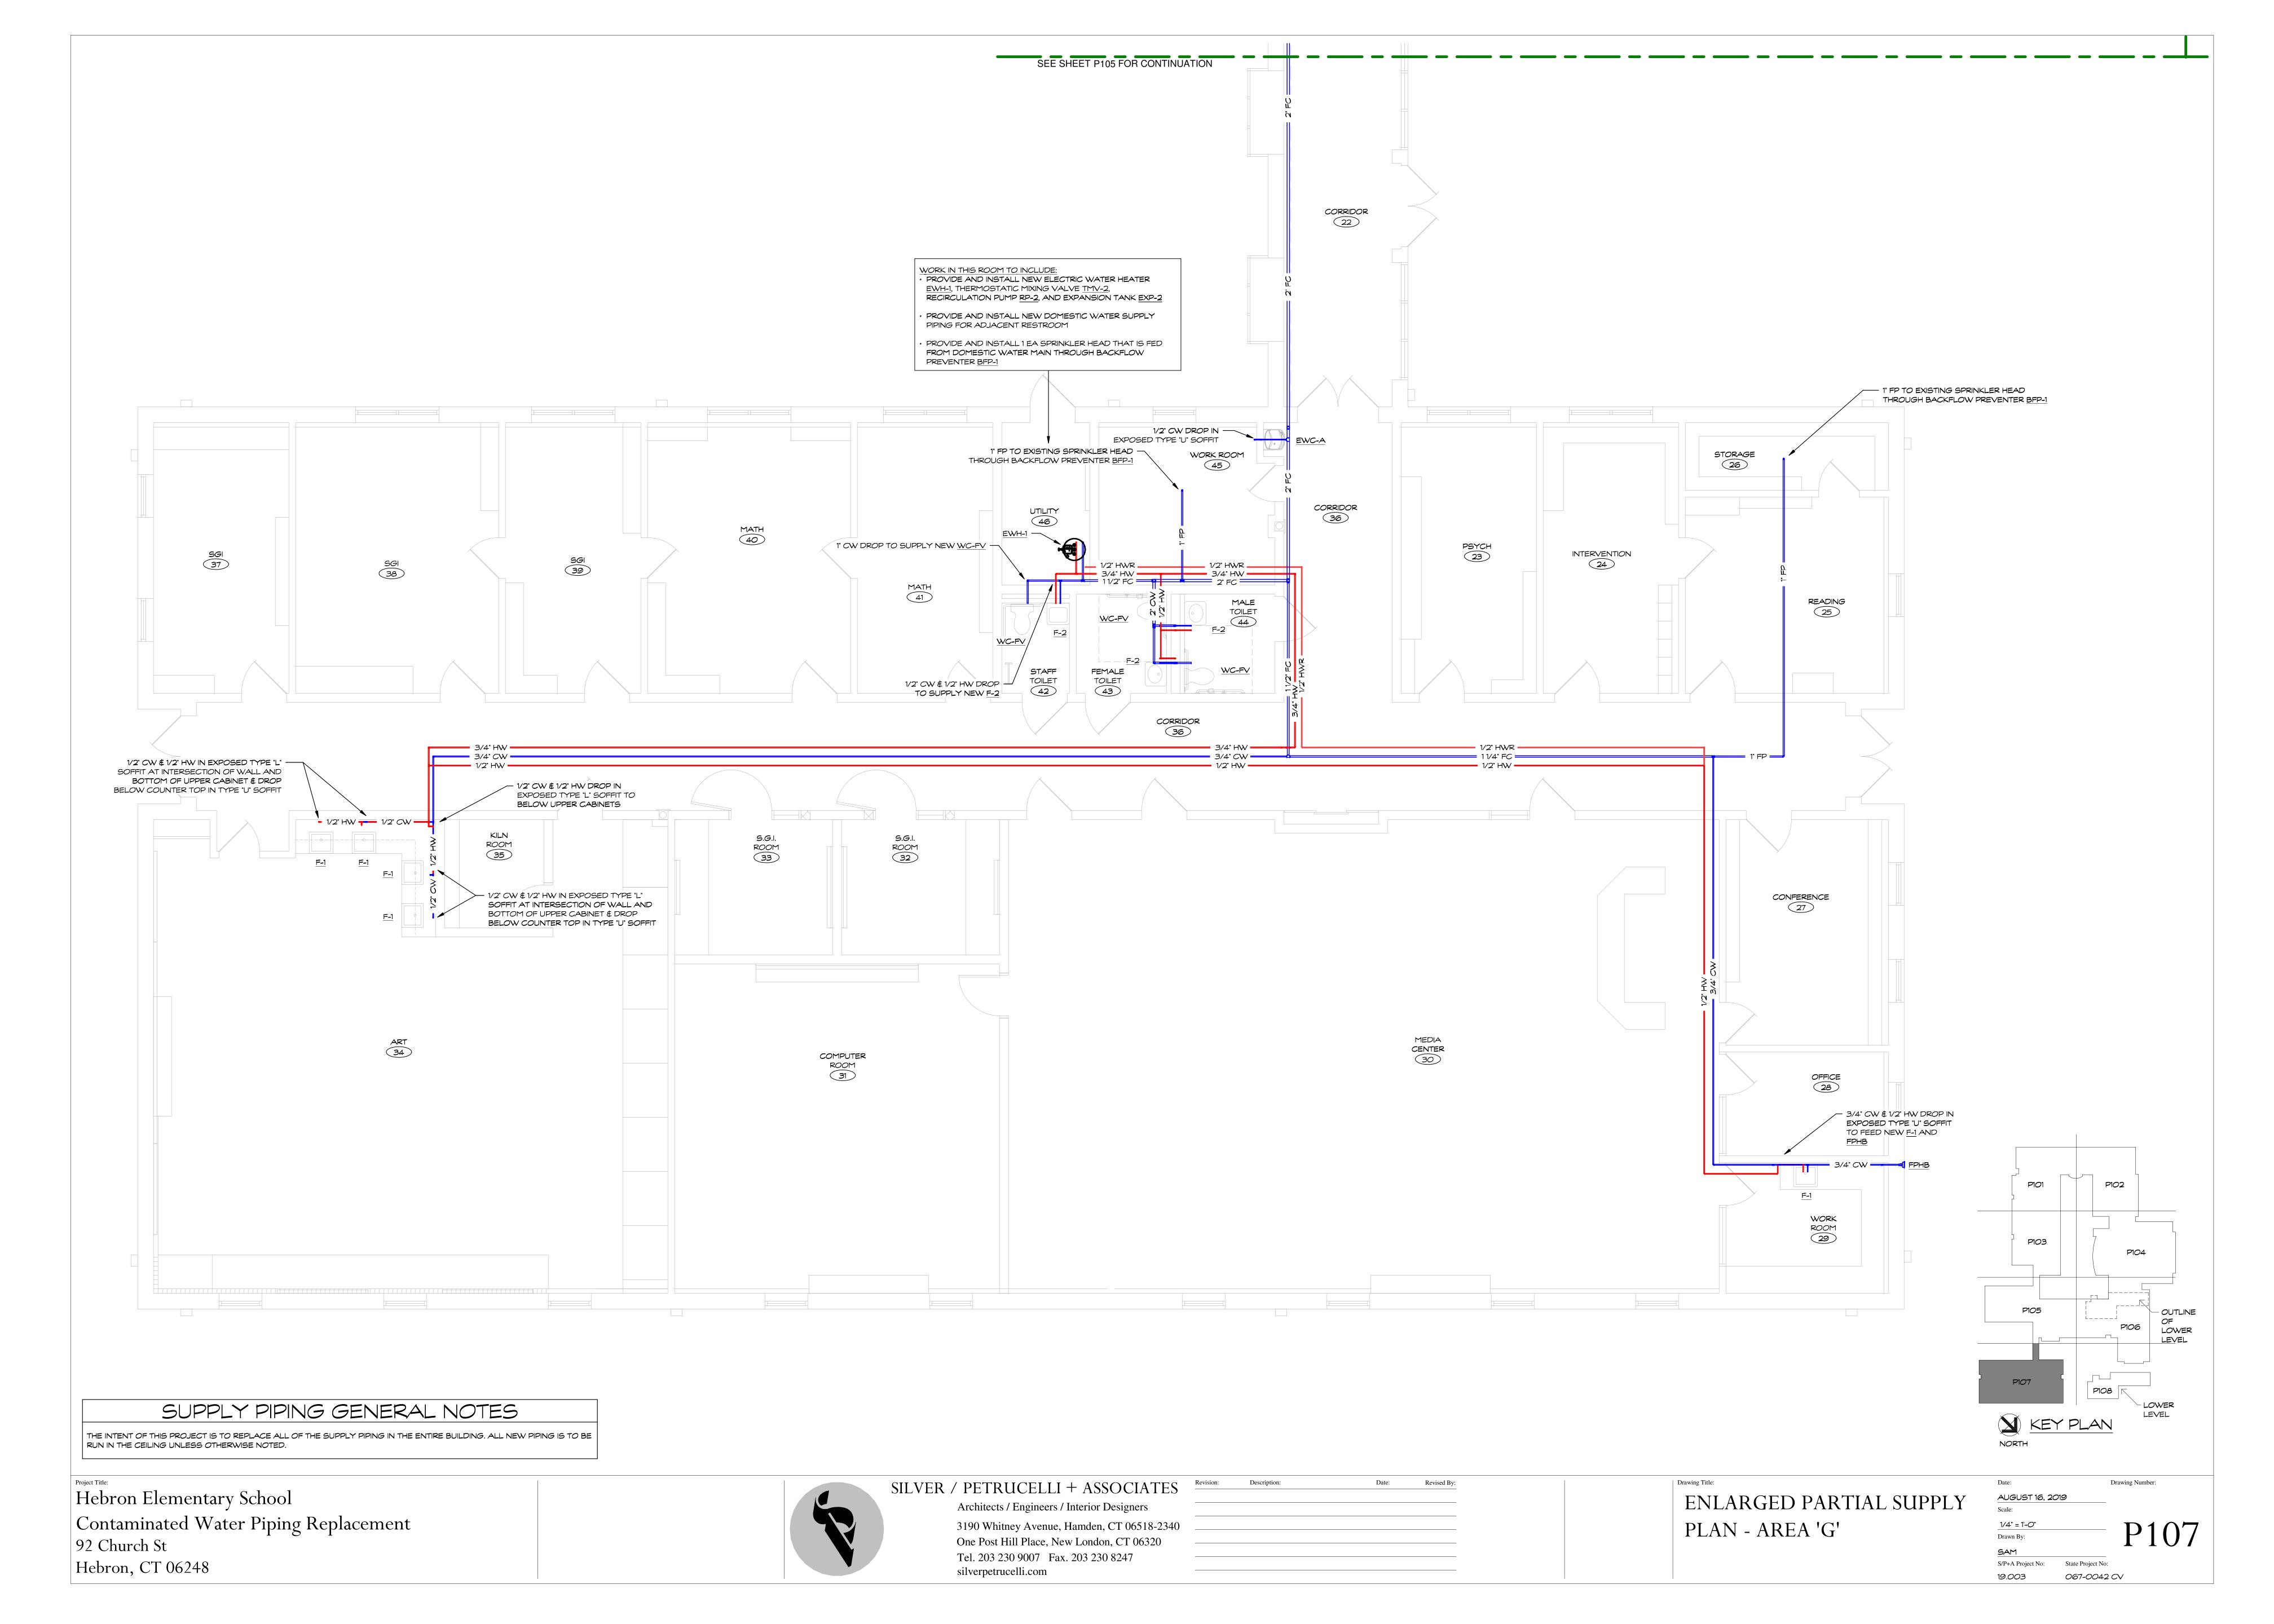

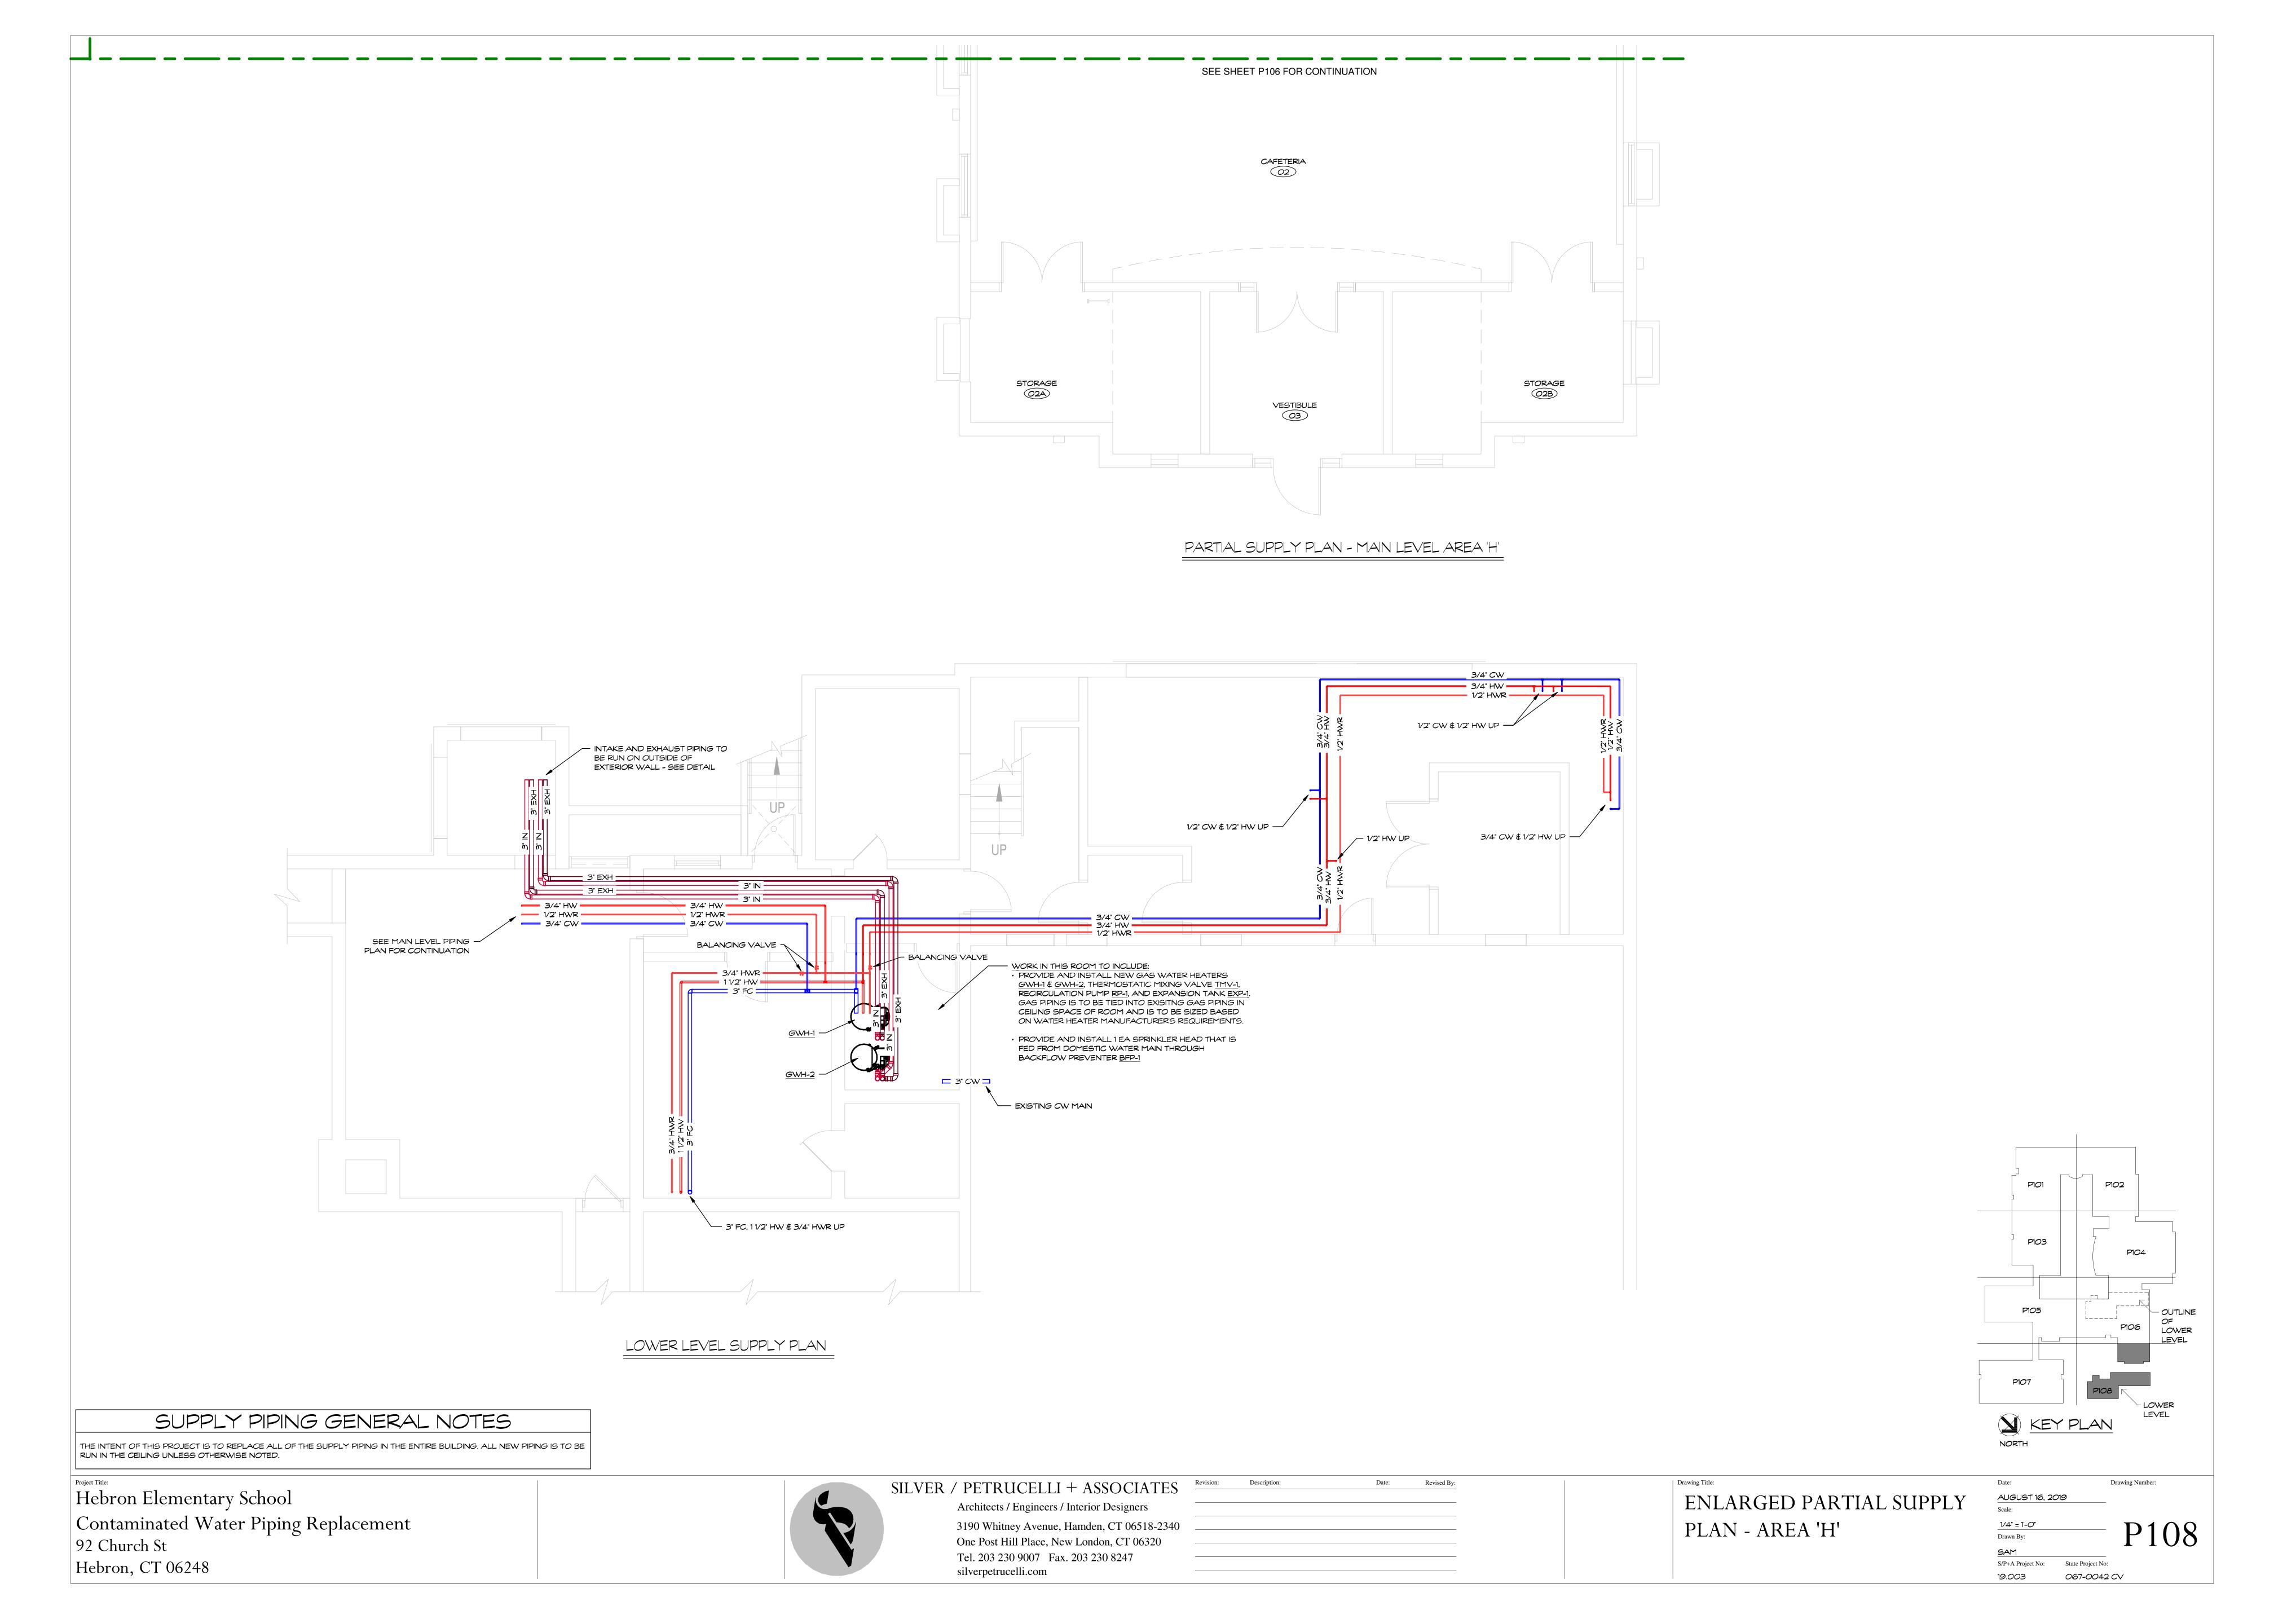

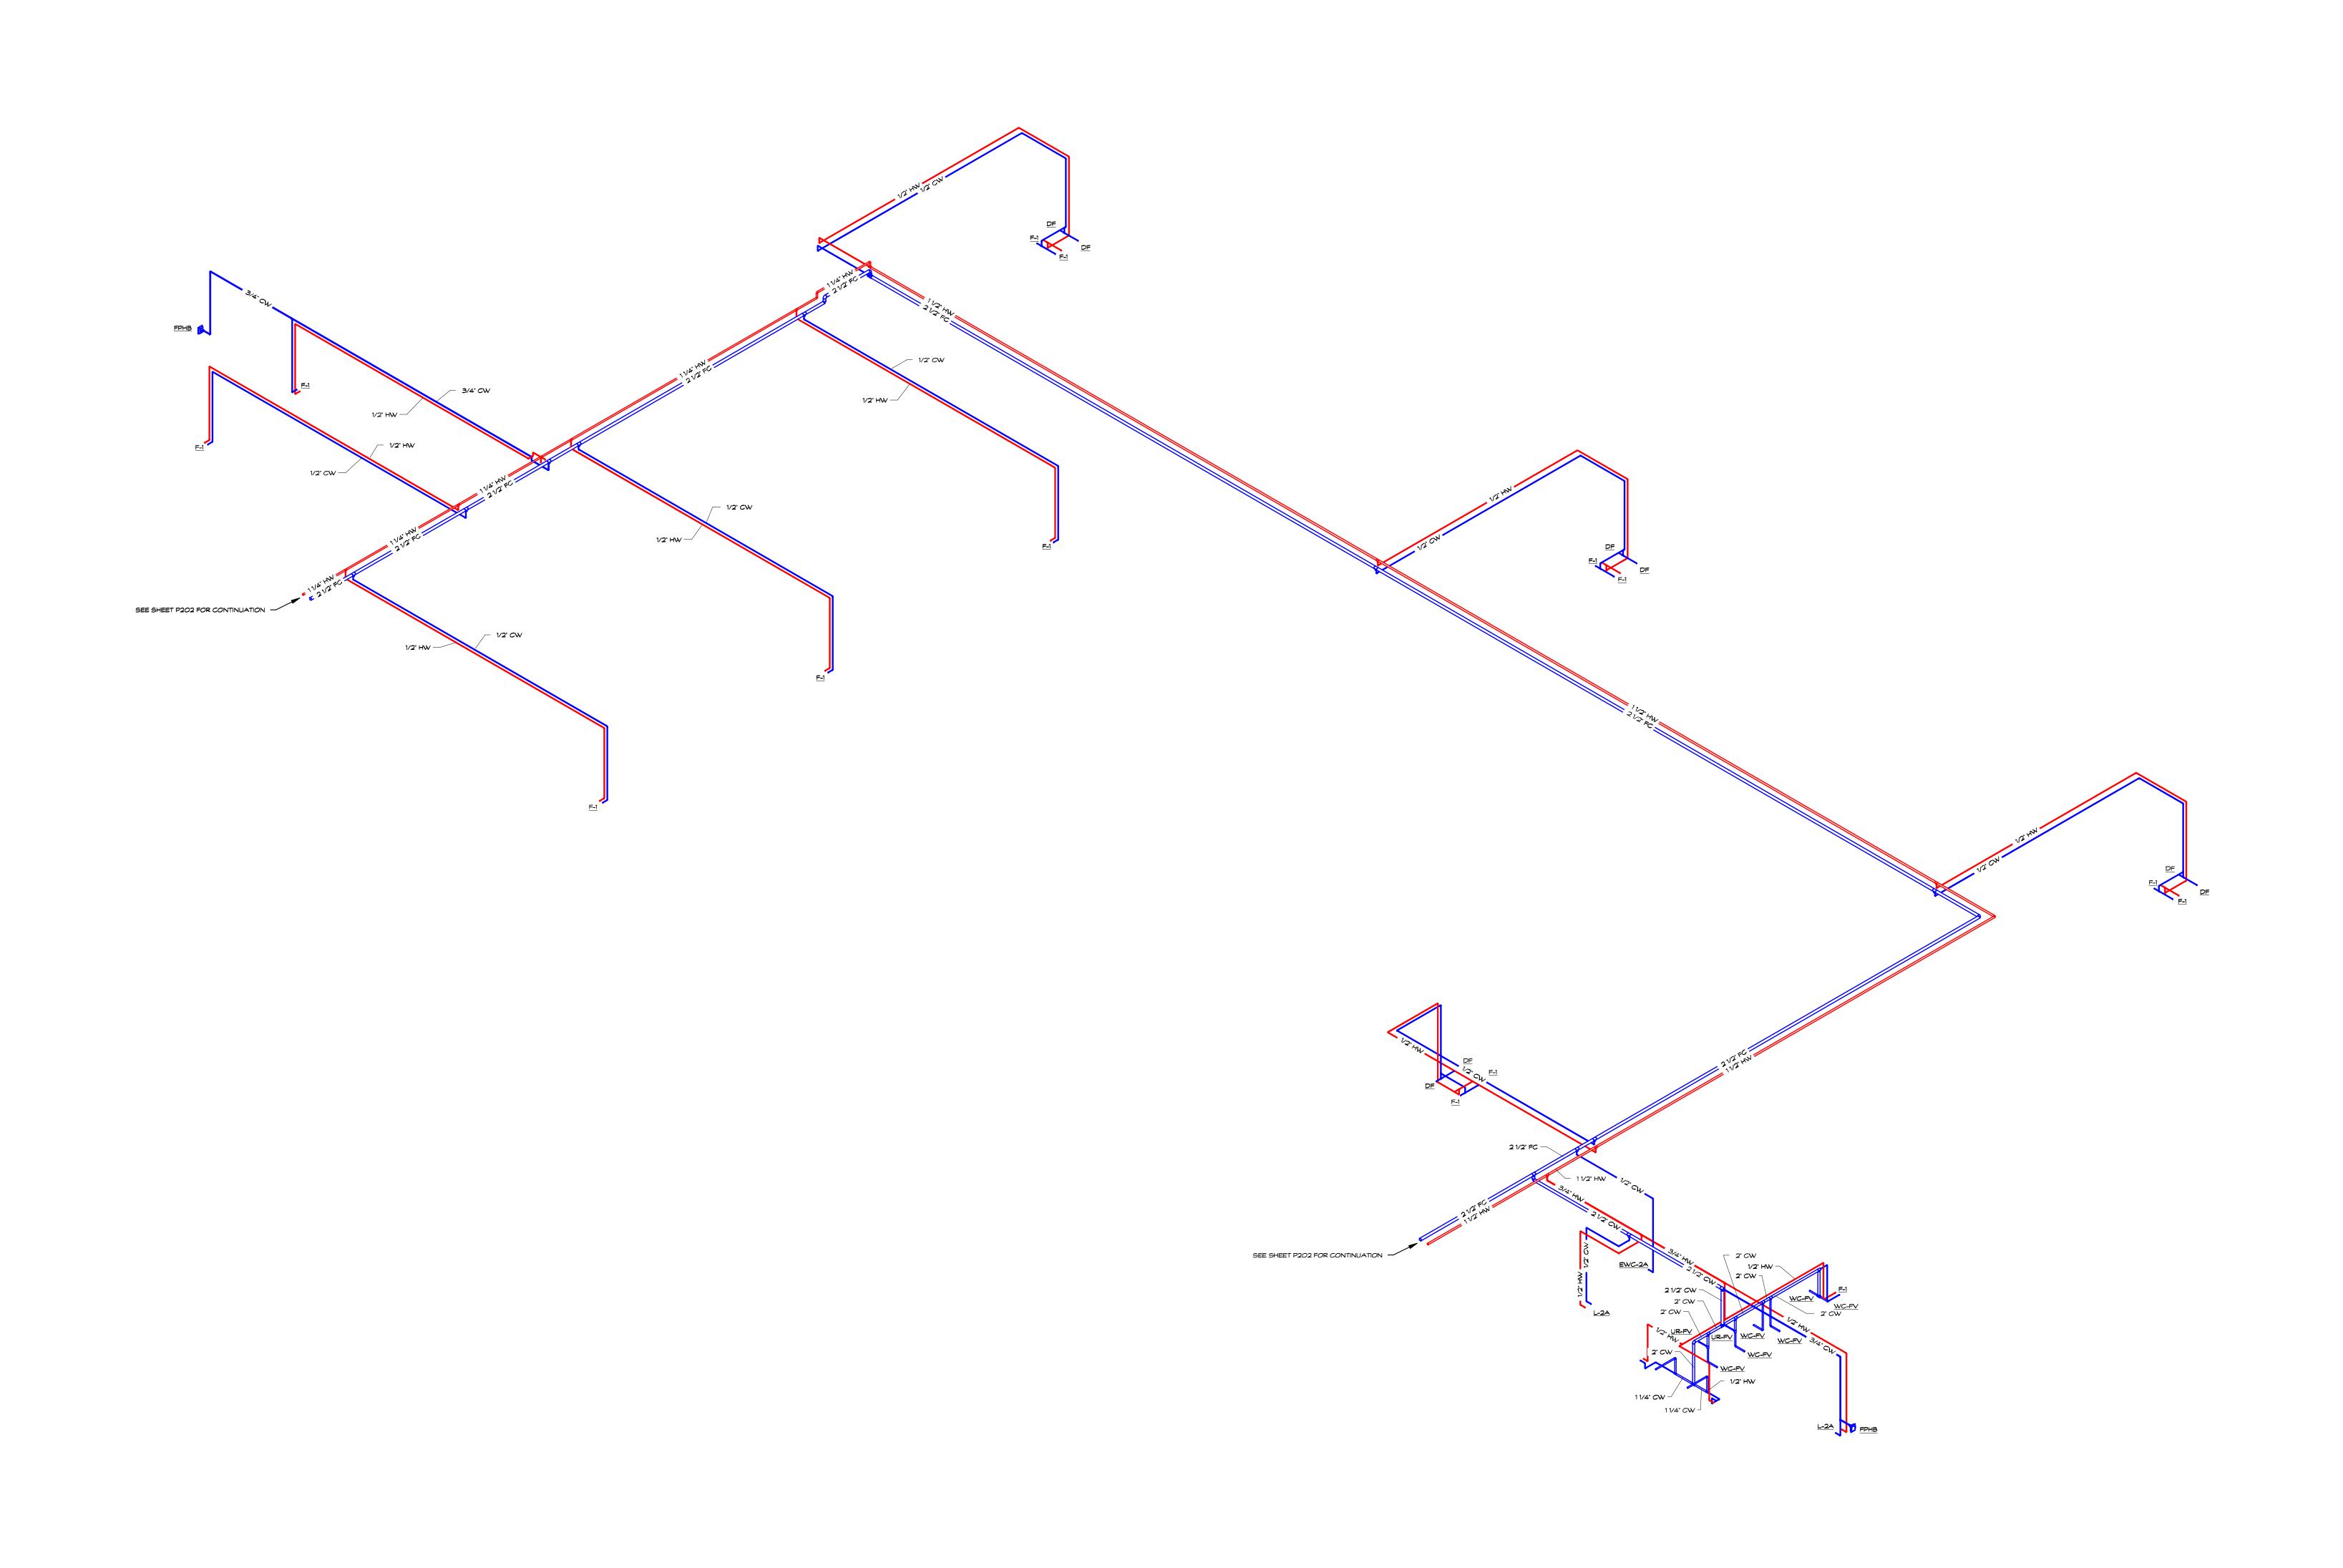

Hebron Elementary School
Contaminated Water Piping Replacement
92 Church St
Hebron, CT 06248



SILVER / PETRUCELLI + ASSOCIATES

Architects / Engineers / Interior Designers

3190 Whitney Avenue, Hamden, CT 06518-2340
One Post Hill Place, New London, CT 06320
Tel. 203 230 9007 Fax. 203 230 8247

silverpetrucelli.com


Revision:	Description:	Date:	Revised By:

SUPPLY ISOMETRIC AREAS
A & B

Date: Drawing Number:

AUGUST 16, 2019
Scale: P201

Drawn By: P4A Project No: State Project No: 19.003 067-0042 CV

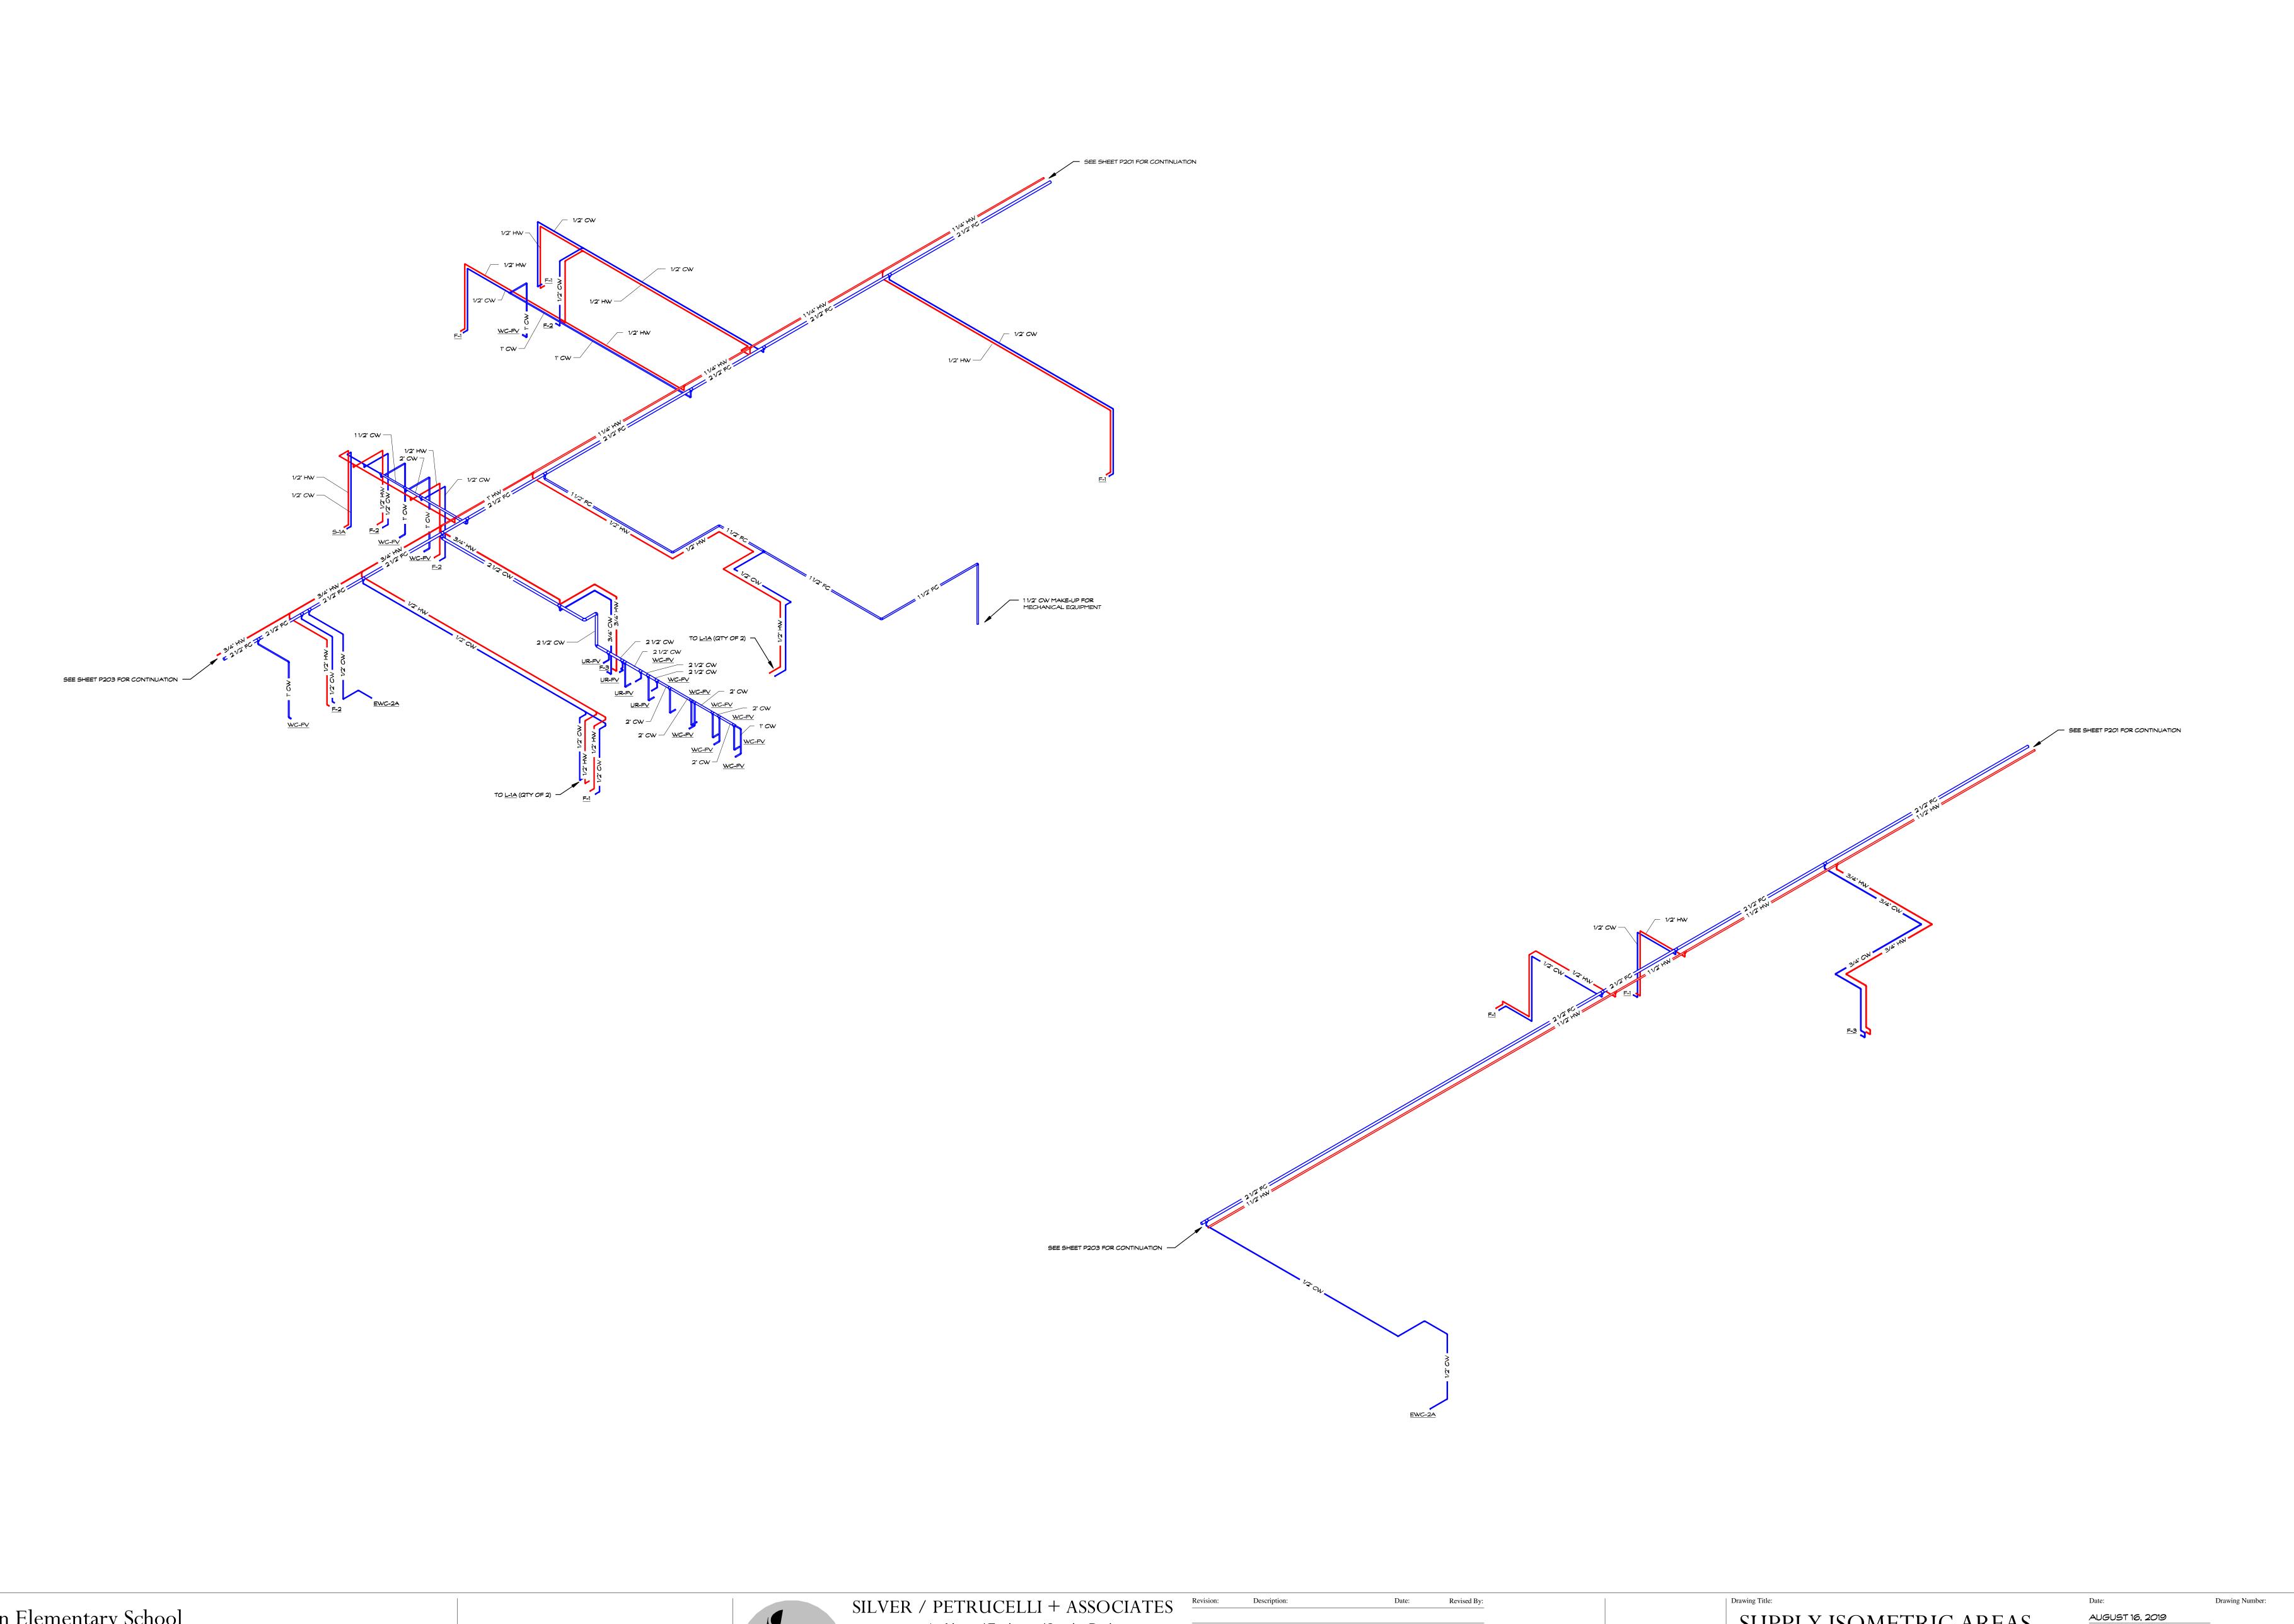

Hebron Elementary School
Contaminated Water Piping Replacement
92 Church St
Hebron, CT 06248



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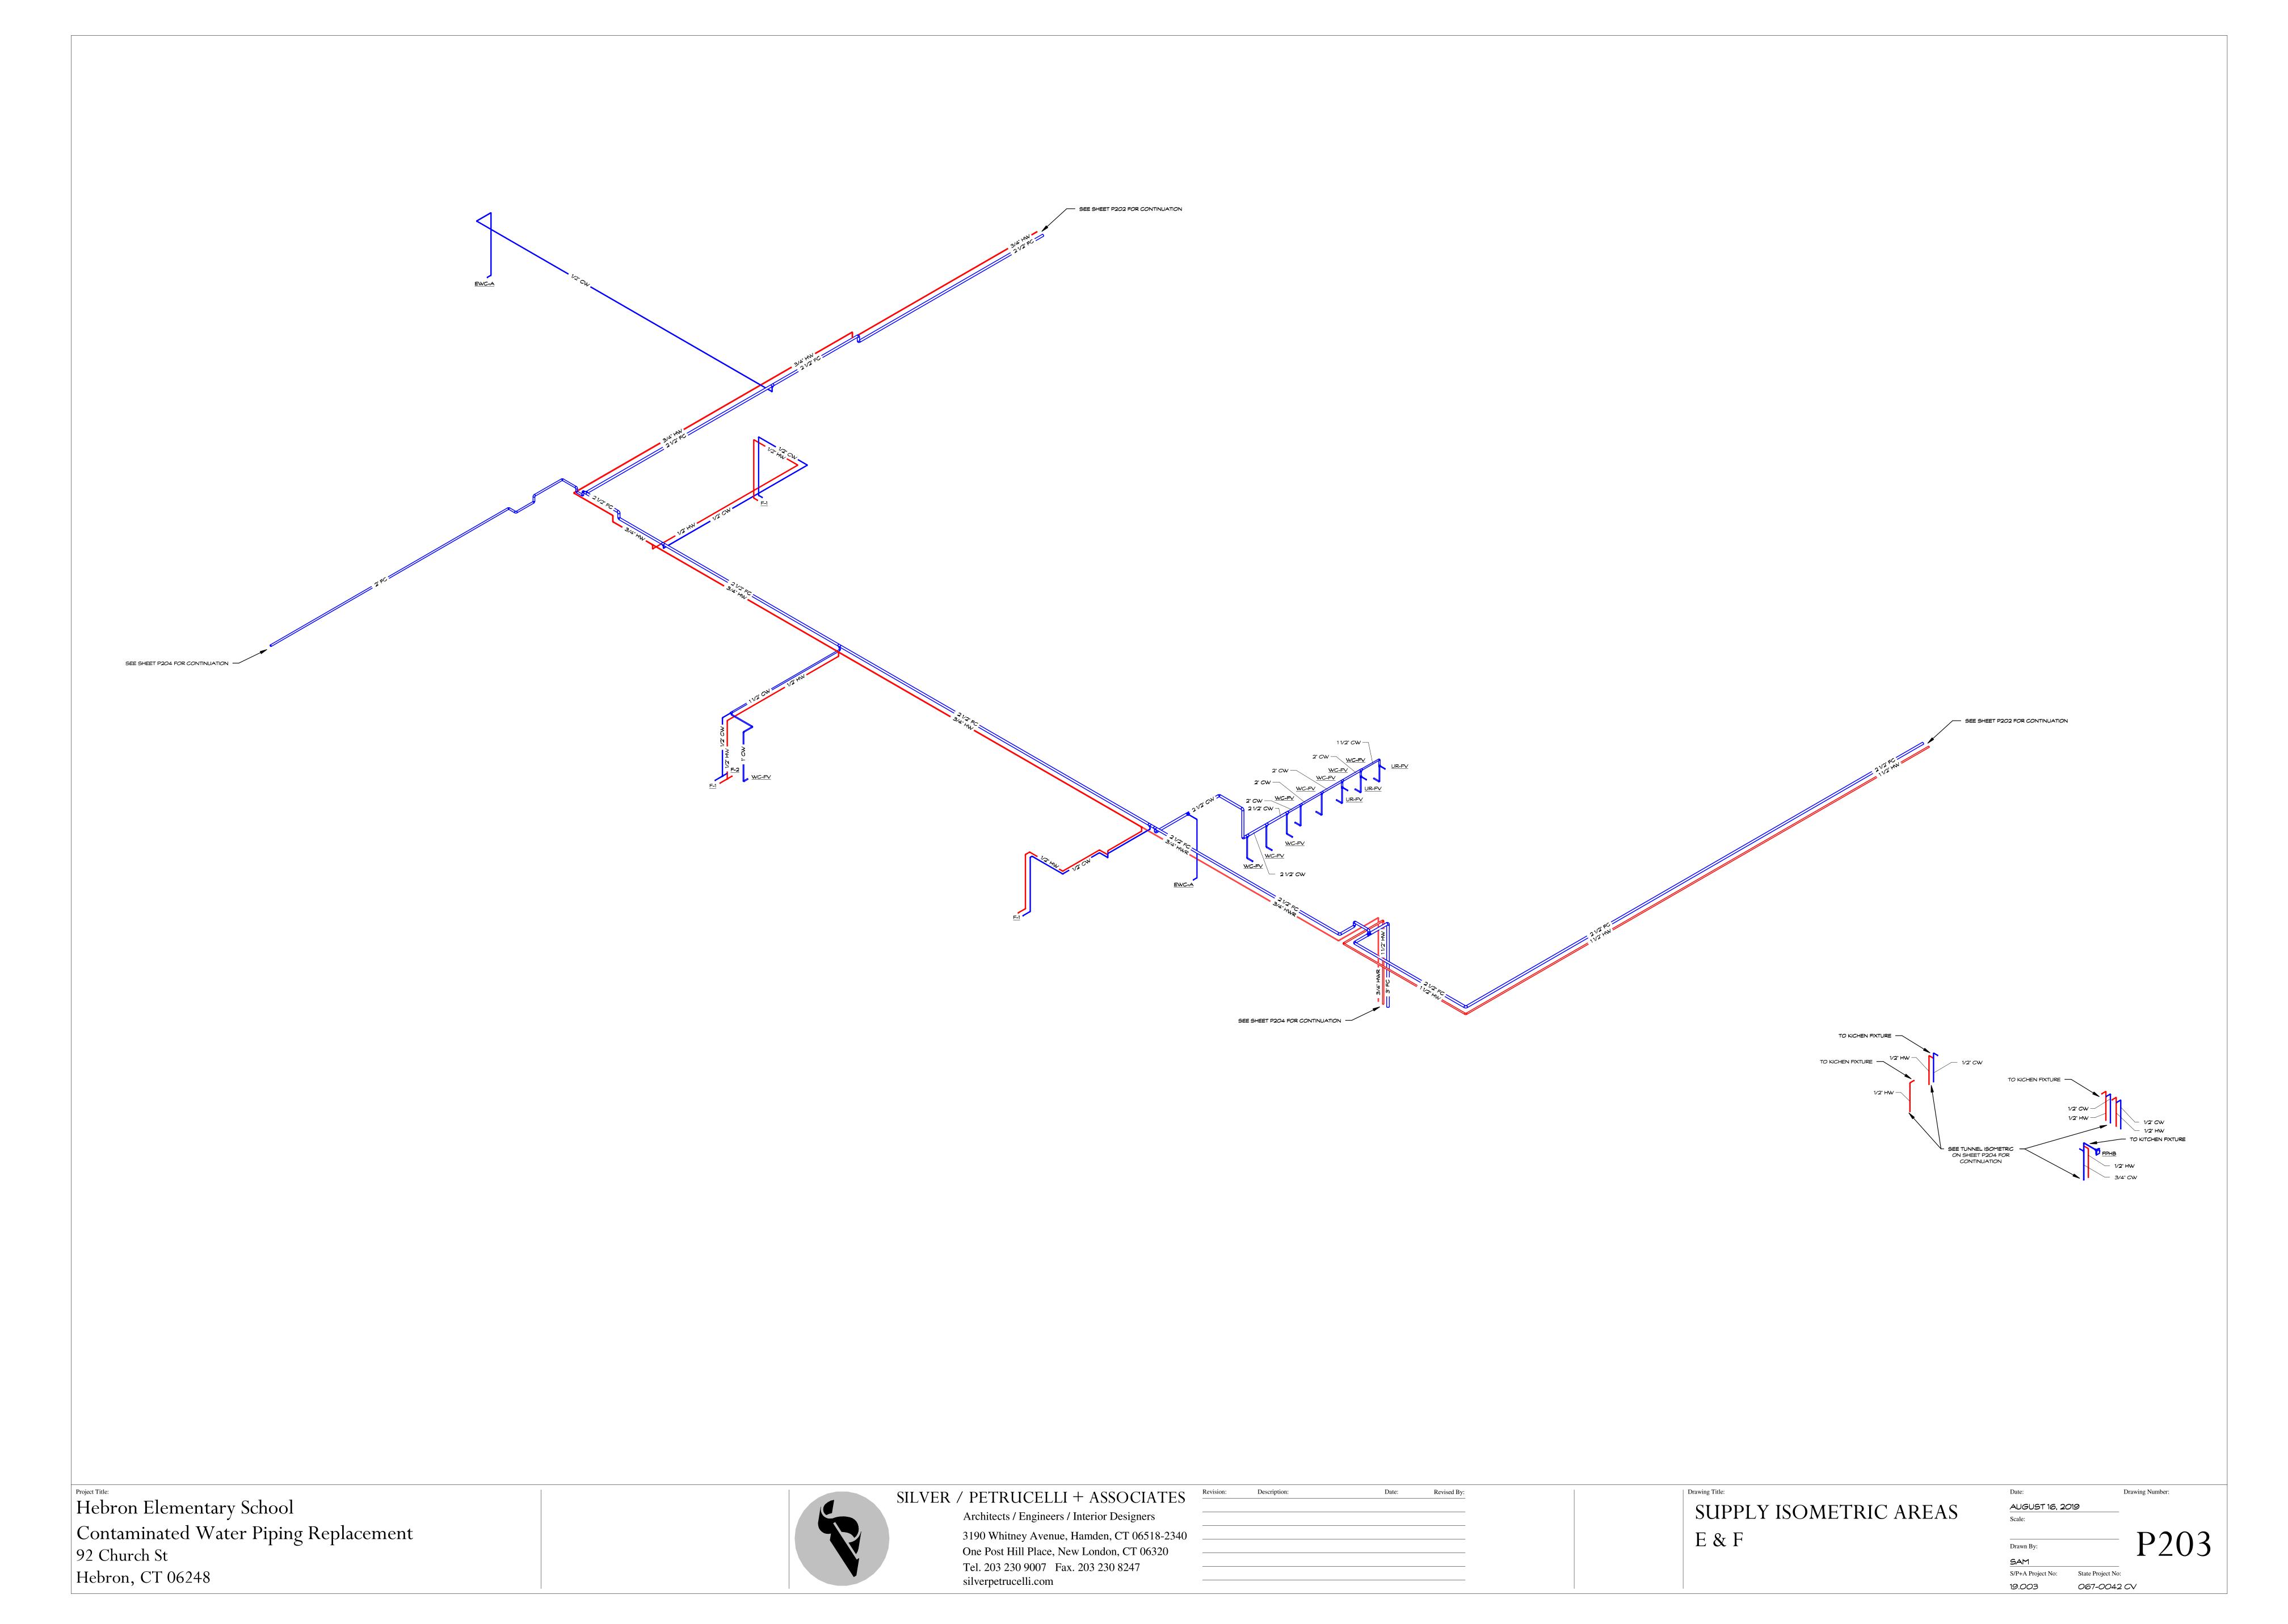
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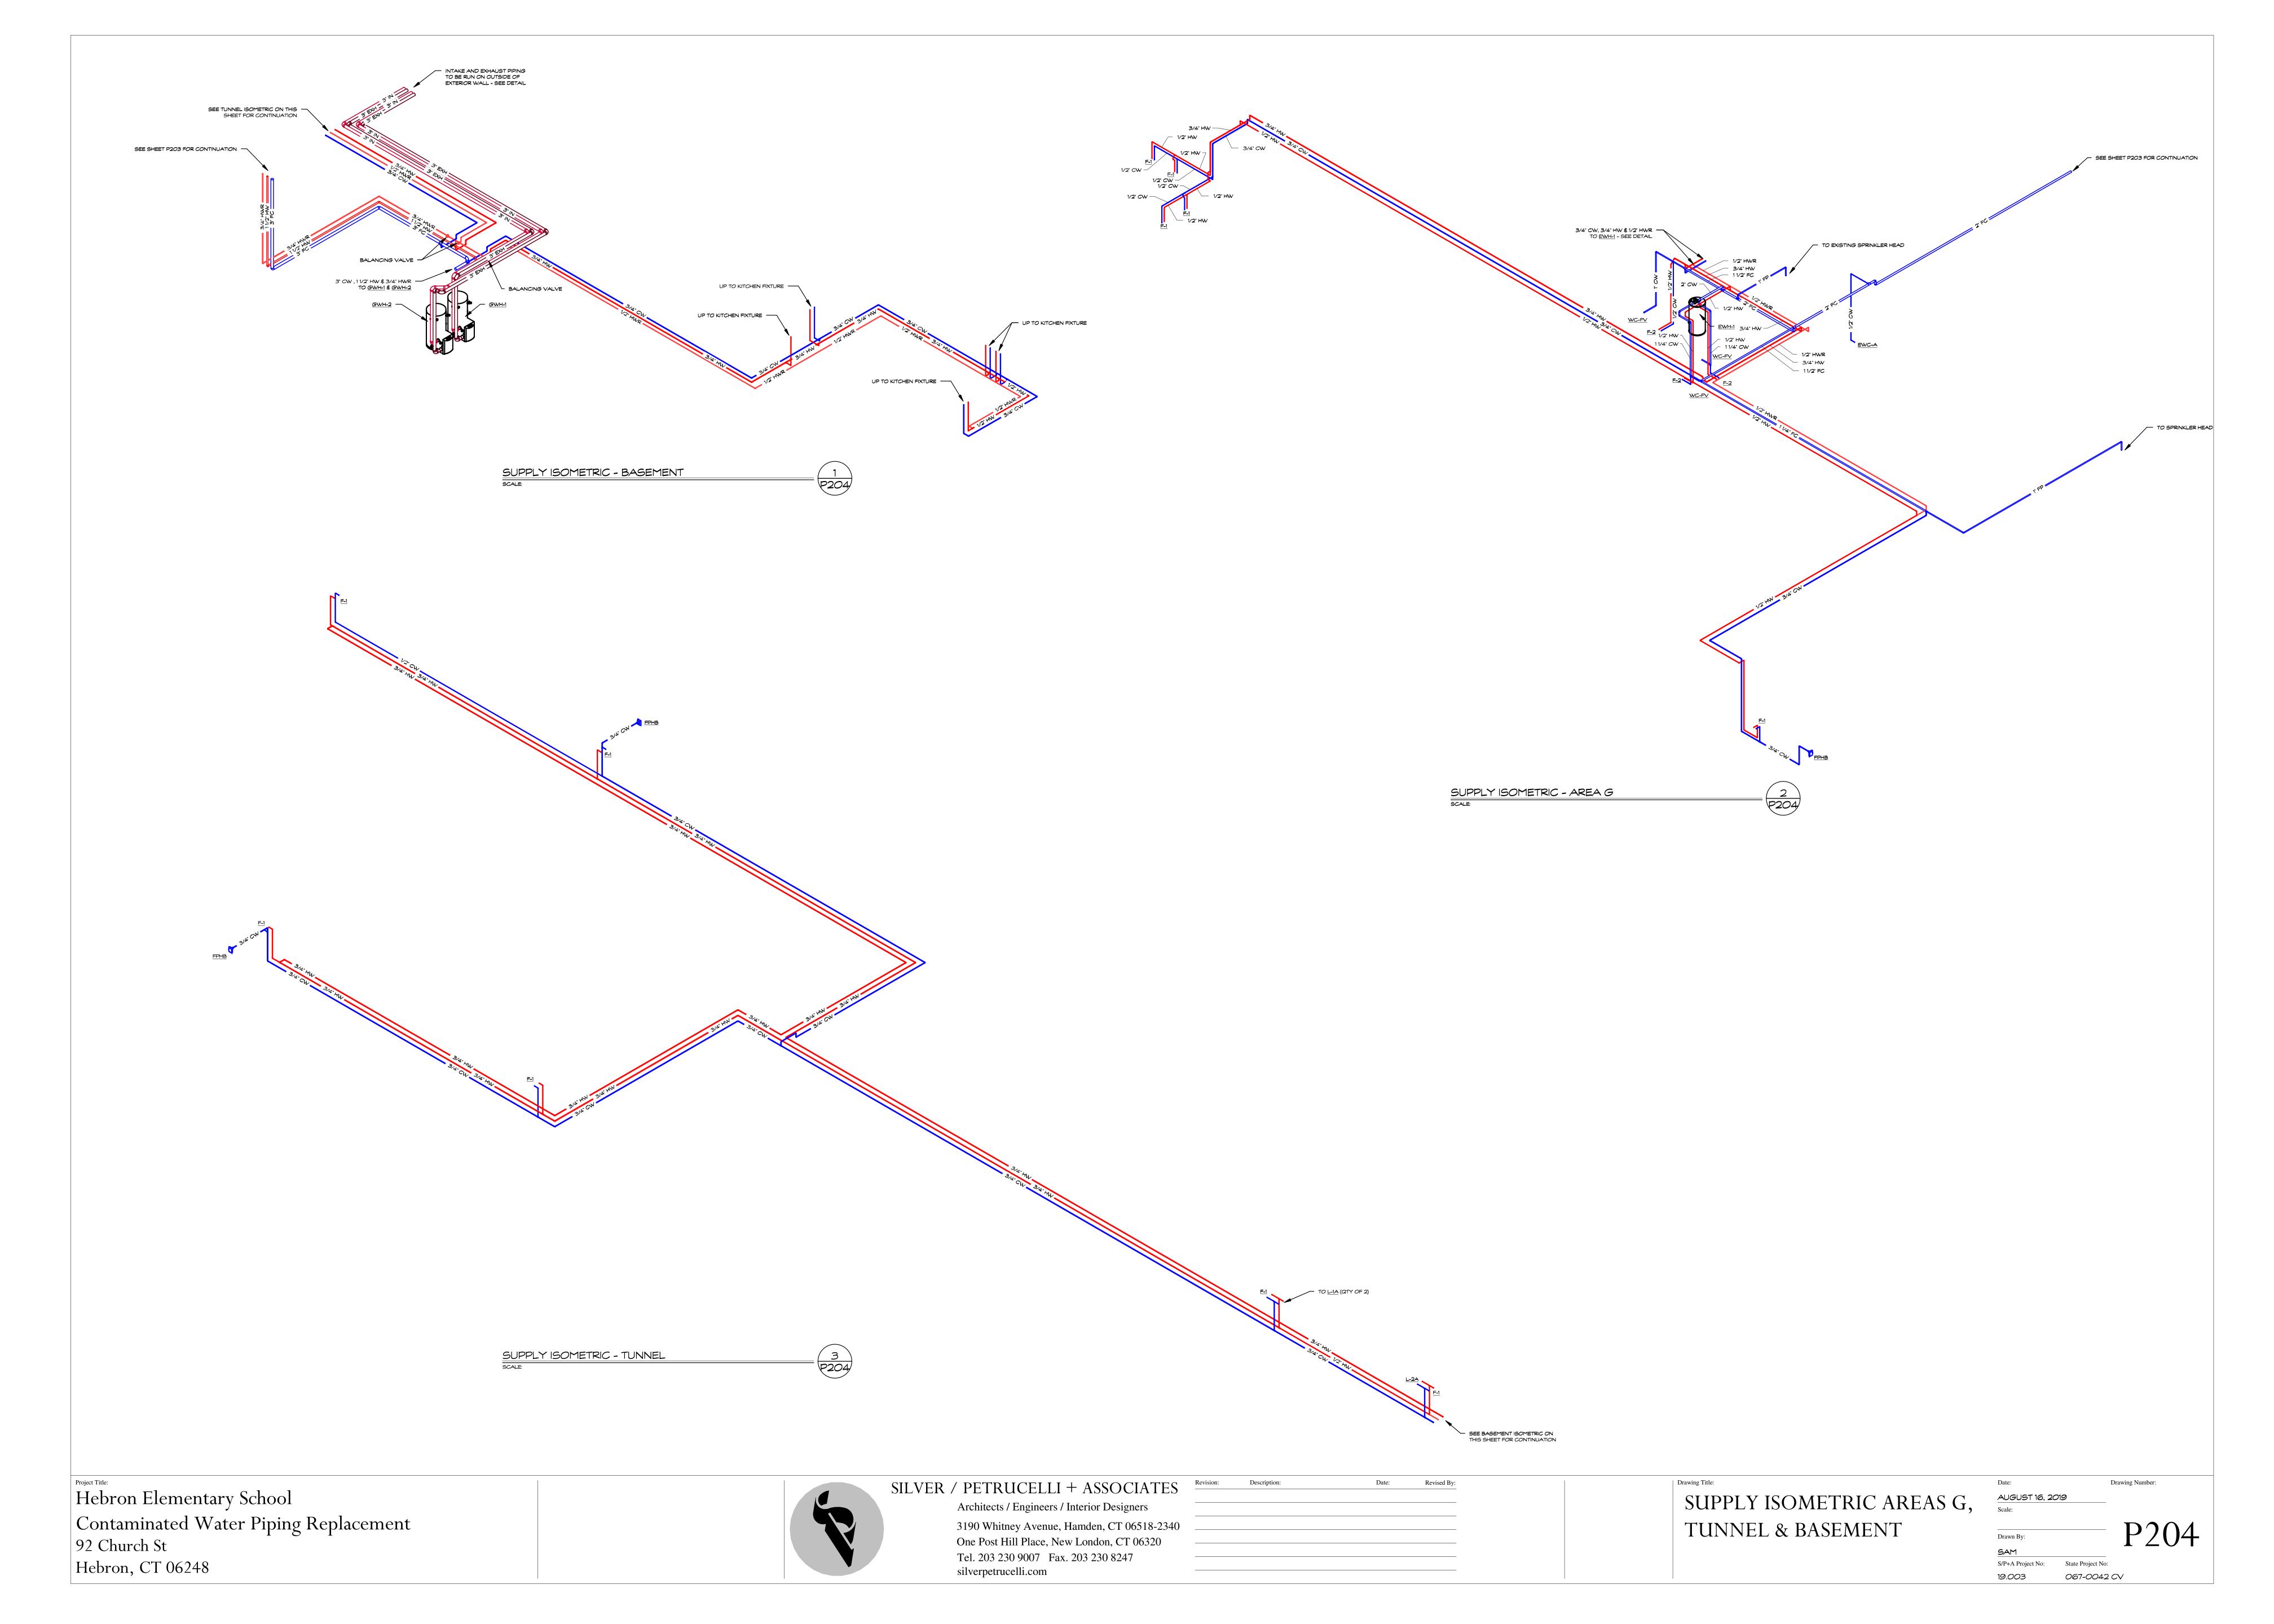
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One Post Hill Place, New London, CT 06320
Tel. 203 230 9007 Fax. 203 230 8247
silverpetrucelli.com


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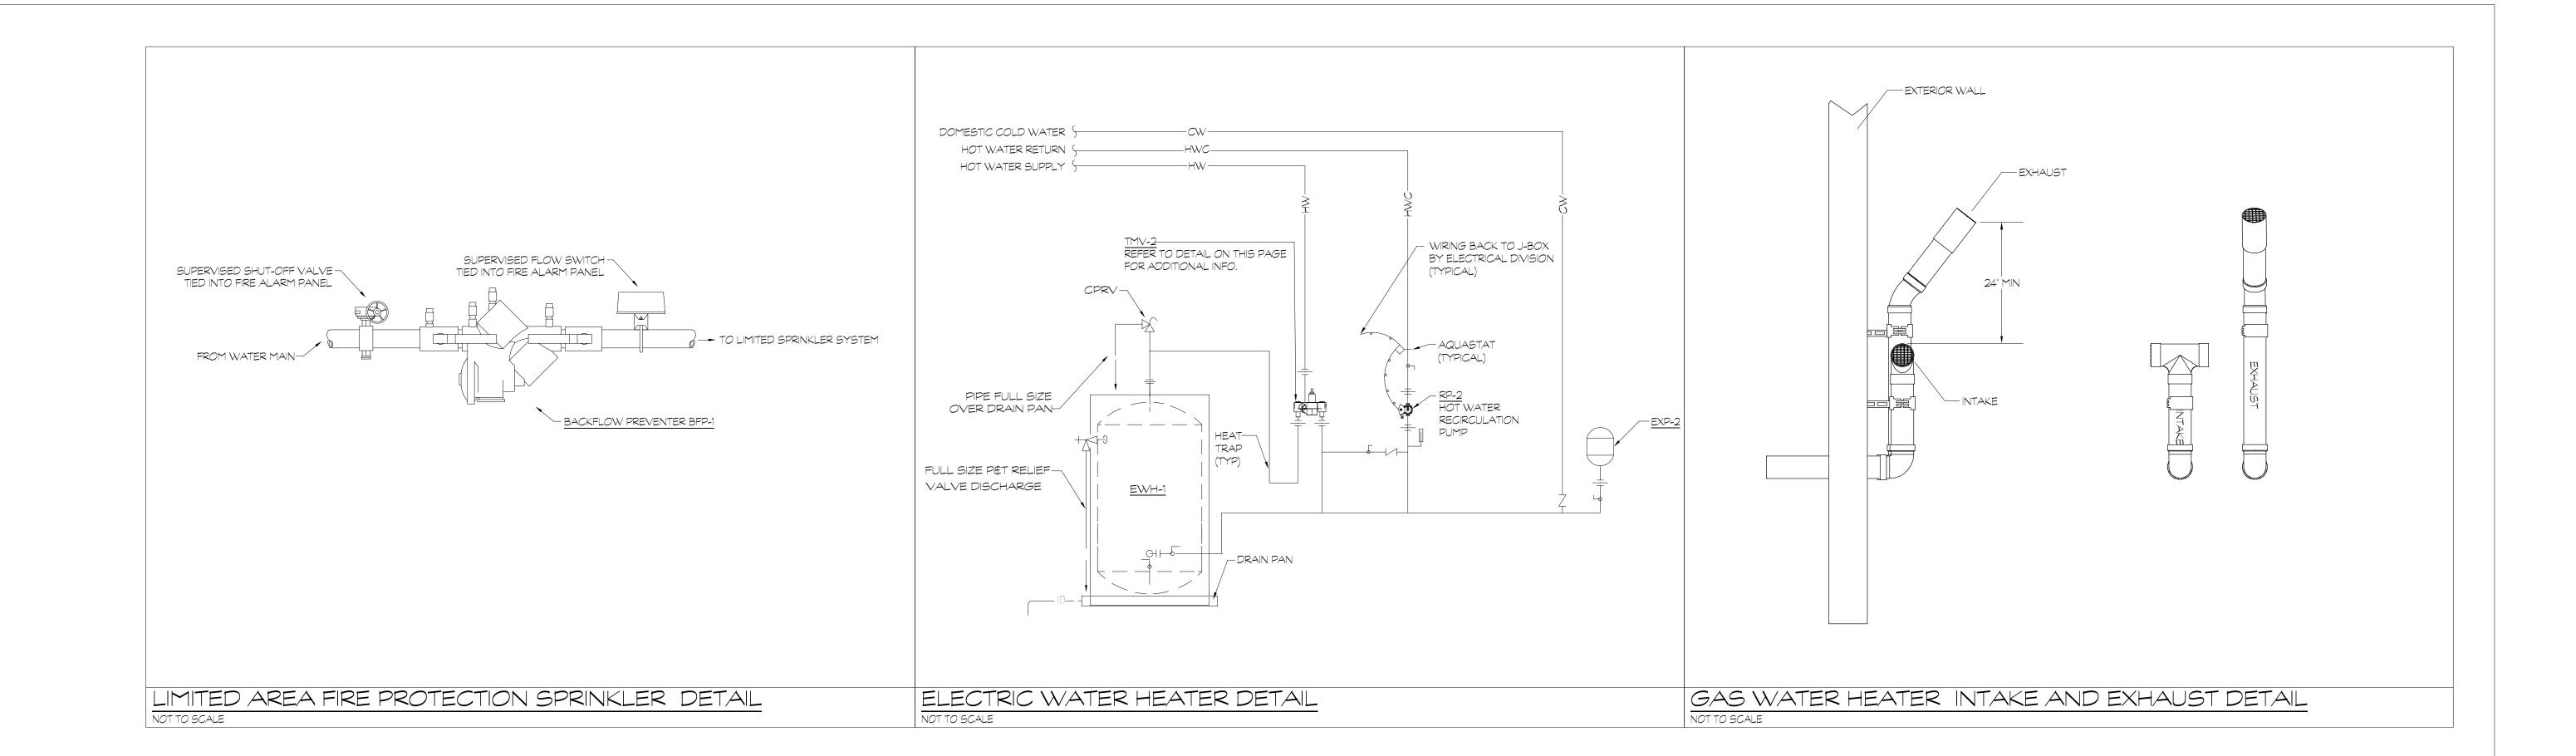
SUPPLY ISOMETRIC AREAS
C & D

067-0042 CV







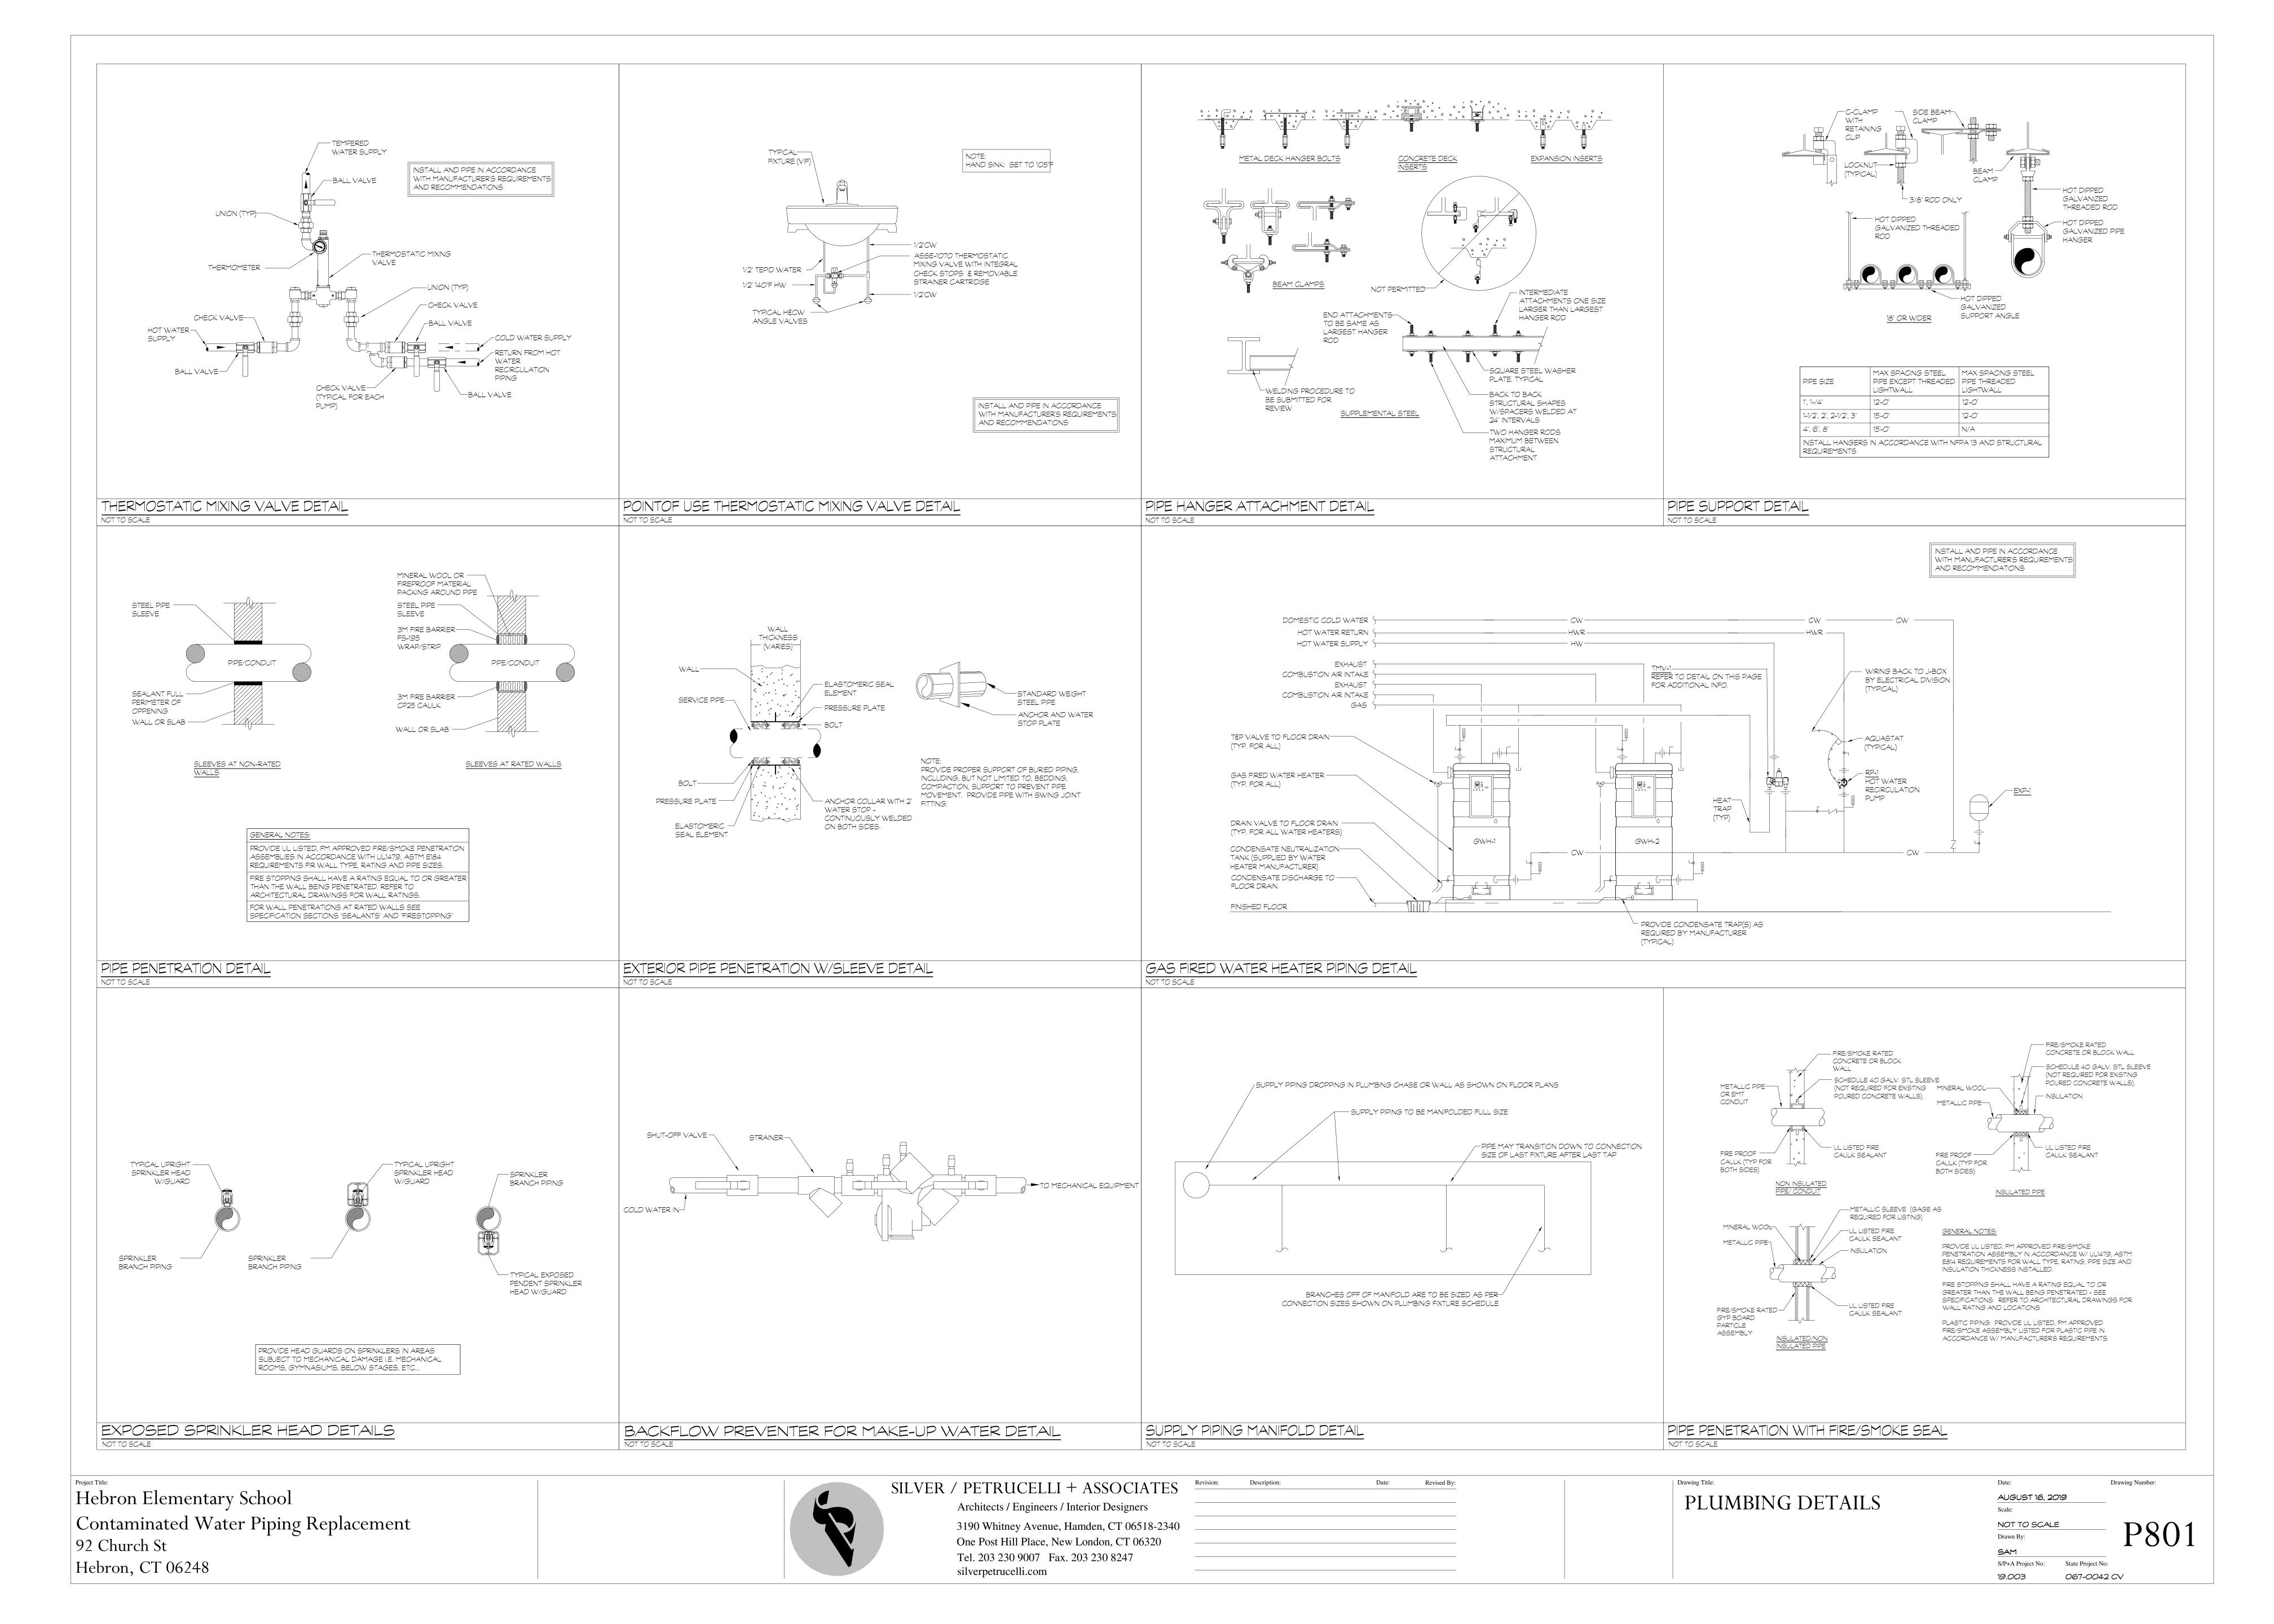

Hebron Elementary School
Contaminated Water Piping Replacement
92 Church St
Hebron, CT 06248



SILVER / PETRUCELLI + ASSOCIATES

Architects / Engineers / Interior Designers

3190 Whitney Avenue, Hamden, CT 06518-2340
One Post Hill Place, New London, CT 06320
Tel. 203 230 9007 Fax. 203 230 8247
silverpetrucelli.com

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	Revision:	Revision: Description:	Revision: Date:

PLUMBING DETAILS

Date: Drawing Number:

AUGUST 16, 2019
Scale:

NOT TO SCALE
Drawn By: PAM
S/P+A Project No: State Project No:
19.003 067-0042 CV

oject Title:	
Hebron Elementary School	
Contaminated Water Piping Replacement	
92 Church St	
Hebron, CT 06248	



PIPE HANGER SPACING TABLE

(INCHES)

SMALLER

MAXIMUM HORIZONTAL SPACING OF CAST IRON PIPE HANGERS SHALL BE INCREASED

NOT ALL PIPE MATERIALS ON THIS TABLE WILL PERTAIN TO THIS PROJECT

PIPE MATERIAL

COPPER & COPPER ALLOY TUBING

COPPER & COPPER ALLOY TUBING

TO 10'-0" WHERE 10'-" LENGTHS OF PIPE ARE USED

* * MIDSTORY GUIDE FOR SIZES 2" AND SMALLER

COPPER & COPPER ALLOY PIPE

HORIZONTAL PIPE VERTICAL PIPE

MAX. HANGER MAX. HANGER

DISTANCE (FT) DISTANCE (FEET)

6'-0"

10'-0"

12'-0"

10'-0"

10'-0"

10'-0"

MECHANICAL JOINT

SILVER / PETRUCELLI + ASSOCIATES Architects / Engineers / Interior Designers 3190 Whitney Avenue, Hamden, CT 06518-2340 One Post Hill Place, New London, CT 06320 Tel. 203 230 9007 Fax. 203 230 8247 silverpetrucelli.com

Revised By:

PLUMBING SCHEDULES

Drawing Number: AUGUST 16, 2019 Scale: NOT TO SCALE Drawn By: S/P+A Project No: State Project No:

067-0042 CV

19.003

DAMAGE (I.E. MECHANICAL ROOMS, GYMS, ETC...)

2. IN AREAS WITH FINISHED CEILINGS CONCEALED, PENDENT SPRINKLER HEADS AND CONCEALED PIPING SHALL BE UTILIZED, UNLESS OTHERWISE INDICATED ON PLANS 3. IN AREAS WITHOUT CEILINGS, EXPOSED UPRIGHT SPRINKLER HEADS AND EXPOSED PIPING SHALL BE UTILIZED. UL LISTED HEAD GUARDS SHALL BE PROVIDED IN AREAS SUBJECT TO

TYPE	STYLE	DECDONICE	COVERAGE			ORIFICE	TEMP.			REMARKS
TIPE	9116	RESPUNSE	COVERAGE	COLOR	COEFFICENT (K)	URIFICE	TEMP.	MODEL	SIN	REMARKS
PENDENT	EXPOSED	QUICK	STANDARD	BRASS	5.6K	1/2"	155°F	VICT	AULIC	
PENDENT	EXPUSED	QUICK	STANDARD	DRASS	5.00	1/2	ר פפו	V27	V2708	
UPRIGHT	EXPOSED	QUICK	STANDARD	BRASS	5.6K	1/2"	200°F	VICT	AULIC	
UPRIGHT	EXPUSED	QUICK	STANDARD	DRASS	5.00	1/2	200 F	V27	V2704	
NOTES: 1. FINIAL COLOR	RS TO BE SELECTE	D BY ARCHITEC	CT.							

	MARK	SIZE	LOCATION	SERVICE	BODY MATERIAL	TEMPERATURE	MAX. WORKING	MANUFACTURER	REMARKS
	MARK	5146	LOCATION	SERVICE	DODITIATERIAL	RANGE	PRESSURE	MODEL	RELIARNS
	BFP-1	1-2 HEADS 1"	CODINIVI ED BRANICHEC	SPRINKLER BRANCHES	BRONZE	33°E 140°E	175PSI :	WATTS	
	DI F-I	3-5 HEADS 1½"	SPRINKLER BRAINCHES	SPRINKLER BRANCHES	DROINZE	33°F-140°F	1/5251	SERIES LF909	
	BFP-2	1½"	2011 ED 200M	MAKELIDAYATED	DDONIZE	22°E 140°E	17500	WATTS	
	BFP-2	172	BOILER ROOM	MAKE-UP WATER	BRONZE	33°F-140°F	175PSI ·	SERIES LF909	-
•									

SPRINKLER HEAD SCHEDULE

BACKFLOW PREVENTER SCHEDULE

2. WITH DIAL THERMOMETER, ADJUSTABLE SET POINT, INTEGRAL STRAINER CHECKSTOPS ON INLETS, PROVIDE SHUTOFFS/UNIONS AT ALL CONNECTIONS 3. MINIMUM LOW RATE WHEN VALVE IS INSTALLED AT OR NEAR HOT WATER SOURCE WITH RECIRCULATED TEMPERED WATER AND CONTINUOUSLY OPERATING CIRCULATION PUMP.

1. MAXIMUM PRESSURE DIFFERENTIAL SHALL BE 10 PSI FOR MIXING VALVE

		THER	10STATI	C MIXING	5 VAL	VE SC	HEDU	LE		
MARK	EQUIPMENT BEING SERVED (I.E.	AREA SERVED	FLOW RATE @	MINIMUM FLOW RATE	INLET	OUTLET	INLET	OUTLET	MANUFACTURER	REMARKS
	WATER HEATER, ETC)	ARLA SERVED	DIFFERENTIAL	GPM	TEMP.	TEMP.	SIZE	SIZE	MODEL	REI MRRS
TMV-1	<i>G</i> WH-1 € <i>G</i> WH-2		42.4	2 GPM	160°F	140°F	1"	1-1/4"	ACORN CONTROLS	
11 10-1	GWFI-I & GWFI-2		42.4	2 OPT 1	100 F	140 F	l l	1-1/4	MV17-3	
TMV-2	EWH-1		21.2	1 GPM	160°E	140°F	3/4"	1"	ACORN CONTROLS	
11°1V-2	EWN-I		21.2	I GPI I	160°F	140 F	5/4	l	MV17-2	
	DOINT OF LIGHT & EALICETS		1.9	ODE CDM	140°F	110°F	1/2"	1/2"	ACORN CONTROLS	FOR ALL HAND
	POINT OF USE @ FAUCETS		1.9	0.25 GPM	140 F	110 P	1/2	1/2	ST70CP-12	WASH SINKS & LAVATORIES
NOTES:			•					•		

PUMP SCHEDULE												
ELECTRICAL SERVICE PUMP TYPE FLUID GPM HEAD										MANUFACTURER	DEMARKS	
LOCATION	SEKVICE	PUTIP I YPE	FLUID	GPI ^M I	HEAD	HP	VOLTAGE	PHASE	RPM	MODEL	REMARKS	
BAGEMENT	HOT WATER	IN II IN IE	WATER	10	15 ET	1/	115) /	1 .	1705	TACO		
DASEFIEINT	RECIRC.		WATER		ואטו	/8	IIDV	IΨ	1/25	113		
ELEC ROOM IN	HOT WATER		\\/ATED	10	15 ET	1/	115\/	1ф	1705	TACO		
WING	RECIRC.		WATER	U	15 F1	/8	עפוו	ιΨ	1/25	113		
E	IEDIA CENTER	BASEMENT HOT WATER RECIRC. LEC ROOM IN HOT WATER PECIPO	BASEMENT HOT WATER RECIRC. INLINE LEC ROOM IN HOT WATER INLINE	BASEMENT HOT WATER RECIRC. INLINE WATER LEC ROOM IN HOT WATER INLINE WATER PECIPC INLINE WATER	LOCATION SERVICE PUMP TYPE FLUID GPM BASEMENT HOT WATER RECIRC. INLINE WATER 10 LEC ROOM IN INDICATE INLINE WATER 10	LOCATION SERVICE PUMP TYPE FLUID GPM HEAD BASEMENT HOT WATER RECIRC. INLINE WATER 10 15 FT LEC ROOM IN HOT WATER INLINE WATER 10 15 FT	LOCATION SERVICE PUMP TYPE FLUID GPM HEAD HP BASEMENT HOT WATER RECIRC. INLINE WATER 10 15 FT 1/8 LEC ROOM IN IEDIA CENTER PECIPC INLINE WATER 10 15 FT 1/8	LOCATION SERVICE PUMP TYPE FLUID GPM HEAD HOT WATER RECIRC. INLINE WATER 10 15 FT 1/8 115V LEC ROOM IN IEDIA CENTER PECIPE INLINE WATER 10 15 FT 1/8 115V	LOCATION SERVICE PUMP TYPE FLUID GPM HEAD ELECTRICAL HOT WATER RECIRC. INLINE WATER 10 15 FT 1/8 115V 14 LEC ROOM IN IEDIA CENTER PECIPE INLINE WATER 10 15 FT 1/8 115V 14	LOCATION SERVICE PUMP TYPE FLUID GPM HEAD HOT WATER RECIRC. INLINE WATER 10 15 FT 1/6 115V 10 1725	COCATION SERVICE PUMP TYPE FLUID GPM HEAD HEAD HEAD HP VOLTAGE PHASE RPM MODEL	

NOTES: 1. FIBERGL	.ASS INSULATION:	THERMAL CON	DUCTIVITY .22 T	0 .28BTU x IN./	/H×FT×°FW	// 100°F MEA	N TEMP. TH	HICKNESS BASI	ED ON ASHRA	AE 90.1, 1999	9 6.2.4.5	
2. REFER ⁻	TO SPECIFICATIONS	S FOR ADDITIO	NAL REQUIREME	ENTS								
						45.00						
ı					PUN	1P SCH	HEDU!	_E				
MARK	LOCATION	SERVICE	PUMP TYPE	FLUID	GPM	HEAD		ELECT	RICAL	,	MANUFACTURER	REMARKS
1 1/ 1/ 1/							HP	VOLTAGE	PHASE	RPM	MODEL	
											TACO	

INSULATION SCHEDULE										
SYSTEM	PIPE SIZE	INSULATION TYPE	INSULATION THICKNESS	FITTINGS, VALVES, FLANGES INSULATION TYPE	REMARKS					
DOMESTIC COLD WATER	ALL	MINERAL FIBER, ASJ, SSL	1"	MOLDED, PRE-FORMED MINERAL FIBER WITH PVC JACKET	TYPE 1					
DOMESTIC HOT WATER & RECIRCULATION	ALL	MINERAL FIBER, ASJ, SSL	1"	MOLDED, PRE-FORMED MINERAL FIBER WITH PVC JACKET	TYPE 1					

			VAL	VE SO	CHEDUI	LE				
		C17F			TY	PE				REMARKS
DESCRIPTION		SIZE	GATE	GLOBE	CHECK	BALL	PLUG	BALANCE	CLASS	REI MRNS
DOMESTIC COLD WA	TER	3" AND SMALLER			CVT	BVT			125PSI	
DOMESTIC HOT WATE	ER & RECIRCULATION	3" AND SMALLER			CVT	BVT		CBV	125PSI	
GAS		2" AND SMALLER					PGVT		125PSI	
NOTES: 1. CALIBRATED PRESS	SURE RELIEF VALVE: II	NSTALL A MINIMUM OF 12" /	ABOVE WATER	HEATER AN	D PIPE DISCH,	ARGE TO	ADEQUATE LC	OCATION. WAT	TS MODEL	54 <i>0</i> C
ABBREVIATION	DESCRIPTION			,	ABBREVIATIO	N I	DESCRIPTION			
BVT	BALL VALVE THREA	THREADED -	BRONZE							
CBV	CALIBRATED BALAN	NCING VALVE - BRONZE	HREADED - A	GA APPROV	VED					

PEX PIPING

DESCRIPTION		SIZE	PIPE			F	ITTING	REMARKS	
		5126	TYPE	SCHEDULE		TYPE	RATING	REI MANS	
DOMESTIC WATER PIPING - BASE BID (CW, HW & HWR)		2" AND SMALLER	PEX			MJ			
DOMESTIC WATER PIPING - ADD ALTERNATE (CW, HW & HWR)		2" AND SMALLER	COPPER	TYPE L		MJ			
DOMESTIC WATER PIPING (CW, HW & HWR)		2½" AND LARGER	COPPER	TYPE L		MJ			
FIRE PROTECTION/COLD WATER PIPING (FC)		ALL	COPPER	TYPE L		MJ	MJ		
FIRE PROTECTION PIPING (FP)		ALL	COPPER	TYPE L		MJ			
GAS PIPING		2" AND SMALLER	STL-BLK	SCH. 40		MIT	CLASS 150		
WATER HEATER INTAKE AND EXHAUST		ALL	CPVC	SCH. 40		CPVC			
ABBREVIATIONS	DESCRIPTION	DESCRIPTION				BREVIATIONS	DESCRIPTION		
CPVC	CHLORINATED POLYVINYL CHLORIDE				MIT		MALLEABLE IRON THREADED		

PIPE AND FITTING SCHEDULE

CALCULATED WATER
HEATER SUPPLY PRE-CHARGE RELIEF
STORAGE PRESSURE PRESSURE PRESSURE TEMP FACTOR

CAPACITY

WATER
HEATER
SUPPLY PRE-CHARGE VALVE
PRESSURE TEMP FACTOR ACCEPTANCE TOTAL ACCEPTANCE TOTAL SIZE VOLUME VOLUME VOLUME VOLUME CAPACITY 5.0 110 GAL 60 PSI 50 PSI 100 | 90°F | 140°F | .01096 1.21 4.86 DETA-12 60 PSI 40 PSI 100 90°F 140°F .01096 0.44 2.09 DETA-5

3. BASED OFF 2.09% EXPANSION FACTOR: 160F HOT WATER STORAGE TEMPERATURE, \$ 3.1 DESIGN PRESSURE FACTOR: 125 PSI MAXIMUM ALLOWABLE PRESSURE \$ 80 PSI LINE PRESSURE. (WATER

EXPANSION TANK SCHEDULE MARK | MAKE & MODEL EXP-1

6. WATER HEATER SHALL BE WIRED FOR NON-SIMULTANEOUS ELEMENT OPERATION.

F-1	CLASSROOM SINK FAUCET, DELTA MODEL 711LF-HDF. PROVIDE WITH POINT-OF-USE THERMOSTATIC MIXING VALVE	N/A	N/A	1/2"	1/2"
F-2	LAVATORY FAUCET, SENSOR, SLOAN OPTIMA MODEL ETF-80-4-PLG-BDT-CP-0.5GPM-MLM-IR-FCT PROVIDE WITH POINT-OF-USE THERMOSTATIC MIXING VALVE	N/A	N/A	1/2"	1/2"
F-3	MOP SINK FAUCET, FIAT MODEL 830-AA PROVIDE WITH POINT-OF-USE THERMOSTATIC MIXING VALVE	N/A	N/A	3/4"	3/4"
FPHB	FREEZE PROOF HOSE BIBB, WOODFORD MODEL MB67	N/A	N/A	3/4"	
L-1A	2 STATION WASH STATION, BRADLEY EXPRESS LAVATORY MODEL SS-2N NOTE: NO SUBSTITUTION WILL BE ACCEPTED FOR THIS ITEM PROVIDE WITH POINT-OF-USE THERMOSTATIC MIXING VALVE	N/A	N/A	1/2"	1/2"
L-2A	3 STATION WASH STATION, BRADLEY EXPRESS LAVATORY MODEL SS-3N NOTE: NO SUBSTITUTION WILL BE ACCEPTED FOR THIS ITEM PROVIDE WITH POINT-OF-USE THERMOSTATIC MIXING VALVE	N/A	N/A	1/2"	1/2"
S-1A	SINGLE BOWL SINK, ELKAY MODEL LRADQ191855 WITH DELTA MODEL 711LF-HDF FAUCET PROVIDE WITH POINT-OF-USE THERMOSTATIC MIXING VALVE	2"	2"	1/2"	1/2"
UR-FV	URINAL FLUSH VALVE, SENSOR, SLOAN MODEL 186 ESS HARDWIRED-0.125-DBP-TMO-HW	N/A	N/A	3/4"	
WC-FV	WATER CLOSET FLUSH VALVE, SENSOR, SLOAN MODEL 111 ESS HARDWIRED-1.28-DFB-TMO-HW	N/A	N/A	1"	
				<u> </u>	

1. LAVATORY & WATER COOLERS SUPPLY SHALL BE BRASS W/ BRASS ANGLE STOPS FOR 1/2" WATER SUPPLY LINES, W/ LOOSE KEY (W/CAP), AND WALL FLANGE. ALL COMPONENTS SHALL

6. THE PLUMBING FIXTURES VENDOR SHALL COORDINATE WITH THE PLUMBING AND GENERAL CONTRACTOR ALL PLUMBING FIXTURES ROUGH IN DIMENSIONS BEFORE CONSTRUCTION BEGIN.

8. REFER TO ARCHITECTURAL DRAWINGS FOR STANDARD, A.D.A MOUNTING AND CHILD HEIGHTS. REFER TO ARCHITECTURAL FOR LOCATION OF A.D.A COMPLIANT SHOWER SEAT AND

GAS WATER HEATER SCHEDULE

RECOVERY @ MIXING VALVE -

TMV-1

TMV-1

PRESSURE INPUT (MBH)

7" - 11" W.C. 199,000

7" - 11" W.C. 199,000

VOLTAGE PHASE AMPS ELEMENT

18.8

10. ALL HARD WIRED FAUCETS TO A HAVE BOX MOUNTED TRANSFORMER ABOVE CEILING. REFER TO ELECTRICAL DOCUMENTS FOR LOCATIONS AND CONNECTION POINT.

229 @ 100°F

1. INSTALL WATER HEATER IN ACCORDANCE WITH BUILDING CODE - PLUMBING & MECHANICAL (WITH LATEST AMENDMENTS) CODES, ENERGY CODE, AND APPLICABLE STANDARDS AND

ELECTRIC WATER HEATER SCHEDULE

4. INSTALL WATER HEATER IN ACCORDANCE WITH BUILDING CODE - PLUMBING & MECHANICAL (WITH LATEST AMENDMENTS) CODES, ENERGY CODE, AND APPLICABLE STANDARDS AND

208

2. CAST BODY "P" TRAP 1-1/2" x 1-1/2" WITH HEAVY CAST J-BEND & FLAT CLEANOUT PLUG, SLIP NUTS AND WALL FLANGE. ALL COMPONENTS SHALL BE POLISHED CHROME FINISH.

4. PROVIDE TRUEBRO MODEL 103 (WHITE), ANTIMICROBAL HANDI LAV-GUARDS INSTALLATION KIT FOR ALL WHEELCHAIR LAVATORY & SINKS FOR WATER SUPPLIES & WASTE LINE.

PLUMBING FIXTURE/EQUIPMENT SCHEDULE

FIXTURE, MODEL NUMBER AND DESCRIPTION

SINGLE LEVEL ELECTRIC WATER COOLER WITH BOTTLE FILLER, ELKAY MODEL LZS8WSSK WITH APRON ELKAY

BI-LEVEL ELECTRIC WATER COOLER WITH BOTTLE FILLER, ELKAY MODEL LZSTL8WSSK WITH APRON ELKAY

CLASSROOM DRINKING FOUNTAIN, OASIS MODEL F140PM

BE POLISHED CHROME FINISH. MANUFACTURER: BRASS CRAFT OR APPROVED EQUAL.

9. CONTRACTOR TO PROVIDE AN EXTRA 10% OF BATTERIES, AERATORS, CARTRIDGE, ETC...

TYPE

2. PROVIDE BRASS DRAIN VALVE, & ALL REQUIRED OPTIONS TO COMPLETE THE INSTALLATION.

STORAGE

5. PROVIDE BRASS DRAIN VALVE, & ALL REQUIRED OPTIONS TO COMPLETE THE INSTALLATION.

40 GALLONS 18 @ 100°F

1. PROVIDE FACTORY INSTALLED HEAVY DUTY ELECTRICAL JUNCTION BOX, CONTROLS, WITH T-STATS SET ON 160°F.

3. CONTACT MANUFACTURERS REPRESENTATIVE FOR HEATERS ELECTRICAL DATA BEFORE FINAL ORDER IS MADE.

3. STRAINERS SHALL BE FURNISHED WITH FIXTURES AS REQUIRED. FOR H/C LAVATORY OR SINKS PROVIDE OFFSET TAILPIECE.

5. PROVIDE WATER SUPPLY & "P" TRAP & OPTIONAL WATER FILTERS FOR ELECTRIC WATER COOLERS AS PER MANUFACTURERS RECOMMENDATIONS.

GAS TANK TYPE 55 GAL 229 @ 100°F

RECOVERY @ | MIXING VALVE |-

2. INSTALL WATER HEATER IN ACCORDANCE TO SPC, SMC CODES, NEC, AND APPLICABLE STANDARDS AND MANUFACTURERS RECOMMENDATIONS.

TMV-2

TEMP. RISE

GAS TANK TYPE 55 GAL

. UNLESS SHOWN ABOVE, PLUMBING FIXTURES MANUFACTURER, TRIM COLOR AND FINISH SHALL BE FURNISHED AS DIRECTED BY OWNER/ARCHITECT.

MANUFACTURER; BRASS CRAFT OR APPROVED EQUAL.

MAKE & MODEL

PH199-55

PH199-55

MAKE & MODEL

EVERLAST EVCO40

MANUFACTURERS RECOMMENDATIONS.

MANUFACTURERS RECOMMENDATIONS.

1. ASME CONSTRUCTION SHALL BE STANDARD

HEATER VOLUME × 2.09 % × 3.1).

2. PROVIDE ALL NECESSARY ACCESSORIES & AIR CHARGE FITTING.

MARK

GWH-1

GWH-2

MARK

LKAPREZL WHERE REQUIRED

LKAPREZL WHERE REQUIRED

NOTE: NO SUBSTITUTION WILL BE ACCEPTED FOR THIS ITEM

MARK

ROUGH-IN

N/A

N/A

N/A

CW

REMARKS

STORE AT 160°F

STORE AT 160°F

REMARKS

HW


WASTE/

SANITARY


N/A

N/A


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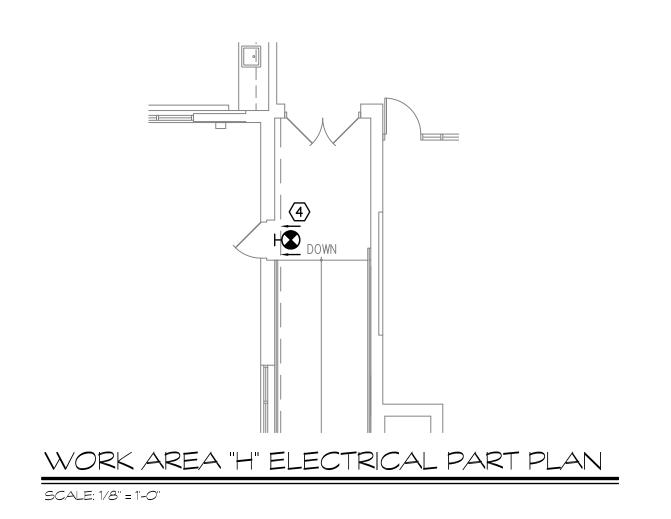
WORK AREA "A" ELECTRICAL PART PLAN SCALE: 1/8" = 1-0"

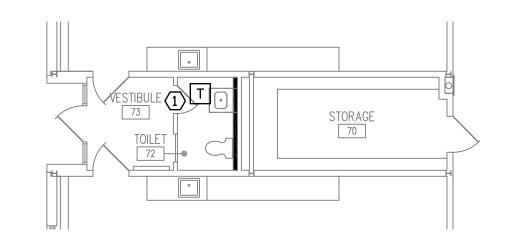




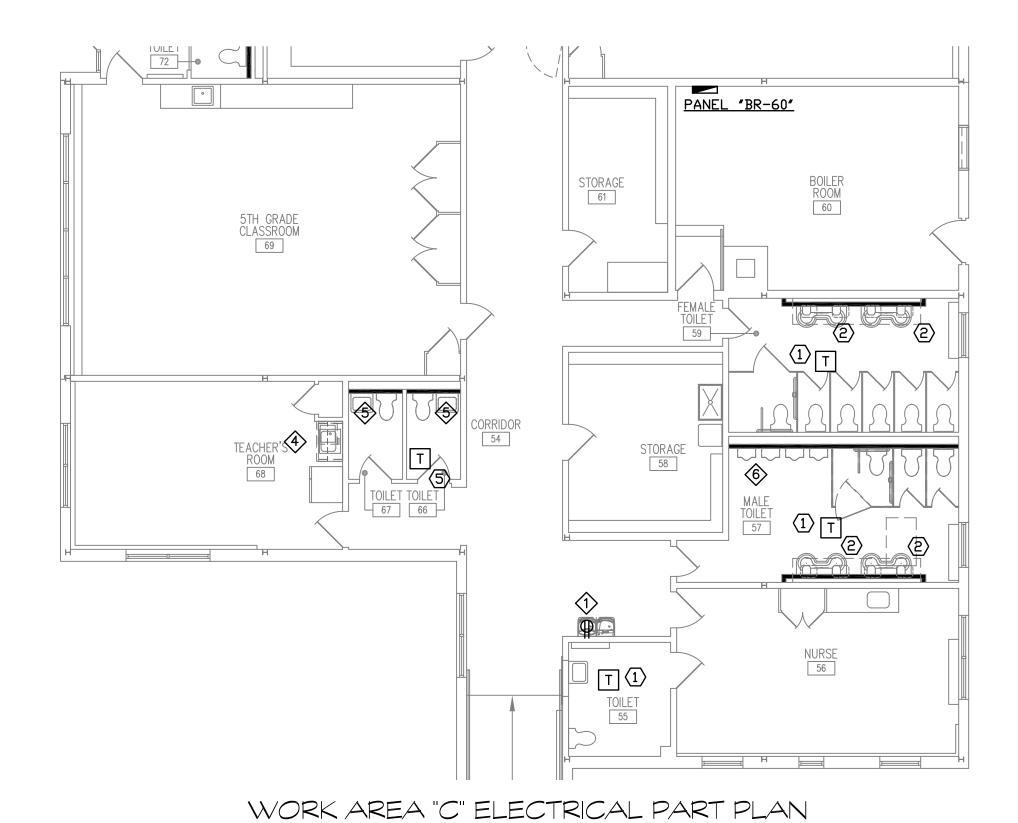


WORK AREA "F" ELECTRICAL PART PLAN SCALE: 1/8" = 1'-0"

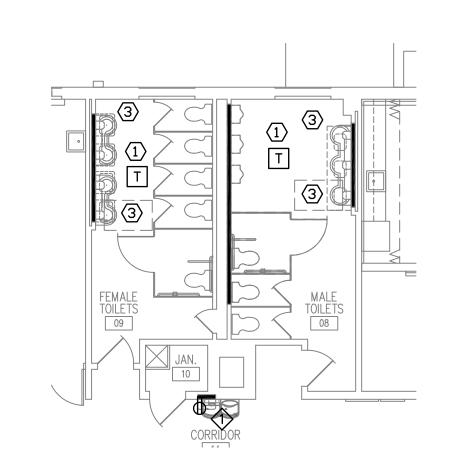


SCALE: 1/8" = 1'-0"

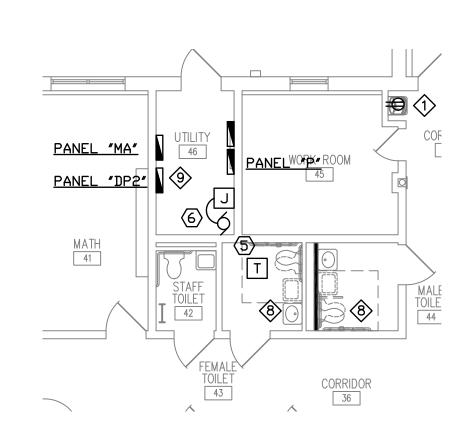



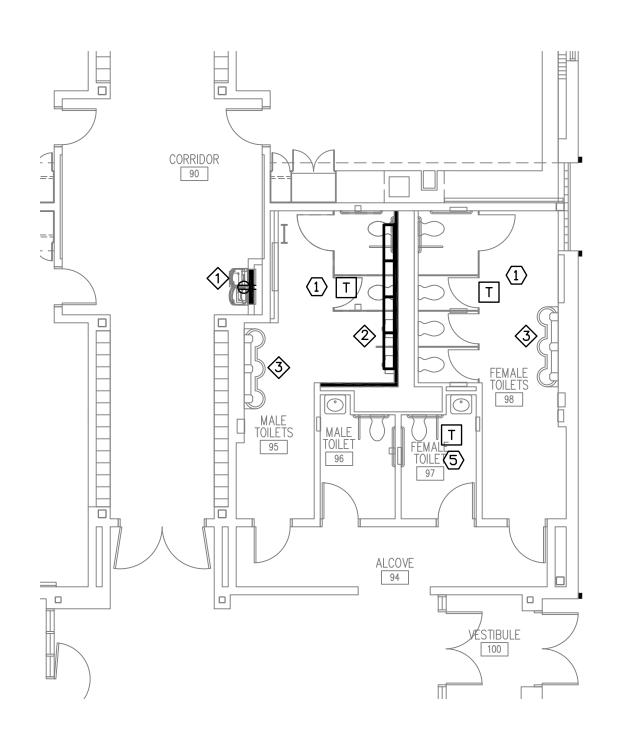


WORK AREA "B" ELECTRICAL PART PLAN SCALE: 1/8" = 1'-0"

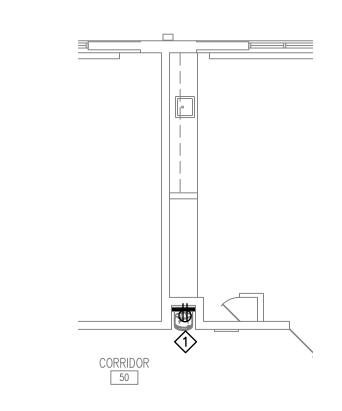


WORK AREA "D" ELECTRICAL PART PLAN SCALE: 1/8" = 1'-0"

SCALE: 1/8" = 1'-0"

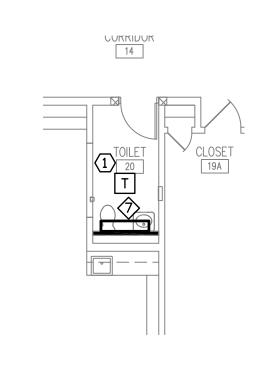

WORK AREA "G" ELECTRICAL PART PLAN

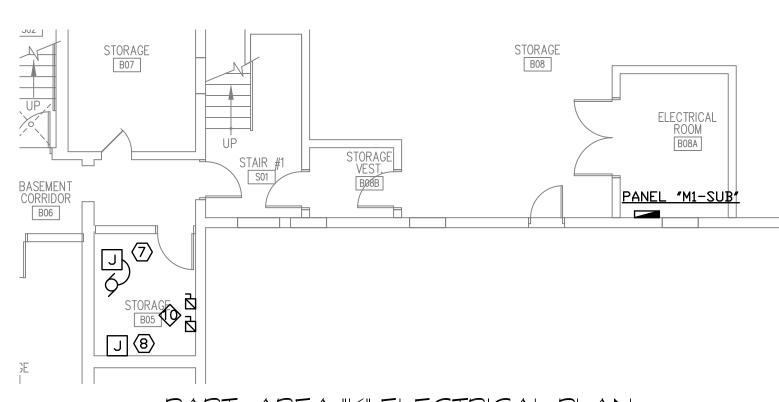

PART AREA "K" ELECTRICAL PLAN (BASEMENT)

ELECTRICAL KEYNOTES


- (1) NEW TRANSFORMER ABOVE CEILING FOR FLUSH VALVES. PROVIDE 2#12 & 1#12G IN 3/4" CONDUIT FROM NEAREST LIGHTING CIRCUIT FÖR TRANSFORMER POWER.
- 2 PROVIDE NEW 20A-1P GE CIRCUIT BREAKER IN SPACE 32 IN PANEL BR-60 LOCATED IN THE BOILER ROOM 60. PROVIDE 2#12 & 1#12G IN 3/4" CONDUIT FROM NEW CIRCUIT BREAKER TO NEW HAND SINK TRANSFORMERS (4) ABOVE
- (3) PROVIDE NEW 20A-1P CUTLER HAMMER CIRCUIT BREAKER IN SPACE 18 IN PANEL M1-SUB LOCATED IN THE BASEMENT ELECTRICAL ROOM BO8A. PROVIDE 2#12 & 1#12G IN 3/4" CONDUIT FROM NEW CIRCUIT BREAKER TO NEW HAND SINK TRANSFORMERS (2) ABOVE CEILING IN MALE AND FEMALE TOILETS ON THE LEVEL ABOVE.
- 4 PROVIDE NEW DUALLITE EVEURWE LED EXIT SIGN (OR EQUAL TO MATCH EXISTING AS CLOSE AS POSSIBLE WITH EMERGENCY BATTERY FOR 90 MINUTE OPERATION. SIGN TO BE DUAL FACED WITH DIRECTIONAL ARROWS AS INDICATED.
- (5) NEW TRANSFORMER ABOVE CEILING FOR FLUSH VALVES. PROVIDE 2#12 & 1#12G IN 3/4" CONDUIT FROM NEAREST LIGHTING CIRCUIT FOR TRANSFORMER POWER. SINGLE TRANSFORMER TO SERVE BOTH TOILET ROOMS.
- (6) PROVIDE NEW SIEMENS 20A-1P CIRCUIT BREAKER IN PANEL P, SECTION 2, SPACE 34. PROVIDE 2#12 & 1#12G IN 3/4" CONDUIT TO NEW RECIRC PUMP.
- 7 PROVIDE NEW CUTLER HAMMER 20A-1P CIRCUIT BREAKER IN PANEL M1-SUB, SPACE 20 LOCATED IN THE BASEMENT ELECTRICAL ROOM BO8A. PROVIDE 2#12 & 1#12G IN 3/4" CONDUIT TO NEW RECIRC PUMP IN STORAGE ROOM BOS.
- (8) PROVIDE NEW CUTLER HAMMER 20A-1P CIRCUIT BREAKER IN PANEL M1-SUB, SPACE 41 LOCATED IN THE BASEMENT ELECTRICAL ROOM BO8A. PROVIDE 2#12 & 1#12G IN 3/4" CONDUIT TO JUNCTIOM BOX FOR NEW GAS WATER HEATERS CONTROL IN STORAGE ROOM B05.

ELECTRICAL DEMO KEYNOTES

- (1) DISCONNECT WATER COOLER FROM EXISTING POWER SOURCE. RECONNECT NEW WATER COOLER TO SOURCE AFTER
- (2) REMOVE EXISTING LIGHT FIXTURES (4) AND STORE FOR REINSTALLATION UPON COMPLETION OF NEW WALL. RECONNECT TO EXISTING CIRCUIT.
- (3) DISCONNECT WASH SINK FROM EXISTING POWER SOURCE. RECONNECT SINK TO SOURCE AFTER INSTALLATION.
- 4 DISCONNECT EXISTING STOVE/REFRIGERATOR UNIT FROM POWER SOURCE. CONTRACTOR TO REMOVE WIRING BACK TO SOURCE PANEL. CIRCUIT BREAKER FOR UNIT TO BE TURNED OFF AND LABELED AS "SPARE".
- DISCONNECT LIGHT FIXTURE AND FIRE ALARM HORN/STROBE AND STORE FOR REINSTALLATION UPON COMPLETION OF NEW WALL. RECONNECT TO EXISTING CIRCUIT POWER AND FIRE
- 6 DISCONNECT FIRE ALARM HORN/STROBE AND CALL FOR AID PULL STATION AND STORE FOR REINSTALLATION UPON COMPLETION OF NEW WALL. RECONNECT TO EXISTING CIRCUIT POWER AND FIRE ALARM CIRCUITS.
- REMOVE EXISTING LIGHT FIXTURE AND STORE FOR REINSTALLATION UPON COMPLETION OF NEW WALL. RECONNECT TO EXISTING CIRCUIT.
- (8) DISCONNECT FIRE ALARM HORN/STROBE AND STORE FOR REINSTALLATION UPON COMPLETION OF NEW WALL. RECONNECT TO EXISTING CIRCUIT FIRE ALARM CIRCUIT.
- DISCONNECT EXISTING WATER HEATER AND MAKE WIRING SAFE. RECONNECT TO NEW WATER HEATER AFTER INSTALLATION. REUSE EXISTING CIRCUIT.
- (2) TO BE REMOVED. EXISTING 60A AND 100A DISCONNECT SWITCHES TO BE TURNED OFF. REMOVE EXISTING WIRING FROM SWITCHES BACK TO SOURCE PANEL M1. TURN CIRCUIT BREAKERS FOR WATER HEATERS OFF AND LABEL AS "SPARE". EXISTING CONDUIT TO REMAIN.

ELECTRICAL GENERAL NOTES

- SPECIFICATION SECTIONS, GENERAL CONDITIONS, SUPPLEMENTAL GENERAL CONDITIONS AND DRAWINGS ARE INTEGRAL PARTS OF CONTRACT DOCUMENTS.
- 2. ALL WORK AND ACTION DEPICTED AND DESCRIBED IN CONTRACT DOCUMENTS TO BE PERFORMED BY THE CONTRACTOR UNLESS SPECIFICALLY NOTED OTHERWISE.
- REFERENCE TO SPECIFIC SUB-CONTRACTORS SUCH AS "ELECTRICAL". ETC. ARE INTENDED TO SUGGEST POSSIBLE DIVISION OF RESPONSIBILITY. PRIME CONTRACTOR TO BE RESPONSIBLE FOR COORDINATION AND EXECUTION OF ALL WORK.
- 4. OBTAIN AND PAY FOR ALL REQUIRED PERMITS AND INSPECTIONS. 5. ALL EQUIPMENT, MATERIALS AND RELATED SYSTEM COMPONENTS TO BE NEW UNLESS NOTED OTHERWISE.
- REPAIR AND REPLACE AT NO COST TO OWNER ALL EQUIPMENT AND MATERIALS DAMAGED DURING CONSTRUCTION.
- STUDY THE PROJECT MANUAL & DRAWINGS OF OTHER DISCIPLINES INCLUDING CIVIL.
- ACCESS TO AND CLEARANCES AROUND ELECTRICAL EQUIPMENT MUST CONFORM TO N.E.C. ARTICLES 110 AND 384. ELECTRICAL CONTRACTOR MUST CONSULT ENGINEER WHERE SPACE APPEARS INADEQUATE DUE TO ARCHITECTURAL CHANGES, EQUIPMENT LAYOUT CHANGES, OR FIELD CONDITIONS. DO NOT COVER, OBSCURE OR BLOCK ACCESS TO EQUIPMENT, DATA PLATES, ACCESS PLATES OR MAINTENANCE AREAS WITH THE ELECTRICAL
- THIS DRAWING SHOWS EQUIPMENT LOCATIONS ONLY. WIRING SHOWN IS SCHEMATIC IN NATURE. REFER TO RISER AND DETAILS FOR ALL REQUIRED POWER AND CONTROL WIRING. COORDINATE CONDUIT ROUTE IN FIELD WITH OTHER TRADES, EQUIPMENT AND OWNER. VERIFY ALL MOUNTING HEIGHTS WITH OWNER AND ARCHITECT PRIOR TO INSTALLATION.
- 10. UNLESS NOTED OTHERWISE, ALL HOMERUNS SHOWN ARE 2#12 & 1#12G IN 3/4" CONDUIT TO 20A-1P CIRCUIT BREAKER IN PANEL LÏSTED UNLÉSS DESIGN DICTATES UPSIZING.
- 11. UNLESS NOTED OTHERWISE, ALL WIRING OF CIRCUIT MUST MAINTAIN HOMERUN WIRING OF CIRCUIT. MINIMUM POWER WIRING TO BE 2#12 & 1#12G IN 3/4" CONDUIT. MINIMUM CONTROL WIRING SHALL BE 2#14, 3/4" CONDUIT.
- 12. CONDUIT ROUTES SHOWN ARE DIAGRAMMATIC IN NATURE AND ARE NOT INTENDED TO BE THE EXACT ROUTE. EXACT ROUTE TO BE DETERMINED IN FIELD. CONDUITS FOR NEW EQUIPMENT ARE TO BE RUN FROM PANEL TO ABOVE DROP CEILING, TIGHT TO STRUCTURE IF POSSIBLE.
- 13. ELECTRICAL CONTRACTOR IS RESPONSIBLE FOR VERIFYING EXISTING PANEL DIRECTORIES FOR ACCURACY AND SHALL UPDATE DIRECTORIES AS NECESSARY AT COMPLETION OF THE PROJECT PER NEC 408.4. CIRCUITS INDICATED ARE BASED ON PANEL DIRECTORY OBSERVATIONS. VERIFY CIRCUITS INDICATED FOR REUSE ARE AVAILABLE.
- 14. ALL WORK SHALL BE PERFORMED IN COMPLIANCE WITH THE APPLICABLE CODES IN THE ORDINANCES AND THE REGULATORY AGENCIES HAVING
- 15. CONTRACTORS SHALL PROVIDE ALL REQUIRED SLEEVES AND SEALS FOR PIPES OR CONDUIT PENETRATING WALLS OR FLOOR SLABS WITH UL LISTED FIRE STOPPING SEALANT WHERE REQUIRED.
- 16. ELECTRICAL CONDUITS & BOXES SHALL BE CONCEALED IN WALLS OR ABOVE CEILINGS WHEREVER POSSIBLE.

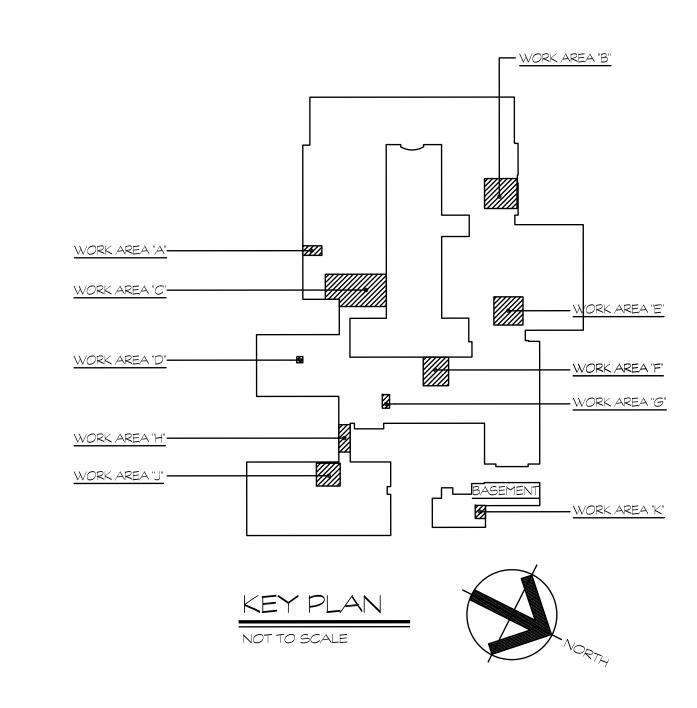

Hebron Elementary School Contaminated Water Piping Replacement 92 Church Street Hebron, Connecticut 06248



SILVER / PETRUCELLI + ASSOCIATES Architects / Engineers / Interior Designers 3190 Whitney Avenue, Hamden, CT 06518-2340 One Post Hill Place, New London, CT 06320 Tel. 203 230 9007 Fax. 203 230 8247

silverpetrucelli.com

SCALE: 1/8" = 1'-0"

Electrical Partial Power Plans

Drawing Number: AUGUST 16, 2019 E101 AS NOTED Drawn By: GΚ

State Project No:

067-0042 CV

S/P+A Project No: