

# Additions and Renovations Platt Technical High School

Milford, CT

## **ADDENDUM NO. 9**

August 29, 2019

The original Specifications and Drawings dated May 24, 2019, Addendum No.1 dated July 23, 2019, Addendum No.2 dated July 29, 2019, Addendum No.3 dated August 2, 2019, Addendum No.4 dated August 9, 2019, Addendum No.5 dated August 15, 2019, Addendum No.6 dated August 21, 2019, Addendum No.7 dated August 26<sup>th</sup> and Addendum No.8 dated August 27th for the above-captioned project are amended as stated in this Addendum. This Addendum consists of four (4) pages, plus the following attachments.

#### BID TIME AND DATE REMAIN UNCHANGED AS REVISED IN ADDENDUM No.8

#### **ATTACHMENTS**

**BID PACKAGE No.03, Concrete, Precast Connection Details** 

(2 pages)

LANDSCAPE ARCHITECTURE DRAWINGS L-503, L-507, L-508

(3 pages)

#### **AMENDMENTS TO ADDENDUM NO.3**

#### **DIVISION 08 – OPENINGS**

ADD 9-001

ADDENDUM NO.3, Page 8, ITEM ADD 3-030 – SECTION 08 45 23 – FIBERGLASS-SANDWICH-PANEL ASSEMBLIES

DELETE Addendum Item ADD 3-030. Requirements to meet FM Global Wind Speed shall REMAIN.

#### AMENDMENTS TO ADDENDUM NO.4

### **DIVISION 08 – OPENINGS**

ADD 9-002 ADDENDUM NO.4, Page 7, ITEM ADD 4-031 – SECTION 08 45 23 – FIBERGLASS-SANDWICH-

**PANEL ASSEMBLIES** 

DELETE the words "FM 4411 and."

ADD 9-003 ADDENDUM NO.4, Page 7, ITEM ADD 4-033 – SECTION 08 45 23 – FIBERGLASS-SANDWICH-

**PANEL ASSEMBLIES** 

REPLACE Article 1.4, Paragraph "I" with the following:

"I. Certify compliance with requirements for Class 1, Exterior Wall System per FM 4881. Provide panels that are marked with the FM 4881 Approval Stamps."



Additions and Renovations - Platt Technical High School - Milford, CT

#### AMENDMENTS TO ADDENDUM NO.5

#### **DIVISION 08 – OPENINGS**

#### ADD 9-004 ADDENDUM NO.5, Page 2, ITEM ADD 5-003 – SECTION 08 45 23 – FIBERGLASS-SANDWICH-

**PANEL ASSEMBLIES** 

DELETE Addendum Item ADD 5-003. Item ADD 4-037 published in Addendum No.4 shall REMAIN.

#### AMENDMENTS TO PROJECT MANUAL

#### **DIVISION 00 – PROCUREMENT AND CONTRACTING REQUIREMENTS**

## ADD 9-005 SECTION 00 41 10 – BID PACKAGE SUBMITTAL REQUIREMENTS

BID PACKAGE No.02, Site Work:

ADD the following: The contractor shall include a \$100,000 allowance in their bid package for the Water Connection Fee and Two wet taps to the Meter Pits for connection of the Site Water by the Water Company.

### ADD 9-006 SECTION 00 41 10 – BID PACKAGE SUBMITTAL REQUIREMENTS

BID PACKAGE No.03, Concrete:

Per the attached Sketch from the Precast Supplier, Precast Connection Details:

This is a reference to Detail F1A on Drawing S3-1-1.

The count of the sleeves in reference to the bottom of the Precast Wall Panels as shown at 48" O.C. is 882 pieces.

### ADD 9-007 SECTION 00 41 10 – BID PACKAGE SUBMITTAL REQUIREMENTS

BID PACKAGE No.03, Concrete:

Per the attached Sketch from the Precast Supplier, Precast Connection Details: This is a reference to Detail R7 & R8 on Drawing S5-2-3 (Addendum No.04) #4 rebar shall be @ 48 O.C. – Grout Cores Solid – Typical.

#### **DIVISION 03 – CONCRETE**

#### ADD 9-008 SECTION 03 40 40 – STRUCTURAL PRECAST SYSTEMS

Page 6, Part 2.1-D.2, REVISE the following Section:

2. Non-metallic, non-corrosive, non-staining product containing selected silica sands, Portland cement, shrinkage compensating materials, water-reducing admixtures, complying with ASTM C 1107. *Minimum compressive strength of 5,000 psi at 7 days*.

#### ADD 9-009 SECTION 03 45 00 – ARCHITECTURAL PRECAST CONCRETE

Page 8, Article 2.8, Paragraph A., ADD the following after the first sentence:

"Minimum compressive strength of 5,000 psi at 7 days."

#### **DIVISION 09 – FINISHES**

#### ADD 9-010 **SECTION 09 30 19 - PORCELAIN TILING**

Page 17, Article 2.8, Paragraph E: DELETE its entirety and REPLACE with the following:

- E. Miscellaneous
  - 1. Uncoupling / Waterproofing Membrane for floors: Subject to compliance with the requirements specified herein, manufacturers offering products which may be incorporated in the work include the following, or equal
    - a. Basis of design: Permat by Blanke Industries, Inc.
    - b. StrataMAT XT from Laticrete International, Inc.
    - c. DitraHEAT XT by Schluter
    - d. Or approved equal: Provide a product meeting ANSI A118.10 and as defined by TCA for "Uncoupling System".
  - 2. Grout and Stone sealer: Grout and stone should be sealed after grouting and before space is open to the public.
    - a. Basis of design: Stonetech Bulletproof by LATICRETE International, Inc
    - b. 511 Impregnator, Manufactured by Miracle Sealants and Abrasives
    - c. Sealers choice gold, By Aqua Mix products

### **DIVISION 22 – PLUMBING**

#### ADD 9-011 Section 22 11 23 - FACILITY NATURAL GAS PIPING

Page 7 Articles 2.9: Add.

- A. Product Description (Ventless): Spring loaded, general purpose, self-operating service regulator including internal relief type diaphragm assembly and vent valve. Diaphragm case can be rotated 360 degrees in relation to body.
  - 1. Comply with ANSI Z21.80.
  - 2. Temperatures: minus 20 degrees F to 150 degrees F.
  - 3. Body: Steel.
  - 4. Spring case, lower diaphragm casing, union ring, seat ring and disk holder: Aluminum.
  - 5. Disk, diaphragm, and O-ring: Nitrile
  - Maximum inlet pressure: 150 psig. 6.
  - Vent line regulator for vent limiting device for indoor applications only. 7.
  - Furnish sizes 2 inches and smaller with threaded ends. Furnish sizes 2-1/2 inches and 8. larger with flanged ends

#### **DIVISION 32 – EXTERIOR IMPROVEMENTS**

#### ADD 9-012 **SECTION 32 31 13 - CHAIN LINK FENCES AND GATES**

Page 2, Article 2.1, Paragraph B, Subparagraph 1 DELETE "local Codes" and REPLACE with "Connecticut State Building Code".

#### **AMENDMENTS TO DRAWINGS**

#### LANDSCAPE ARCHITECTURE

#### ADD 9-013 DRAWING L-503- SITE DETAILS

Modify Detail 2 Chain Link Fence REVISE dimension for footing as noted. Refer to revision tag RL9-01.

#### ADD 9-014 DRAWING L-507- SITE DETAILS

Modify Detail 5 Baseball Backstop ADD footing 2'-4" Dia. dimension as noted. ADD "6 5/8" Post, 1.66" Top Mid and Bottom Rails" as noted. Refer to revision tag RL9-02.

Modify Detail 6 Softball Backstop ADD footing depth 5'-6" Min. and 1'-4" Dia. dimensions as noted. ADD "4" Post, 1.66" Rails, and 2 3/8" Hood Framework" as noted. Refer to revision tag RL9-03.

#### ADD 9-015 DRAWING L-508- SITE DETAILS

Modify Detail 5 Batting Cage ADD footing depth 4' Min. and 1'-4" Dia. dimensions as noted. ADD "4" Post, 1.66" Rails" as noted. ADD "17/8" Strut" as noted. ADD 2 3/8" Roof Framing and Support Structure" as noted. Refer to revision tag RL9-04.

#### **ARCHITECTURAL FINISHES**

## ADD 9-016 DRAWINGS AF1-1-1A, AF1-1-B, AF1-2-1C, AF1-1-1D, AF1-1-1E, AF1-1-1F, AF1-1-1G, AF1-1-2B, AF1-1-2C, AF1-1-2D, AF1-1-2E - FLOOR FINISHES PLANS

ADD "General Notes 8" to the sheet per the following:

"8. PROVIDE UNCOUPLING/ WATERPROOFING MEMBRANE OVER ENTIRE FLOOR AREA WHICH RECEIVES PORCELAIN TILE.

#### ADD 9-017 DRAWING AF1-1-B - FIRST LEVEL FLOOR FINISHES PLAN - AREA B


DELETE note "PROVIDE EXTRA CRACK SUPPRESSION MEMBRANE, TYP."

#### **STRUCTURAL**


#### ADD 9-018 DRAWING S1-1-3C - THIRD FLOOR AND ROOF FRAMING PLAN - AREA C

REVISE section designation near column "KK-21.8" to read "S5/S4-1-4".

END OF ADDENDUM NO.9

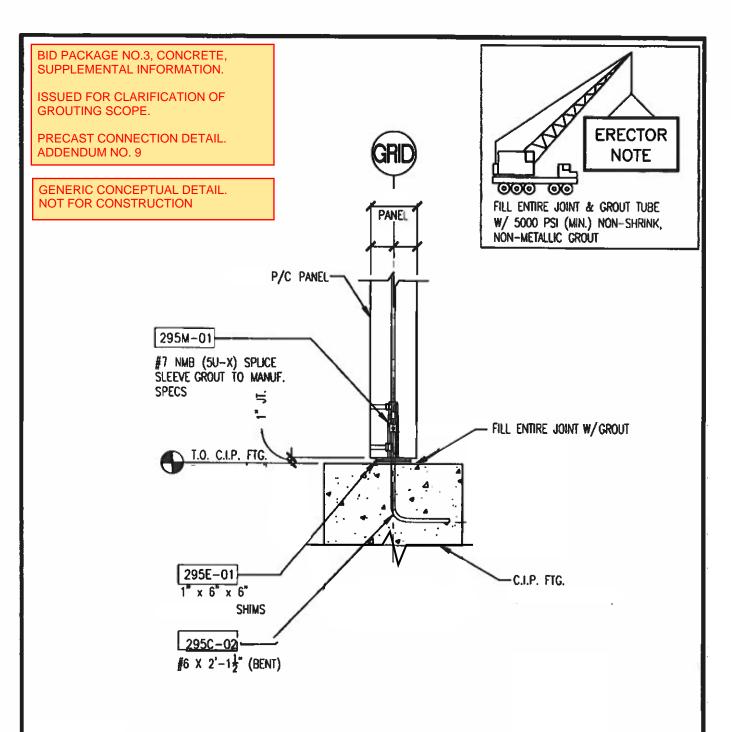


882 pcs

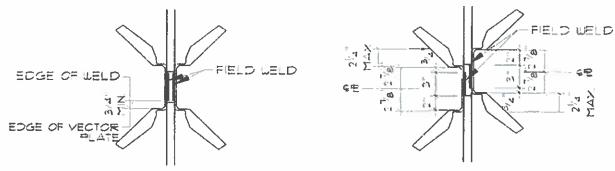


#### ALIGNED VECTORS IN PLAN

#### MAXIMUM MIS-ALIGNED VECTORS IN PLAN

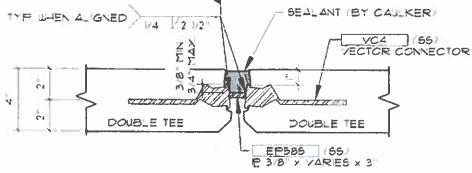

#### DETAIL FOR ERECTION PLATES OVER AND UNDER I"

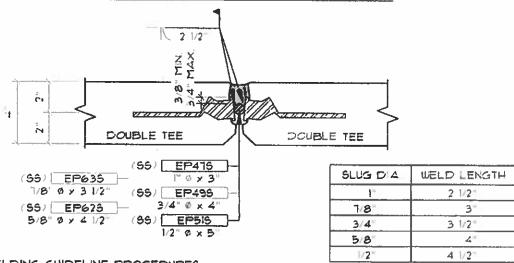

#### WELDING GUIDELINE PROCEDURES:

- 1) PLACE THE WELD IN THE CENTER OF EACH JVI CONNECTOR FACEPLATE.
- 2) DO NOT PLACE ANY WELD CLOSER THAN 3/4" FROM THE END OF EXPOSED VECTOR CONNECTOR
- 3) DO NOT OVER WELD OR WELD NEAR ENDS.
- 4) MAINTAIN LEVEL PLANES WHEN SETTING FIELD PLATE.
- 5) AFTER WELDING ONE SIDE OF LOOSE PLATE, ALLOW TIME TO COOL BEFORE WELDING OTHER SIDE.

#### NOTE:


I. FINAL JOINT PREPARATION TO BE DONE IN CONFORMANCE WITH SEALANT MANUFACTURER'S SPECIFICATIONS.


BID PACKAGE NO.3, CONCRETE, SUPPLEMENTAL INFORMATION.

ISSUED FOR CLARIFICATION OF GROUTING SCOPE.

PRECAST CONNECTION DETAIL. ADDENDUM NO. 9

GENERIC CONCEPTUAL DETAIL. NOT FOR CONSTRUCTION

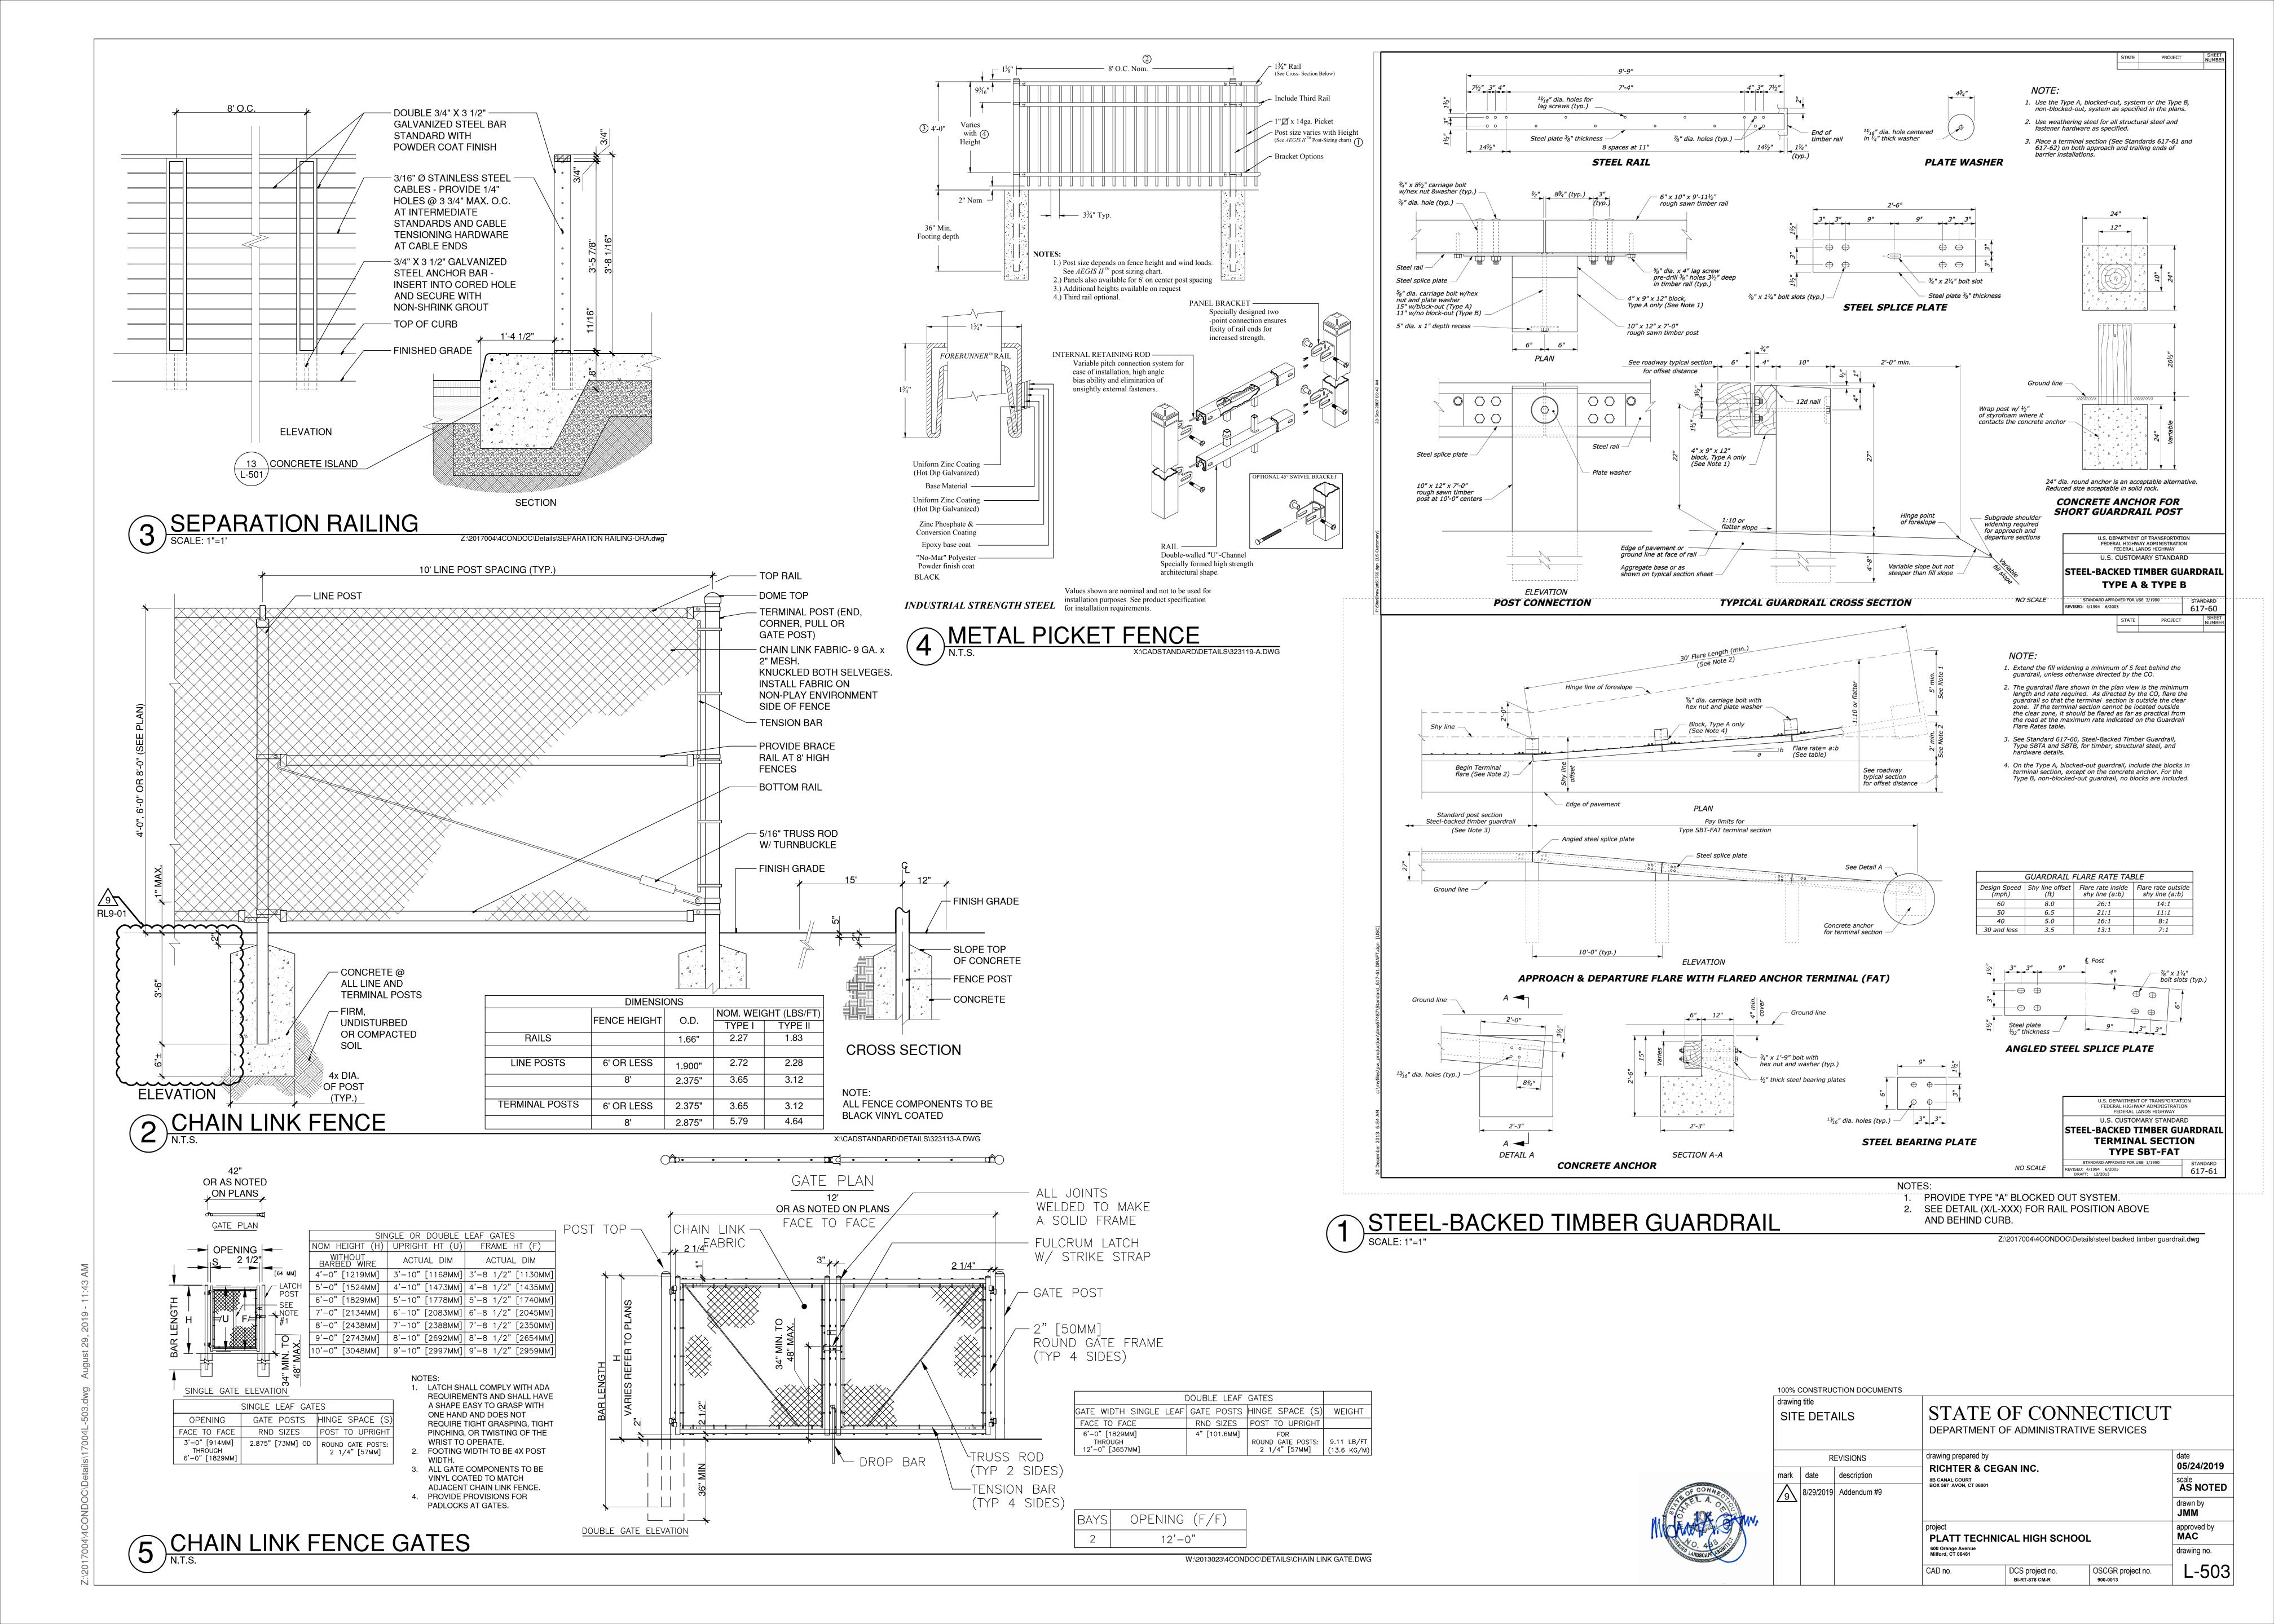


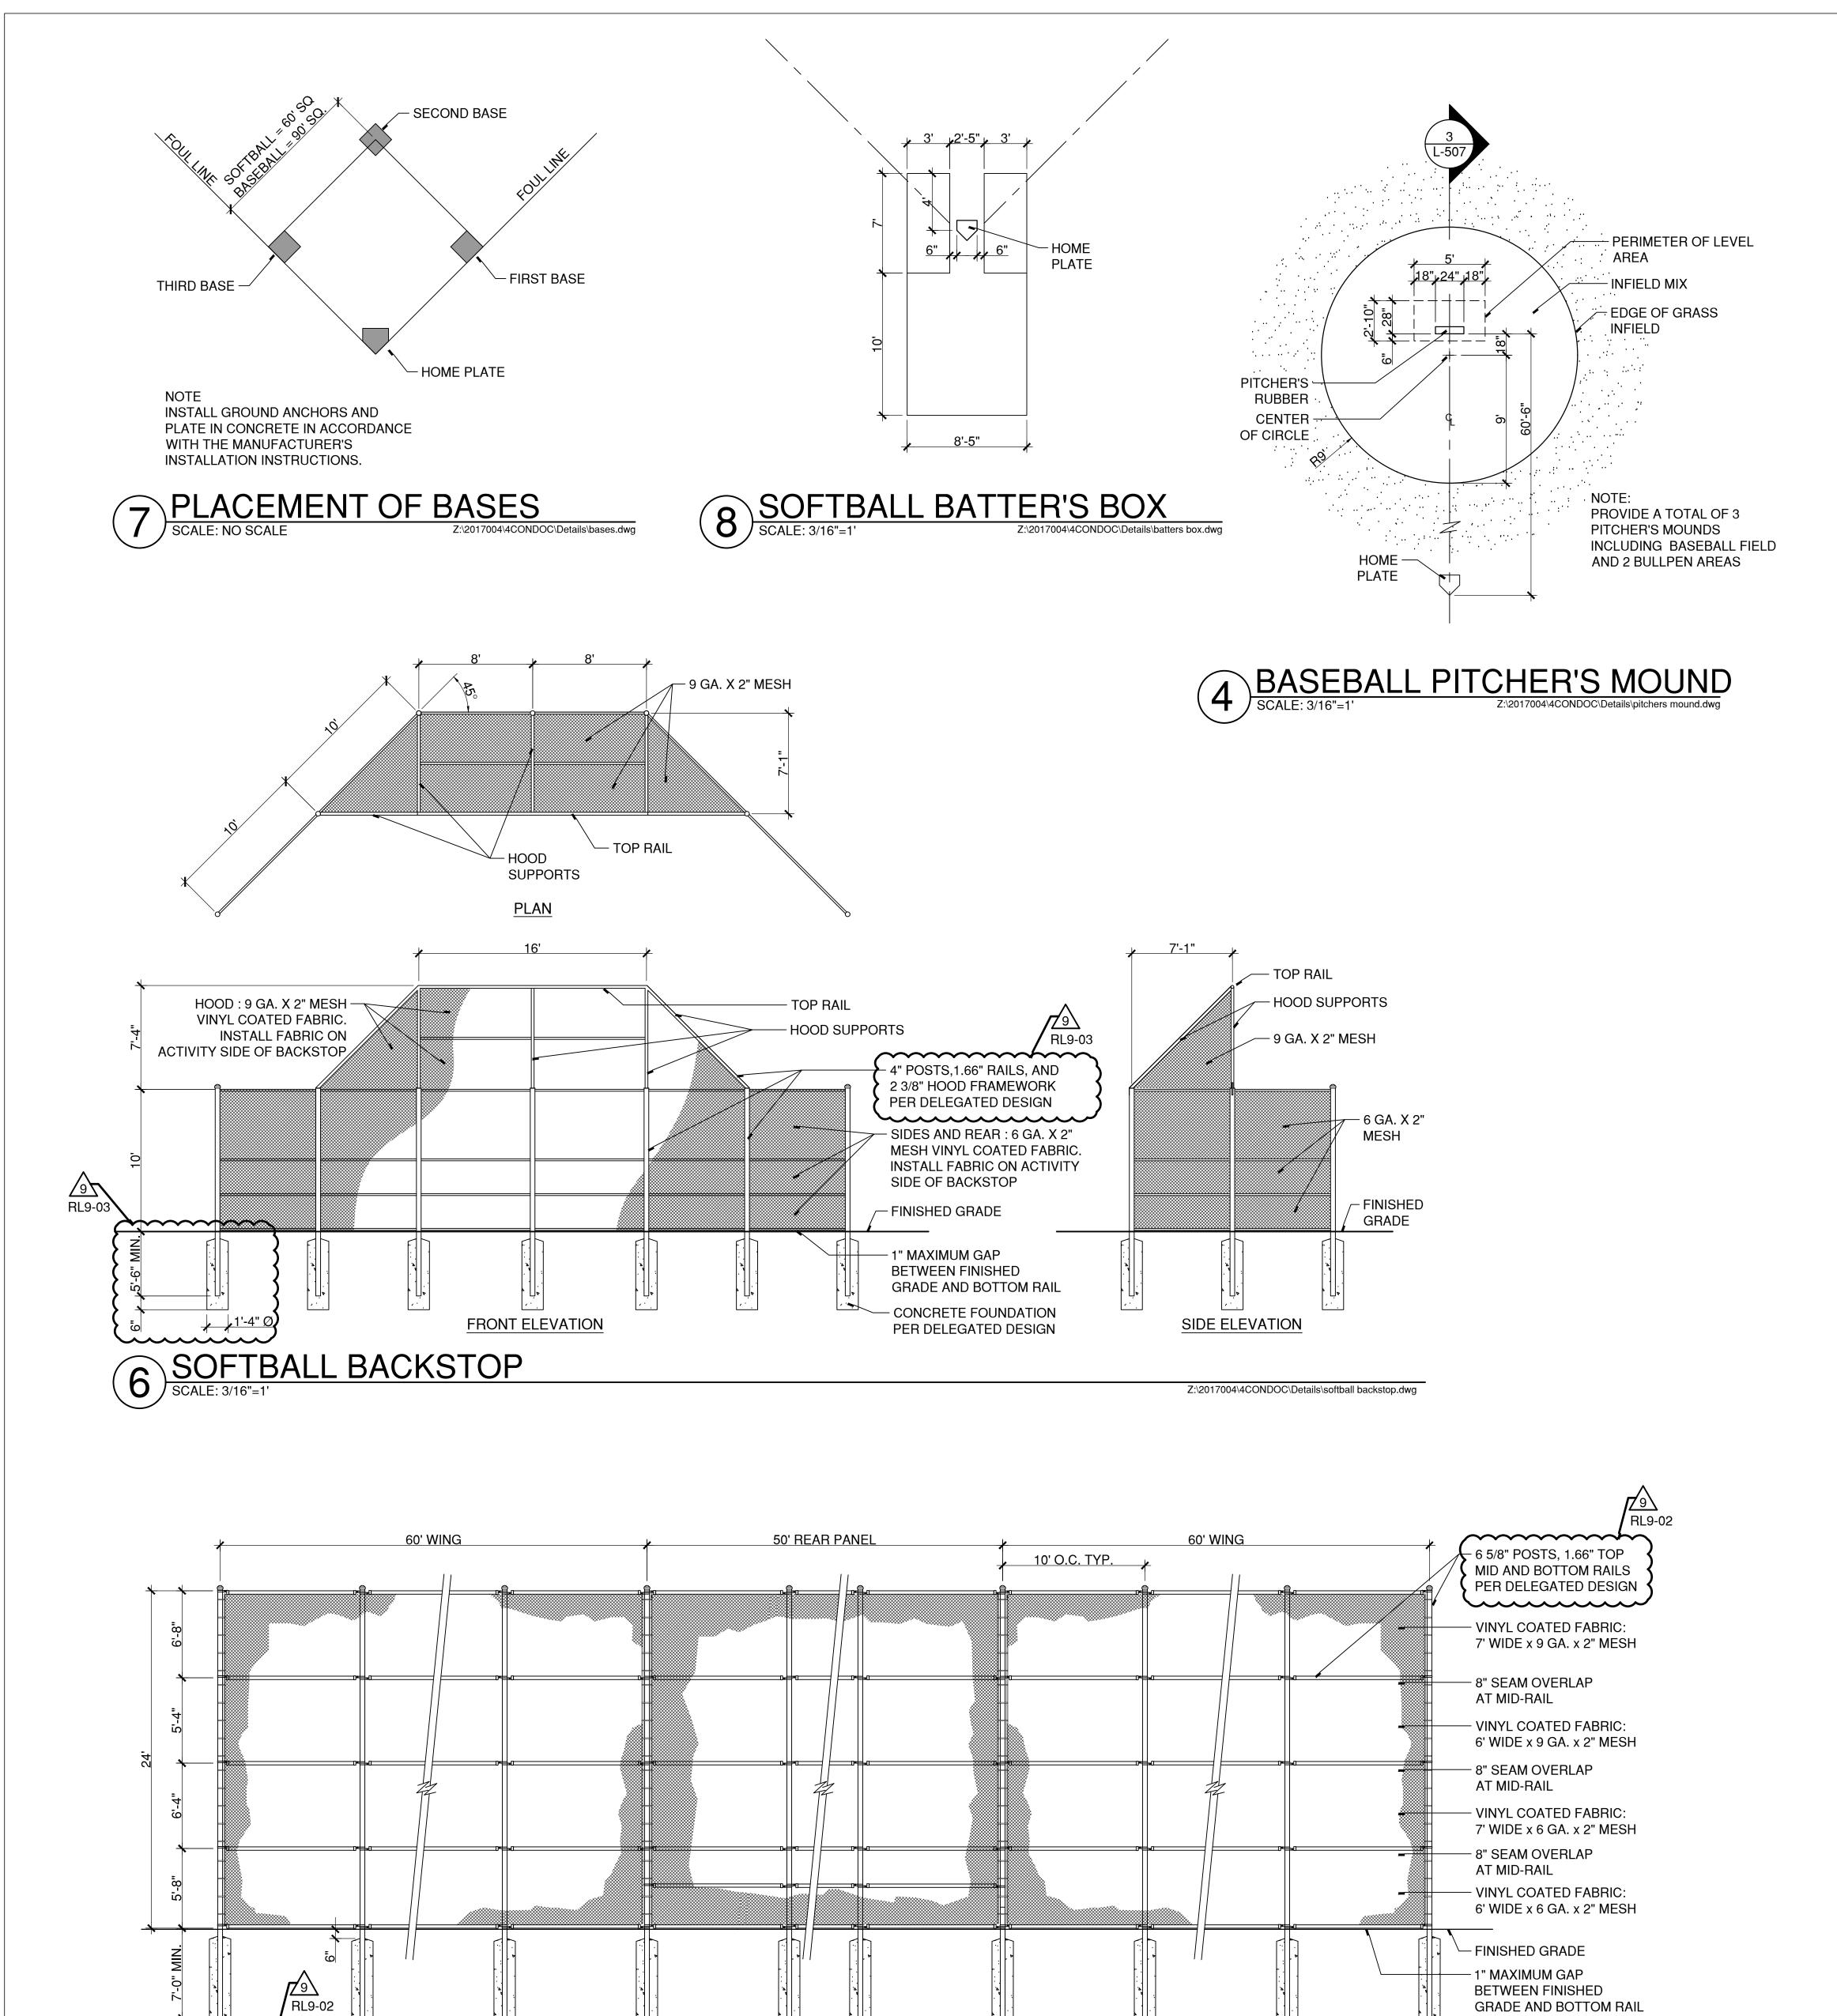

- CONCRETE FOUNDATION


PER DELEGATED DESIGN

Z:\2017004\4CONDOC\Details\baseball backstop.dwg

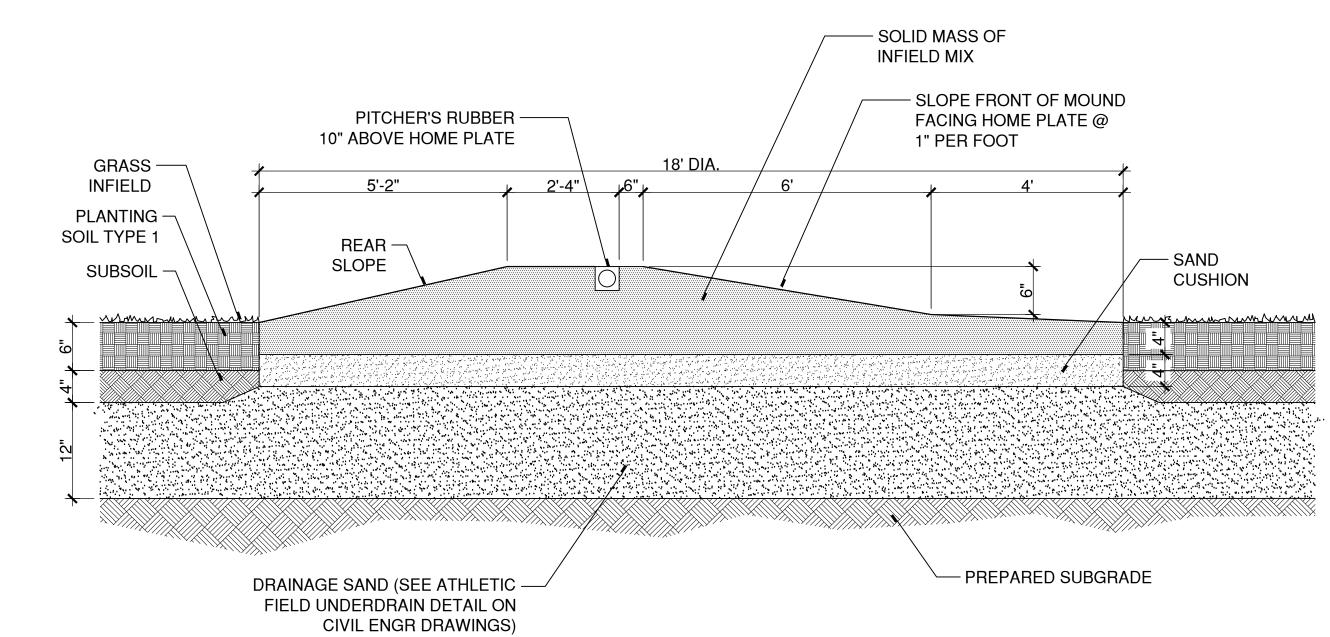


3 BASEBALL PITCHER'S MOUND SECTION SCALE: 1/2"=1' (H) x 1" = 1' (V)


Z:\2017004\4CONDOC\Details\pitchers mound section.dwg

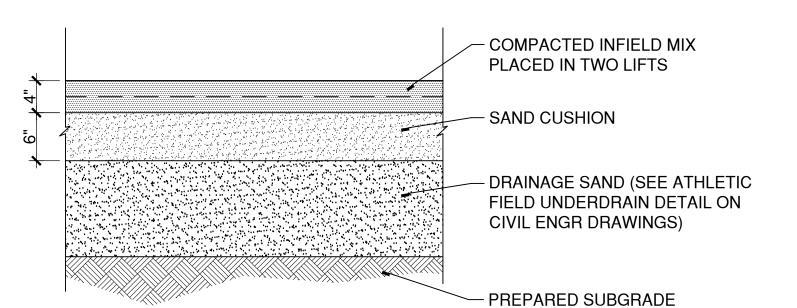

SKINNED INFIELD
SCALE: 1"=1"
Z:\2017004 Z:\2017004\4CONDOC\Details\skinned infield.dwg

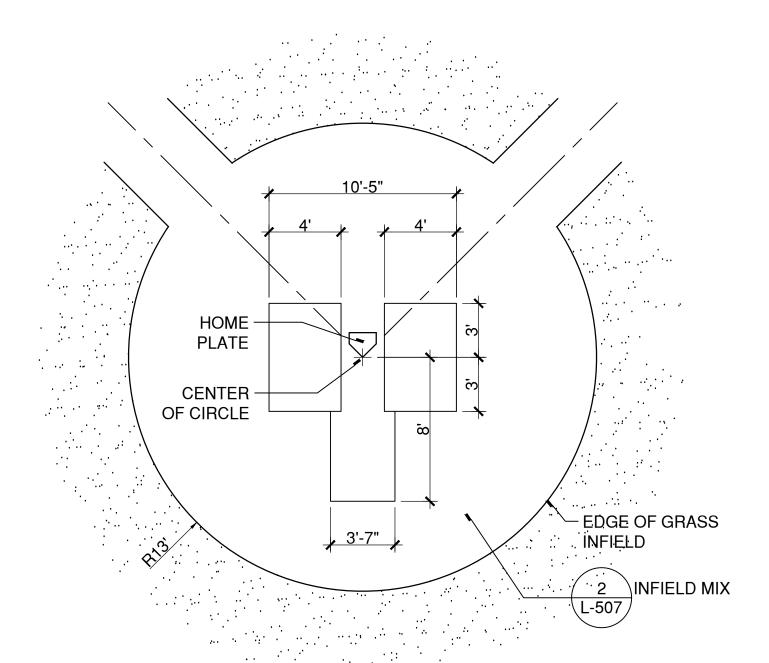


1 BASEBALL BATTER'S BOX
SCALE: 3/16"=1'
Z:\2017004\4CONDOC\Details\batters Z:\2017004\4CONDOC\Details\batters box.dwg

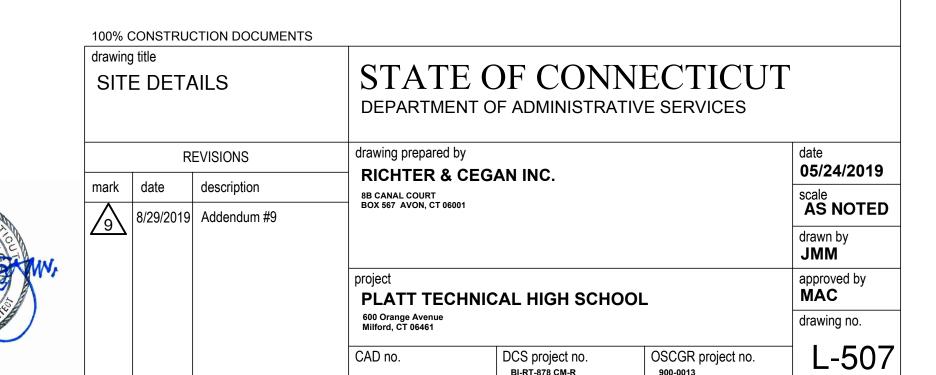


BI-RT-878 CM-R

5 BASEBALL BACKSTOP

SCALE: 3/16"=1"

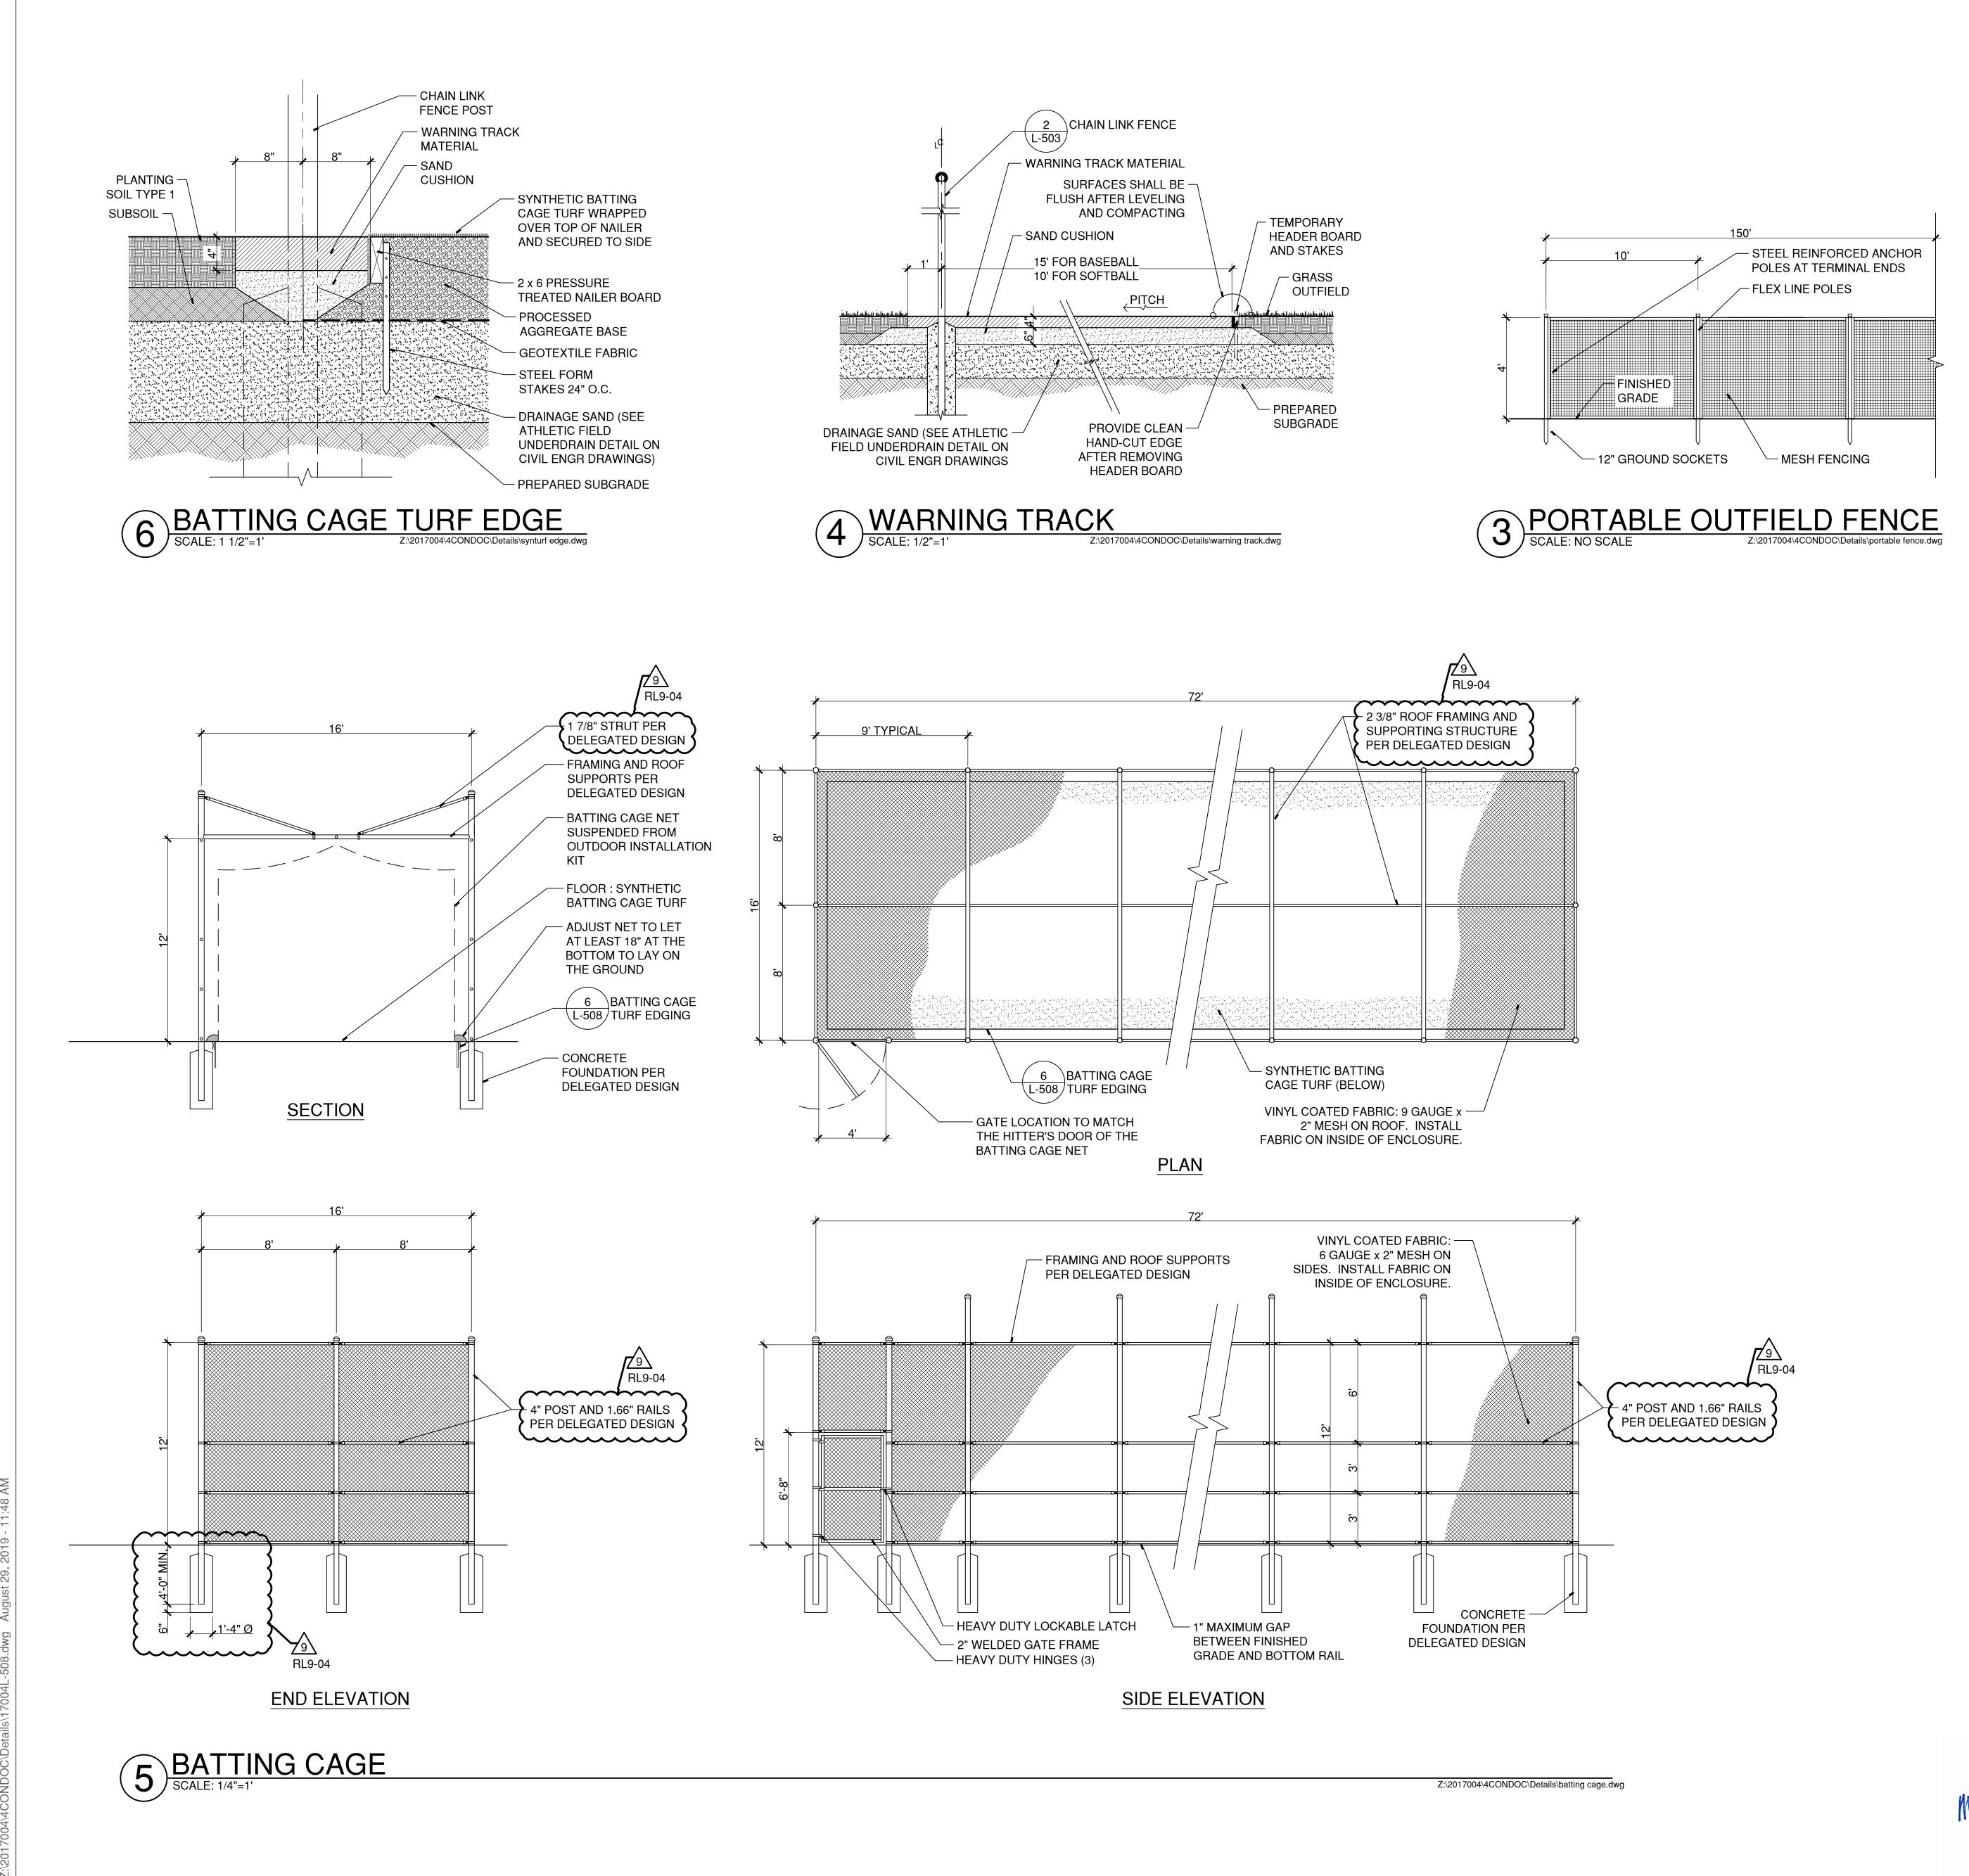

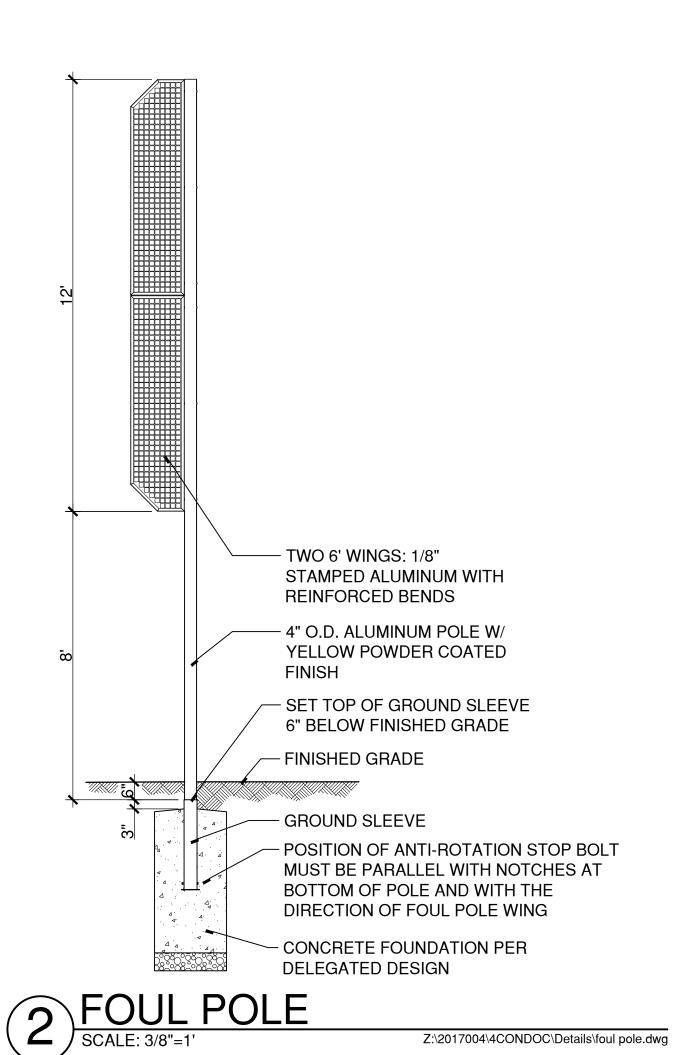

FOUL GROUND GROUND - ALIGN FOUL EDGE OF FOUL POLE WITH FOUL EDGE OF FOUL LINE FOUL POLE FOUL POLE WING - 2' BEHIND CHAIN LINK OUTFIELD FENCE OR 8' BEHIND PORTABLE OUTFIELD NOTE: — CHAIN LINK OR PORTABLE LOCATION ALONG THE OUTFIELD FENCE (SEE PLANS) THIRD BASE FOUL LINE IS SHOWN. THE FIRST — 2 1/2" WIDE FOUL LINE BASE FOUL POLE IS MARKING MIRROR IMAGE.

1 FOUL POLE PLACEMENT
SCALE: NO SCALE
Z:\2017004\4CONDOC\Details\foul pole

		CTION DOCUMENTS				
drawing title SITE DETAILS			STATE OF CONNECTICUT DEPARTMENT OF ADMINISTRATIVE SERVICES			
REVISIONS				drawing prepared by  RICHTER & CEGAN INC.		
mark	date	description	8B CANAL COURT BOX 567 AVON, CT 06001			05/24/2019 scale
9	8/29/2019	Addendum #9				AS NOTE
791						drawn by <b>JMM</b>
			project PLATT TECHNICAL HIGH SCHOOL			approved by <b>MAC</b>
			600 Orange Avenue Milford, CT 06461			drawing no.
			CAD no.	DCS project no.	OSCGR project no.	L-50