Proposed Commercial Kitchen Expansion

EASTCONN

376 Hartford Turnpike Hampton, Connecticut

Date: June 26, 2019

OWNER

EASTCONN
376 Hartford Turnpike
Hampton, CT 06247

Facilities Department Phone: 860-455-1543

ARCHITECT

Evelyn Cole Smith Architects, LLC
P.O. Box 182
134 B Main Street
Putnam, CT 06260

Phone: 860-315-9570

CIVIL ENGINEER


CME Associates, Inc.
33 Wilbur Cross Way, Suite 105
Mansfield, CT 06268


Phone: 860-855-1055


MECHANICAL ENGINEER

Salamone & Associates PC 116 North Plains Industrial Road Wallingford, CT 06492


Phone: 203-281-6895

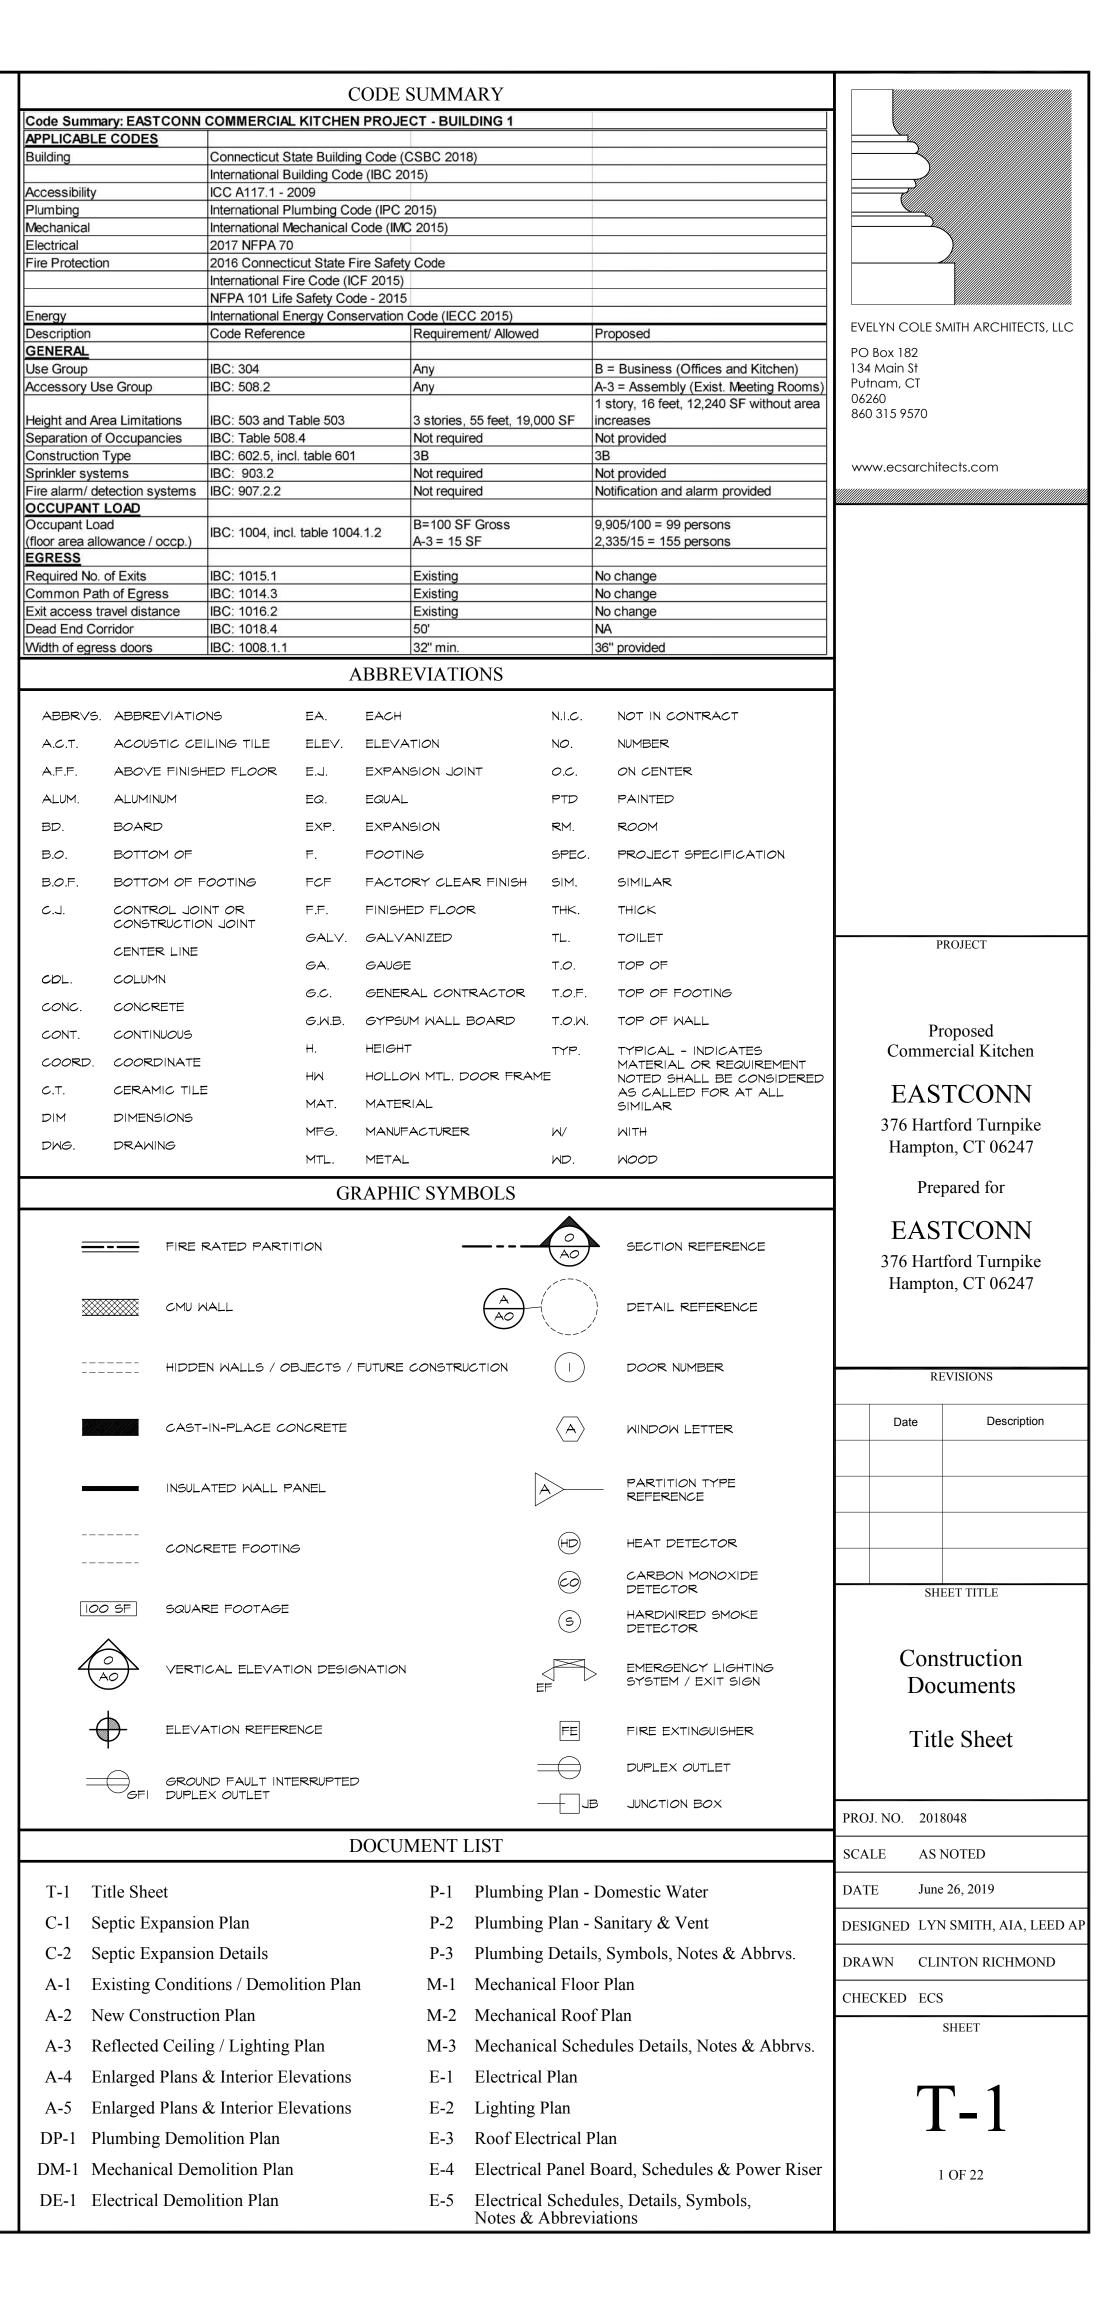


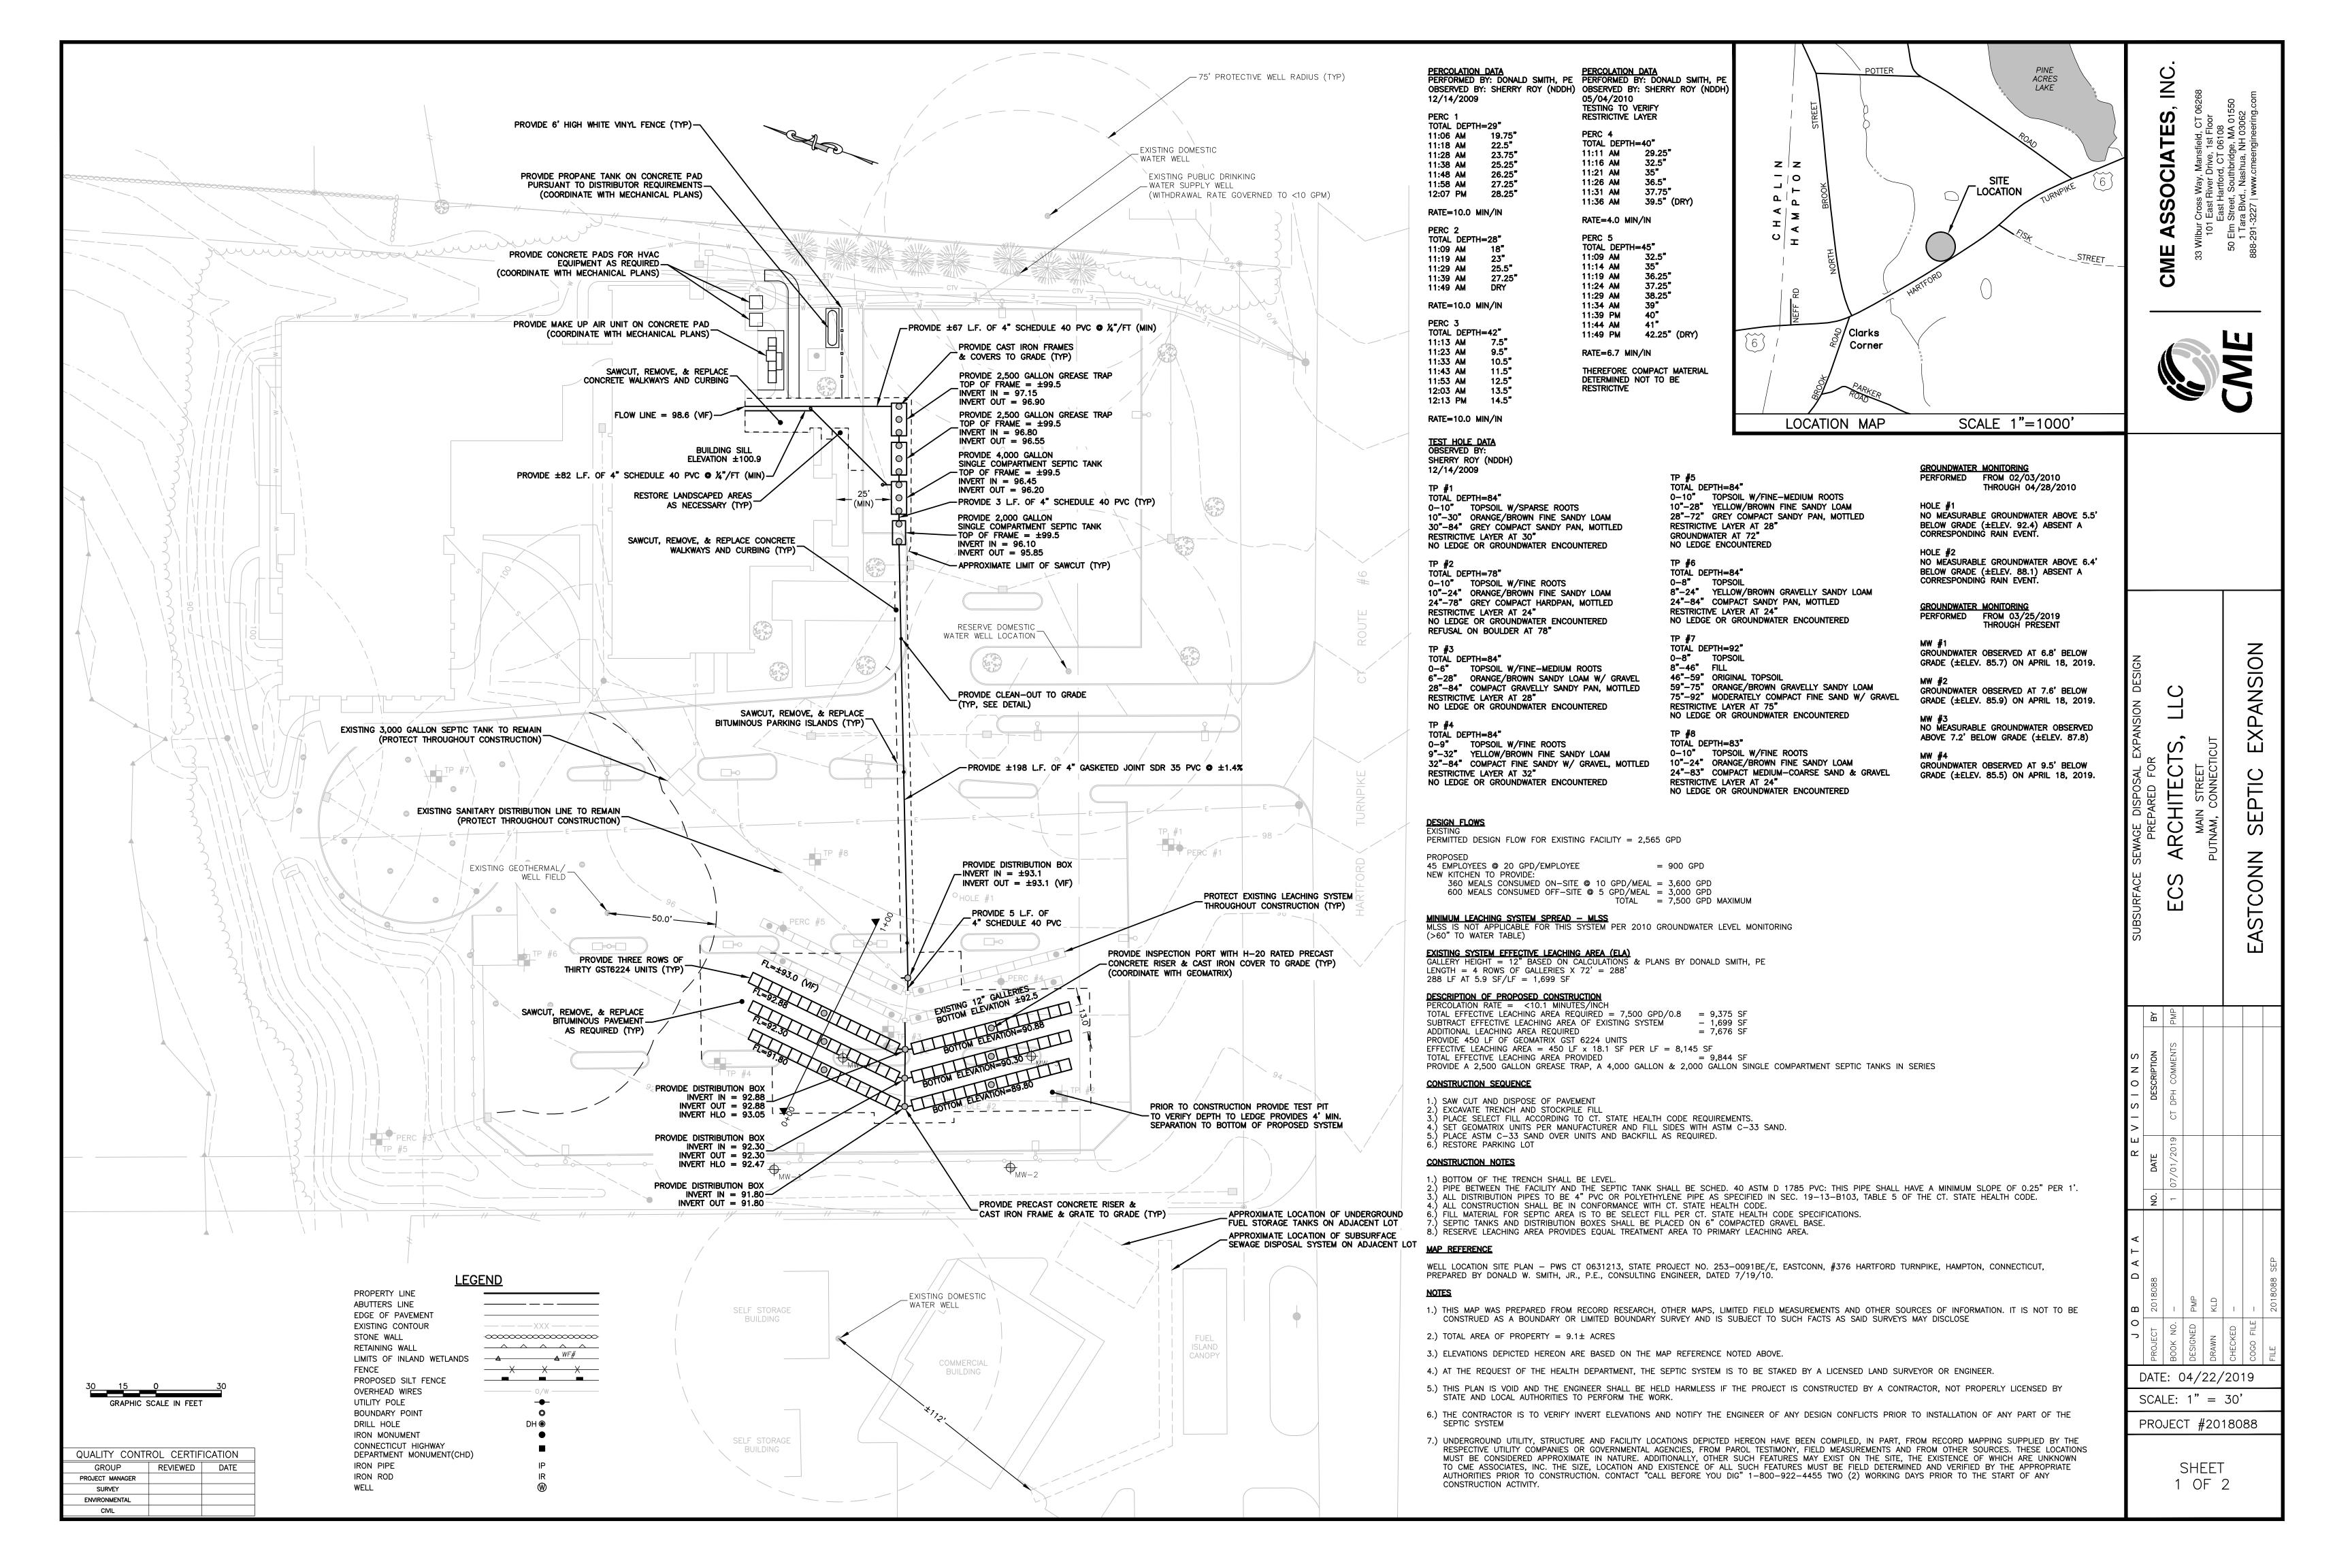

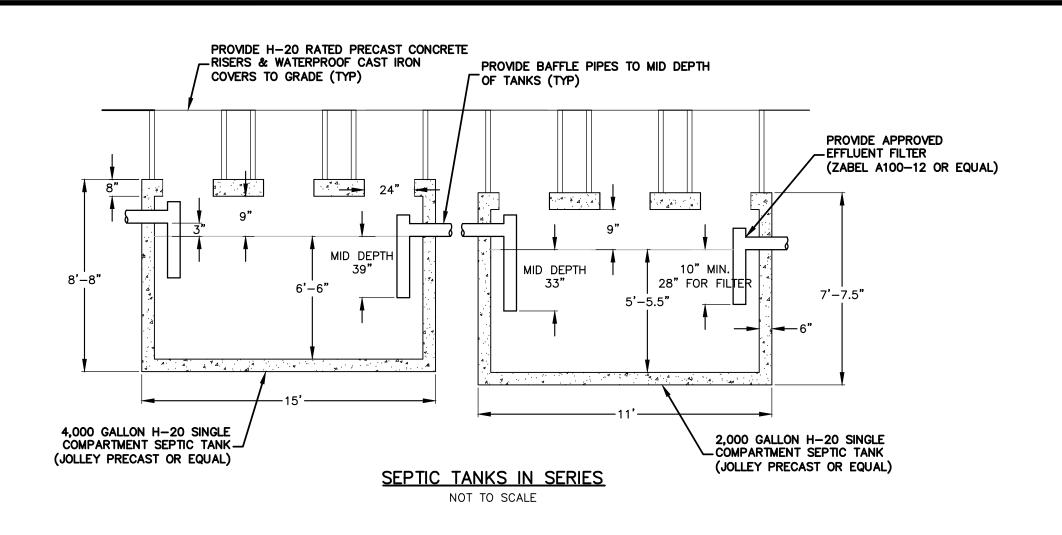


- COMPACTED SAND

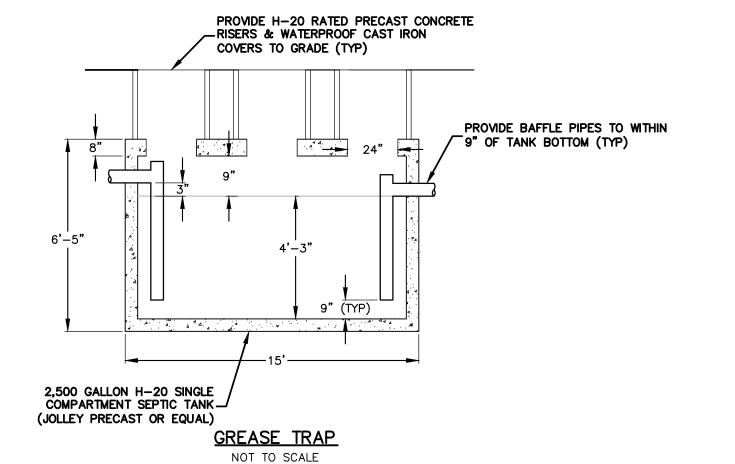

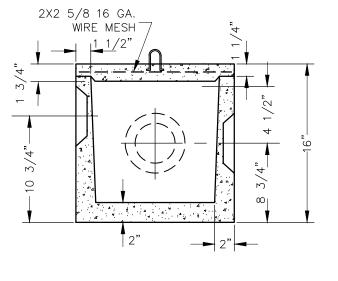



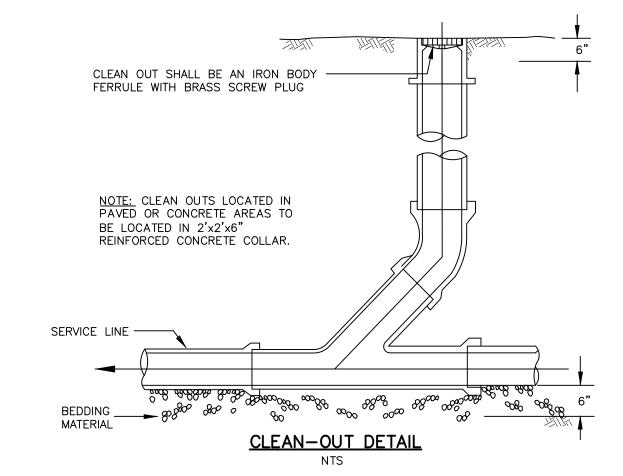

SEPTIC SYSTEM FILL MATERIAL SPECIFICATIONS

1.) THE FILL SHALL NOT CONTAIN ANY MATERIAL LARGER THAN THREE(3) INCHES.

2.) UP TO 45% OF THE DRY WEIGHT OF THE REPRESENTATIVE SAMPLE MAY BE RETAINED ON THE #4 SIEVE (THIS IS THE GRAVEL PORTION OF THE SAMPLE).

3.) THE MATERIAL THAT PASSES THE #4 SIEVE IS THEN REWEIGHED AND THE SIEVE ANALYSIS STARTED 4.) THE REMAINING SAMPLE SHALL MEET THE FOLLOWING GRADATION CRITERIA.

 PERCENT PASSING

 SIEVE SIZE
 WET SIEVE
 DRY SIEVE

 #4
 100%
 100%

 #10
 70%-100%
 70%-100%

 #40
 10%-50% * 10%-75%


 #100
 0%-20%
 0%-5%


 #200
 0%-5%
 0%-2.5%


*NOTE: PERCENT PASSING THE #40 SIEVE CAN BE INCREASED TO NO GREATER THAN 75% IF THE PERCENT PASSING THE #100 SIEVE DOES NOT EXCEED 10% AND THE #200 DOES NOT EXCEED 5%

GEOMATRIX GST™62" LEACHING SYSTEM

Finished Grade shall be pitched to sheet flow stormwater away from system

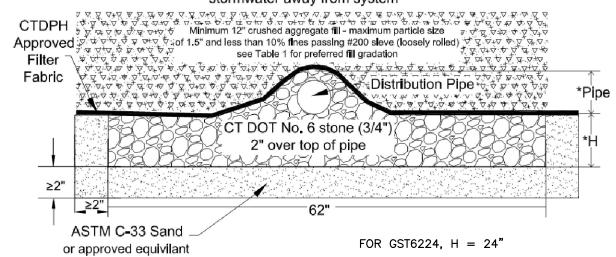

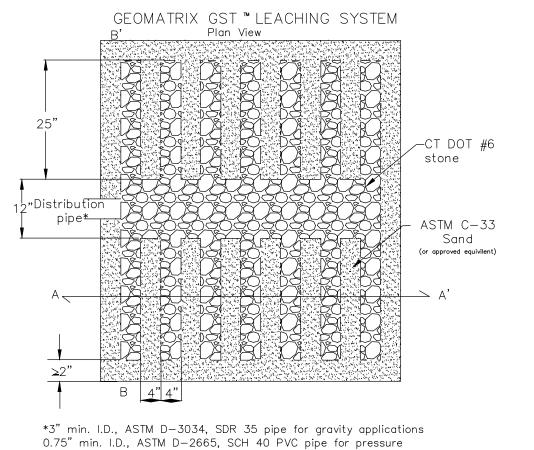

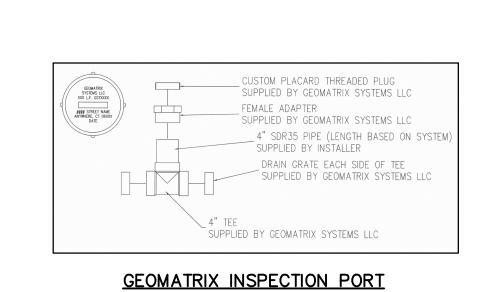


SURFACE COURSE

12" COMPACTED TRAFFIC BOUND GRAVEL SURFACE——PER M.02.03 OF FORM 817, GRADING "C" (1.5" MINUS)

BITUMINOUS CONCRETE PAVEMENT

NOT TO SCALE

2-1/2" CLASS 1 BINDER COURSE

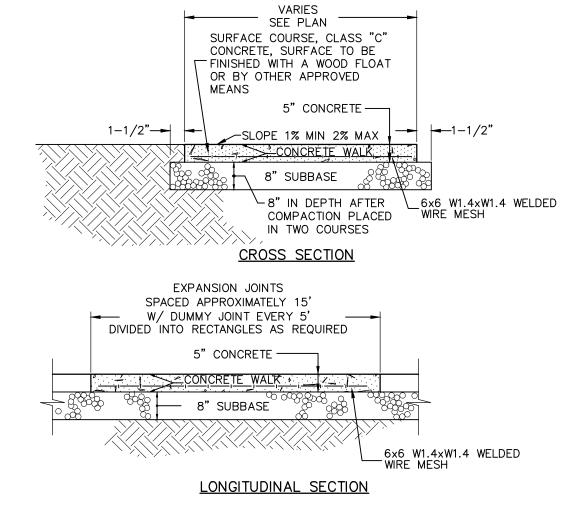

CONCRETE SIDEWALK

NOT TO SCALE

∠ĆOMPÁCTÉD NÁTIVE∕

´_MĄTĘRIĄL OŔ /

/ BORROW /

TRENCH SECTION FOR SANITARY SEWER TRENCH

NOT TO SCALE

BACKFILL MATERIAL TO BE PLACED IN 12" MAXIMUM LIFTS


(AS DETERMINED BY THE MODIFIED PROCTOR METHOD)

& COMPACTED TO 95% MAXIMUM DRY DENSITY

1/4" O.D., 6" MIN.

TRENCH BOTTOM -

12" MINIMUM IN ROCK EXCAVATION -

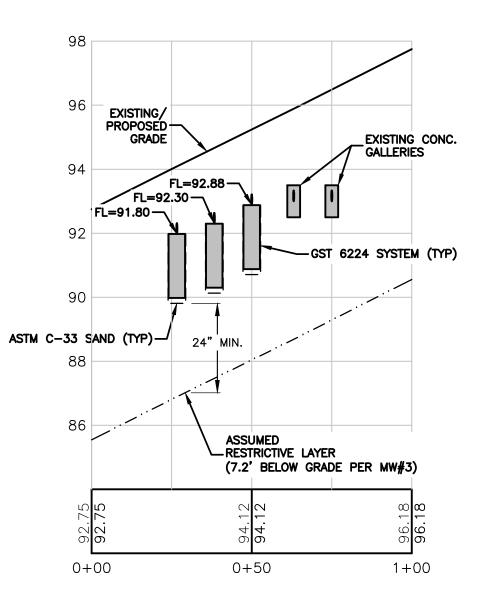

CROSS SECTION

1"=30' HORIZONTAL


1"=3' VERTICAL

D A T A R E V I S I O N S 18088 NO. DATE DESCRIPTION 1 07/01/2019 CT DPH COMMENTS F D D 18088 SFP		SUBSURFACE SEWAGE DISPOSAL
D A T A NO. DAT 1 07/01/		VISIONS
180881 D D 180883	-	R
	0	
PROJECT BOOK NO. DESIGNED DRAWN CHECKED COGO FILE		1 O B
DATE: 04/22/2019		
SCALE: AS NOTED	SC	5

PROJECT #2018088

SHEET 2 OF 2

QUALITY CONTR	ROL CERTIF	ICATION
GROUP	REVIEWED	DATE
PROJECT MANAGER		
SURVEY		
ENVIRONMENTAL		

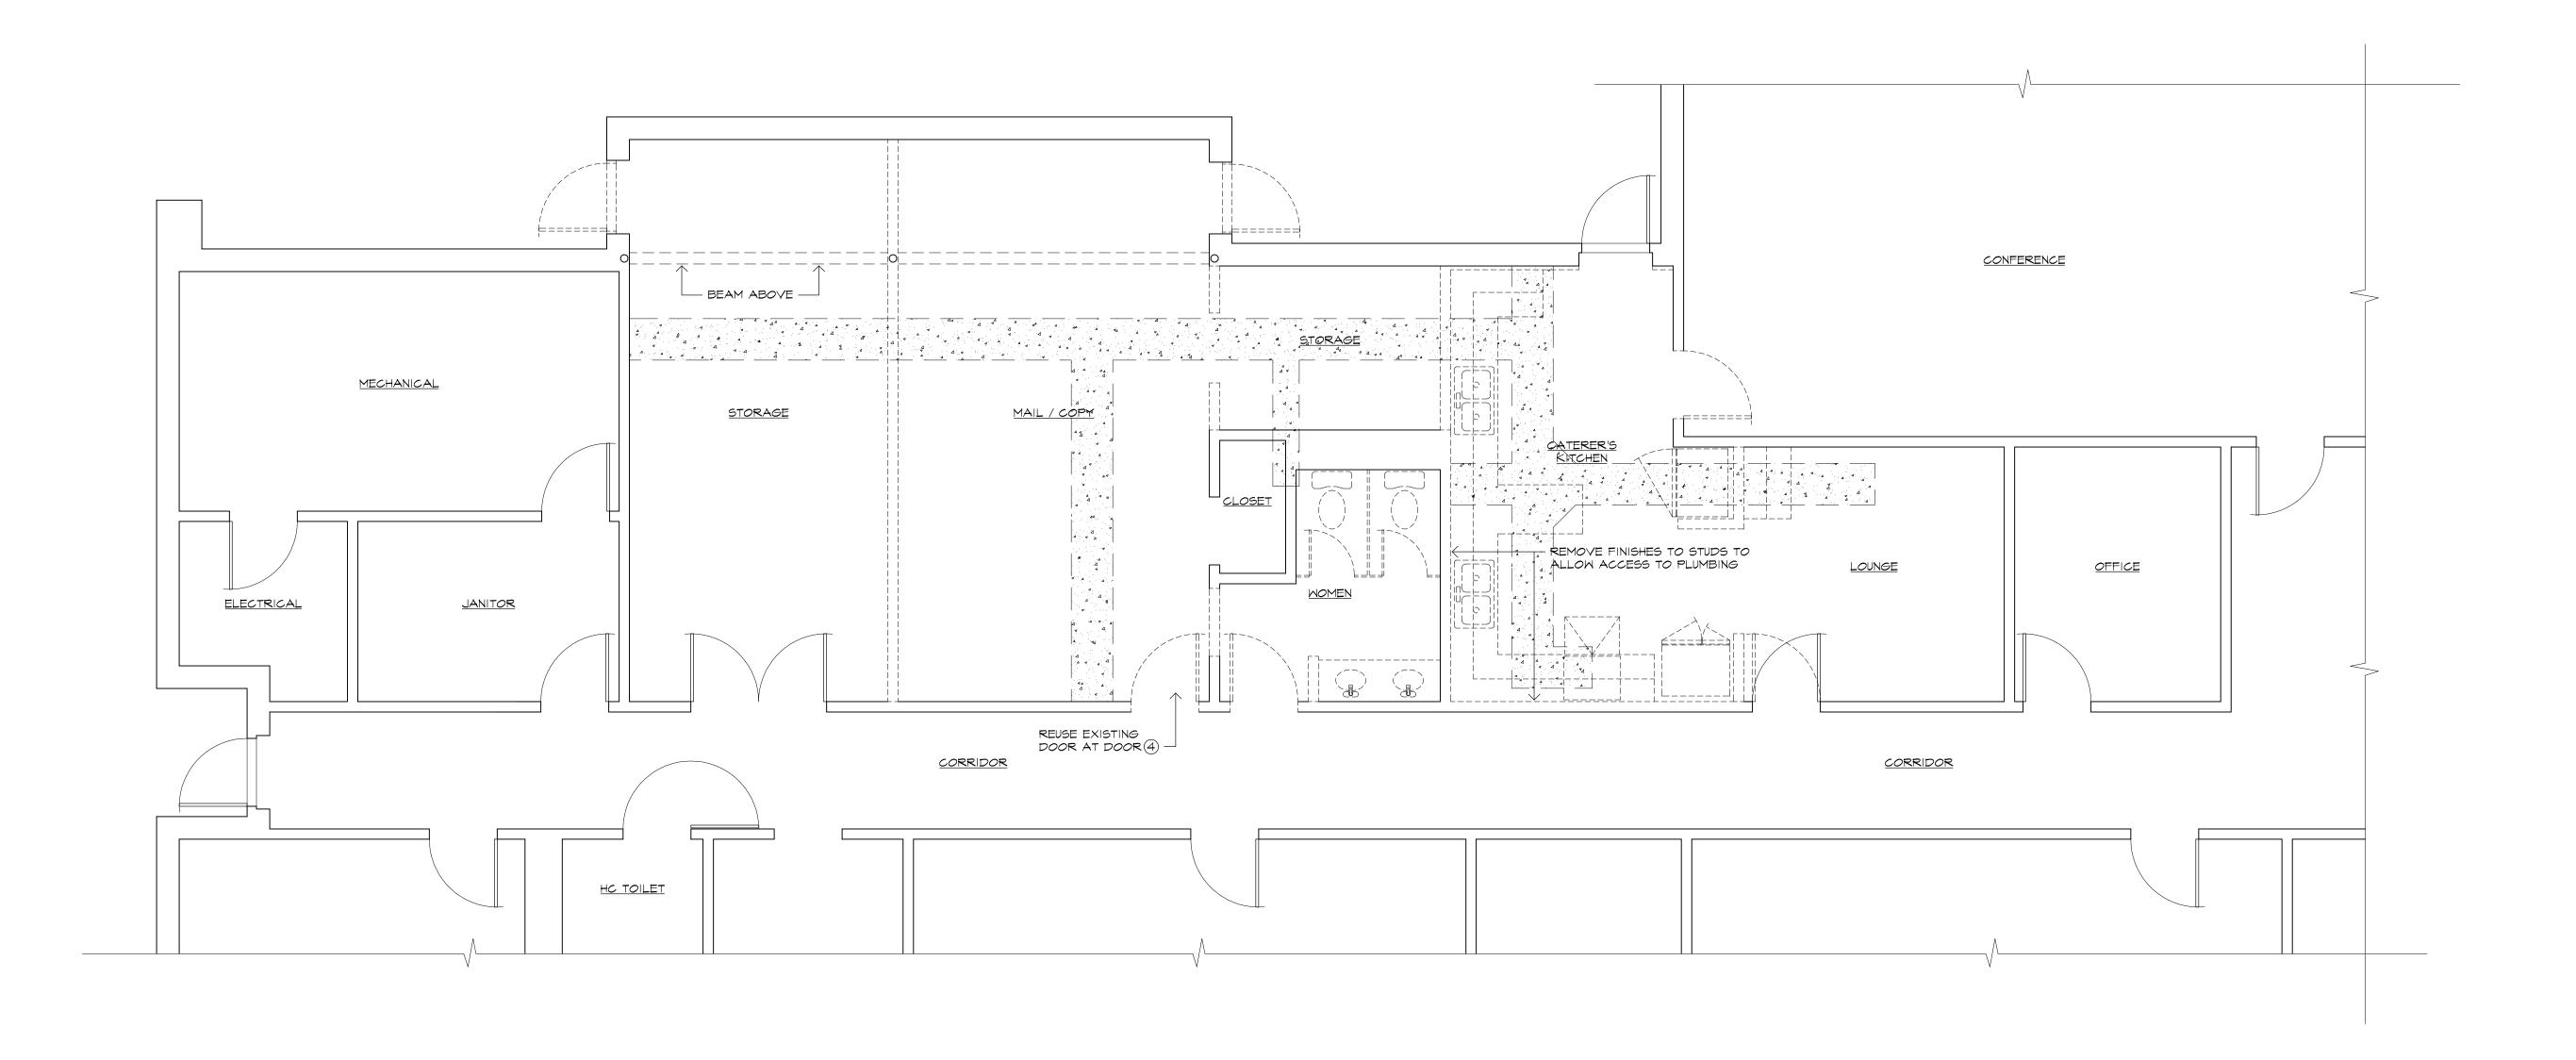

FIRST FLOOR EXISTING / DEMOLITION PLAN SCALE: 1/4"=1'-0"

3. EXISTING ACOUSTIC TILE CEILING & GRID TO BE REMOVED.

I. SEE DP-1, DM-1, AND DE-1 FOR PLUMBING, MECHANICAL & ELECTRICAL DEMOLITION EXTENTS.

2. EXISTING FLOOR FINISHES TO BE REMOVED TO CONCRETE SLAB. PREPARE SLAB FOR NEW TILE FLOOR.

4. REMOVE EXISTING CONCRETE SLAB GENERALLY IN LOCATIONS SHOWN. COORDINATE WITH PLUMBING DRAWINGS.

EVELYN COLE SMITH ARCHITECTS, LLC PO Box 182 134 Main St

PO Box 182 134 Main St Putnam, CT 06260 860 315 9570

www.ecsarchitects.com

STAMP

RESERVED

PROJECT

Proposed Commercial Kitchen

EASTCONN
376 Hartford Turnpike

Hampton, CT 06247

Prepared for

EASTCONN
376 Hartford Turnpike

REVISIONS

Hampton, CT 06247

	Date	Description

Construction

SHEET TITLE

Documents

Existing Conditions / Demolition Plan

PROJ. NO. 2018048

SCALE AS NOTED

LEGEND

EXISTING WALL

EXISTING WALL TO BE REMOVED

EXISTING SLAB TO BE REMOVED

DATE June 26, 2019


DESIGNED LYN SMITH, AIA, LEED A

DRAWN CLINTON RICHMOND

CHECKED ECS

A-



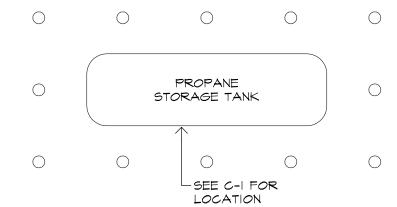


	DESCRIPTION		SIZE		TYPE FEATURES		RES	FRAME		REMARKS	
DOOR NUMBER	ROOM NAME	WIDTH	HEIGHT	THICKNESS		FLUSH WOOD	TEMPERED GLASS	PRE-MANUFACTURED	FRAME MATERIAL	HARDWARE SET	
1	HC TOILET	3'-0"	6'-8"	1 3/8"	Α	•			HM	1	NEW DOOR AND FRAME.
2	JANITOR	3'-0"	6'-8"	1 3/8"	Α	•			НМ	2	REUSE DOOR IN EXIST. FRAME. ADD STOP
3	DRY FOOD STORAGE	3'-0"	6'-8"	1 3/8"	Α	•			НМ	3	NEW DOOR AND FRAME.
4	CORRIDOR	3'-0"	6'-8"	1 3/8"	Α	•			MH	4	REUSE EXISTING DOOR. NEW FRAME.
5	CORRIDOR	PAIR 3'-0"	6'-8"	1 3/8"	Α	•			МН		EXISTING PAIR.
6	WALK-IN COOLER	3'-0"	6'-8"		С			•			BY COOLER MANUFACTURER
7	WALK-IN FREEZER	3'-0"	6'-8"		С			•			BY FREEZER MANUFACTURER
8	CONFERENCE	3'-0"	6'-8"	1 3/8"	Α	•			НМ		EXISTING DOOR AND FRAME

1. CONTRACTOR TO VERIFY EXISTING DOORS AND OPENINGS DIMENSIONS.

2. KEYING TO BE COORDINATED WITH OWNER.

HARDWARE	SET ONE	HARDWARE SET TWO	HARDWARE SET THREE	HARDWARE SET FOUR
3 HINGES		3 HINGES	3 HINGES	3 HINGES
LEVER HANDLE PRIVA	CY LOCKSET	LEVER HANDLE PASSAGE SET	LEVER HANDLE LOCKSET	LEVER HANDLE LOCKSET
CLOSER		KICKPLATE ON EXT.	KICKPLATE ON EXT.	CLOSER
KICKPLATE BOTH SIDE	S	SILENCERS	SILENCERS	KICKPLATE BOTH SIDES
SILENCERS				SILENCERS

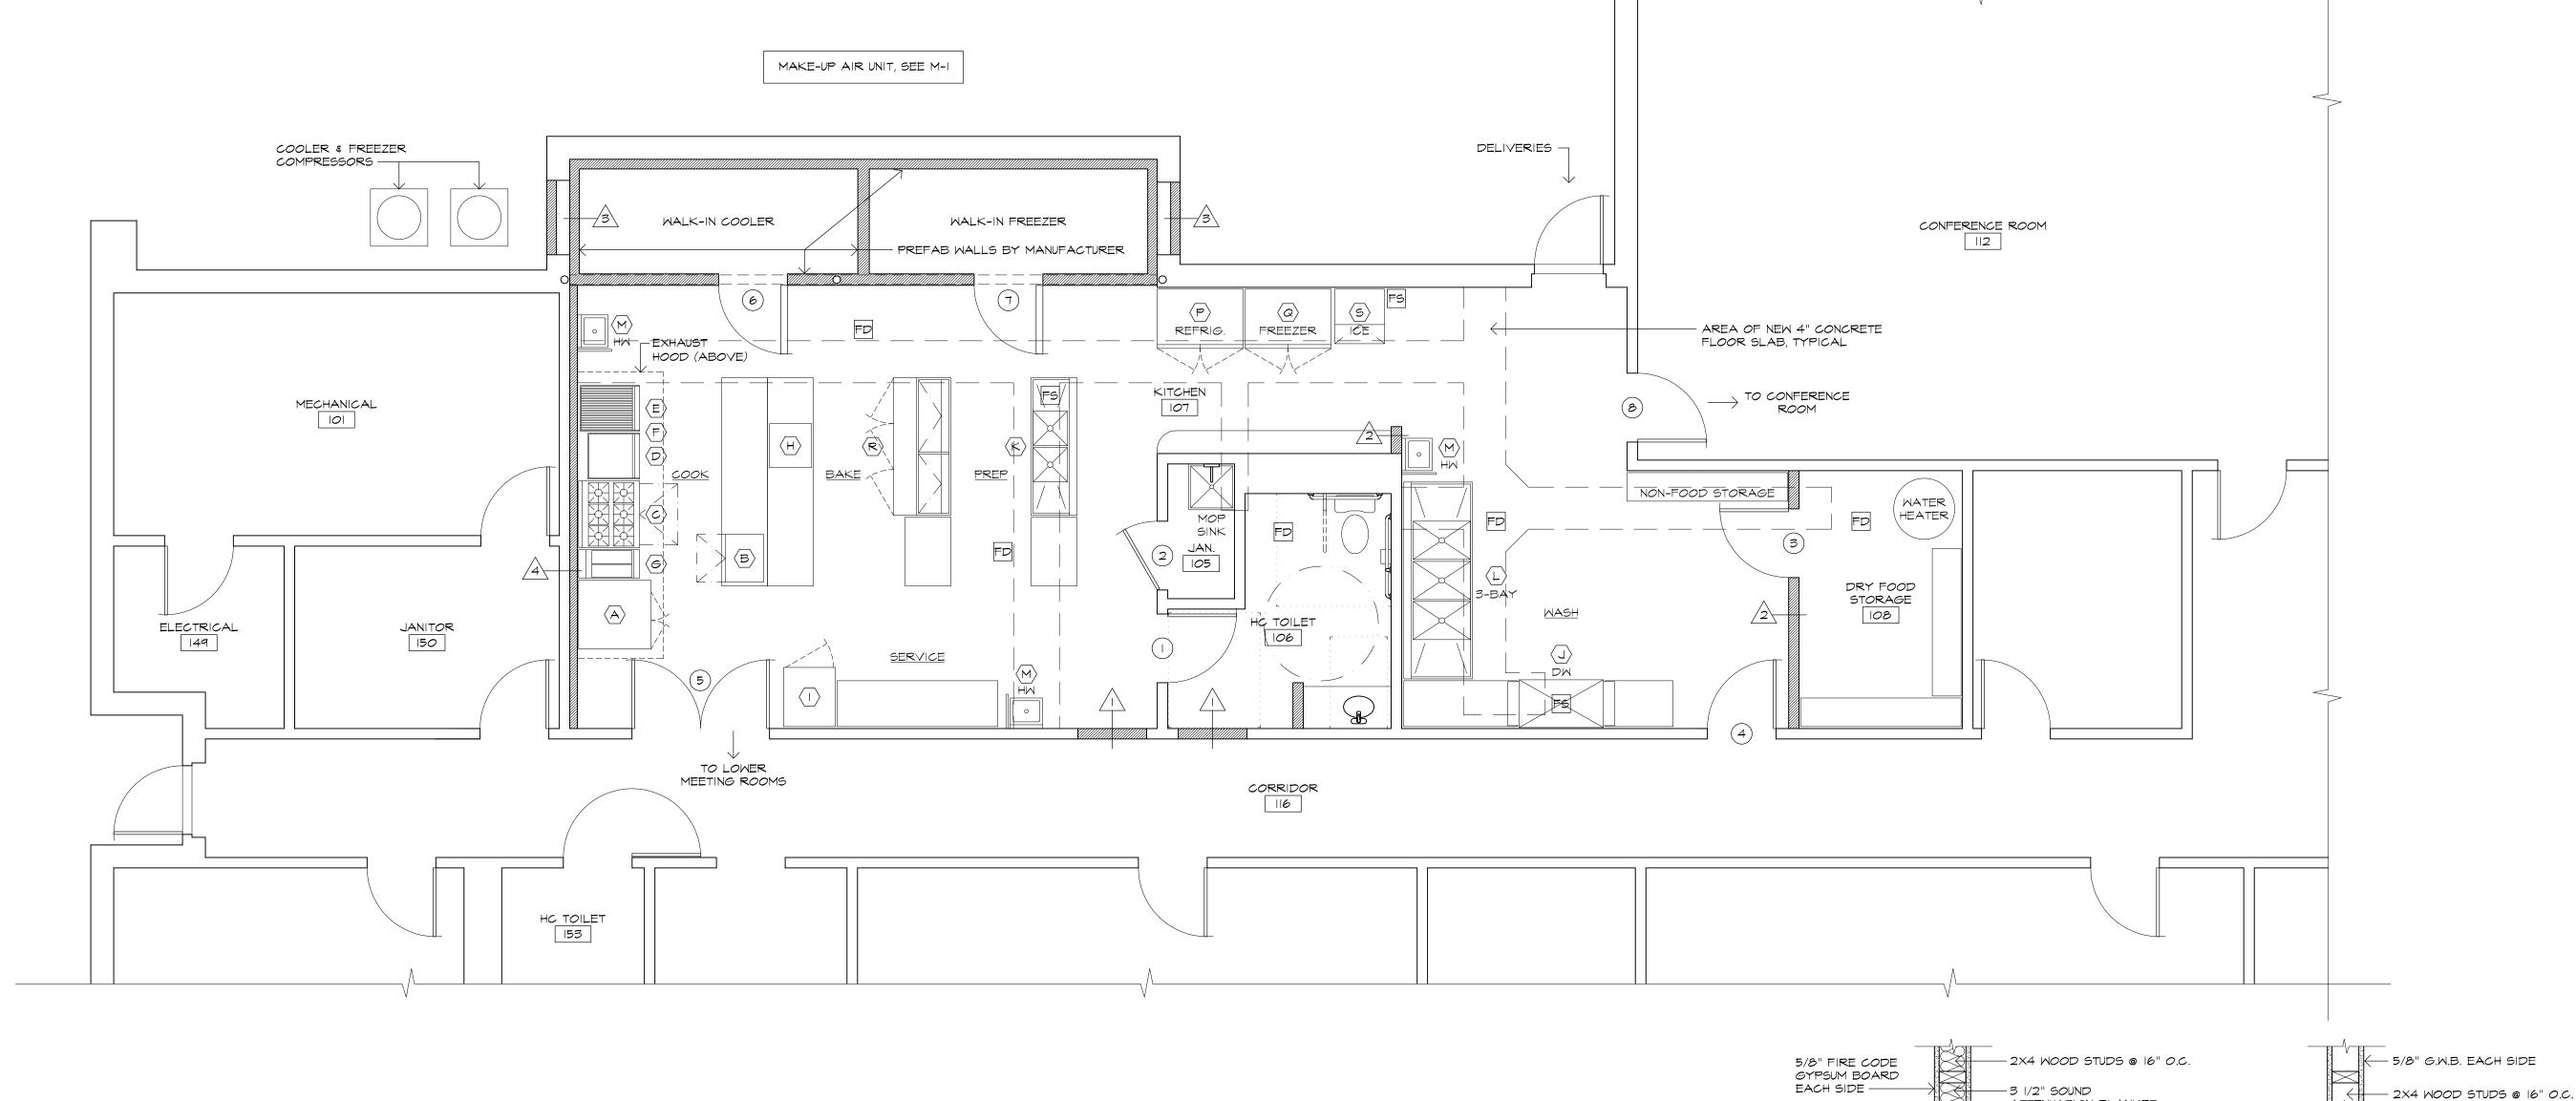



EXISTING WALL

EXISTING WALL TO BE REMOVED


EXISTING WALL TO BE REMOVE

MEW CONSTRUCTION

FD FIRE DETECTOR

FLOOR SINK



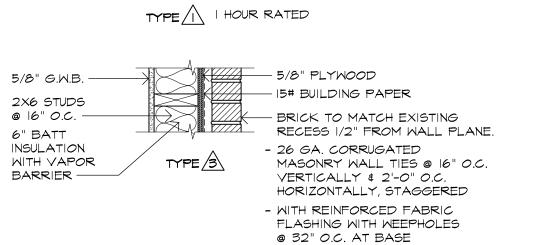

ATTENUATION BLANKET

COMBUSTIBLE WALL

NON- COMBUSTIBLE

PROTECTION

5/8" TILE BACKER BOARD

CERAMIC TILE

2 1/2" STEEL STUDS

5/8" GYPSUM WALL BOARD

TYPE 4

- NEW LIMITED

- EXIST. COMBUSTIBLE WALL

TYPE 2 TYPICAL

WALL TYPES (SEE FINISH SCHEDULE FOR WALL FINISHES)

EVELYN COLE SMITH ARCHITECTS, LLC

PO Box 182 134 Main St Putnam, CT 06260 860 315 9570

www.ecsarchitects.com

STAMP

RESERVED

PROJECT

Proposed Commercial Kitchen

EASTCONN
376 Hartford Turnpike

Prepared for

Hampton, CT 06247

EASTCONN
376 Hartford Turnpike

REVISIONS

Hampton, CT 06247

Date	Description

Construction Documents

SHEET TITLE

New Construction Plan

PROJ. NO. 2018048

SCALE AS NOTED

DATE June 26, 2019


DESIGNED LYN SMITH, AIA, LEED A

DRAWN CLINTON RICHMOND

SHEET

CHECKED ECS

A-2

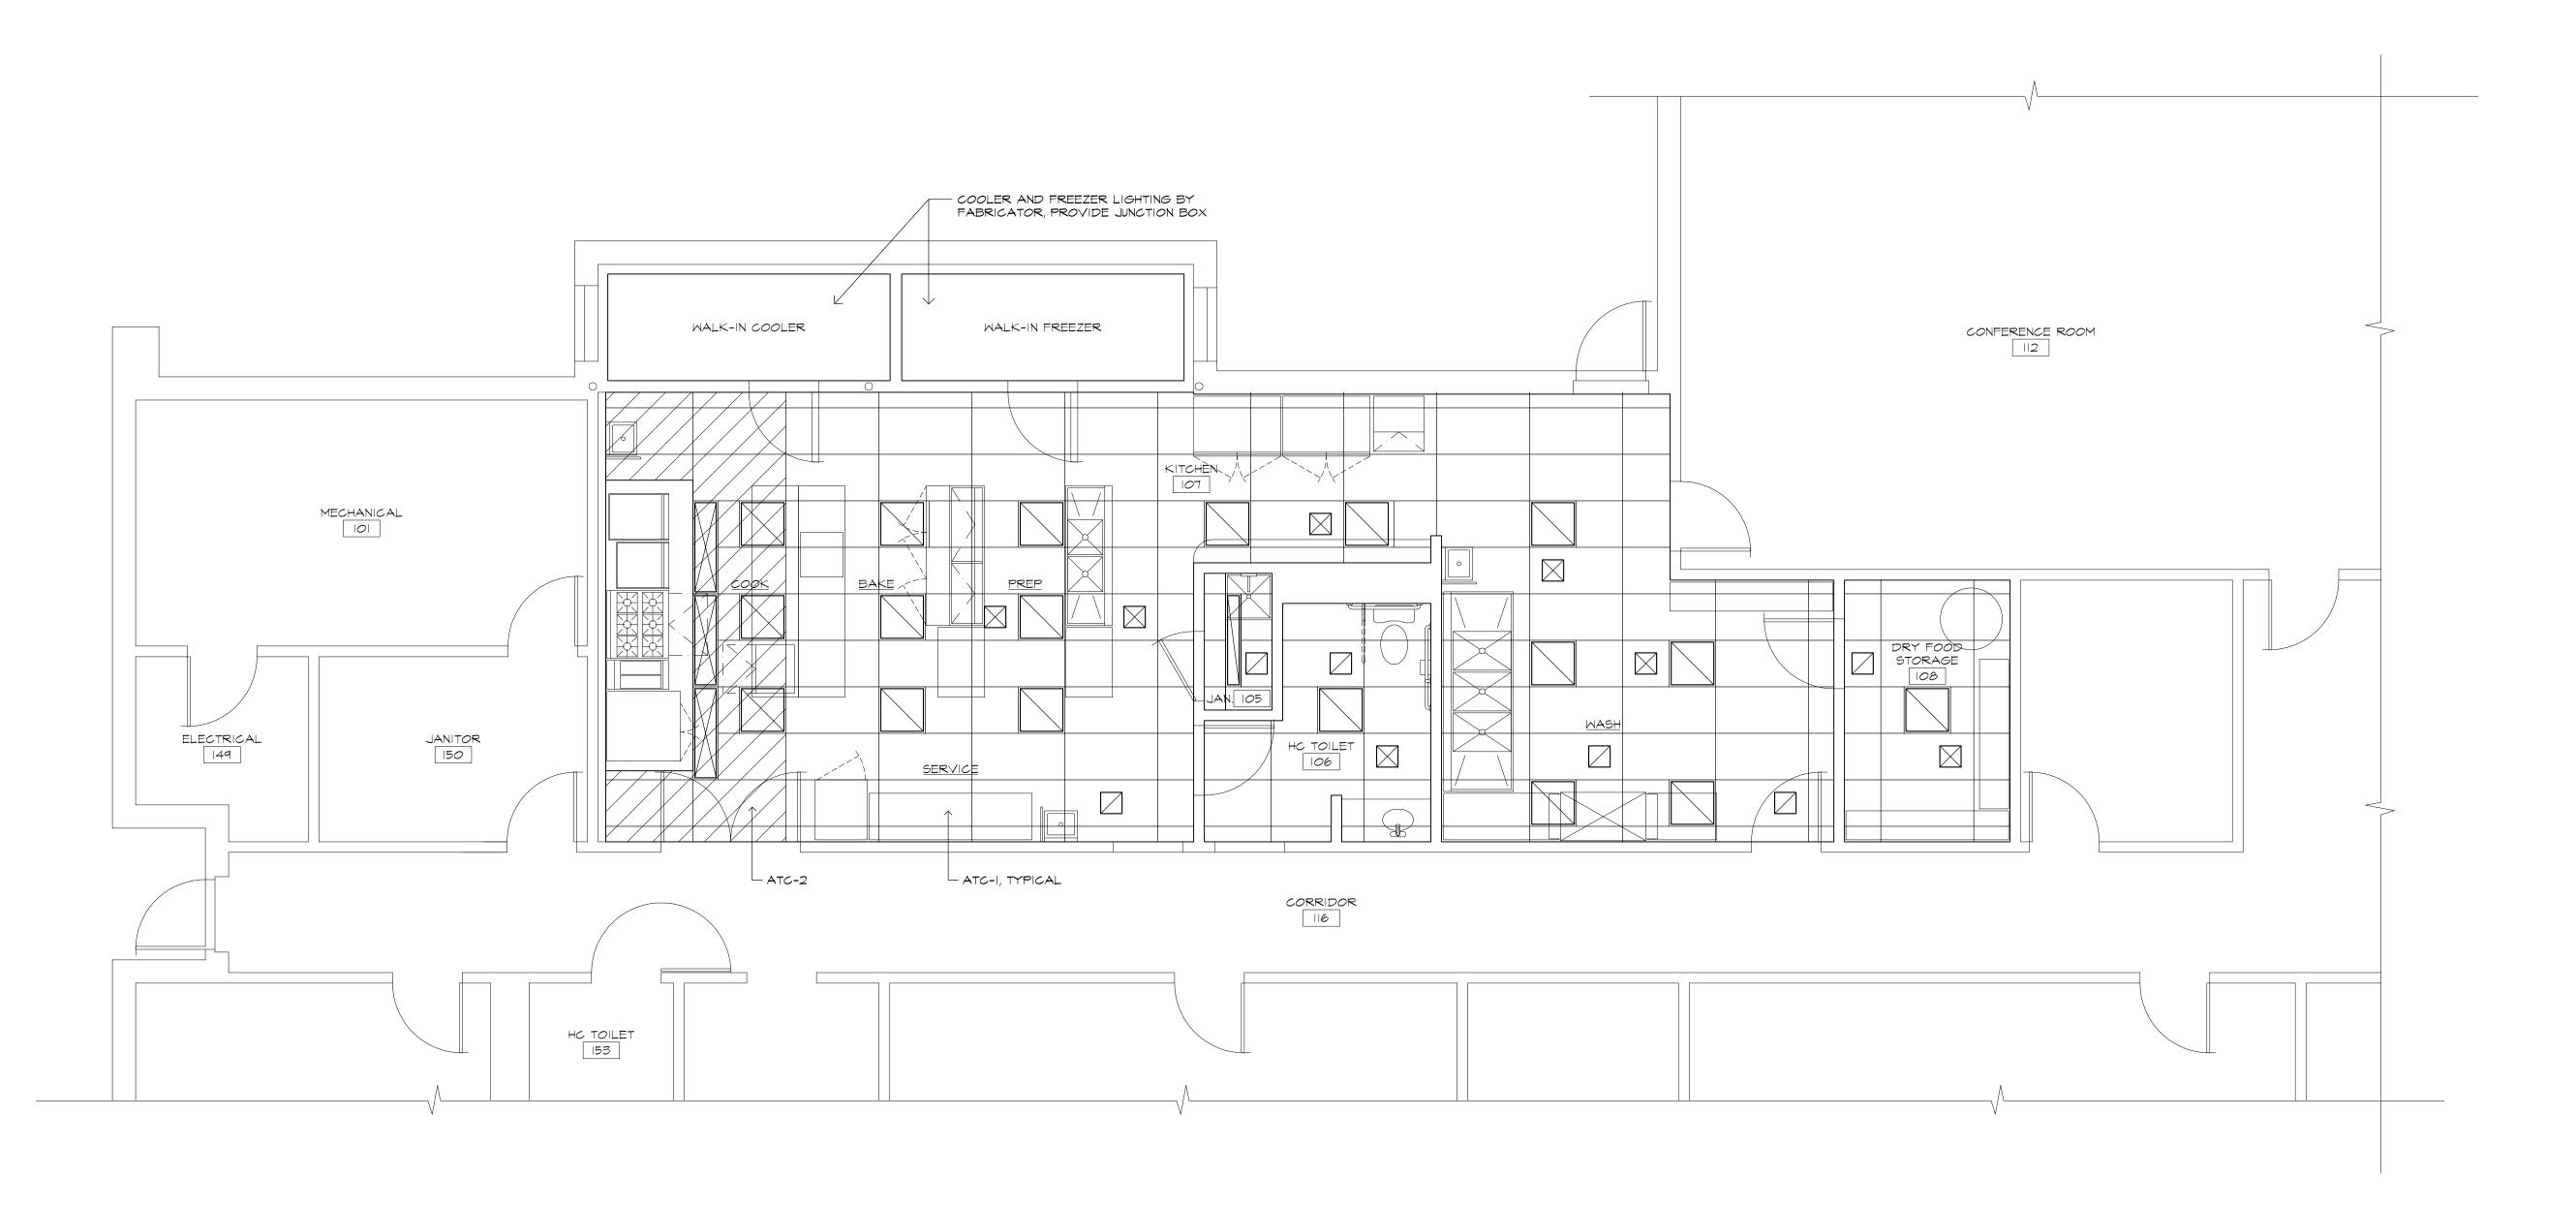






NOTES:

- I. NEW LAY-IN TILE CEILING HEIGHT TO BE AT 8'-O" A.F.F.
- 2. SEE ELECTRICAL PLANS FOR LIGHTING FIXTURE SCHEDULE.
- 3. SUPPLY AND RETURN AIR GRILLS TO BE CENTERED IN CEILING TILE. LOCATIONS SHOWN HERE ARE SCHEMATIC.

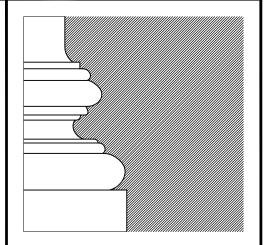

EVELYN COLE SMITH ARCHITECTS, LLC
PO Box 182
134 Main St
Putnam, CT

www.ecsarchitects.com

STAMP

06260 860 315 9570

RESERVED

PROJECT

Proposed Commercial Kitchen

EASTCONN 376 Hartford Turnpike Hampton, CT 06247

Prepared for

EASTCONN
376 Hartford Turnpike
Hampton, CT 06247

REVISIONS

	Date	Description

Construction Documents

SHEET TITLE

Reflected Ceiling / Lighting Plan

PROJ. NO. 2018048

SCALE AS NOTED


DATE June 26, 2019

DRAWN CLINTON RICHMOND


DESIGNED LYN SMITH, AIA, LEED A

CHECKED ECS


A-3

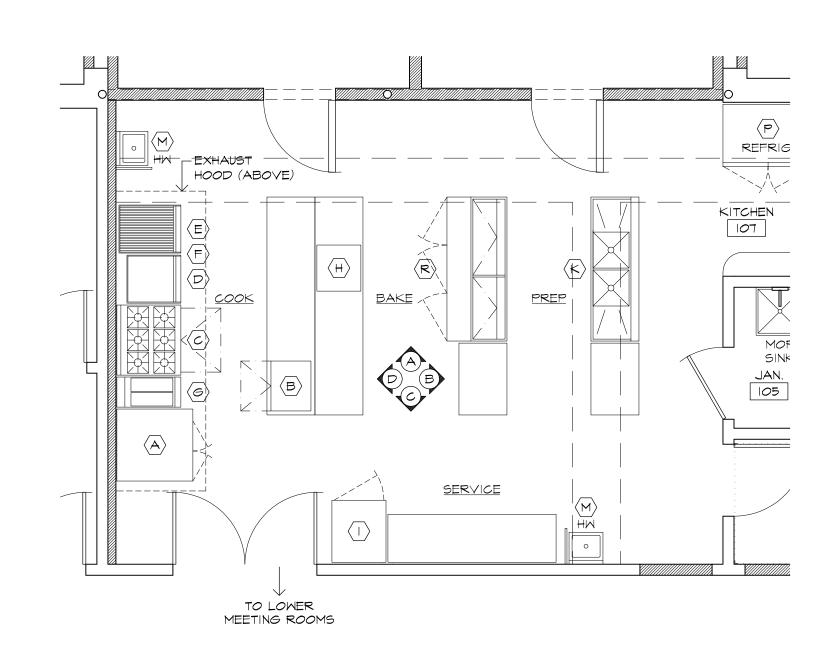





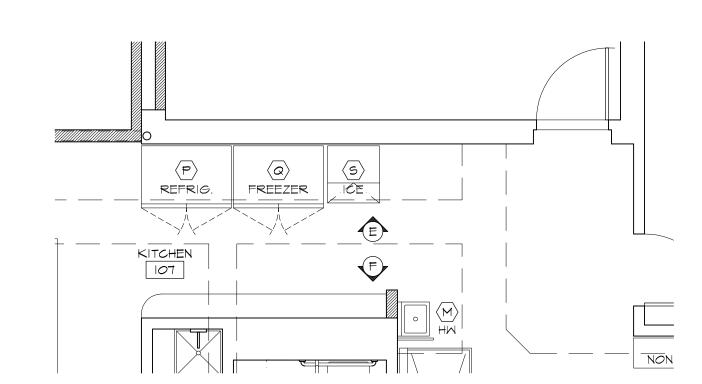





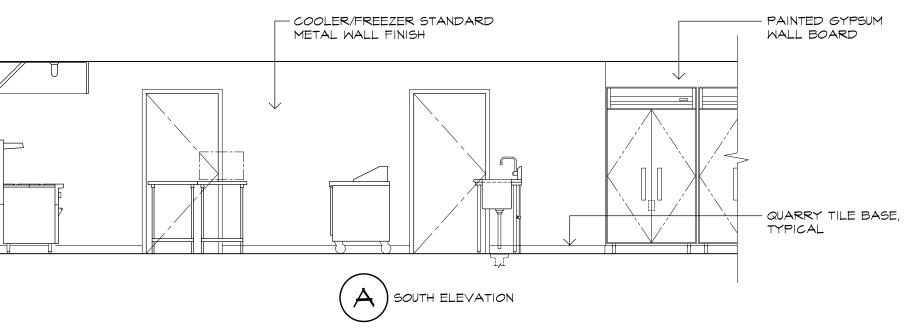

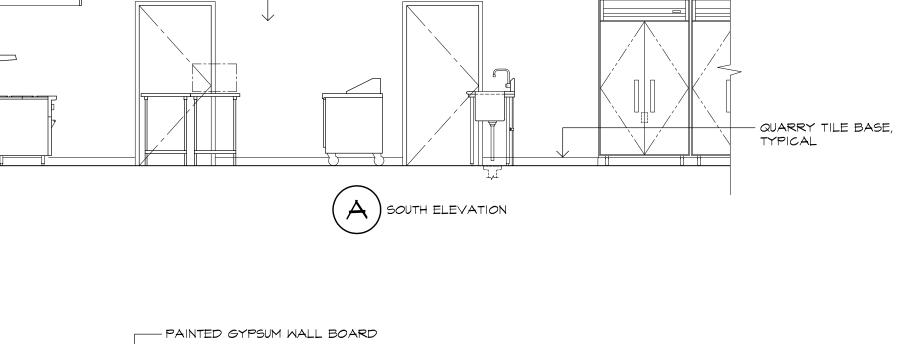

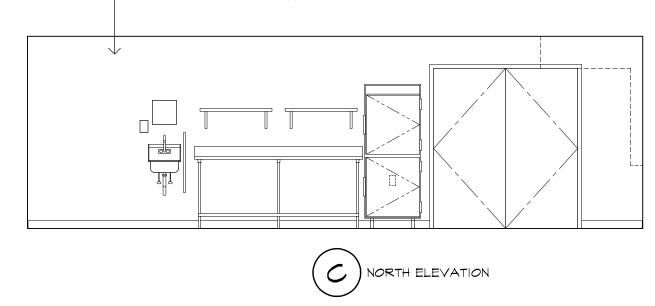


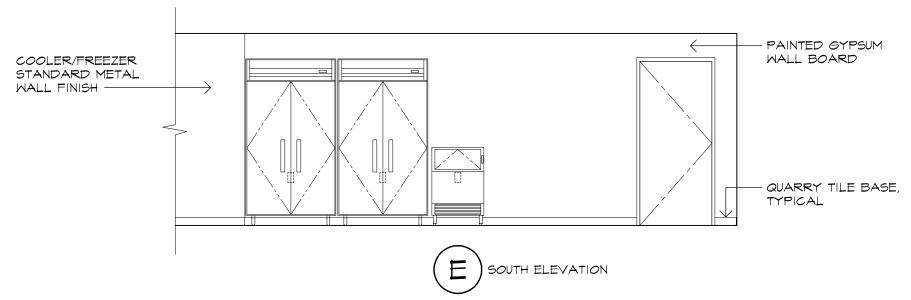


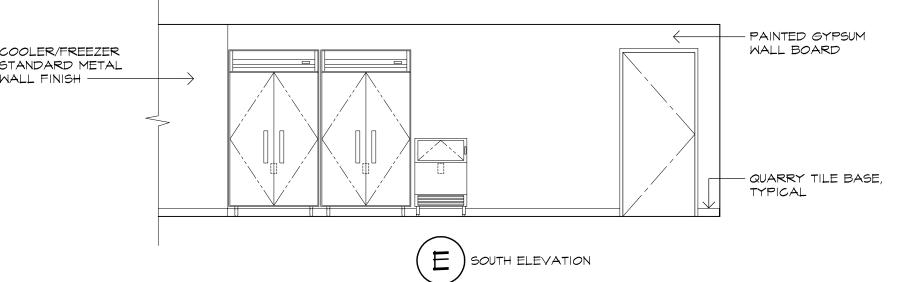



ROOM FINISH SCHEDULE										
Doors Norse	Floo	r	Walls			Ceiling	Door	Frame	Domonilia	
Room Name	Material	Base	North	East	South	West	Material	Stain	Paint	Remarks
Janitor	QT	QT	GWB	GWB	GWB	GWB	ACT	•	P-3	
Toilet	QT	QT	GWB/P-2	GWB/P-2	EX. CT	GWB/P-2	ACT	•	P-3	
Kitchen	QT	QT	GWB/P-2/FRP	CT-1/FRP	GWB/P-2	GWB-P-2	ACT	•	P-3	COOLER/FREEZER STANDARD FINISH
Dry Storage	QT	QT	GWB/P-2	GWB/P-2	GWB/P-2	GWB/P-2	ACT	•	P-3	
Notes: Materials listed are Basis of Design.										
QT: Quarry Tile. Met	tropolitan C	eramics	, Quarry Basics, (6 x 6 floor ti	le with matc	hing cove base	and prefab	ricated i	nside and	outside corners.
ACT: Acoustic Ceiling	g Tile. Armst	trong, K	itchen Zone, 24"	x 24" tiles v	vith Prelude	grid.				
GWB: Gypsum Wall										
FRP: Fiberglass Rein	forced Pane	l. Crane	Composites, Gla	asbord FX, p	ebbled finish	n with matching	g trim. White	e.		
CT-1: Ceramic Tile. A	American Ol	ean, Bri	ght, 6" x 6" with	bullnose to	o edge.					
EX. CT: Existing Ceramic Tile to remain										
P-1: Sherwin Williams, Ceiling white										
P-2: Sherwin Williams Epoxy, color to be determined										
P-3: Sherwin William	ns Gloss Ena	mel, col	or to be determ	ined						
Notos										·

- 1. All equipment listed above will be purchased and installed by the owner.
- 2. Contractor to coordinate size and location of required hookups.

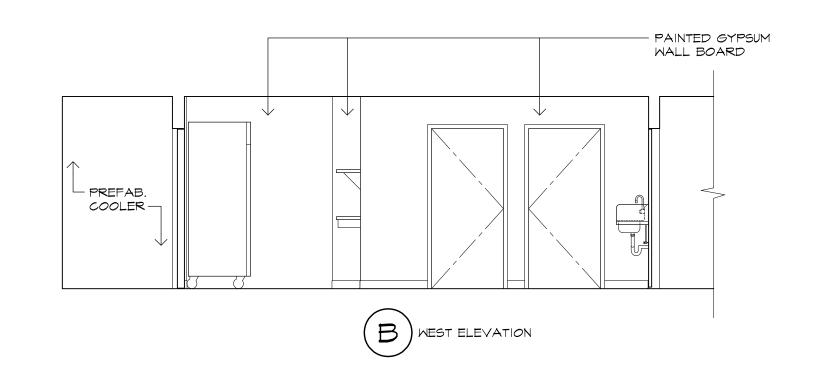

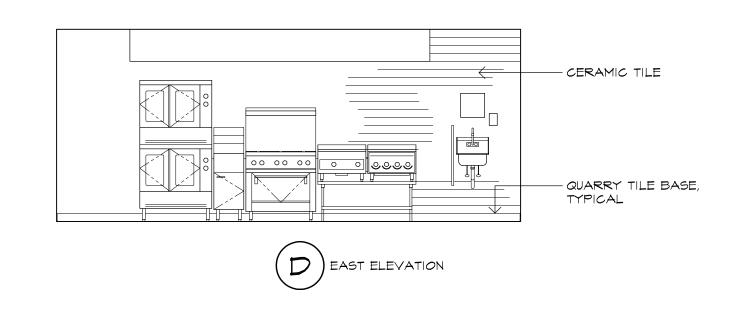

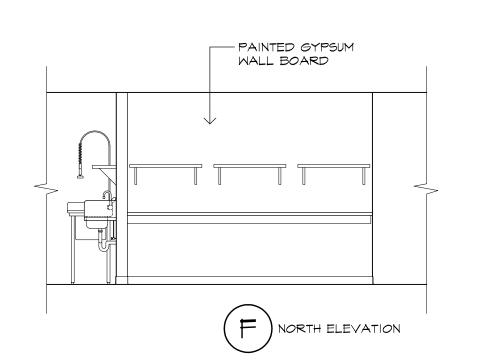

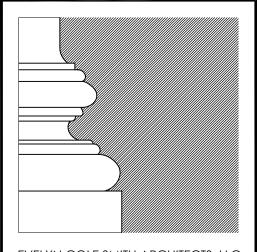

EVELYN COLE SMITH ARCHITECTS, LLC PO Box 182 134 Main St Putnam, CT

06260 860 315 9570

www.ecsarchitects.com

STAMP

RESERVED

PROJECT

Proposed Commercial Kitchen

EASTCONN

376 Hartford Turnpike Hampton, CT 06247

Prepared for

EASTCONN 376 Hartford Turnpike Hampton, CT 06247

REVISIONS

Date	Description

Construction Documents

SHEET TITLE


Enlarged Plans & **Interior Elevations**

PROJ. NO. 2018048 SCALE AS NOTED DATE June 26, 2019 DESIGNED LYN SMITH, AIA, LEED A


DRAWN CLINTON RICHMOND


CHECKED ECS




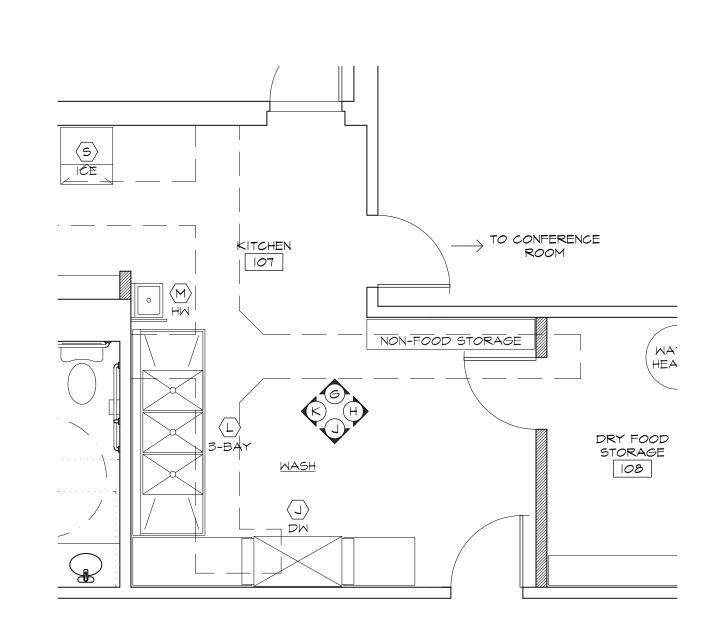




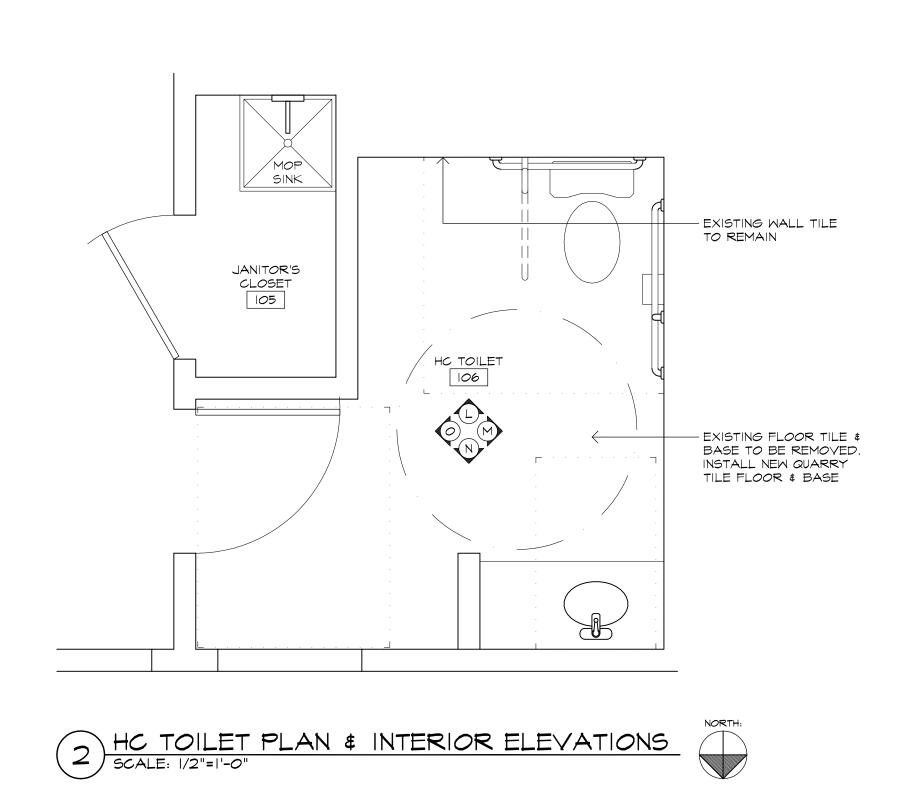

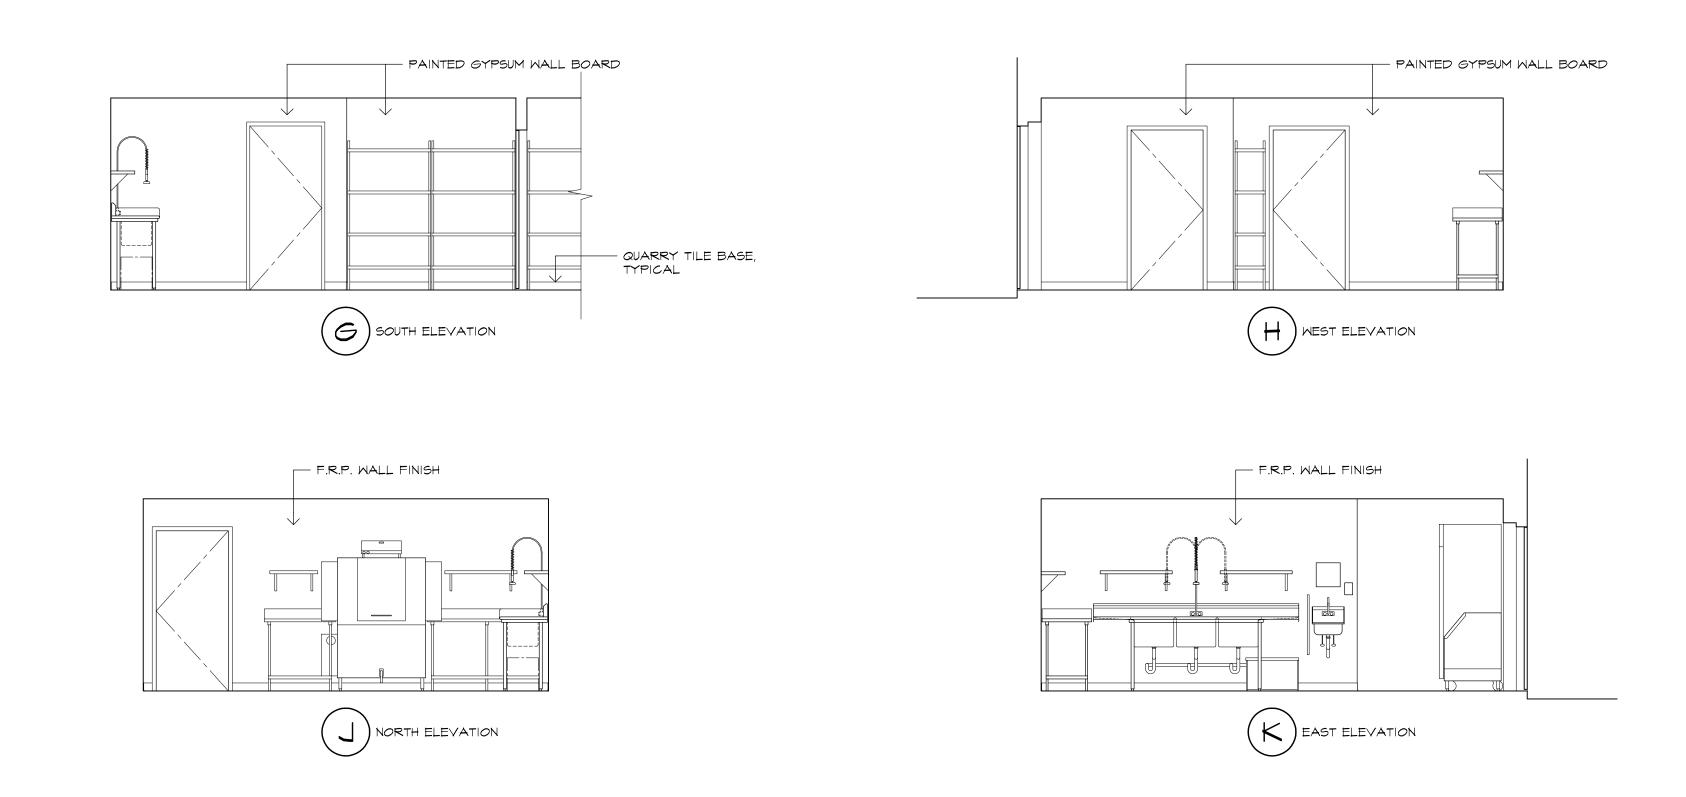

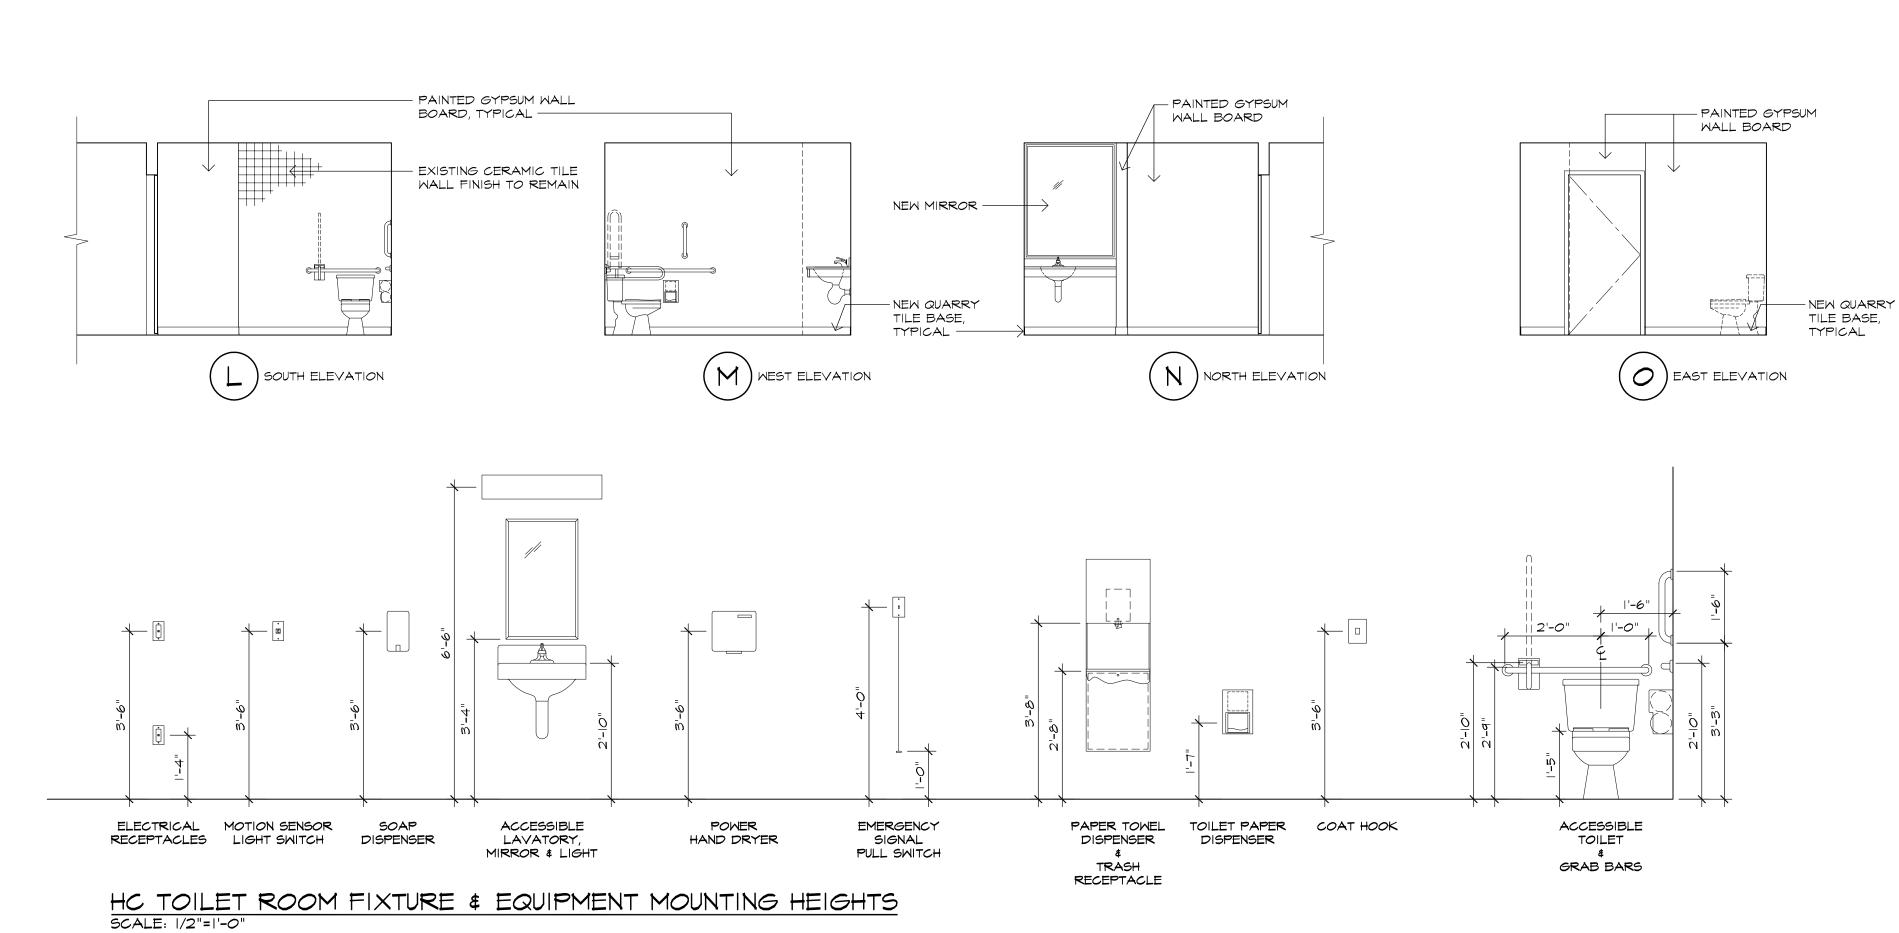

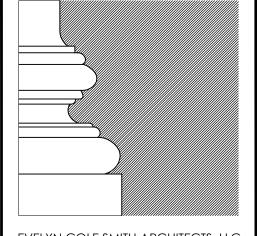

EVELYN COLE SMITH ARCHITECTS, LLC
PO Box 182
134 Main St
Putnam, CT
06260

860 315 9570

www.ecsarchitects.com

STAMP

RESERVED

PROJECT

Proposed Commercial Kitchen

EASTCONN

376 Hartford Turnpike Hampton, CT 06247

Prepared for

EASTCONN 376 Hartford Turnpike

Hampton, CT 06247

REVISIONS				
	Date	Description		
SHEET TITLE				

Construction Documents

Enlarged Plans & Interior Elevations

PROJ. NO. 2018048

SCALE AS NOTED

DATE June 26, 2019


DESIGNED LYN SMITH, AIA, LEED A

DRAWN CLINTON RICHMOND

SHEET

CHECKED ECS

A - 5

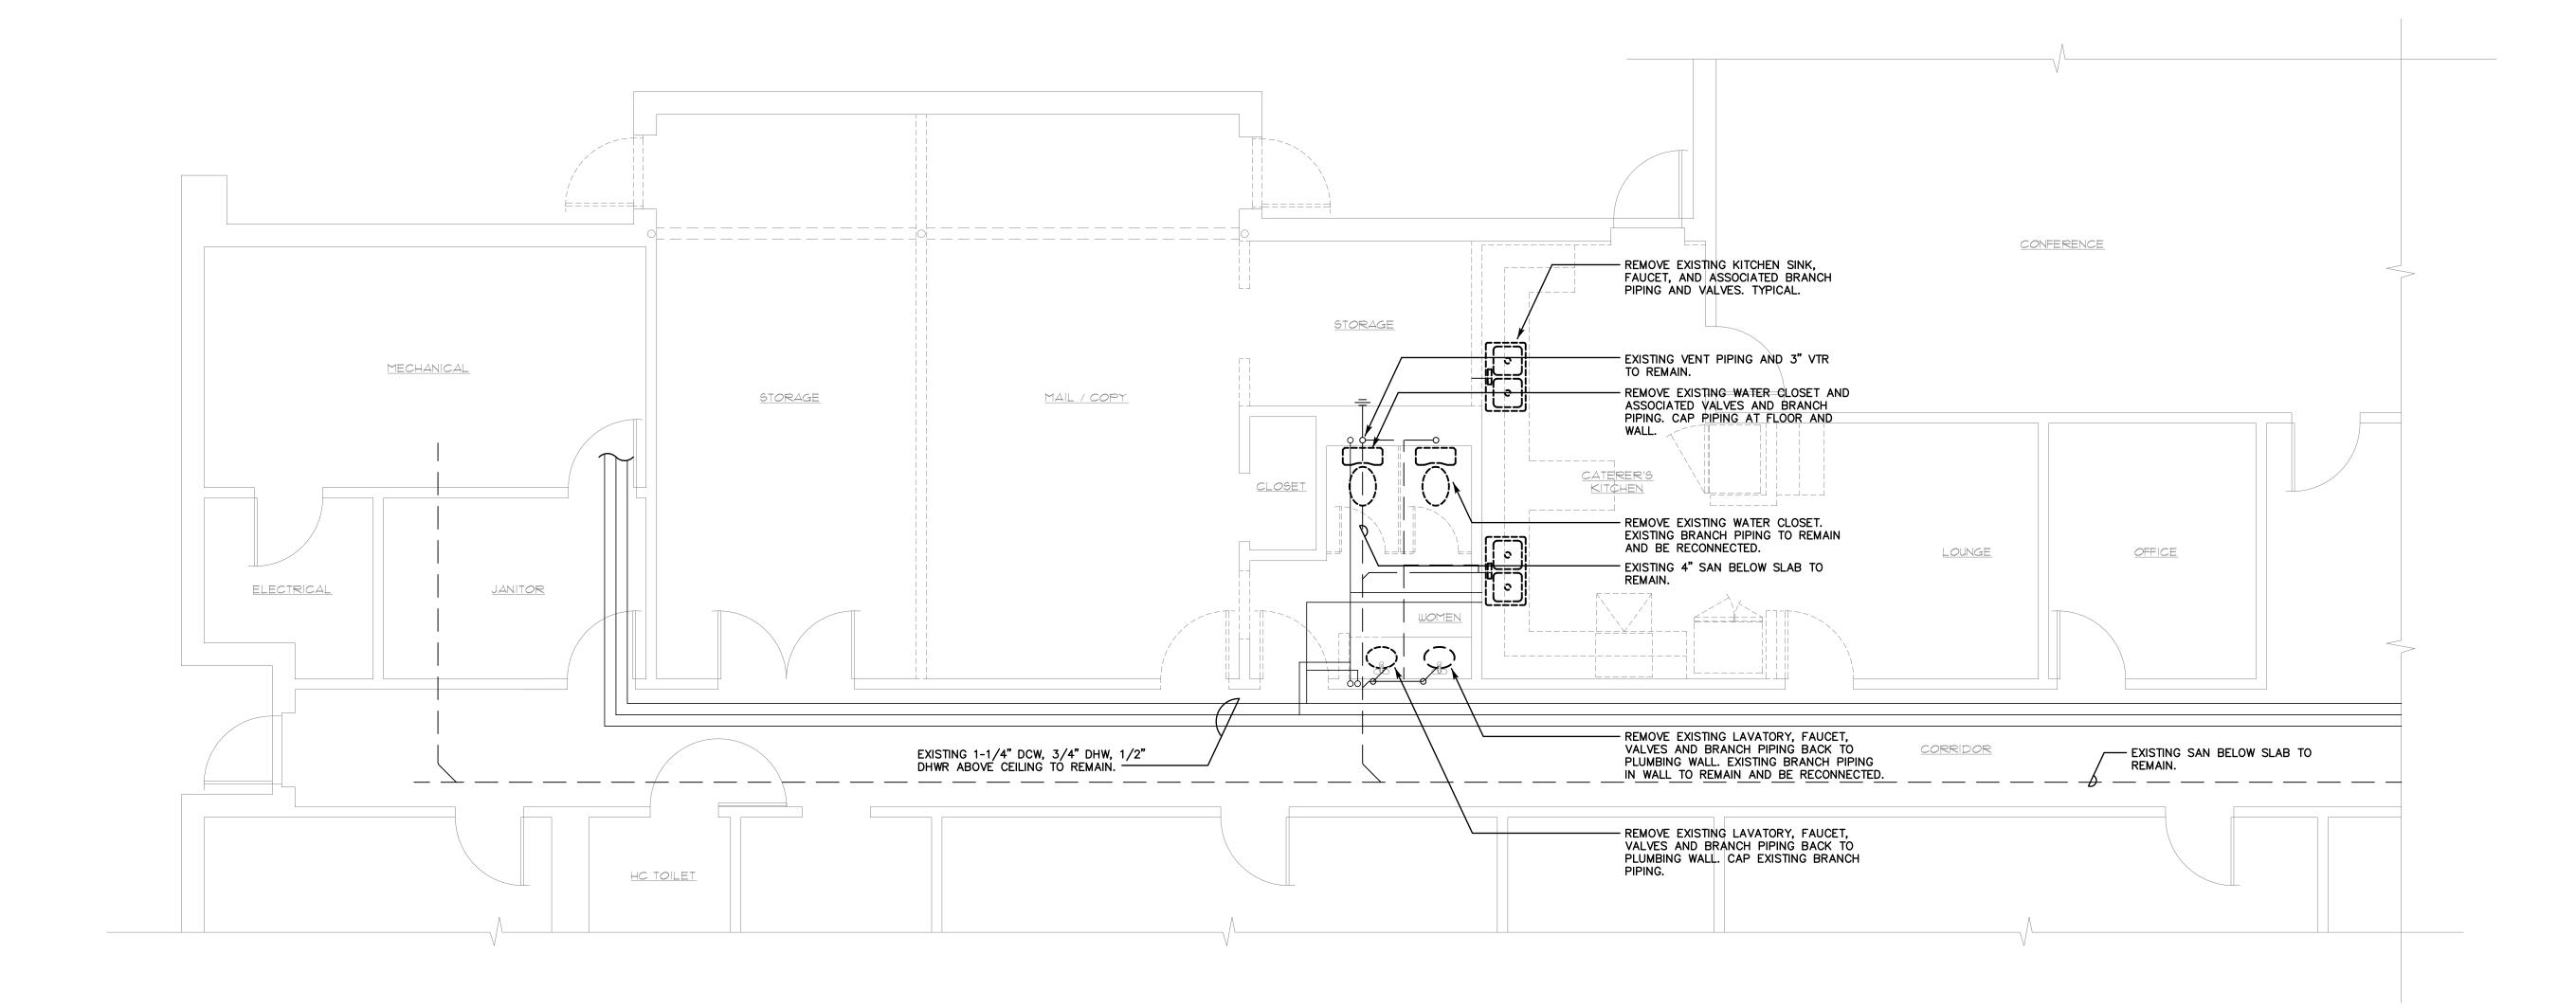

FIRST FLOOR PLUMBING DEMOLITION PLAN SCALE: 1/4"=1'-0"




EXISTING CONDITIONS NOTE:

THE CONTRACTOR(S) SHALL VISIT THE SITE PRIOR TO BIDDING, NOTING EXISTING CONDITIONS AND EQUIPMENT. IF SAID EQUIPMENT IS NOT BEING REMOVED AS PART OF THE PROJECT OR IS NOTED AS EXISTING TO REMAIN AND IMPEDES PROVIDING PROPOSED EQUIPMENT AND OR PROVIDING PROPOSED SCOPE OF WORK, EQUIPMENT SHALL BE TEMPORARILY RELOCATED AND COMPLETELY REINSTALLED AFTER PROPOSED SCOPE OF WORK IS COMPLETED. THIS SHALL BE PART OF THE BASE BID AND CONTRACTOR(S) SHALL BID ACCORDINGLY, NO ADDITIONAL COMPENSATION WILL BE CONSIDERED FOR RELATED WORK OR COORDINATION WITH EXISTING CONDITIONS.

PLUMBING DEMOLITION NOTES:

- 1. THE CONTRACTOR SHALL VISIT THE PROJECT SITE PRIOR TO BIDDING AND BECOME INFORMED AS TO THE NATURE AND SCOPE OF WORK REQUIRED, NOTING AND ACCOUNTING FOR EXISTING CONDITIONS. TYPICAL.
- 2. PROPERLY DISPOSE OF ALL DEMOLITION DEBRIS AS REQUIRED BY FEDERAL, STATE AND LOCAL CODES AND ORDINANCES.
- 3. ALL DEMOLITION WORK SHALL BE PERFORMED IN A SAFE AND ORDERLY MANNER WITH QUALIFIED AND LICENSED PERSONNEL IN ACCORDANCE WITH STATE AND LOCAL GOVERNING AUTHORITIES AND ALL APPLICABLE CODES AND STANDARDS. TYPICAL.
- 4. ALL SERVICE DISRUPTIONS MUST BE SCHEDULED A MINIMUM OF 72 HOURS IN ADVANCE WITH THE OWNER'S REPRESENTATIVE.
- DO NOT DAMAGE EXISTING EQUIPMENT AND/OR SYSTEMS NOT BEING REMOVED. THE CONTRACTOR SHALL BE RESPONSIBLE FOR ANY DAMAGE TO EXISTING EQUIPMENT AND/OR SYSTEMS NOT BEING REMOVED.

 6. BUILDING WILL BE OCCUPIED DURING ALL PHASES OF
- 6. BUILDING WILL BE OCCUPIED DURING ALL PHASES OF CONSTRUCTION. CONTAIN AND CONTROL CONSTRUCTION DEBRIS SO AS NOT TO INTERFERE WITH DAILY OPERATION OF BUILDING. KEEP EGRESS PATHS FREE FOR DAILY OPERATION OF BUILDING.
- 7. DURING THE PHASING OF CONSTRUCTION ALL EXISTING SYSTEMS SERVING OCCUPIED AREAS ARE TO BE MAINTAINED IN USE. CONTRACTOR IS TO REPIPE AND/OR REVALVE SO AS TO ENSURE CONTINUED OPERATION IN THESE OCCUPIED AREAS.
- DRAWINGS ARE DIAGRAMMATIC. CONTRACTOR SHALL FIELD VERIFY ALL EXISTING CONDITIONS INCLUDED IN AND RELATED TO THE PROJECT SCOPE OF WORK. TYPICAL.

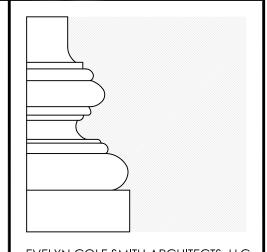

EVELYN COLE SMITH ARCHITECTS, LLC PO Box 182 134 Main St Putnam, CT 06260

www.ecsarchitects.com

860 315 9570

STAMP

CONSULTAN

SALAMONE & ASSOCIATES, P.C.

CONSULTING ENGINEERS

116 North Plains Industrial Road
Wallingford, Connecticut 06492
Phone: (203) 281-6895 Fax: (203) 287-8728

PROJECT

Proposed Commercial Kitchen

EASTCONN 376 Hartford Turnpike Hampton, CT 06247

Prepared for

EASTCONN 376 Hartford Turnpike Hampton, CT 06247

REVISI

	KI	EVISIONS
	Date	Description
	SHI	EET TITLE

First Floor Plumbing Demolition Plan

PROJ. NO. 2018048

SCALE AS NOTED

DATE APRIL, 2019


DESIGNED SJS

DRAWN SJS

CHECKED JAS

SHEET


DP-1

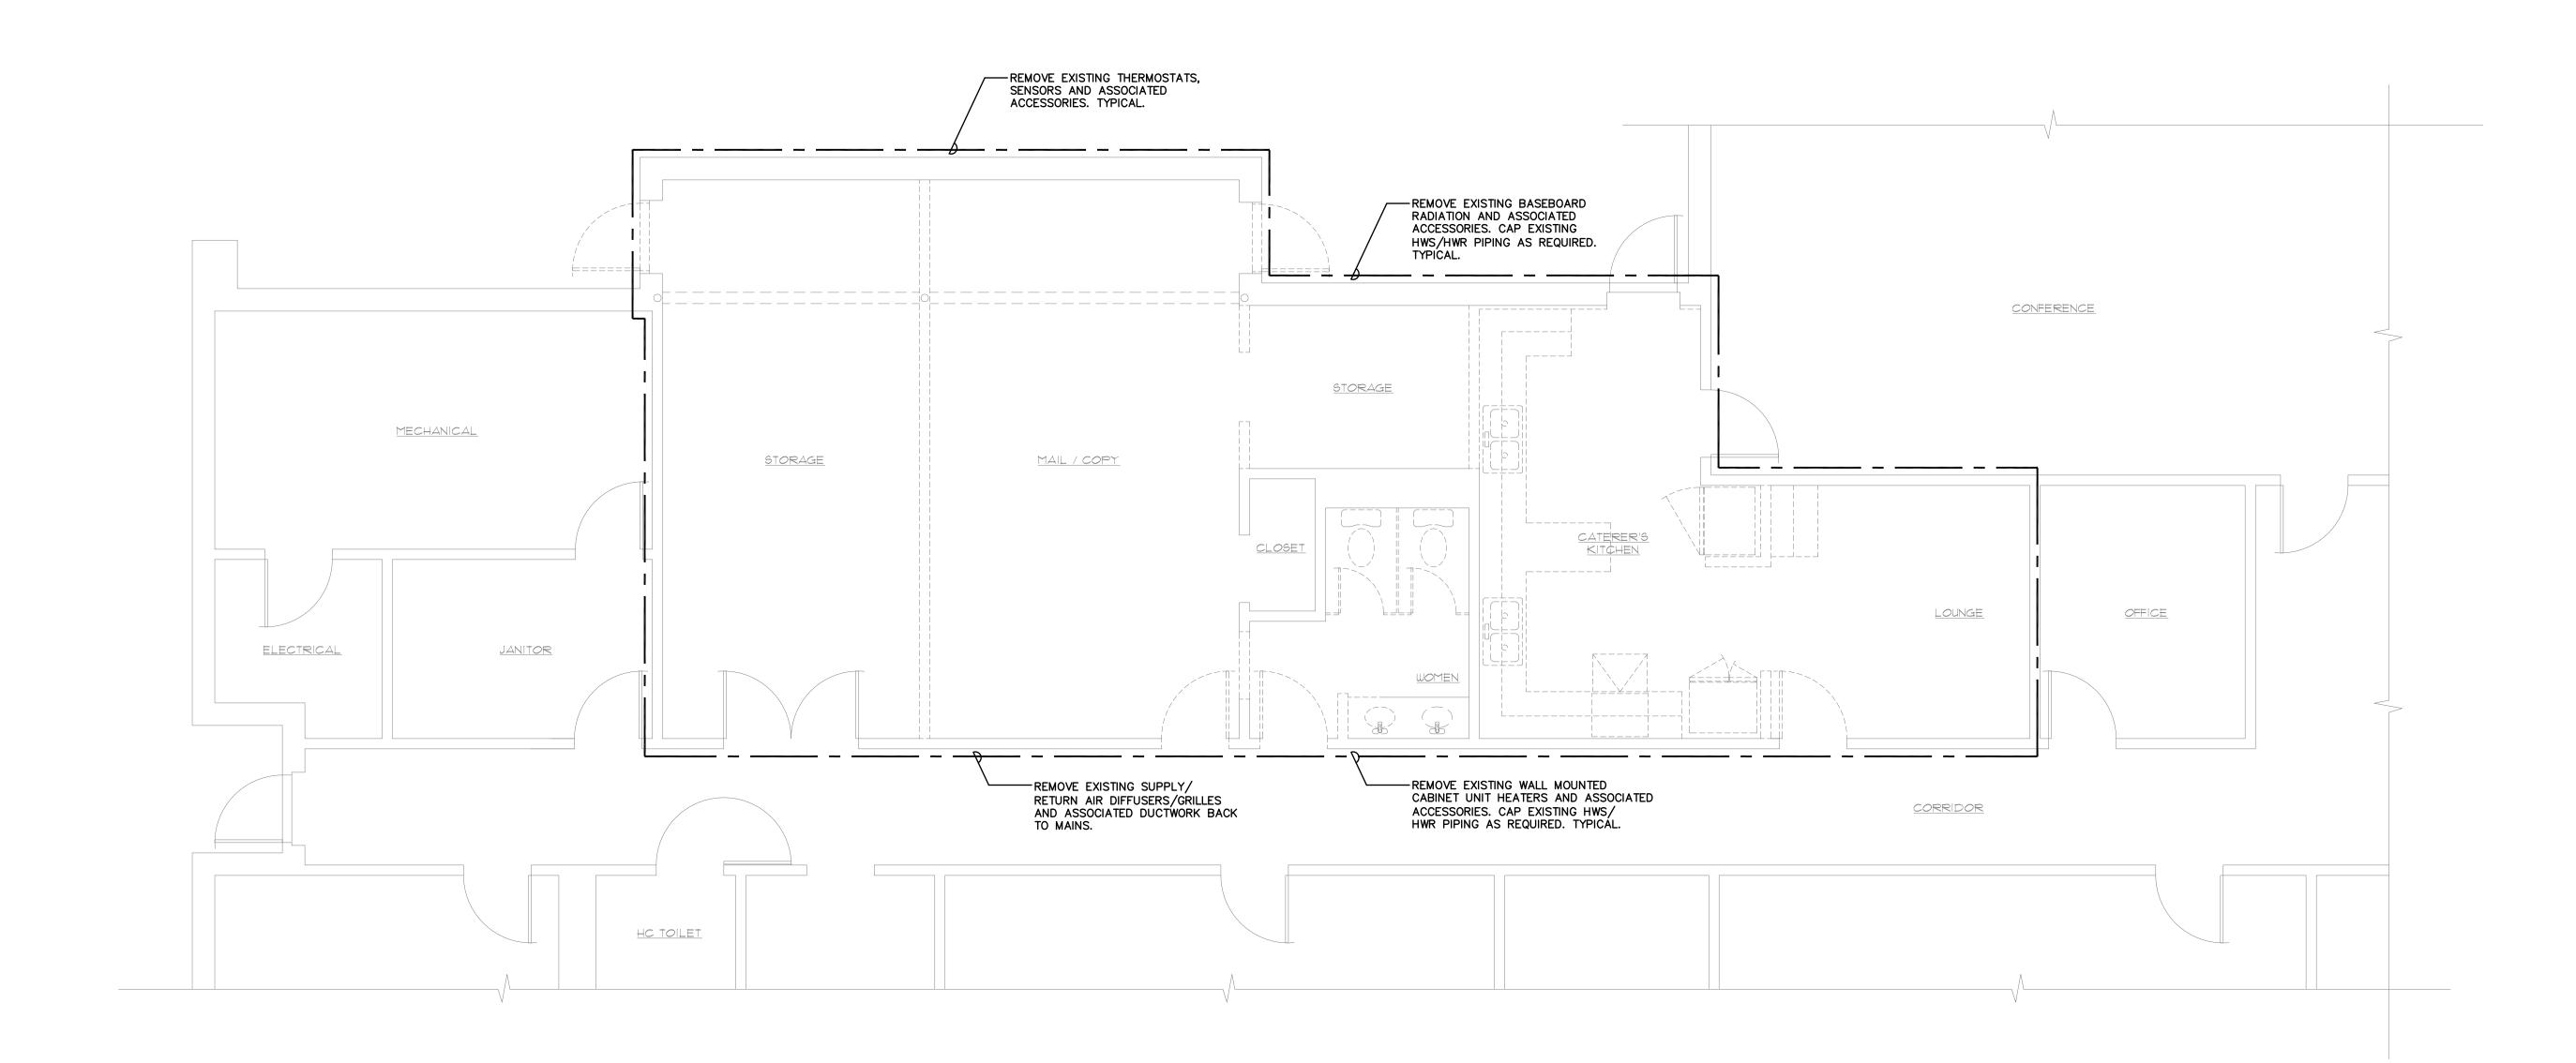

FIRST FLOOR MECHANICAL DEMOLITION PLAN

SCALE: 1/4"=1'-0"



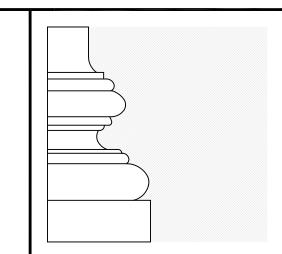

EVELYN COLE SMITH ARCHITECTS, LLC PO Box 182 134 Main St Putnam, CT 06260

www.ecsarchitects.com

860 315 9570

STAMP

SALAMONE ASSOCIATES, P.C.

CONSULTING ENGINEERS 116 North Plains Industrial Road Wallingford, Connecticut 06492 one: (203) 281-6895 Fax: (203) 287-8728

Proposed Commercial Kitchen

EASTCONN 376 Hartford Turnpike Hampton, CT 06247

Prepared for

EASTCONN 376 Hartford Turnpike Hampton, CT 06247

REVISIONS

	Date	Description		
SHEET TITLE				

First Floor Mechanical **Demolition Plan**

MECHANICAL DEMOLITION NOTES:

1. THE CONTRACTOR(S) SHALL VISIT THE SITE PRIOR TO BIDDING, NOTING EXISTING CONDITIONS AND EQUIPMENT. IF SAID EQUIPMENT IS NOT BEING REMOVED AS PART OF THE PROJECT OR IS NOTED AS EXISTING TO REMAIN AND IMPEDES PROVIDING PROPOSED EQUIPMENT AND OR PROVIDING PROPOSED SCOPE OF WORK, EQUIPMENT SHALL BE TEMPORARILY RELOCATED AND COMPLETELY REINSTALLED AFTER PROPOSED SCOPE OF WORK IS COMPLETED. THIS SHALL BE PART OF THE BASE BID AND CONTRACTOR(S) SHALL BID ACCORDINGLY, NO ADDITIONAL COMPENSATION WILL BE CONSIDERED FOR RELATED WORK OR COORDINATION WITH EXISTING CONDITIONS.

REMOVE AND PROPERLY DISPOSE OF EQUIPMENT AND ASSOCIATED COMPONENTS/ACCESSORIES AS INDICATED ON DEMOLITION PLANS. PROPERLY DISPOSE OF ALL DEMOLITION DEBRIS AS REQUIRED BY FEDERAL, STATE AND LOCAL CODES AND ORDINANCES. TYPICAL.

- 3. ALL DEMOLITION WORK SHALL BE PERFORMED IN A SAFE AND ORDERLY MANNER WITH QUALIFIED AND LICENSED PERSONNEL IN ACCORDANCE WITH STATE AND LOCAL GOVERNING AUTHORITIES AND ALL APPLICABLE CODES AND STANDARDS. COORDINATE WORK WITH ALL PROJECT DISCIPLINES AND EXISTING CONDITIONS. TYPICAL.
- 4. DRAWINGS ARE DIAGRAMMATIC. CONTRACTOR SHALL FIELD VERIFY ALL EXISTING CONDITIONS INCLUDED IN AND RELATED TO THE PROJECT SCOPE OF WORK. TYPICAL.
- 5. DO NOT DISTURB ANY SUSPECTED HAZARDOUS MATERIALS. NOTIFY OWNERS REPRESENTATIVE OF ANY SUSPECTED MATERIALS IMPEDING PERFORMANCE OF WORK. TYPICAL.


PROJ. NO. 2018048 SCALE AS NOTED

DATE APRIL, 2019

DESIGNED ST DRAWN ST

CHECKED JAS SHEET

DM-1

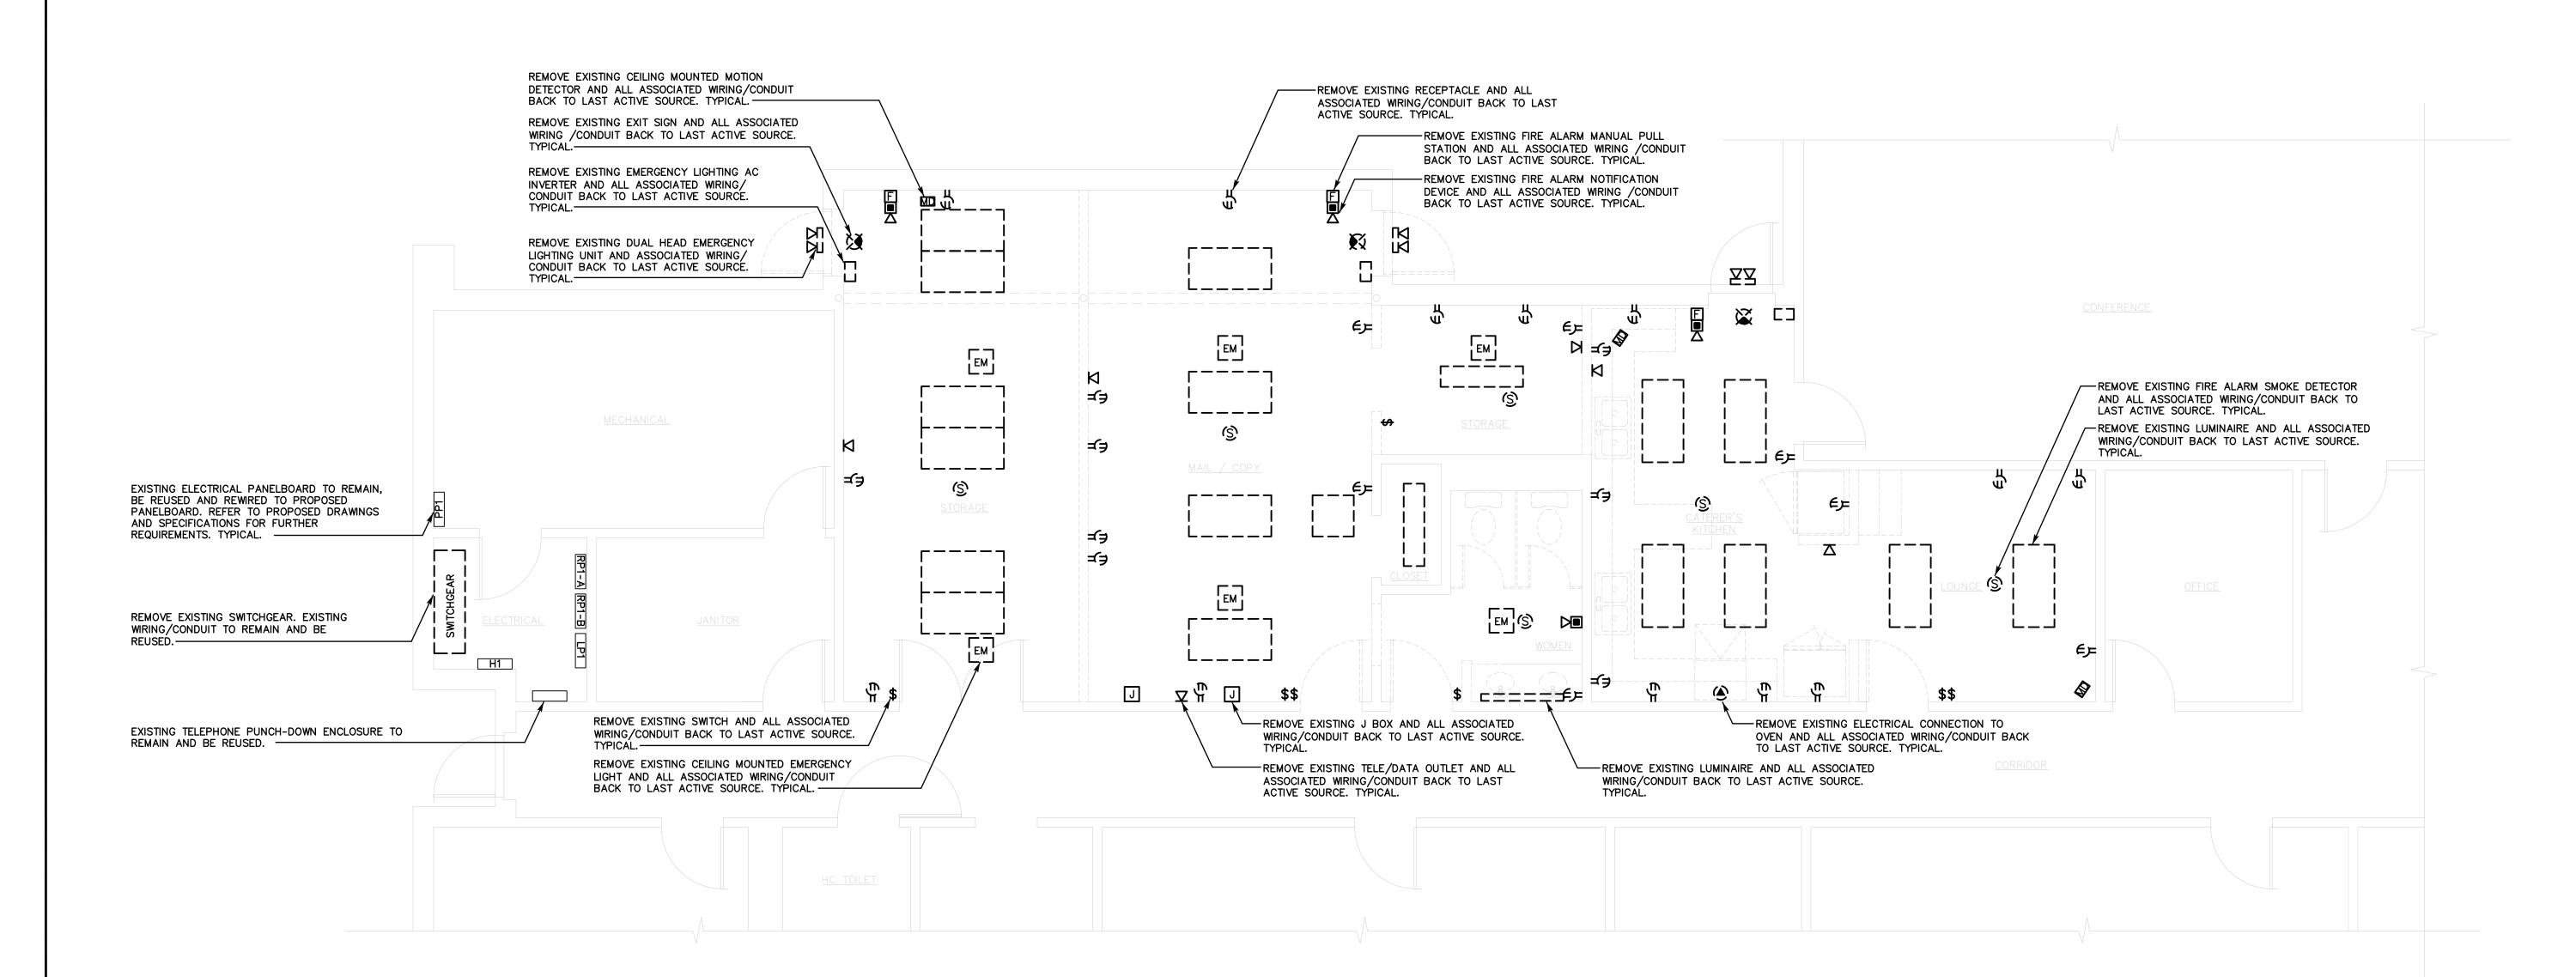

FIRST FLOOR ELECTRICAL DEMOLITION PLAN

SCALE: 1/4"=1'-0"



NOTE:

THE CONTRACTOR(S) SHALL VISIT THE PROJECT SITE PRIOR TO BIDDING,

NOTING EXISTING CONDITIONS AND EQUIPMENT. IF SAID EQUIPMENT IS

NOT BEING REMOVED AS PART OF PROJECT OR IS NOTED AS EXISTING

TO REMAIN AND IMPEDES PROVIDING PROPOSED EQUIPMENT AND/OR

PROPOSED SCOPE OF WORK IS COMPLETED. THIS SHALL BE PART OF

BASE BID AND CONTRACTOR'S SHALL BID ACCORDINGLY, NO ADDITIONAL

PROVIDING PROPOSED SCOPE OF WORK. EQUIPMENT SHALL BE


TEMPORARY RELOCATED AND COMPLETELY REINSTALLED AFTER

COMPENSATION WILL BE CONSIDERED FOR RELATED WORK OR

COORDINATION WITH EXISTING CONDITIONS.

ELECTRICAL DEMOLITION NOTES:

- 1. PRIOR TO BID THE CONTRACTOR SHALL VISIT SITE TO DETERMINE EXTENT OF DEMOLITION. ALL EXISTING ELECTRICAL EQUIPMENT, WIRING AND CONDUIT LOCATIONS AND SIZES SHOWN ARE APPROXIMATE. DEMOLITION DRAWINGS DO NOT SHOW ALL EXISTING ELECTRICAL EQUIPMENT, CONDUIT AND WIRING WHICH REQUIRE REMOVAL. CONTRACTOR SHALL FIELD
- 2. DRAWINGS ARE DIAGRAMMATIC. CONTRACTOR SHALL FIELD VERIFY ALL LOCATIONS, QUANTITIES AND DIMENSIONS OF EXISTING MATERIALS, FIXTURES AND/OR EQUIPMENT WITHIN AND AFFECTING PROJECT SCOPE OF WORK.
- 3. REMOVE ALL EQUIPMENT, WIRING, CONDUITS, ACCESSORIES AND RELATED SUPPORTS AS INDICATED ON DEMOLITION DRAWINGS. TYPICAL.
- 4. PROPERLY DISPOSE OF ALL DEMOLITION DEBRIS AS REQUIRED BY FEDERAL, STATE AND LOCAL CODES AND ORDINANCES.
- 5. DO NOT DAMAGE EXISTING EQUIPMENT AND/OR SYSTEMS NOT INDICATED FOR REMOVAL BY DEMOLITION DRAWINGS. ANY DAMAGE INCURRED WILL BE THE RESPONSIBILITY OF THE CONTRACTOR. CONTRACTOR SHALL MATCH AND REPLACE AT NO COST TO OWNER.
- CONTRACTOR SHALL PROVIDE MINIMUM OF 72 HOURS NOTICE PRIOR TO ANY EQUIPMENT/SERVICE SHUT DOWN.
 BUILDING WILL BE OCCUPIED DURING ALL PHASES OF CONSTRUCTION. CONTAIN AND CONTROL CONSTRUCTION DEBRIS SO AS NOT TO INTERFERE WITH DAILY OPERATION OF BUILDING. KEEP EGRESS PATHS FREE FOR DAILY OPERATION OF BUILDING.
- 8. DEMOLITION WORK SHALL BE PERFORMED BY QUALIFIED, LICENSED PERSONNEL AS REQUIRED BY ALL APPLICABLE CODES AND STANDARDS.

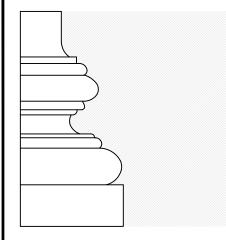

EVELYN COLE SMITH ARCHITECTS, LLC
PO Box 182
134 Main St

Putnam, CT 06260 860 315 9570

www.ecsarchitects.com

STAMP

CONSULTANT

SALAMONE & ASSOCIATES, P.C.

CONSULTING ENGINEERS

116 North Plains Industrial Road
Wallingford, Connecticut 06492
Phone: (203) 281-6895 Fax: (203) 287-8728

PROJECT

Proposed Commercial Kitchen

EASTCONN 376 Hartford Turnpike Hampton, CT 06247

Prepared for

EASTCONN 376 Hartford Turnpike Hampton, CT 06247

Date Description

REVISIONS

SHEET TITLE

First Floor Electrical Demolition Plan

PROJ. NO. 2018048

SCALE AS NOTED

DATE APRIL, 2019


DESIGNED FB

DRAWN FB

CHECKED JAS

DF₋1

SHEET

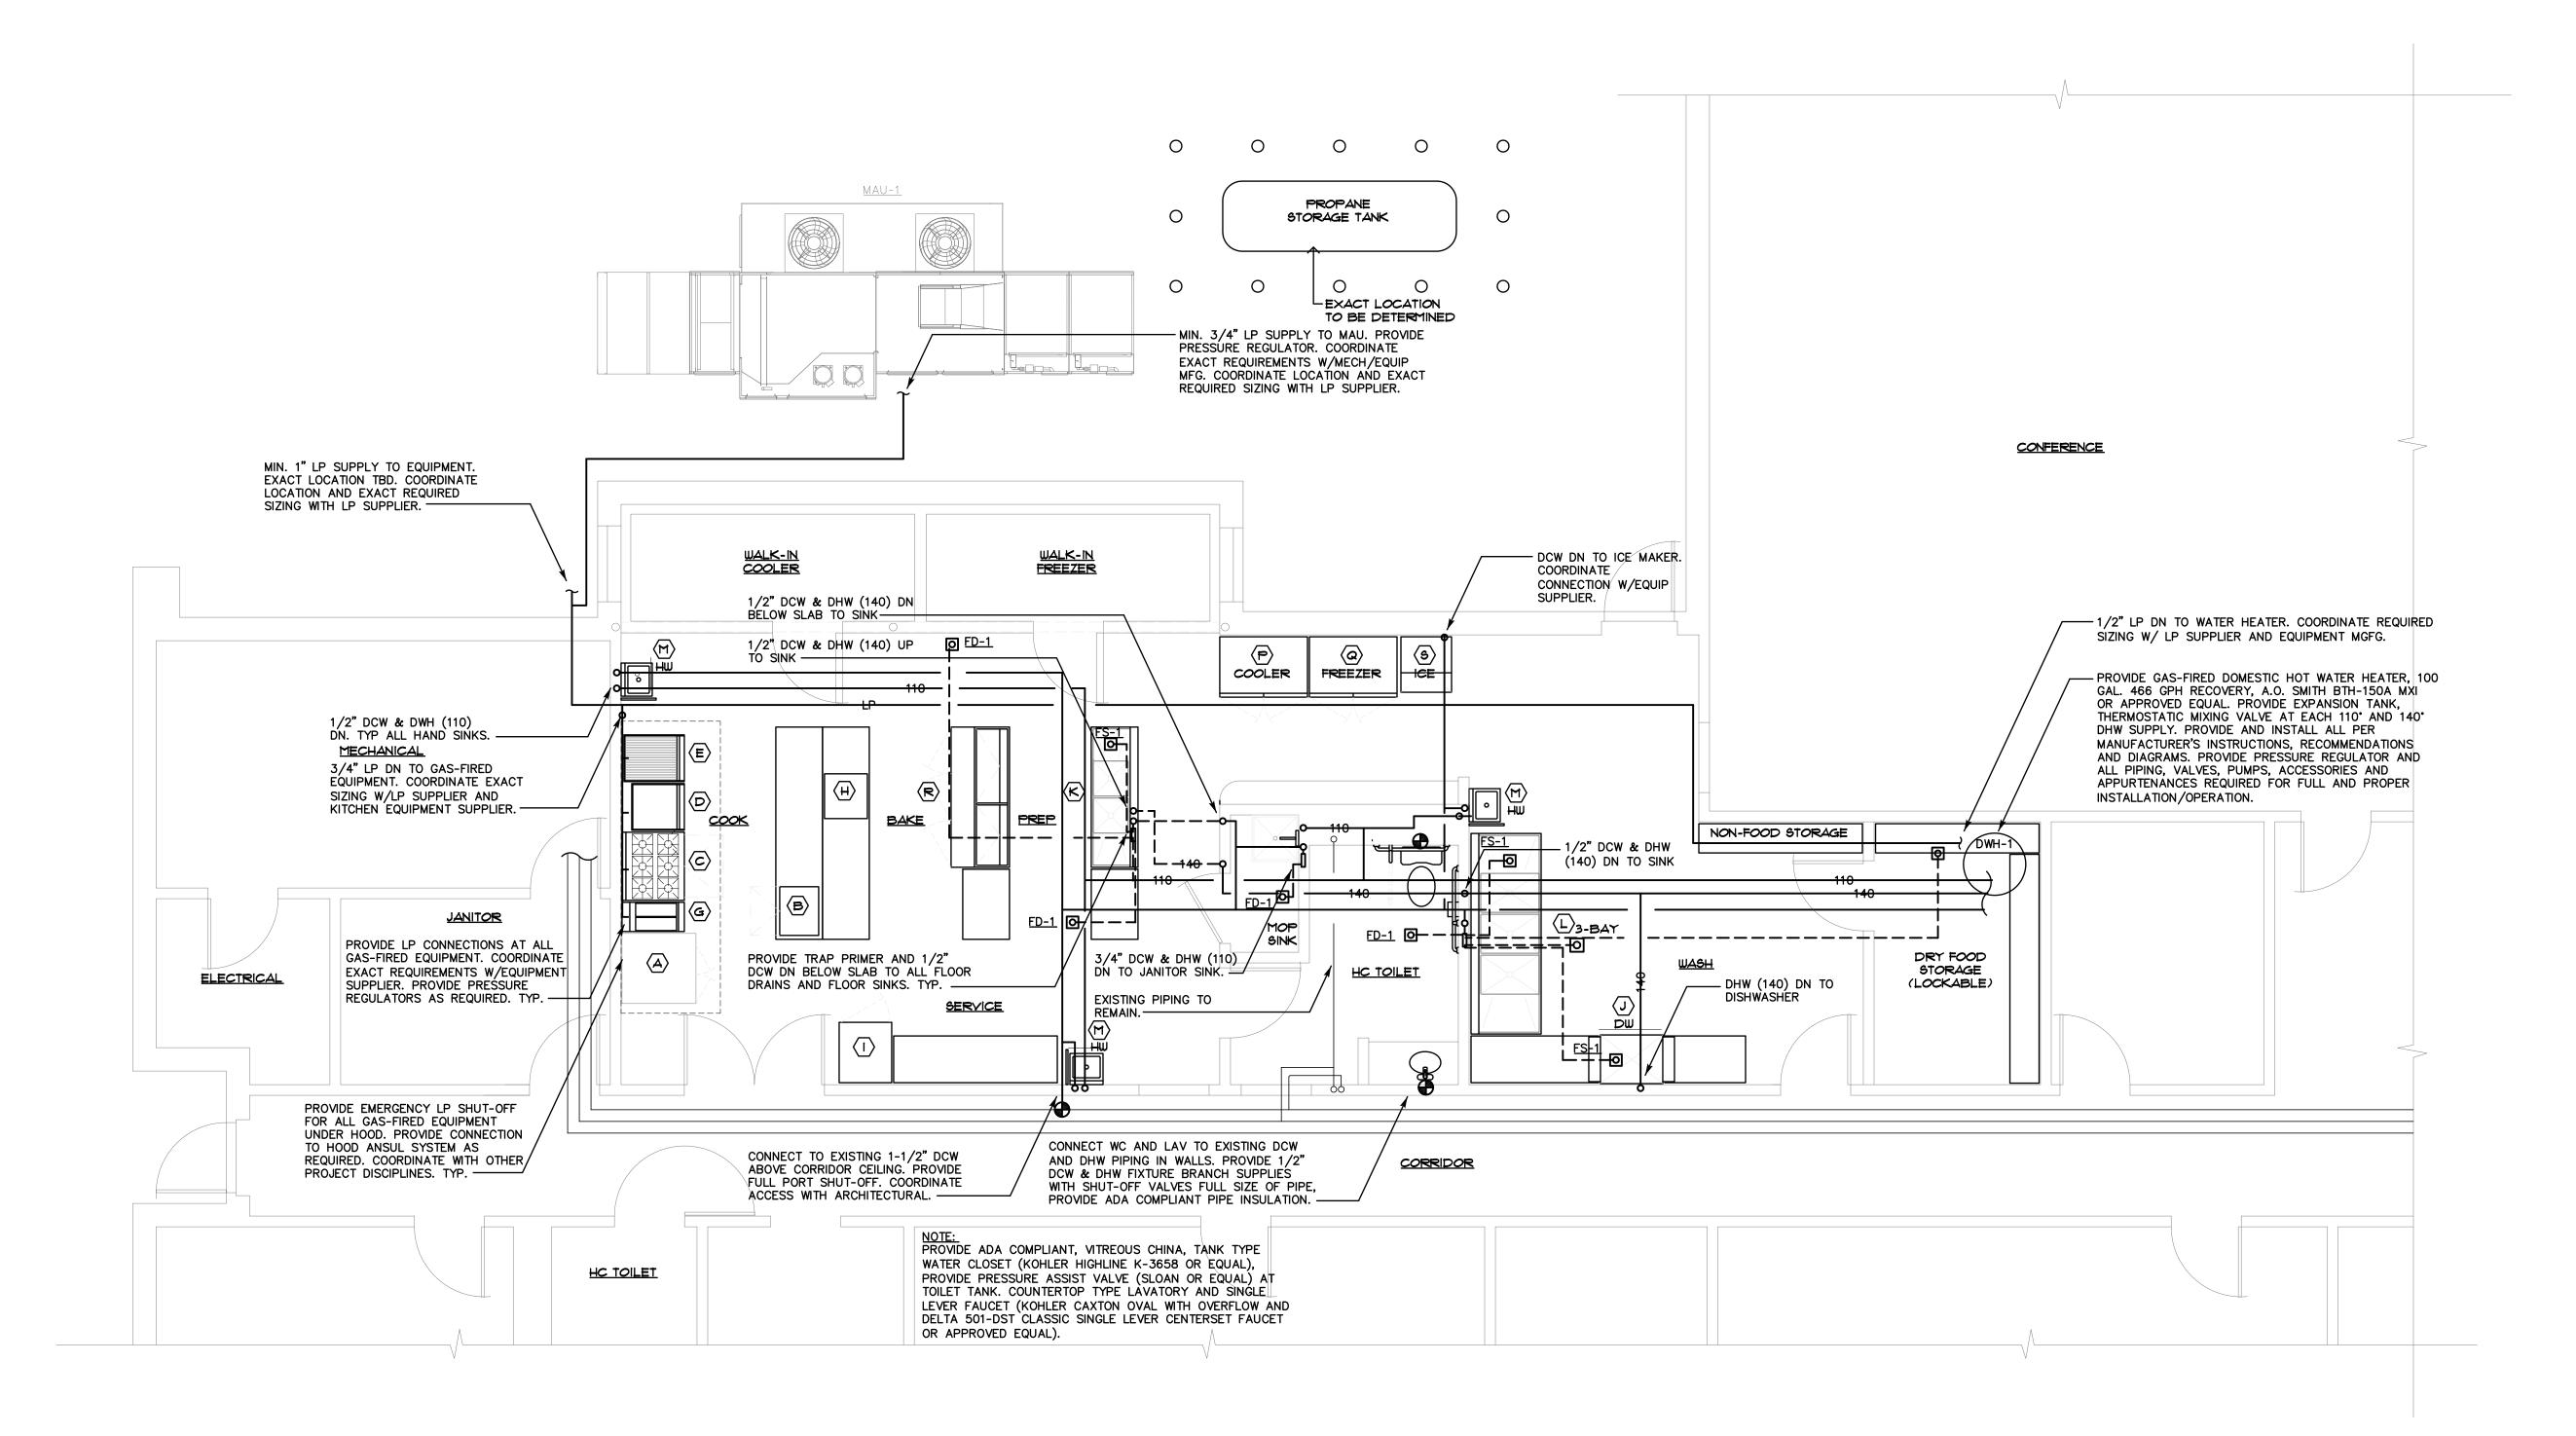

FIRST FLOOR PLUMBING PLAN **DOMESTIC WATER**



PLUMBING GENERAL NOTES:


- THE CONTRACTOR SHALL VISIT THE PROJECT SITE PRIOR TO BIDDING AND BECOME INFORMED AS TO THE NATURE AND SCOPE OF WORK REQUIRED, NOTING AND ACCOUNTING FOR EXISTING CONDITIONS. TYPICAL.
- THE CONTRACTOR SHALL BE RESPONSIBLE FOR ALL WORK INCLUDING TOOLS, MATERIAL, MANPOWER, ETC. REQUIRED FOR COMPLETE AND PROPER INSTALLATION OF PROPOSED MATERIALS, FIXTURES AND/OR EQUIPMENT.
- ALL WORK SHALL BE PERFORMED IN A SAFE AND ORDERLY MANNER WITH QUALIFIED AND LICENSED PERSONNEL IN ACCORDANCE WITH STATE AND LOCAL GOVERNING AUTHORITIES AND ALL APPLICABLE CODES AND STANDARDS. TYPICAL.
- ALL SERVICE DISRUPTIONS MUST BE SCHEDULED A MINIMUM OF 72 HOURS IN ADVANCE WITH THE OWNER'S REPRESENTATIVE. CONTRACTOR SHALL PROVIDE CLEANOUTS FOR PROPOSED
- SANITARY PIPING AS REQUIRED PER CURRENT APPLICABLE CODES AND STANDARDS. TYPICAL.
- ROUTING OF ALL PIPING SHALL BE COORDINATED WITH STRUCTURAL FRAMING ELEMENTS AND ALL OTHER PROJECT DISCIPLINES. TYPICAL.
- PROVIDE CONDENSATE DRAINAGE PIPING FOR ANY/ALL AIR HANDLERS, MAKE-UP AIR UNIT, ENERGY RECOVERY UNITS AND FAN COIL UNITS. COORDINATE WITH MECHANICAL. TYPICAL.
- PLUMBING WORK SHALL BE COORDINATED WITH LOCAL HEALTH DEPARTMENT. TYPICAL.

EXISTING CONDITIONS NOTE:

THE CONTRACTOR(S) SHALL VISIT THE SITE PRIOR TO BIDDING, NOTING EXISTING CONDITIONS AND EQUIPMENT. IF SAID EQUIPMENT IS NOT BEING REMOVED AS PART OF THE PROJECT OR IS NOTED AS EXISTING TO REMAIN AND IMPEDES PROVIDING PROPOSED EQUIPMENT AND OR PROVIDING PROPOSED SCOPE OF WORK, EQUIPMENT SHALL BE TEMPORARILY RELOCATED AND COMPLETELY REINSTALLED AFTER PROPOSED SCOPE OF WORK IS COMPLETED. THIS SHALL BE PART OF THE BASE BID AND CONTRACTOR(S) SHALL BID ACCORDINGLY, NO ADDITIONAL COMPENSATION WILL BE CONSIDERED FOR RELATED WORK OR COORDINATION WITH EXISTING CONDITIONS.

KITCHEN FIXTURES AND EQUIPMENT NOTE:

FINAL/EXACT LOCATIONS OF PROPOSED FIXTURES AND EQUIPMENT PER ARCHITECT AND EQUIPMENT SUPPLIER. ALL PIPING, CONNECTIONS, VALVES, AND ASSOCIATED ACCESSORIES AND APPURTENANCES SHALL BE COORDINATED AND PROVIDED/INSTALLED ACCORDINGLY. ROUTING AND SIZING OF ALL PIPING SERVING FIXTURES AND EQUIPMENT SHALL BE COORDINATED WITH EQUIPMENT SUPPLIER AND PROVIDED AND INSTALLED PER MANUFACTURER/SUPPLIER INSTRUCTIONS AND RECOMMENDATIONS AND CURRENT CODE. COORDINATE ALL WORK WITH EXISTING CONDITIONS AND ALL OTHER PROJECT DISCIPLINES. PROVIDE AND INSTALL PER CURRENT APPLICABLE CODES AND STANDARDS. TYPICAL.

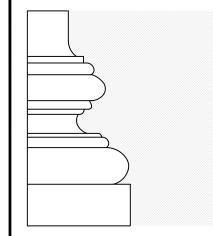

EVELYN COLE SMITH ARCHITECTS, LLC PO Box 182 134 Main St

www.ecsarchitects.com

Putnam, CT

860 315 9570

06260

STAMP

ASSOCIATES, P.C.

SALAMONE

CONSULTING ENGINEERS 116 North Plains Industrial Road Wallingford, Connecticut 06492 one: (203) 281-6895 Fax: (203) 287-8728

Proposed Commercial Kitchen

EASTCONN 376 Hartford Turnpike Hampton, CT 06247

Prepared for

EASTCONN 376 Hartford Turnpike Hampton, CT 06247

REVISIONS

	Date	Description
	SH	EET TITLE

First Floor Plumbing Plan - Domestic Water

PROJ. NO. 2018048


SCALE AS NOTED

DESIGNED SJS

DATE APRIL, 2019

DRAWN SJS CHECKED JAS

SHEET

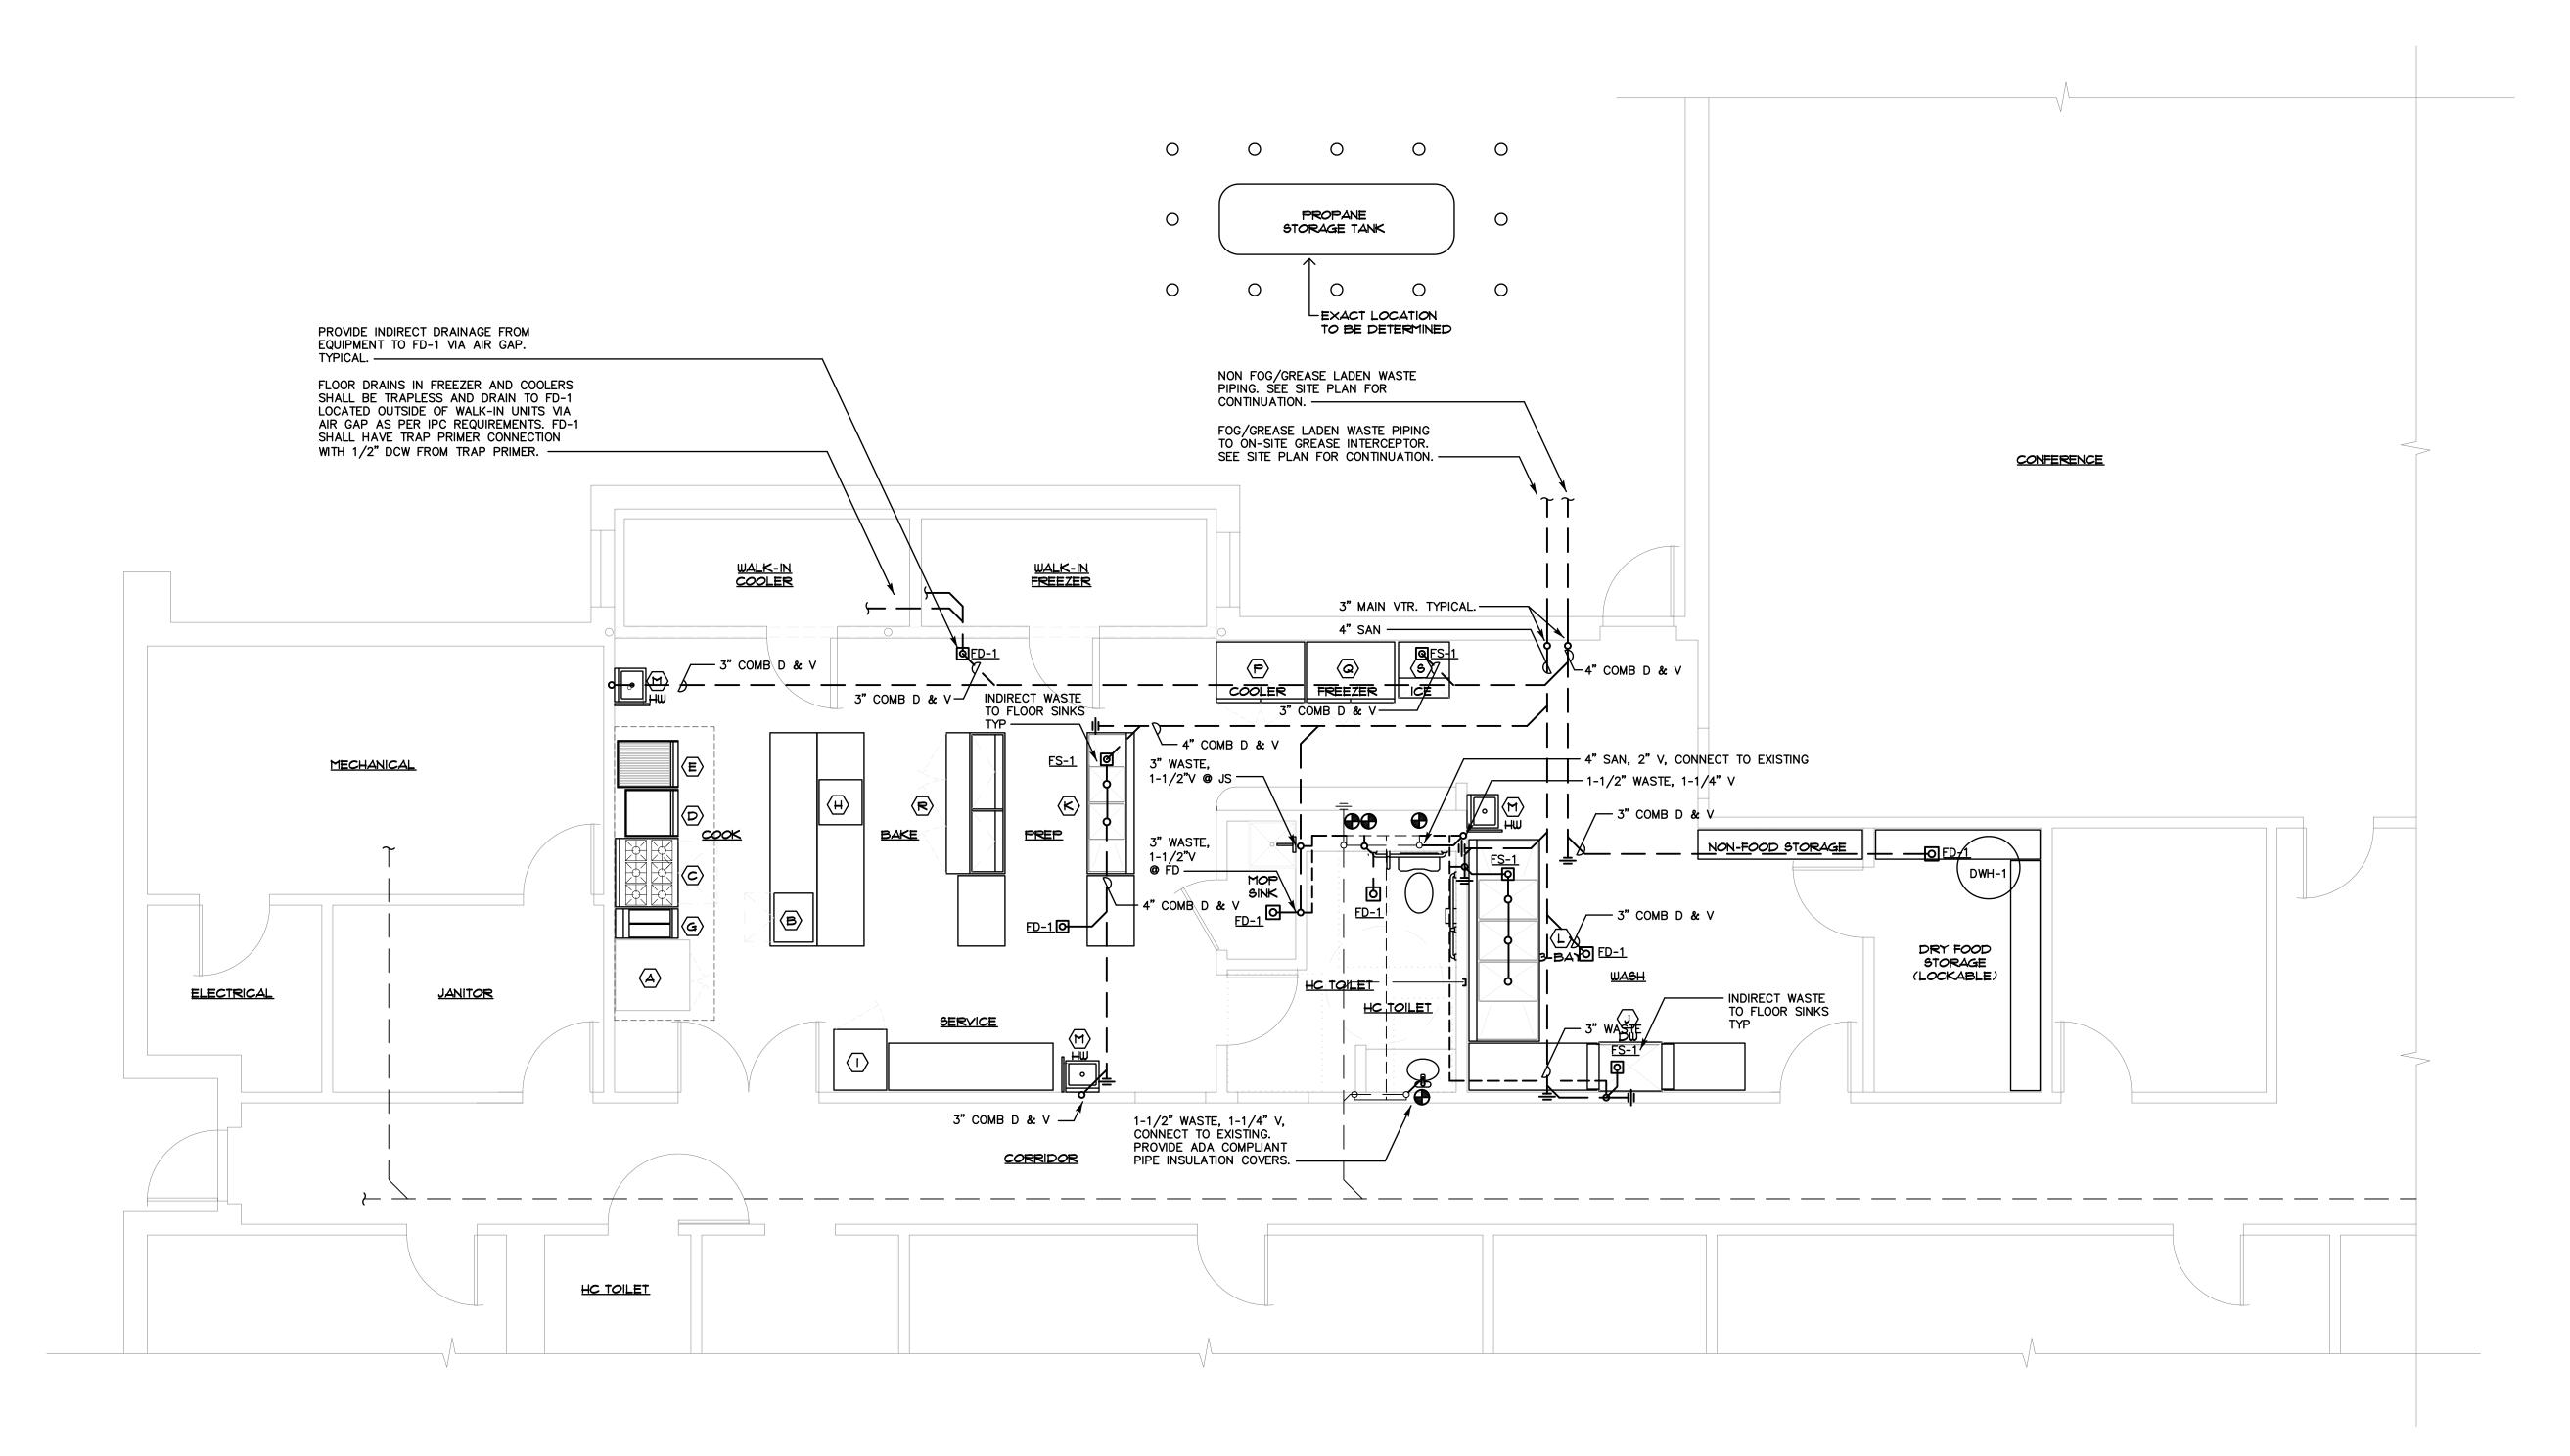

FIRST FLOOR PLUMBING PLAN
SANITARY & VENT

PLUMBING GENERAL NOTES:

- THE CONTRACTOR SHALL VISIT THE PROJECT SITE PRIOR TO BIDDING AND BECOME INFORMED AS TO THE NATURE AND SCOPE OF WORK REQUIRED, NOTING AND ACCOUNTING FOR EXISTING CONDITIONS. TYPICAL.
- THE CONTRACTOR SHALL BE RESPONSIBLE FOR ALL WORK INCLUDING TOOLS, MATERIAL, MANPOWER, ETC. REQUIRED FOR COMPLETE AND PROPER INSTALLATION OF PROPOSED MATERIALS, FIXTURES AND/OR EQUIPMENT.
- 6. ALL WORK SHALL BE PERFORMED IN A SAFE AND ORDERLY MANNER WITH QUALIFIED AND LICENSED PERSONNEL IN ACCORDANCE WITH STATE AND LOCAL GOVERNING AUTHORITIES AND ALL APPLICABLE CODES AND STANDARDS. TYPICAL.
- ALL SERVICE DISRUPTIONS MUST BE SCHEDULED A MINIMUM OF 72 HOURS IN ADVANCE WITH THE OWNER'S REPRESENTATIVE.


 CONTRACTOR SHALL PROVIDE CLEANOUTS FOR PROPOSED
- . CONTRACTOR SHALL PROVIDE CLEANOUTS FOR PROPOSED SANITARY PIPING AS REQUIRED PER CURRENT APPLICABLE CODES AND STANDARDS. TYPICAL.
- 5. ROUTING OF ALL PIPING SHALL BE COORDINATED WITH STRUCTURAL FRAMING ELEMENTS AND ALL OTHER PROJECT DISCIPLINES. TYPICAL.
- PROVIDE CONDENSATE DRAINAGE PIPING FOR ANY/ALL AIR HANDLERS, MAKE-UP AIR UNIT, ENERGY RECOVERY UNITS AND FAN COIL UNITS. COORDINATE WITH MECHANICAL. TYPICAL.
- PLUMBING WORK SHALL BE COORDINATED WITH LOCAL HEALTH DEPARTMENT. TYPICAL.

EXISTING CONDITIONS NOTE:

THE CONTRACTOR(S) SHALL VISIT THE SITE PRIOR TO BIDDING, NOTING EXISTING CONDITIONS AND EQUIPMENT. IF SAID EQUIPMENT IS NOT BEING REMOVED AS PART OF THE PROJECT OR IS NOTED AS EXISTING TO REMAIN AND IMPEDES PROVIDING PROPOSED EQUIPMENT AND OR PROVIDING PROPOSED SCOPE OF WORK, EQUIPMENT SHALL BE TEMPORARILY RELOCATED AND COMPLETELY REINSTALLED AFTER PROPOSED SCOPE OF WORK IS COMPLETED. THIS SHALL BE PART OF THE BASE BID AND CONTRACTOR(S) SHALL BID ACCORDINGLY, NO ADDITIONAL COMPENSATION WILL BE CONSIDERED FOR RELATED WORK OR COORDINATION WITH EXISTING CONDITIONS.

KITCHEN FIXTURES AND EQUIPMENT NOTE:

FINAL/EXACT LOCATIONS OF PROPOSED FIXTURES AND EQUIPMENT PER ARCHITECT AND EQUIPMENT SUPPLIER. ALL PIPING, CONNECTIONS, VALVES, AND ASSOCIATED ACCESSORIES AND APPURTENANCES SHALL BE COORDINATED AND PROVIDED/INSTALLED ACCORDINGLY. ROUTING AND SIZING OF ALL PIPING SERVING FIXTURES AND EQUIPMENT SHALL BE COORDINATED WITH EQUIPMENT SUPPLIER AND PROVIDED AND INSTALLED PER MANUFACTURER/SUPPLIER INSTRUCTIONS AND RECOMMENDATIONS AND CURRENT CODE. COORDINATE ALL WORK WITH EXISTING CONDITIONS AND ALL OTHER PROJECT DISCIPLINES. PROVIDE AND INSTALL PER CURRENT APPLICABLE CODES AND STANDARDS. TYPICAL.

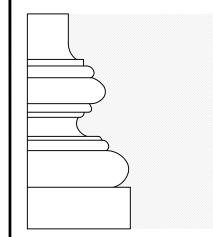

EVELYN COLE SMITH ARCHITECTS, LLC PO Box 182 134 Main St

www.ecsarchitects.com

Putnam, CT 06260

860 315 9570

STAMP

CONSULT

SALAMONE & ASSOCIATES, P.C.

CONSULTING ENGINEERS

116 North Plains Industrial Road
Wallingford, Connecticut 06492
hone: (203) 281-6895 Fax: (203) 287-8726

PROJECT

Proposed Commercial Kitchen

EASTCONN 376 Hartford Turnpike Hampton, CT 06247

Prepared for

EASTCONN 376 Hartford Turnpike Hampton, CT 06247

Date Description

First Floor Plumbing
Plan - Sanitary & Vent

PROJ. NO. 2018048

SCALE AS NOTED


DATE APRIL, 2019

DESIGNED SJS


DRAWN SJS

CHECKED JAS


SHEET

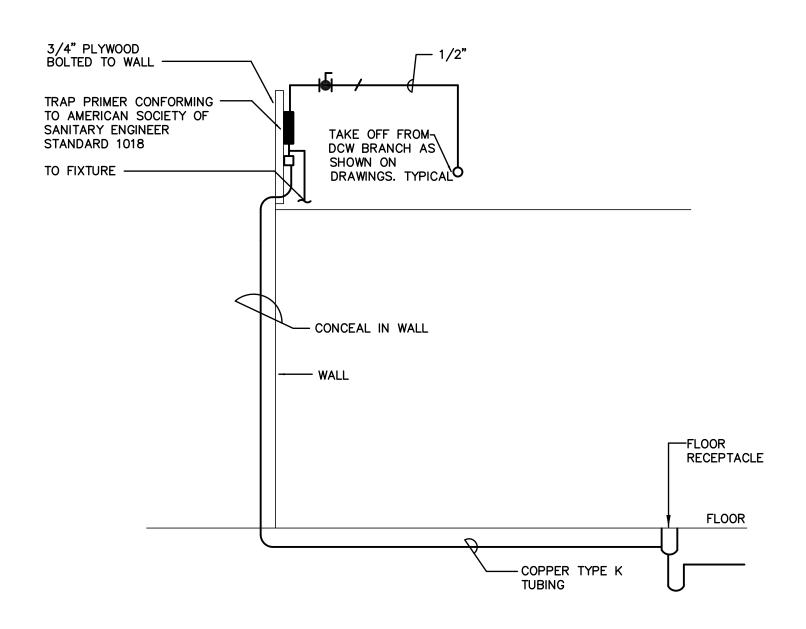


TYPICAL TRAP PRIMER DETAIL

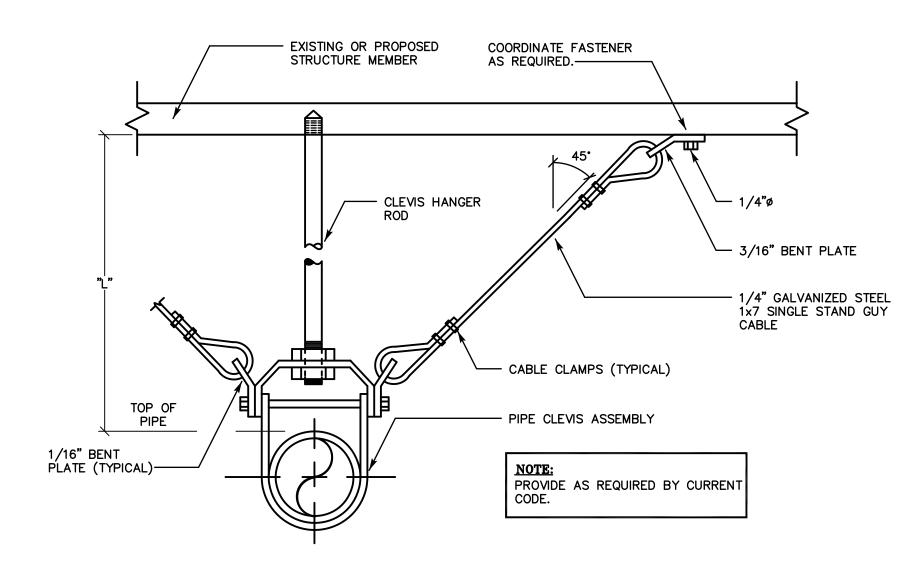

TYPICAL SEISMIC RESTRAINT
ASSEMBLY OF SUSPENDED PIPING
SCALE: N.T.S.

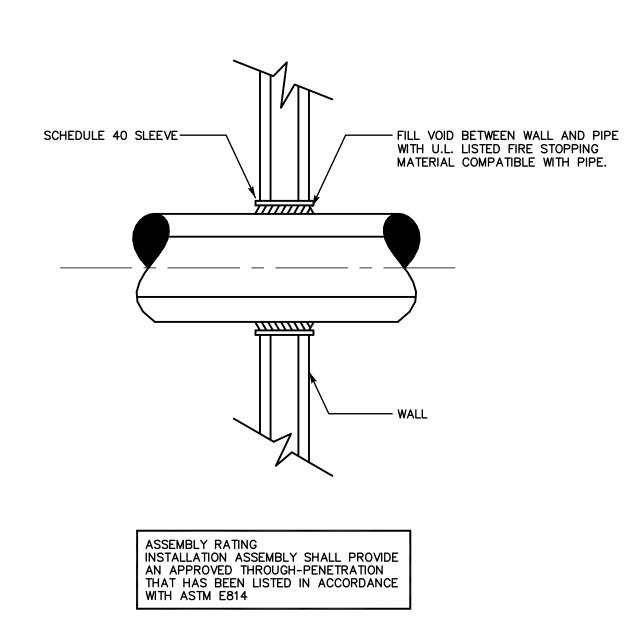


TYPICAL WALL PIPE PENETRATION
FIRE STOPPING DETAIL
SCALE: N.T.S.

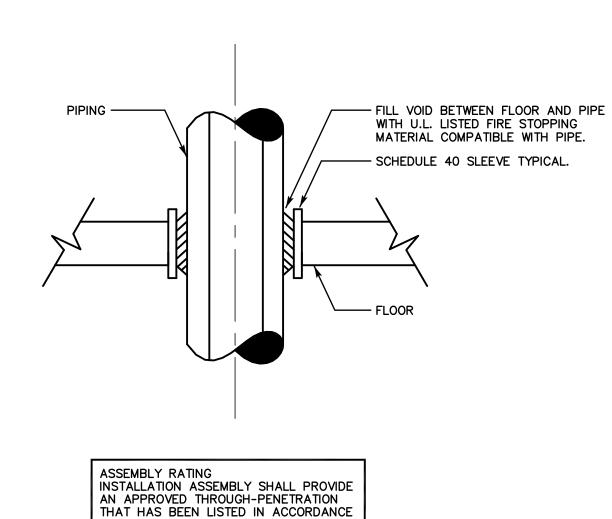

TYPICAL FLOOR PIPE PENETRATION
FIRE STOPPING DETAIL

WITH ASTM E814

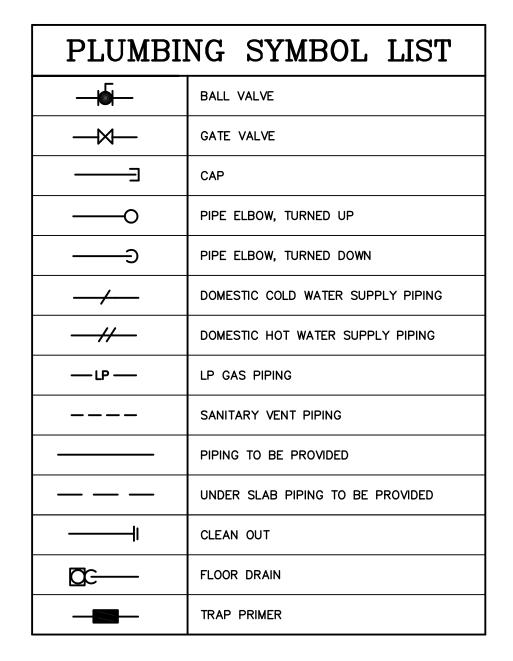

PLUMBING ABBREVIATIONS

PLUME	BING ABBREVIATION
C.O.	CLEANOUT
DCW	DOMESTIC COLD WATER SUPPLY
DHW	DOMESTIC HOT WATER SUPPLY
DN	DOWN
DWH	DOMESTIC WATER HEATER
ET	EXPANSION TANK
F.C.O.	FLOOR CLEANOUT
FD	FLOOR DRAIN
GPH	GALLONS PER HOUR
GPM	GALLONS PER MINUTE
JS	JANITOR'S SINK
LAV	LAVATORY
NTS	NOT TO SCALE
SAN	SANITARY
SK	SINK
TM	THERMOSTATIC MIXING VALVE
TYP	TYPICAL
VTR	SANITARY VENT THROUGH ROOF


WATER CLOSET

PLUMBING GENERAL NOTES

- . NOTES BELOW ARE NOT INTENDED TO REPLACE SPECIFICATIONS. SEE SPECIFICATIONS FOR REQUIREMENTS IN ADDITION TO GENERAL NOTES.
- 2. PROVIDE FIXTURE SHUT-OFF VALVES AND P-TRAPS FOR ALL FIXTURES PROVIDED. PROVIDE SANITARY, WASTE AND DOMESTIC WATER PIPING AS REQUIRED FOR ALL FIXTURES PROVIDED.
- 3. REFER TO AND CAREFULLY CHECK ARCHITECTURAL, ELECTRICAL AND MECHANICAL DRAWINGS AND DETAILS, NOTING LOCATIONS WHERE WALLS, PARTITIONS, CEILINGS AND OTHER SURFACES ARE FURRED, LOCATION OF PIPE SLEEVES, LOCATIONS OF PIPE SHAFTS AND CONFLICTS WITH WORK OF OTHER TRADES AND ARRANGE WORK ACCORDINGLY. FURNISH ALL OFFSETS, FITTINGS, VALVES, DRAINS, ETC. REQUIRED TO MEET SUCH CONDITIONS.
- 4. DUE TO SCALE OF DRAWINGS, ALL REQUIRED OFFSETS, FITTINGS, VALVES, DRAINS, ETC. MAY NOT BE INDICATED.
- 5. ALL PIPING PASSING THROUGH FIRE RATED WALLS SHALL BE PROVIDED WITH SCHEDULE 40 STEEL PIPE SLEEVES AND SPACE BETWEEN EXTERIOR OF PIPE AND INTERIOR OF PIPE SLEEVE PACKED WITH A FIRE RATED MATERIAL EQUAL TO THE RATING OF THE WALL.
- 6. UNLESS OTHERWISE INDICATED, PROVIDE A COMPLETE AND OPERATIONAL PLUMBING SYSTEM INCLUDING ALL NECESSARY MATERIAL, LABOR AND EQUIPMENT.
- CONTRACTOR SHALL OBTAIN AND PAY FOR ALL REQUIRED PERMITS AND ARRANGE FOR ALL REQUIRED INSPECTIONS IN ACCORDANCE WITH STATE AND LOCAL GOVERNING CODES.
- 8. THE TERM "PROVIDE" SHALL MEAN "TO FURNISH, INSTALL AND CONNECT COMPLETELY."
- 9. WHERE THE CONTRACTOR PROPOSES TO USE AN ITEM OF EQUIPMENT OTHER THAN THAT SPECIFIED OR DETAILED ON THE DRAWINGS WHICH REQUIRES ANY REDESIGN OF THE STRUCTURE, PARTITIONS, FOUNDATIONS, PIPING, WRING OR ANY OTHER PART OF THE MECHANICAL, ELECTRICAL OR ARCHITECTURAL LAYOUT, ALL SUCH REDESIGN AND ALL NEW DRAWINGS AND DETAILING REQUIRED THEREFORE, SHALL BE PREPARED AT THE CONTRACTOR'S EXPENSE AND ARE SUBJECT TO THE REVIEW AND APPROVAL OF THE OWNER OR HIS AUTHORIZED REPRESENTATIVE. OWNER RESERVES THE RIGHT TO HAVE THE ARCHITECT OR ENGINEER OF HIS CHOICE PREPARE ANY REDESIGN WORK.
- 10. ALL WORK SHALL BE DONE WITH LICENSED WORKMEN IN ACCORDANCE WITH STATE AND LOCAL GOVERNING AUTHORITIES.
- 11. CONTRACTOR SHALL MAKE ADEQUATE PROVISIONS FOR PIPE SLOPE AND ANCHORAGE.
- 12. BEFORE CUTTING OR DRILLING INTO BUILDING ELEMENTS, INSPECT AND LAYOUT WORK TO AVOID DAMAGING STRUCTURAL ELEMENTS AND
- BUILDING UTILITIES.

 13. ALL WORK SHALL BE DONE IN ACCORDANCE WITH THE LATEST
- ACCEPTED:
- A. INTERNATIONAL BUILDING CODE
 B. CONNECTICUT SUPPLEMENT
- C. INTERNATIONAL MECHANICAL CODE
- D. ASTM & ANSI STANDARDS.
 E. INTERNATIONAL PLUMBING CODE
- F. FIRE SAFETY CODE
- 14. CONTRACTOR SHALL BE RESPONSIBLE FOR REPAIR AND PAYMENT FOR ALL UTILITIES DAMAGED DURING CONSTRUCTION.
- 15. CONTRACTOR TO CONFIRM PIPE LOCATIONS, ELEVATIONS, AND SIZES BEFORE ANY WORK IS STARTED. IF ANY DISCREPANCIES ARE FOUND NOTIFY ENGINEER BEFORE PROCEEDING WITH WORK.
- 16. PROVIDE WATER SERVICE SHUT OFF VALVES ON WATER SUPPLY IMMEDIATELY ADJACENT TO PLUMBING FIXTURES.
- 17. PROVIDE SEISMIC BRACING OF ALL PLUMBING PIPES PER THE CONNECTICUT BUILDING CODE.
- 18. PROVIDE WATER HAMMER ARRESTERS FOR ALL FLUSH VALVES. SIZE AND
- LOCATE IN ACCORDANCE WITH MANUFACTURER'S RECOMMENDATIONS.

 19. FOLLOW MANUFACTURER'S INSTRUCTIONS AND RECOMMENDATIONS FOR
- INSTALLATION OF PROVIDED EQUIPMENT.
- 20. ALL PIPES THAT PENETRATE WALLS, FLOORS AND CEILINGS IN FINISHED AREAS SHALL RECEIVE CHROME PLATED METAL ESCUTCHEONS.
- 21. ALL SHOP DRAWINGS OF INDIVIDUAL COMPONENTS ARE TO BE SUBMITTED
- AS A COMPLETE PACKAGE.
- 22. ALL SHOP DRAWINGS OF RELATED COMPONENTS SHALL BE SUBMITTED AS A COMPLETE PACKAGE.
- 23. ALL WORK IN INTERIOR FINISHED SPACES IS TO BE CONCEALED BEHIND WALLS, ABOVE CEILINGS, OR UNDER THE FLOOR. PROVIDE ALL NECESSARY CUTTING, PATCHING, REPAINTING AND/OR REPLACEMENT OF FINISHES AS REQUIRED TO PERFORM WORK.
- 24. WRITTEN REQUESTS FOR PLANNED SHUTDOWN OR INTERRUPTION OF BUILDING SERVICES, SYSTEMS OR EQUIPMENT SHALL BE MADE IN WRITING 72 HOURS PRIOR TO START OF THE REQUESTED SHUTDOWN PERIOD.
- 25. SUPPORT PIPING ABOVE SUSPENDED CEILING, FROM CONSTRUCTION ABOVE, AS CLOSE AS POSSIBLE TO BOTTOM OF SLABS, BEAMS, MAINTAINING MAXIMUM HEADROOM AT ALL TIMES.
- 26. PROVIDE CLEANOUTS PER PLUMBING CODE.
- 27. ISLE AND CORRIDOR WAYS THROUGH CONSTRUCTION AREAS WHICH ARE REQUIRED FOR EGRESS (NORMAL OR EMERGENCY) SHALL BE KEPT CLEAR OF MATERIAL, EQUIPMENT, & DEBRIS.
- 28. ALL WORK SHALL BE LICENSED WORKMAN IN ACCORDANCE WITH STATE AND LOCAL GOVERNING AUTHORITIES.

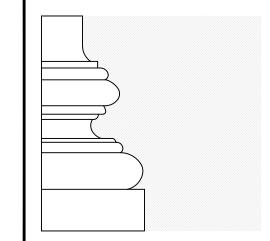

EVELYN COLE SMITH ARCHITECTS, LLC

PO Box 182 134 Main St Putnam, CT 06260 860 315 9570

www.ecsarchitects.com

STAMP

CONSULTAN

SALAMONE

& ASSOCIATES, P.C. CONSULTING ENGINEERS

Wallingford, Connecticut 06492 one: (203) 281-6895 Fax: (203) 287-8728

116 North Plains Industrial Road

Proposed Commercial Kitchen

EASTCONN

376 Hartford Turnpike Hampton, CT 06247

Prepared for

EASTCONN 376 Hartford Turnpike Hampton, CT 06247

REVISIONS

Date Description

Plumbing Details,

SHEET TITLE

Symbols, Notes & Abbreviations

PROJ. NO. 2018048

DATE APRIL, 2019

DESIGNED SJS


SCALE AS NOTED

DRAWN SJS

CHECKED JAS

SHEET

P-3

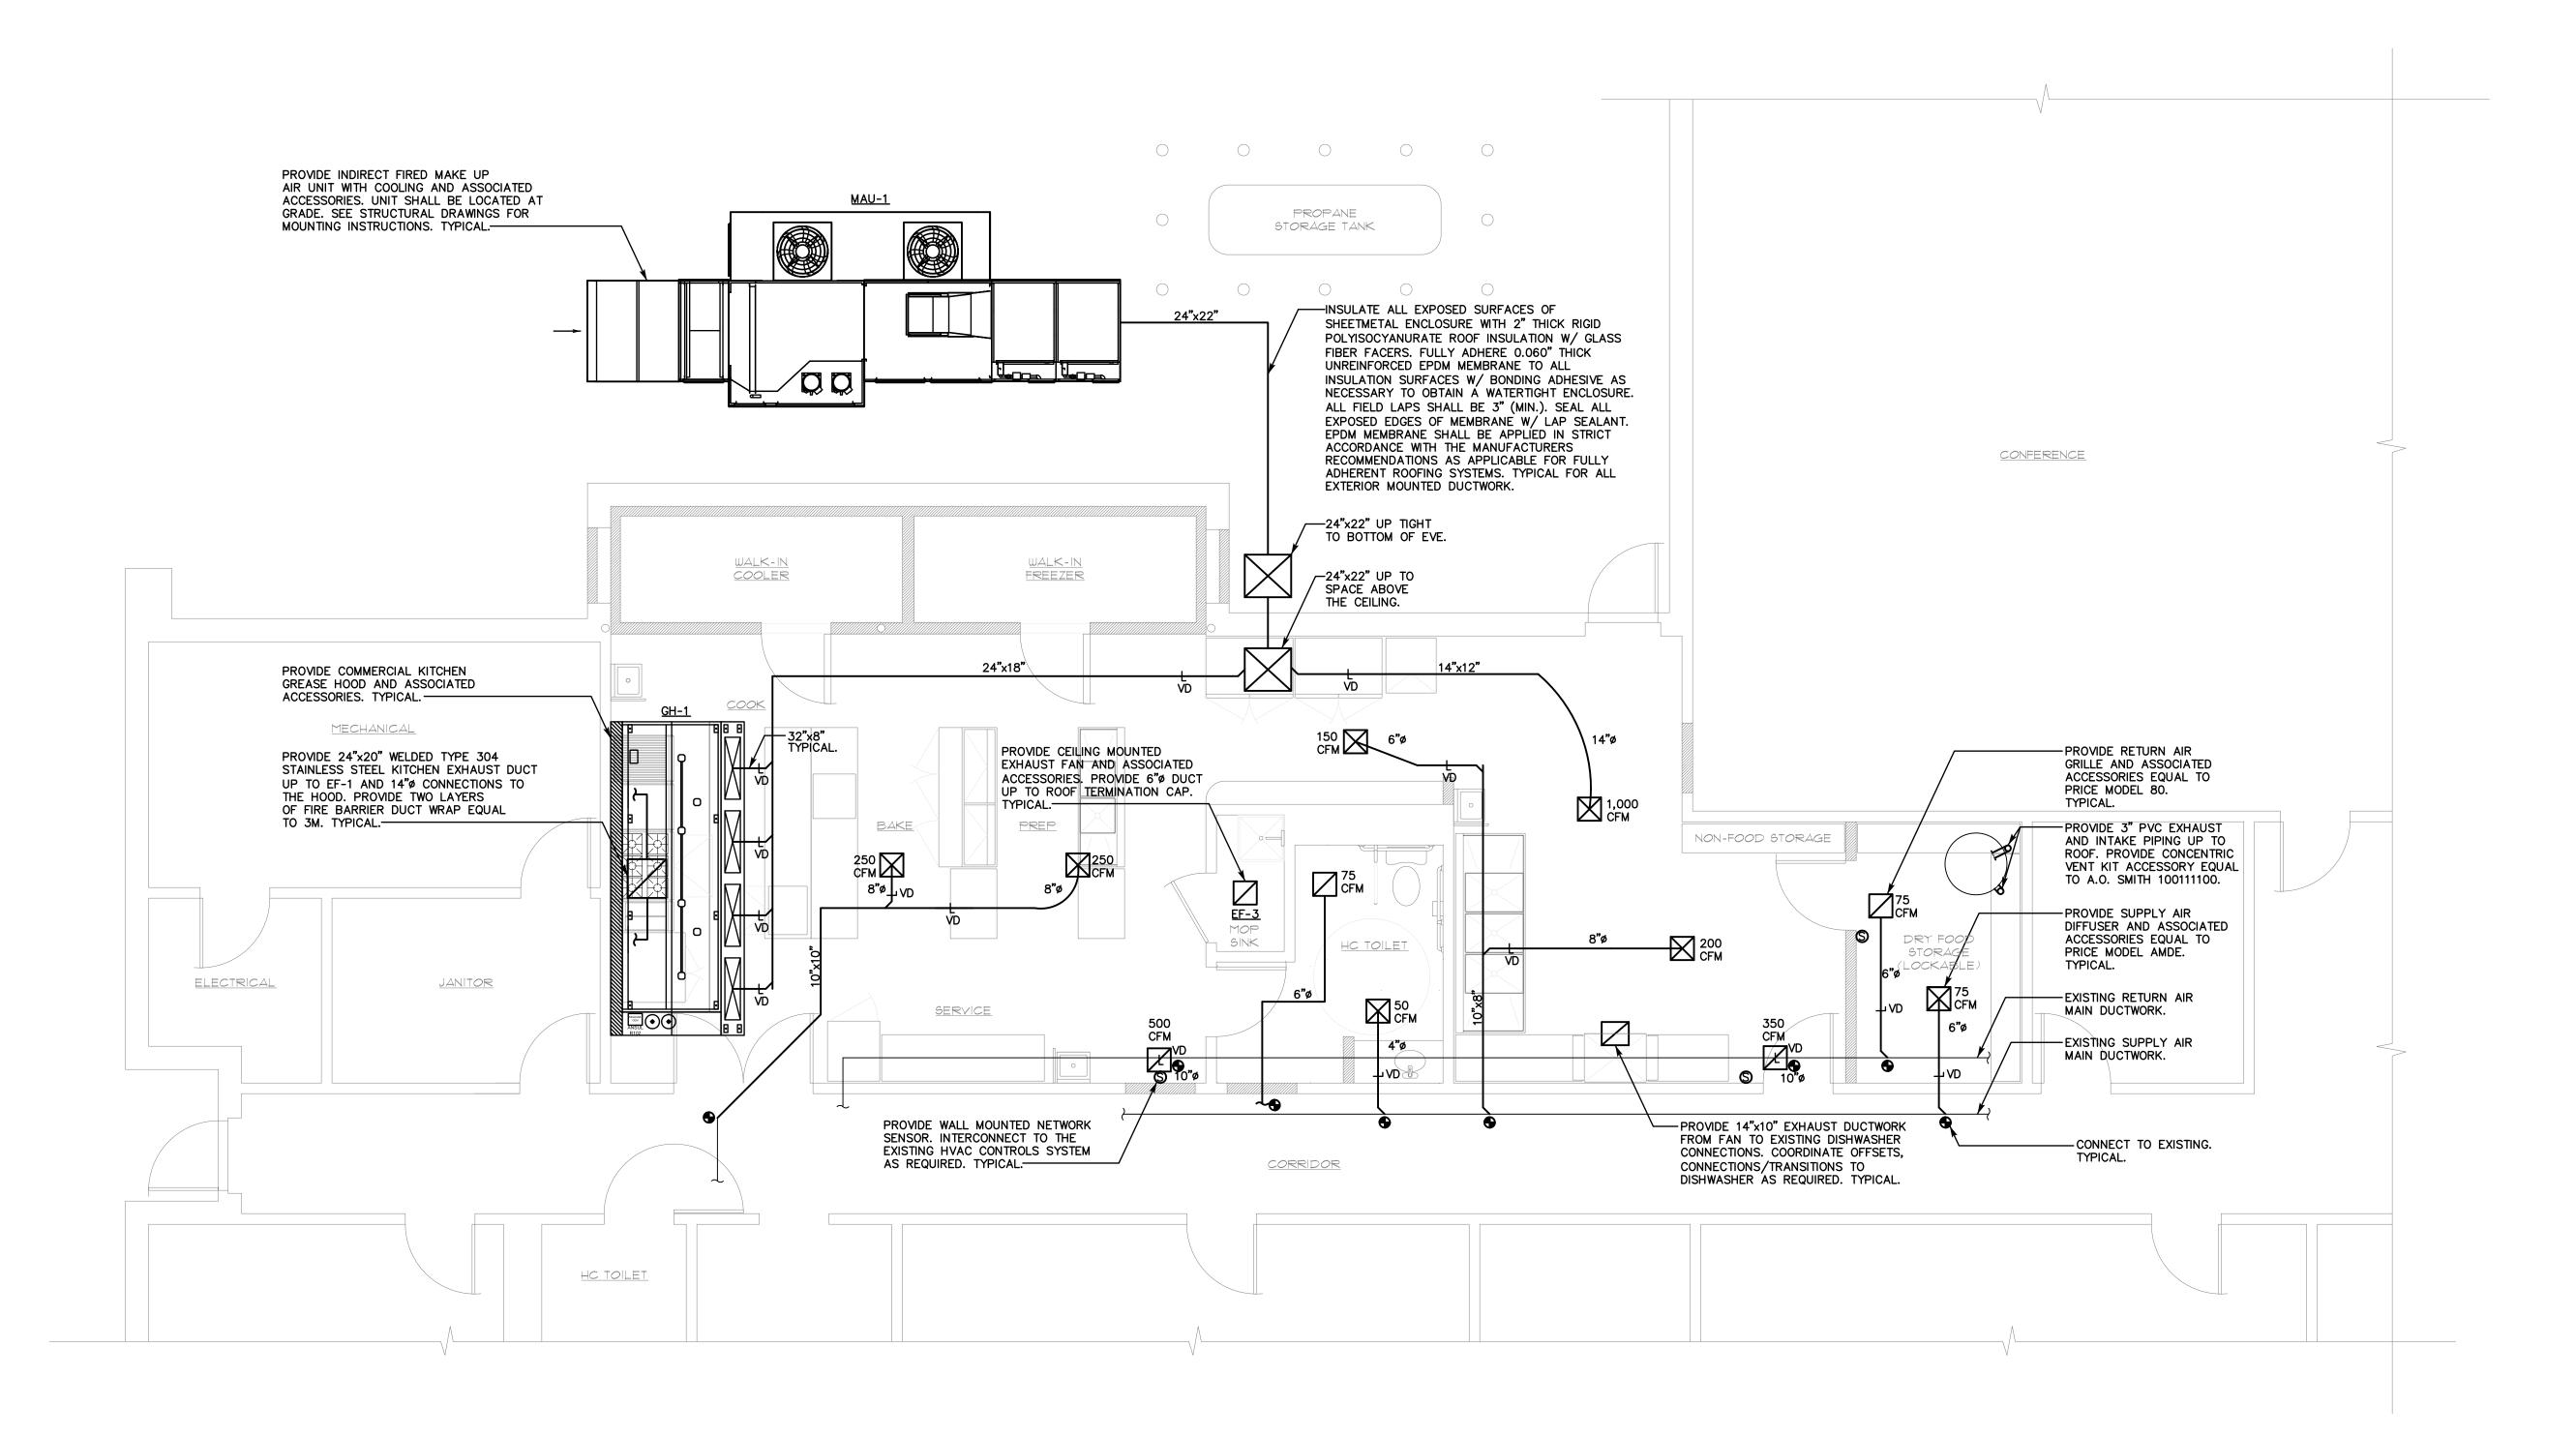


FIRST FLOOR MECHANICAL PLAN

SCALE: 1/4"=1'-0"

MECHANICAL NOTES:

- 1. THE CONTRACTOR SHALL VISIT THE PROJECT SITE, PRIOR TO BIDDING, AND BECOME INFORMED AS TO THE NATURE AND SCOPE OF WORK REQUIRED, NOTING AND ACCOUNTING FOR EXISTING CONDITIONS. TYPICAL.
- 2. COORDINATE ALL WORK WITH EXISTING/PROPOSED CONDITIONS. TYPICAL.
- 3. THE CONTRACTOR SHALL BE RESPONSIBLE FOR ALL WORK INCLUDING TOOLS, MATERIAL, MANPOWER, ETC. REQUIRED FOR COMPLETE AND PROPER INSTALLATION OF PROPOSED MATERIALS, FIXTURES AND/OR EQUIPMENT.
- 4. DRAWINGS ARE DIAGRAMMATIC. CONTRACTOR SHALL FIELD VERIFY ALL LOCATIONS, QUANTITIES AND DIMENSIONS OF EXISTING MATERIALS, PIPING, CONDUIT, FIXTURES AND/OR EQUIPMENT WITHIN AND AFFECTING PROJECT SCOPE OF WORK.
- 5. ALL WORK SHALL BE PERFORMED IN A SAFE AND ORDERLY MANNER WITH QUALIFIED AND LICENSED PERSONNEL IN ACCORDANCE WITH STATE AND LOCAL GOVERNING AUTHORITIES AND ALL APPLICABLE CODES AND STANDARDS. TYPICAL.
- 6. ALL SERVICE DISRUPTIONS MUST BE SCHEDULED A MINIMUM OF 72 HOURS IN ADVANCE WITH THE OWNER'S REPRESENTATIVE.
- 7. CONTRACTOR SHALL NOT DAMAGE ANY EXISTING EQUIPMENT, PIPING, OR ASSOCIATED ACCESSORIES WHICH ARE TO REMAIN.
- CONTRACTOR SHALL NOT DAMAGE ANY EXISTING ELECTRICAL CONNECTIONS, WIRING AND ASSOCIATED ACCESSORIES WHICH ARE TO REMAIN.
- 9. PROVIDE ALL REQUIRED PENETRATIONS. COORDINATE WITH EXISTING STRUCTURAL ELEMENTS. FIRE STOP ALL PENETRATIONS. TYPICAL
 10. ROUTING OF ALL PIPING/DUCTWORK SHALL BE COORDINATED WITH
- EXISTING/PROPOSED CONDITIONS, STRUCTURAL FRAMING ELEMENTS
 AND ALL OTHER PROJECT DISCIPLINES. TYPICAL

 PROVIDE VOLUME DAMPERS AT EACH SUPPLY BRANCH AND MAIN
- 11. PROVIDE VOLUME DAMPERS AT EACH SUPPLY BRANCH AND MAIN RETURN DUCTS. TYPICAL.

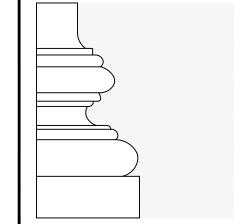

EVELYN COLE SMITH ARCHITECTS, LLC
PO Box 182

134 Main St Putnam, CT 06260 860 315 9570

www.ecsarchitects.com

STAMP

CONSULTAN

SALAMONE

& ASSOCIATES, P.C.

CONSULTING ENGINEERS

116 North Plains Industrial Road
Wallingford, Connecticut 06492
one: (203) 281-6895 Fax: (203) 287-8728

PROJECT

Proposed Commercial Kitchen

EASTCONN
376 Hartford Turnpike

376 Hartford Turnpike Hampton, CT 06247

Prepared for

EASTCONN 376 Hartford Turnpike Hampton, CT 06247

REVISIONS

	Date	Description
	SH	EET TITLE

First Floor Mechanical Plan

PROJ. NO. 2018048

SCALE AS NOTED

DATE APRIL, 2019

DESIGNED ST

DRAWN ST

CHECKED JAS

M-1

SHEET




ROOF MECHANICAL PLAN
SCALE: 1/4"=1'-0"



MECHANICAL NOTES:

- 1. THE CONTRACTOR SHALL VISIT THE PROJECT SITE, PRIOR TO BIDDING, AND BECOME INFORMED AS TO THE NATURE AND SCOPE OF WORK REQUIRED, NOTING AND ACCOUNTING FOR EXISTING CONDITIONS. TYPICAL.
- 2. COORDINATE ALL WORK WITH EXISTING/PROPOSED CONDITIONS. TYPICAL.
- THE CONTRACTOR SHALL BE RESPONSIBLE FOR ALL WORK INCLUDING TOOLS, MATERIAL, MANPOWER, ETC. REQUIRED FOR COMPLETE AND PROPER INSTALLATION OF PROPOSED MATERIALS, FIXTURES AND/OR EQUIPMENT.
- 4. DRAWINGS ARE DIAGRAMMATIC. CONTRACTOR SHALL FIELD VERIFY
 ALL LOCATIONS, QUANTITIES AND DIMENSIONS OF EXISTING
 MATERIALS, PIPING, CONDUIT, FIXTURES AND/OR EQUIPMENT WITHIN
 AND AFFECTING PROJECT SCOPE OF WORK.
- 5. ALL WORK SHALL BE PERFORMED IN A SAFE AND ORDERLY MANNER WITH QUALIFIED AND LICENSED PERSONNEL IN ACCORDANCE WITH STATE AND LOCAL GOVERNING AUTHORITIES AND ALL APPLICABLE CODES AND STANDARDS. TYPICAL.
- 6. ALL SERVICE DISRUPTIONS MUST BE SCHEDULED A MINIMUM OF 72 HOURS IN ADVANCE WITH THE OWNER'S REPRESENTATIVE.
- 7. CONTRACTOR SHALL NOT DAMAGE ANY EXISTING EQUIPMENT, PIPING, OR ASSOCIATED ACCESSORIES WHICH ARE TO REMAIN.
- 8. CONTRACTOR SHALL NOT DAMAGE ANY EXISTING ELECTRICAL CONNECTIONS, WIRING AND ASSOCIATED ACCESSORIES WHICH ARE TO REMAIN.
- 9. PROVIDE ALL REQUIRED PENETRATIONS. COORDINATE WITH EXISTING STRUCTURAL ELEMENTS. FIRE STOP ALL PENETRATIONS. TYPICAL

 10. ROUTING OF ALL PIPING/DUCTWORK SHALL BE COORDINATED WITH
- ROUTING OF ALL PIPING/DUCTWORK SHALL BE COORDINATED WITH EXISTING/PROPOSED CONDITIONS, STRUCTURAL FRAMING ELEMENTS AND ALL OTHER PROJECT DISCIPLINES. TYPICAL
 PROVIDE VOLUME DAMPERS AT EACH SUPPLY BRANCH AND MAIN RETURN DUCTS. TYPICAL.

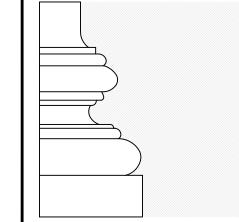

EVELYN COLE SMITH ARCHITECTS, LLC PO Box 182

134 Main St Putnam, CT 06260 860 315 9570

www.ecsarchitects.com

STAMP

CONSULTAN

& ASSOCIATES, P.C.

SALAMONE

CONSULTING ENGINEERS

116 North Plains Industrial Road
Wallingford, Connecticut 06492
hone: (203) 281-6895 Fax: (203) 287-8728

PROJECT

Proposed Commercial Kitchen

EASTCONN 376 Hartford Turnnike

376 Hartford Turnpike Hampton, CT 06247

Prepared for

EASTCONN 376 Hartford Turnpike

Hampton, CT 06247

REVISIONS

	Date	Description
	SH	EET TITLE

Roof Mechanical Plan

PROJ. NO. 2018048

SCALE AS NOTED

DATE APRIL, 2019


DESIGNED ST

DRAWN ST


CHECKED JAS

SHEET


M-2

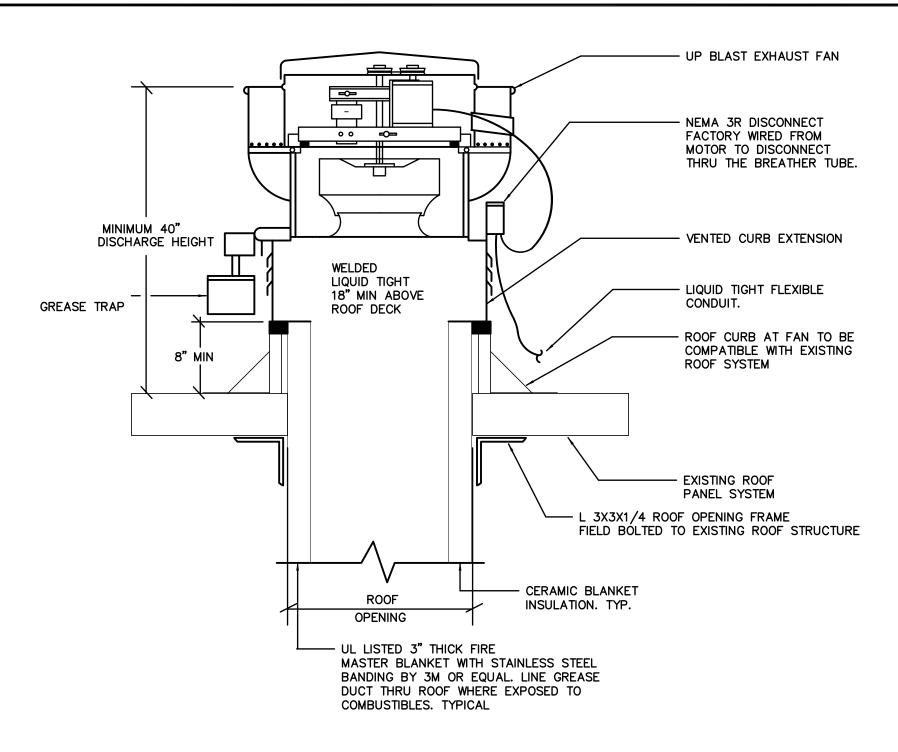

KITCHEN GREASE EXHAUST FAN DETAIL

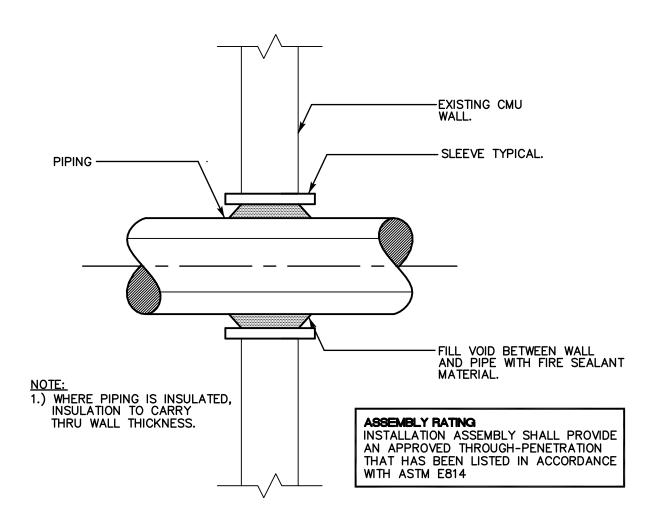

TYPICAL WALL PIPE PENETRATION FIRE STOPPING DETAIL

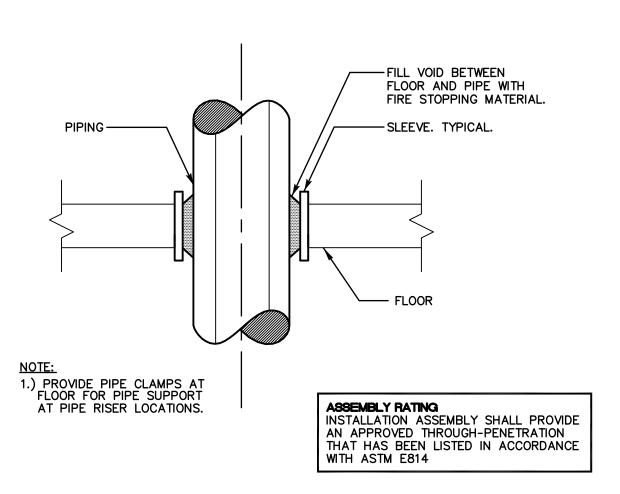

TYPICAL FLOOR PIPE PENETRATION FIRE STOPPING DETAIL

 INSTALL PER ALL APPLICABLE CODES MAKE UP AIR UNITS SHALL BE SUPP ACCESSORIES: A. SUPPLY FAN VFD B. HEATING/COOLING INLET SENSOR C. FREEZE PROTECTION 						
LOCATION SUPPLY AIR FLOW (CFM) 4,7 MIN. SUPPLY AIR FLOW (CFM) OUTSIDE AIR FLOW (CFM) 7,0 TOTAL STATIC PRESSURE FAN MOTOR HP COOLING COIL (TOTAL MBH) 14,0 IEER ARI REFRIGERANT TYPE HEATING TYPE HEATING INPUT (MBH) HEATING OUTPUT (MBH) LOCAL NEMA 3R DISCONNECT ELECTRICAL CHARA. (V/PH/HZ) APPROXIMATE UNIT WEIGHT (LBS) DESIGN BASED MODEL DESIGN BASED MANUFACTURER NOTES: 1. SEE SPECIFICATIONS/DRAWINGS FOR 2. INSTALL PER ALL APPLICABLE CODES 3. MAKE UP AIR UNITS SHALL BE SUPPACCESSORIES: A. SUPPLY FAN VFD B. HEATING/COOLING INLET SENSOR C. FREEZE PROTECTION						
SUPPLY AIR FLOW (CFM) MIN. SUPPLY AIR FLOW (CFM) OUTSIDE AIR FLOW (CFM) TOTAL STATIC PRESSURE FAN MOTOR HP COOLING COIL (TOTAL MBH) IEER ARI REFRIGERANT TYPE HEATING TYPE HEATING INPUT (MBH) LOCAL NEMA 3R DISCONNECT ELECTRICAL CHARA. (V/PH/HZ) APPROXIMATE UNIT WEIGHT (LBS) DESIGN BASED MODEL DESIGN BASED MANUFACTURER NOTES: 1. SEE SPECIFICATIONS/DRAWINGS FOR 2. INSTALL PER ALL APPLICABLE CODES 3. MAKE UP AIR UNITS SHALL BE SUPP ACCESSORIES: A. SUPPLY FAN VFD B. HEATING/COOLING INLET SENSOR C. FREEZE PROTECTION						
MIN. SUPPLY AIR FLOW (CFM) OUTSIDE AIR FLOW (CFM) TOTAL STATIC PRESSURE FAN MOTOR HP COOLING COIL (TOTAL MBH) IEER AII REFRIGERANT TYPE HEATING TYPE HEATING INPUT (MBH) LOCAL NEMA 3R DISCONNECT ELECTRICAL CHARA. (V/PH/HZ) APPROXIMATE UNIT WEIGHT (LBS) DESIGN BASED MODEL DESIGN BASED MANUFACTURER NOTES: 1. SEE SPECIFICATIONS/DRAWINGS FOR 2. INSTALL PER ALL APPLICABLE CODES 3. MAKE UP AIR UNITS SHALL BE SUPP ACCESSORIES: A. SUPPLY FAN VFD B. HEATING/COOLING INLET SENSOR C. FREEZE PROTECTION						
OUTSIDE AIR FLOW (CFM) TOTAL STATIC PRESSURE FAN MOTOR HP COOLING COIL (TOTAL MBH) IEER ARI REFRIGERANT TYPE HEATING TYPE HEATING INPUT (MBH) LOCAL NEMA 3R DISCONNECT ELECTRICAL CHARA. (V/PH/HZ) APPROXIMATE UNIT WEIGHT (LBS) DESIGN BASED MODEL NOTES: 1. SEE SPECIFICATIONS/DRAWINGS FOR 2. INSTALL PER ALL APPLICABLE CODES 3. MAKE UP AIR UNITS SHALL BE SUPP ACCESSORIES: A. SUPPLY FAN VFD B. HEATING/COOLING INLET SENSOR C. FREEZE PROTECTION						
TOTAL STATIC PRESSURE FAN MOTOR HP COOLING COIL (TOTAL MBH) IEER © ARI REFRIGERANT TYPE HEATING TYPE HEATING INPUT (MBH) LOCAL NEMA 3R DISCONNECT ELECTRICAL CHARA. (V/PH/HZ) APPROXIMATE UNIT WEIGHT (LBS) DESIGN BASED MODEL NOTES: 1. SEE SPECIFICATIONS/DRAWINGS FOR 2. INSTALL PER ALL APPLICABLE CODES 3. MAKE UP AIR UNITS SHALL BE SUPP ACCESSORIES: A. SUPPLY FAN VFD B. HEATING/COOLING INLET SENSOR C. FREEZE PROTECTION						
FAN MOTOR HP COOLING COIL (TOTAL MBH) IEER ARI REFRIGERANT TYPE HEATING TYPE HEATING INPUT (MBH) LOCAL NEMA 3R DISCONNECT ELECTRICAL CHARA. (V/PH/HZ) APPROXIMATE UNIT WEIGHT (LBS) DESIGN BASED MODEL DESIGN BASED MANUFACTURER NOTES: 1. SEE SPECIFICATIONS/DRAWINGS FOR 2. INSTALL PER ALL APPLICABLE CODES 3. MAKE UP AIR UNITS SHALL BE SUPP ACCESSORIES: A. SUPPLY FAN VFD B. HEATING/COOLING INLET SENSOR C. FREEZE PROTECTION						
COOLING COIL (TOTAL MBH) IEER © ARI REFRIGERANT TYPE HEATING TYPE HEATING INPUT (MBH) LOCAL NEMA 3R DISCONNECT ELECTRICAL CHARA. (V/PH/HZ) APPROXIMATE UNIT WEIGHT (LBS) DESIGN BASED MODEL DESIGN BASED MANUFACTURER 1. SEE SPECIFICATIONS/DRAWINGS FOR 2. INSTALL PER ALL APPLICABLE CODES 3. MAKE UP AIR UNITS SHALL BE SUPP ACCESSORIES: A. SUPPLY FAN VFD B. HEATING/COOLING INLET SENSOR C. FREEZE PROTECTION						
IEER @ ARI REFRIGERANT TYPE HEATING TYPE HEATING INPUT (MBH) LOCAL NEMA 3R DISCONNECT ELECTRICAL CHARA. (V/PH/HZ) APPROXIMATE UNIT WEIGHT (LBS) DESIGN BASED MODEL NOTES: 1. SEE SPECIFICATIONS/DRAWINGS FOR 2. INSTALL PER ALL APPLICABLE CODES 3. MAKE UP AIR UNITS SHALL BE SUPP ACCESSORIES: A. SUPPLY FAN VFD B. HEATING/COOLING INLET SENSOR C. FREEZE PROTECTION						
REFRIGERANT TYPE HEATING TYPE HEATING INPUT (MBH) LOCAL NEMA 3R DISCONNECT ELECTRICAL CHARA. (V/PH/HZ) APPROXIMATE UNIT WEIGHT (LBS) DESIGN BASED MODEL NOTES: 1. SEE SPECIFICATIONS/DRAWINGS FOR 2. INSTALL PER ALL APPLICABLE CODES 3. MAKE UP AIR UNITS SHALL BE SUPP ACCESSORIES: A. SUPPLY FAN VFD B. HEATING/COOLING INLET SENSOR C. FREEZE PROTECTION						
HEATING TYPE HEATING INPUT (MBH) HEATING OUTPUT (MBH) LOCAL NEMA 3R DISCONNECT ELECTRICAL CHARA. (V/PH/HZ) APPROXIMATE UNIT WEIGHT (LBS) DESIGN BASED MODEL DESIGN BASED MANUFACTURER NOTES: 1. SEE SPECIFICATIONS/DRAWINGS FOR 2. INSTALL PER ALL APPLICABLE CODES 3. MAKE UP AIR UNITS SHALL BE SUPP ACCESSORIES: A. SUPPLY FAN VFD B. HEATING/COOLING INLET SENSOR C. FREEZE PROTECTION						
HEATING INPUT (MBH) HEATING OUTPUT (MBH) LOCAL NEMA 3R DISCONNECT ELECTRICAL CHARA. (V/PH/HZ) APPROXIMATE UNIT WEIGHT (LBS) DESIGN BASED MODEL DESIGN BASED MANUFACTURER 1. SEE SPECIFICATIONS/DRAWINGS FOR 2. INSTALL PER ALL APPLICABLE CODES 3. MAKE UP AIR UNITS SHALL BE SUPP ACCESSORIES: A. SUPPLY FAN VFD B. HEATING/COOLING INLET SENSOR C. FREEZE PROTECTION						
HEATING OUTPUT (MBH) LOCAL NEMA 3R DISCONNECT ELECTRICAL CHARA. (V/PH/HZ) APPROXIMATE UNIT WEIGHT (LBS) DESIGN BASED MODEL XIG DESIGN BASED MANUFACTURER ACC NOTES: 1. SEE SPECIFICATIONS/DRAWINGS FOR 2. INSTALL PER ALL APPLICABLE CODES 3. MAKE UP AIR UNITS SHALL BE SUPP ACCESSORIES: A. SUPPLY FAN VFD B. HEATING/COOLING INLET SENSOR C. FREEZE PROTECTION						
LOCAL NEMA 3R DISCONNECT ELECTRICAL CHARA. (V/PH/HZ) 208 APPROXIMATE UNIT WEIGHT (LBS) 3,0 DESIGN BASED MODEL XIG DESIGN BASED MANUFACTURER ACC NOTES: 1. SEE SPECIFICATIONS/DRAWINGS FOR 2. INSTALL PER ALL APPLICABLE CODES 3. MAKE UP AIR UNITS SHALL BE SUPP ACCESSORIES: A. SUPPLY FAN VFD B. HEATING/COOLING INLET SENSOR C. FREEZE PROTECTION						
ELECTRICAL CHARA. (V/PH/HZ) 208 APPROXIMATE UNIT WEIGHT (LBS) 3,0 DESIGN BASED MODEL XIG DESIGN BASED MANUFACTURER ACC NOTES: 1. SEE SPECIFICATIONS/DRAWINGS FOR 2. INSTALL PER ALL APPLICABLE CODES 3. MAKE UP AIR UNITS SHALL BE SUPP ACCESSORIES: A. SUPPLY FAN VFD B. HEATING/COOLING INLET SENSOR C. FREEZE PROTECTION						
APPROXIMATE UNIT WEIGHT (LBS) 3,0 DESIGN BASED MODEL XIG DESIGN BASED MANUFACTURER ACC NOTES: 1. SEE SPECIFICATIONS/DRAWINGS FOR 2. INSTALL PER ALL APPLICABLE CODES 3. MAKE UP AIR UNITS SHALL BE SUPP ACCESSORIES: A. SUPPLY FAN VFD B. HEATING/COOLING INLET SENSOR C. FREEZE PROTECTION						
DESIGN BASED MODEL XIG DESIGN BASED MANUFACTURER ACC NOTES: 1. SEE SPECIFICATIONS/DRAWINGS FOR 2. INSTALL PER ALL APPLICABLE CODES 3. MAKE UP AIR UNITS SHALL BE SUPP ACCESSORIES: A. SUPPLY FAN VFD B. HEATING/COOLING INLET SENSOR C. FREEZE PROTECTION						
DESIGN BASED MANUFACTURER NOTES: 1. SEE SPECIFICATIONS/DRAWINGS FOR 2. INSTALL PER ALL APPLICABLE CODES 3. MAKE UP AIR UNITS SHALL BE SUPP ACCESSORIES: A. SUPPLY FAN VFD B. HEATING/COOLING INLET SENSOR C. FREEZE PROTECTION						
NOTES: 1. SEE SPECIFICATIONS/DRAWINGS FOR 2. INSTALL PER ALL APPLICABLE CODES 3. MAKE UP AIR UNITS SHALL BE SUPP ACCESSORIES: A. SUPPLY FAN VFD B. HEATING/COOLING INLET SENSOR C. FREEZE PROTECTION						
 SEE SPECIFICATIONS/DRAWINGS FOR INSTALL PER ALL APPLICABLE CODES MAKE UP AIR UNITS SHALL BE SUPP ACCESSORIES: SUPPLY FAN VFD HEATING/COOLING INLET SENSOR FREEZE PROTECTION 						
NOTES: 1. SEE SPECIFICATIONS/DRAWINGS FOR FURTHER REQUIREMENTS. 2. INSTALL PER ALL APPLICABLE CODES AND MANUFACTURES INSTALLATION INSTRUCTIONS. 3. MAKE UP AIR UNITS SHALL BE SUPPLIED WITH THE FOLLOWING FACTORY SUPPLIED ACCESSORIES: A. SUPPLY FAN VFD B. HEATING/COOLING INLET SENSOR						

EXHA	UST FAN S	CHEDULE	
EXHAUST FAN NO.	EF-1	EF-2	EF-3
SERVICE	GH-1	DISHWASHER	JANITOR CL.
LOCATION	ROOF	ROOF	CEILING
AIR FLOW (SCFM)	3,750	1,000	110
EXT. STATIC PRESS. (IWG)	1.474	.961	.375
WHEEL TYPE	CENTRIFUGAL	CENTRIFUGAL	CENTRIFUGAL
WHEEL CONSTRUCTION	ALUMINUM	ALUMINUM	ALUMINUM
DRIVE TYPE	BELT	DIRECT	DIRECT
BEARING TYPE	BALL	BALL	BALL
LUBRICATION TYPE	PERMANENT	PERMANENT	PERMANENT
MOTOR HP/WATTS	2	1/4	24.2
ELECT. CHARAC. (V/PH/HZ)	208/3/60	120/1/60	120/1/60
LOCAL DISCONNECT	YES	YES	YES
HOUSING MATERIAL	GALVANIZED STEEL	GALVANIZED STEEL	GALVANIZED STEEL
BACKDRAFT DAMPER	YES	YES	YES
DESIGN BASED MODEL	XRUB-180-20	XRUD-101-VG	SP-A110-VG
DESIGN BASED MANUFACTURER	ACCUREX	GREENHECK	GREENHECK
NOTES: 1. SEE SPECIFICATIONS/DRAWING 2. INSTALL PER ALL APPLICABLE 3. PROVIDE THE FOLLOWING MAN	CODES AND MANUF	FACTURES INSTALLAT	ION INSTRUCTIONS.

A. MOTOR VFD

B. JUNCTION BOX MOUNTED AND WIRED C. HINGED BASE

D. HIGH TEMP CURB SEAL

E. GREASE TRAP AND CLEAN OUT PORT

F. BIRDSCREEN G. HEAT BAFFEL


PROVIDE THE FOLLOWING MANUFACTURER'S ACCESSORIES FOR EF-2: A. MOTOR VARI-GREEN EC

B. JUNCTION BOX MOUNTED AND WIRED

C. HINGED BASE D. FOAM CURB SEAL

E. GREASE TRAP AND CLEAN OUT PORT F. BIRDSCREEN

KITCHEN (GREASE HOOD SCHEDULE
HOOD NO.	GH-1
SERVICE	KITCHEN EQUIP.
LOCATION	KITCHEN
EXHAUST AIR FLOW (CFM)	3,750
EXT. STATIC PRESS. (IWG)	.851
SUPPLY AIR FLOW (CFM)	3,750
COOKING LOAD	HEAVY
HOOD CONSTRUCTION	304 SS
DESIGN BASED MODEL	XXEW-150.00-S
DESIGN BASED MANUFACTURER	ACCUREX
NOTES:	
	S FOR FURTHER REQUIREMENTS. E CODES AND MANUFACTURES INSTALLATION INSTRUCTIONS.

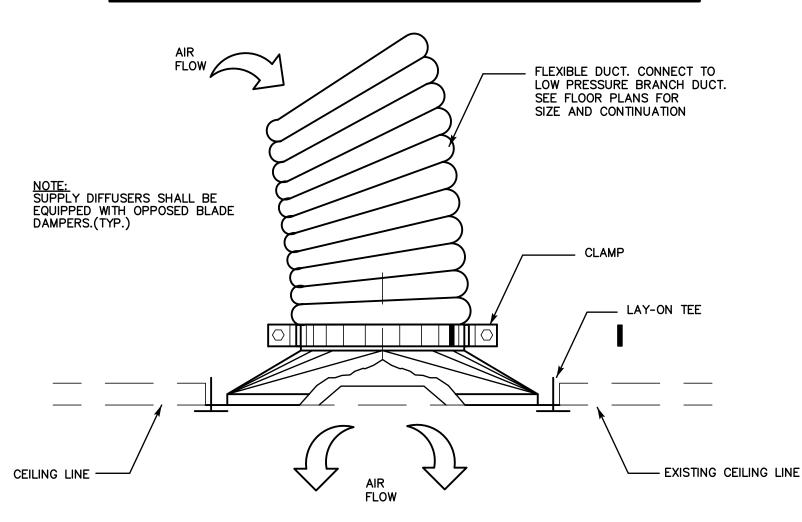

TYPICAL SQUARE DIFFUSER DETAIL SQUARE RETURN GRILLE SIMILAR

MECH	HANICAL ABBREVIATIONS
AD	ACCESS DOOR
AF	AIR FILTER
AFF	ABOVE FINISHED FLOOR
AHU	AIR HANDLING UNIT
AMP	AMPERE
BDD	BACK DRAFT DAMPER
BHP	BRAKE HORSE POWER
BTU	BRITISH THERMAL UNIT
BTUH	BRITISH THERMAL UNIT/HOUR
CENTRIF	CENTRIFUGAL
CFM	CUBIC FEET PER MINUTE
DB	DRY BULB
EAT	ENTERING AIR TEMPERATURE
EF	EXHAUST FAN
ESP	EXTERNAL STATIC PRESSURE
EXH	EXHAUST
FD	FIRE DAMPER
FFF	FROM FINISHED FLOOR
FPM	FEET PER MINUTE
FPS	FEET PER SECOND
FT	FEET
GPM	GALLONS PER MINUTE
HP	HORSEPOWER
HT	HEIGHT
ID	INSIDE DIAMETER
IN	INCHES
L	LENGTH
LAT	LEAVING AIR TEMPERATURE
LVR	LOUVER
LWT	LEAVING WATER TEMPERATURE
MAX	MAXIMUM
MBH	THOUSAND BTU/HOUR
MIN	MINIMUM
NG	NATURAL GAS
NTS	NOT TO SCALE
OA	OUTSIDE AIR
OBD	OPPOSED BLADE DAMPER
PRV	PRESSURE RELIEF VALVE
PSIA	POUNDS PER SQUARE INCH ABSOLUTE
PSIG	POUNDS PER SQUARE INCH GAUGE
RH	RELATIVE HUMIDITY
RPM	REVOLUTIONS PER MINUTE
SENS	SENSOR
SF	SUPPLY FAN
S	SMOKE DETECTOR
SP	STATIC PRESSURE
TEMP	TEMPERATURE
TONS	TONS OF REFRIGERATION

MECHANICAL GENERAL NOTES 1. REFER TO SPECIFICATIONS AND BID DOCUMENTS FOR ADDITIONAL CONTRACT

2. MECHANICAL DRAWINGS TO BE USED IN CONJUNCTION WITH ARCHITECTURAL, STRUCTURAL, PLUMBING AND ELECTRICAL DRAWINGS. 3. NOTES BELOW ARE NOT INTENDED TO REPLACE SPECIFICATIONS. SEE

SPECIFICATIONS FOR REQUIREMENTS IN ADDITION TO DRAWING NOTES. 4. MECHANICAL DRAWINGS DO NOT NECESSARILY SHOW ALL RELATED WORK CONTRACTOR TO USE ALL DRAWINGS IN CONTRACT DOCUMENTS FOR DIVISION

5. UNLESS OTHERWISE INDICATED, PROVIDE A COMPLETE AND OPERATIONAL MECHANICAL SYSTEM INCLUDING ALL NECESSARY MATERIAL, LABOR AND

6. MECHANICAL PLANS, DETAILS AND ONE LINE DIAGRAMS SHOW THE GENERAL LOCATION AND ARRANGEMENT OF THE SYSTEM. THESE ARE DIAGRAMMATIC AND DO NOT SHOW ALL BENDS, COUPLINGS, OFFSETS, VALVES, DRAINS, FITTINGS, HANGERS, CLEANOUTS AND ACCESS DOORS WHICH THE CONTRACTOR MUST PROVIDE TO COMPLETE THE SYSTEM.

7. PLANS AND DETAILS DO NOT SHOW ALL INTERFERENCES AND CONDITIONS, VISIBLE AND/OR HIDDEN, THAT MAY EXIST; THUS REQUIRING THE CONTRACTOR TO INSPECT AND SURVEY THE SPACE BEFORE PERFORMING THE WORK. BEFORE SELECTING MATERIAL AND EQUIPMENT AND PROCEEDING WITH WORK, INSPECT AREAS WHERE MATERIAL AND EQUIPMENT ARE TO BE INSTALLED TO INSURE SUITABILITY, AND CHECK NEEDED SPACE FOR PLACEMENT AND

CLEARANCES. 9. BEFORE CUTTING OR DRILLING INTO BUILDING ELEMENTS, INSPECT AND LAYOUT WORK TO AVOID DAMAGING STRUCTURAL ELEMENTS AND BUILDING UTILITIES. 10. LOCATE ALL EQUIPMENT WHICH REQUIRES SERVICING IN FULLY ACCESSIBLE POSITIONS. IF REQUIRED FOR BETTER ACCESSIBILITY, FURNISH ACCESS DOORS FOR THAT PURPOSE. MINOR DEVIATIONS FROM DRAWINGS ALLOWED FOR BETTER ACCESSIBILITY. ANY CHANGE SHALL BE SUBMITTED TO THE

OWNER'S REPRESENTATIVE FOR APPROVAL. 1. COORDINATE WORK WITH OTHER DIVISIONS AND SPECIFICATIONS ON THIS

12. ALL WORK IN INTERIOR FINISHED SPACES IS TO BE CONCEALED BEHIND WALLS, ABOVE CEILINGS OR HUNG CEILINGS, OR UNDER THE FLOOR. PROVIDE ALL NECESSARY CUTTING, PATCHING, REPAINTING AND/OR REPLACEMENT OF CEILING TILES AS REQUIRED TO PERFORM WORK.

13. ALL EQUIPMENT REQUIRED TO BE LISTED OR APPROVED BY A TESTING LABORATORY SHALL BEAR A LABEL OF SUCH LABORATORY.

14. THE CONTRACTOR SHALL OBTAIN ALL REQUIRED PERMITS AND ARRANGE FOR ALL REQUIRED INSPECTIONS IN ACCORDANCE WITH STATE AND LOCAL

GOVERNING AUTHORITIES. 15. ALL WORK SHALL BE DONE IN ACCORDANCE WITH THE MOST CURRENT A. CONNECTICUT BASIC BUILDING CODE AND SUPPLEMENTS

B. INTERNATIONAL ENERGY CONSERVATION CODE INTERNATIONAL PLUMBING CODE D. INTERNATIONAL MECHANICAL CODE

E. NATIONAL ELECTRIC CODE 16. IF A MANUFACTURER OF EQUIPMENT REQUIRES LARGER CAPACITY CIRCUITRY AND/OR EQUIPMENT; THE CONTRACTOR SHALL PROVIDE SUCH CAPACITY AND/OR EQUIPMENT UNDER HIS CONTRACT AT NO COST TO THE OWNER.

17. IF A MANUFACTURER OF PROVIDED EQUIPMENT RECOMMENDS ACCESSORY(S)
OR OPTION(S) FOR THE SUPPLIED EQUIPMENT; THE CONTRACTOR SHALL PROVIDE
ACCESSORY(S) OR OPTION(S) UNDER HIS CONTRACT AT NO COST TO THE

18. THE TERM "INDICATED" SHALL MEAN "AS SHOWN ON CONTRACT DOCUMENTS (SPECIFICATIONS, DRAWINGS AND RELATED ATTACHMENTS)". 19. THE TERM "PROVIDE" SHALL MEAN "TO FURNISH, INSTALL AND CONNECT COMPLETELY".

20. ISLE AND CORRIDOR WAYS THROUGH CONSTRUCTION AREAS WHICH ARE REQUIRED FOR EGRESS (NORMAL OR EMERGENCY) SHALL BE KEPT CLEAR OF MATERIAL, EQUIPMENT AND DEBRIS. 21. COORDINATE ALL WORK WITH THE OWNER'S REPRESENTATIVE.

22. PROVIDE ALL CRANES, RIGGING AND STREET STAGING, AND TRAFFIC CONTROL NEEDED TO INSTALL EQUIPMENT PROVIDED.

23. UNLESS OTHERWISE INDICATED, PROVIDE CONTROL WIRING FOR ALL MECHANICAL SYSTEM EQUIPMENT.

24. CONTRACTOR SHALL COORDINATE ELECTRICAL REQUIREMENTS OF MECHANICAL EQUIPMENT WITH DIVISION 16.

25. UNLESS OTHERWISE INDICATED, SUPPORT PIPES WITH HANGER SPACING IN ACCORDANCE WITH THE INTERNATIONAL MECHANICAL CODE.

26. CONTRACTOR SHALL MAKE ADEQUATE PROVISIONS FOR PIPE EXPANSION, CONTRACTION, SLOPE AND ANCHORAGE. 27. CONTRACTOR SHALL INSULATE ALL HVAC SYSTEM PIPING AND DUCTWORK.

28. UNLESS OTHERWISE INDICATED, ALL DUCTWORK, PIPING AND WIRING SHALL BE CONCEALED ABOVE CEILINGS AND/OR IN WALLS.

29. PLANS DO NOT SHOW ALL EQUIPMENT, VALVES, FITTINGS AND CONNECTIONS. SEE PIPING RISER DIAGRAMS, DETAILS, SCHEDULES AND SPECIFICATIONS FOR ADDITIONAL REQUIREMENTS.

ADDITIONAL REQUIREMENTS.

30. SUBMIT FOR REVIEW DETAILED SHOP DRAWINGS FOR ALL EQUIPMENT AND MATERIAL REQUIRED TO COMPLETE THE WORK. NO MATERIAL OR EQUIPMENT MAY BE DELIVERED TO THE JOB SITE OR INSTALLED UNTIL ACCEPTED SHOP DRAWINGS FOR THE PARTICULAR MATERIAL OR EQUIPMENT HAS BEEN APPROVED BY THE OWNER OR HIS AUTHORIZED REPRESENTATIVE WHERE THE CONTRACTOR PROPOSES TO USE AN ITEM OF EQUIPMENT OTHER THAN SPECIFIED OR DETAILED ON THE DRAWINGS, WHICH REQUIRES ANY REDESIGN OF THE STRUCTURE, PARTITIONS, FOUNDATIONS, PIPING, WIRING OR ANY OTHER PART OF THE MECHANICAL, ELECTRICAL OR ARCHITECTURAL LAYOUT ALL SUCH REDESIGN AND ALL NEW DRAWINGS AND DETAILING REQUIRED THEREFORE, SHALL BE PREPARED AT THE CONTRACTOR'S EXPENSE AND IS SUBJECT TO THE REVIEW AND APPROVAL OF THE OWNER OR HIS AUTHORIZED REPRESENTATIVE. OWNER RESERVES THE RIGHT TO HAVE THE ARCHITECT OR ENGINEER OF HIS CHOICE PREPARE ANY REDESIGN WORK.

. TURN OVER TO THE OWNER ALL MANUFACTURER'S WARRANTIES FOR EQUIPMENT AND MATERIAL PROVIDED.

32. THE CONTRACTOR MAY SUBSTITUTE EQUIPMENT OF ANOTHER MANUFACTURER IF IT IS OF EQUAL QUALITY AND RATING, SUBJECT TO OWNER'S AND ENGINEER'S REVIEW AND ACCEPTANCE. WHERE CONTRACTOR SUBSTITUTES EQUIPMENT REQUIRING DIFFERENT SYSTEM CONFIGURATION, HE SHALL BE RESPONSIBLE FOR PROVIDING INSTALLATION SHOP DRAWINGS AND ALL RELATED ACCESSORY EQUIPMENT FOR A COMPLETE SYSTEM INSTALLATION.

33. ASCERTAIN FROM EXAMINATION OF THE DRAWINGS, ANY SPECIAL TEMPORARY OPENINGS AND STRUCTURAL LOADING IN THE BUILDING REQUIRED FOR THE ADMISSION OF APPARATUS PROVIDED UNDER THIS DIVISION. NOTIFY THE OWNER ACCORDINGLY. CONTRACTOR SHALL BE RESPONSIBLE FOR ALL ASSEMBLY AND DISASSEMBLY OR EQUIPMENT AS REQUIRED TO PLACE EQUIPMENT IN ITS FINAL LOCATIONS.

34. UNLESS OTHERWISE INDICATED, PROVIDE 14 GAUGE GALVANIZED PIPE SLEEVES TWO (2) SIZES LARGER THAN THE PIPE OR INSULATION WHERE SUCH ASSEMBLIES PENETRATE WALLS, PARTITIONS, FLOORS OR STRUCTURAL MEMBERS. 35. ALL VOIDS BETWEEN PIPES SHALL BE FILLED WITH A FIRE TESTED AND

APPROVED ELASTOMERIC CAULKING MATERIAL 36. ALL WORK SHALL BE DONE WITH LICENSED WORKMEN IN ACCORDANCE WITH STATE AND LOCAL GOVERNING AUTHORITIES.

37. PROVIDE DYNAMICALLY RATED FIRE DAMPERS AND ACCESS DOORS AT ALL FIRE RATED ASSEMBLIES. TYPICAL.

EVELYN COLE SMITH ARCHITECTS, LLC PO Box 182 134 Main St Putnam, CT

www.ecsarchitects.com

06260

860 315 9570

STAMP

CONSULTANT

SALAMONE ASSOCIATES, P.C.

CONSULTING ENGINEERS 116 North Plains Industrial Road Wallingford, Connecticut 06492 ione: (203) 281-6895 Fax: (203) 287-8728

PROJECT

Proposed Commercial Kitchen

EASTCONN 376 Hartford Turnpike

Prepared for

EASTCONN 376 Hartford Turnpike

Hampton, CT 06247

Hampton, CT 06247

REVISIONS

Date Description

Mechanical Schedules Details, Notes and Abbreviations

SHEET TITLE

PROJ. NO. 2018048


SCALE AS NOTED DATE APRIL, 2019

DESIGNED ST DRAWN ST

CHECKED JAS

SHEET

M-3

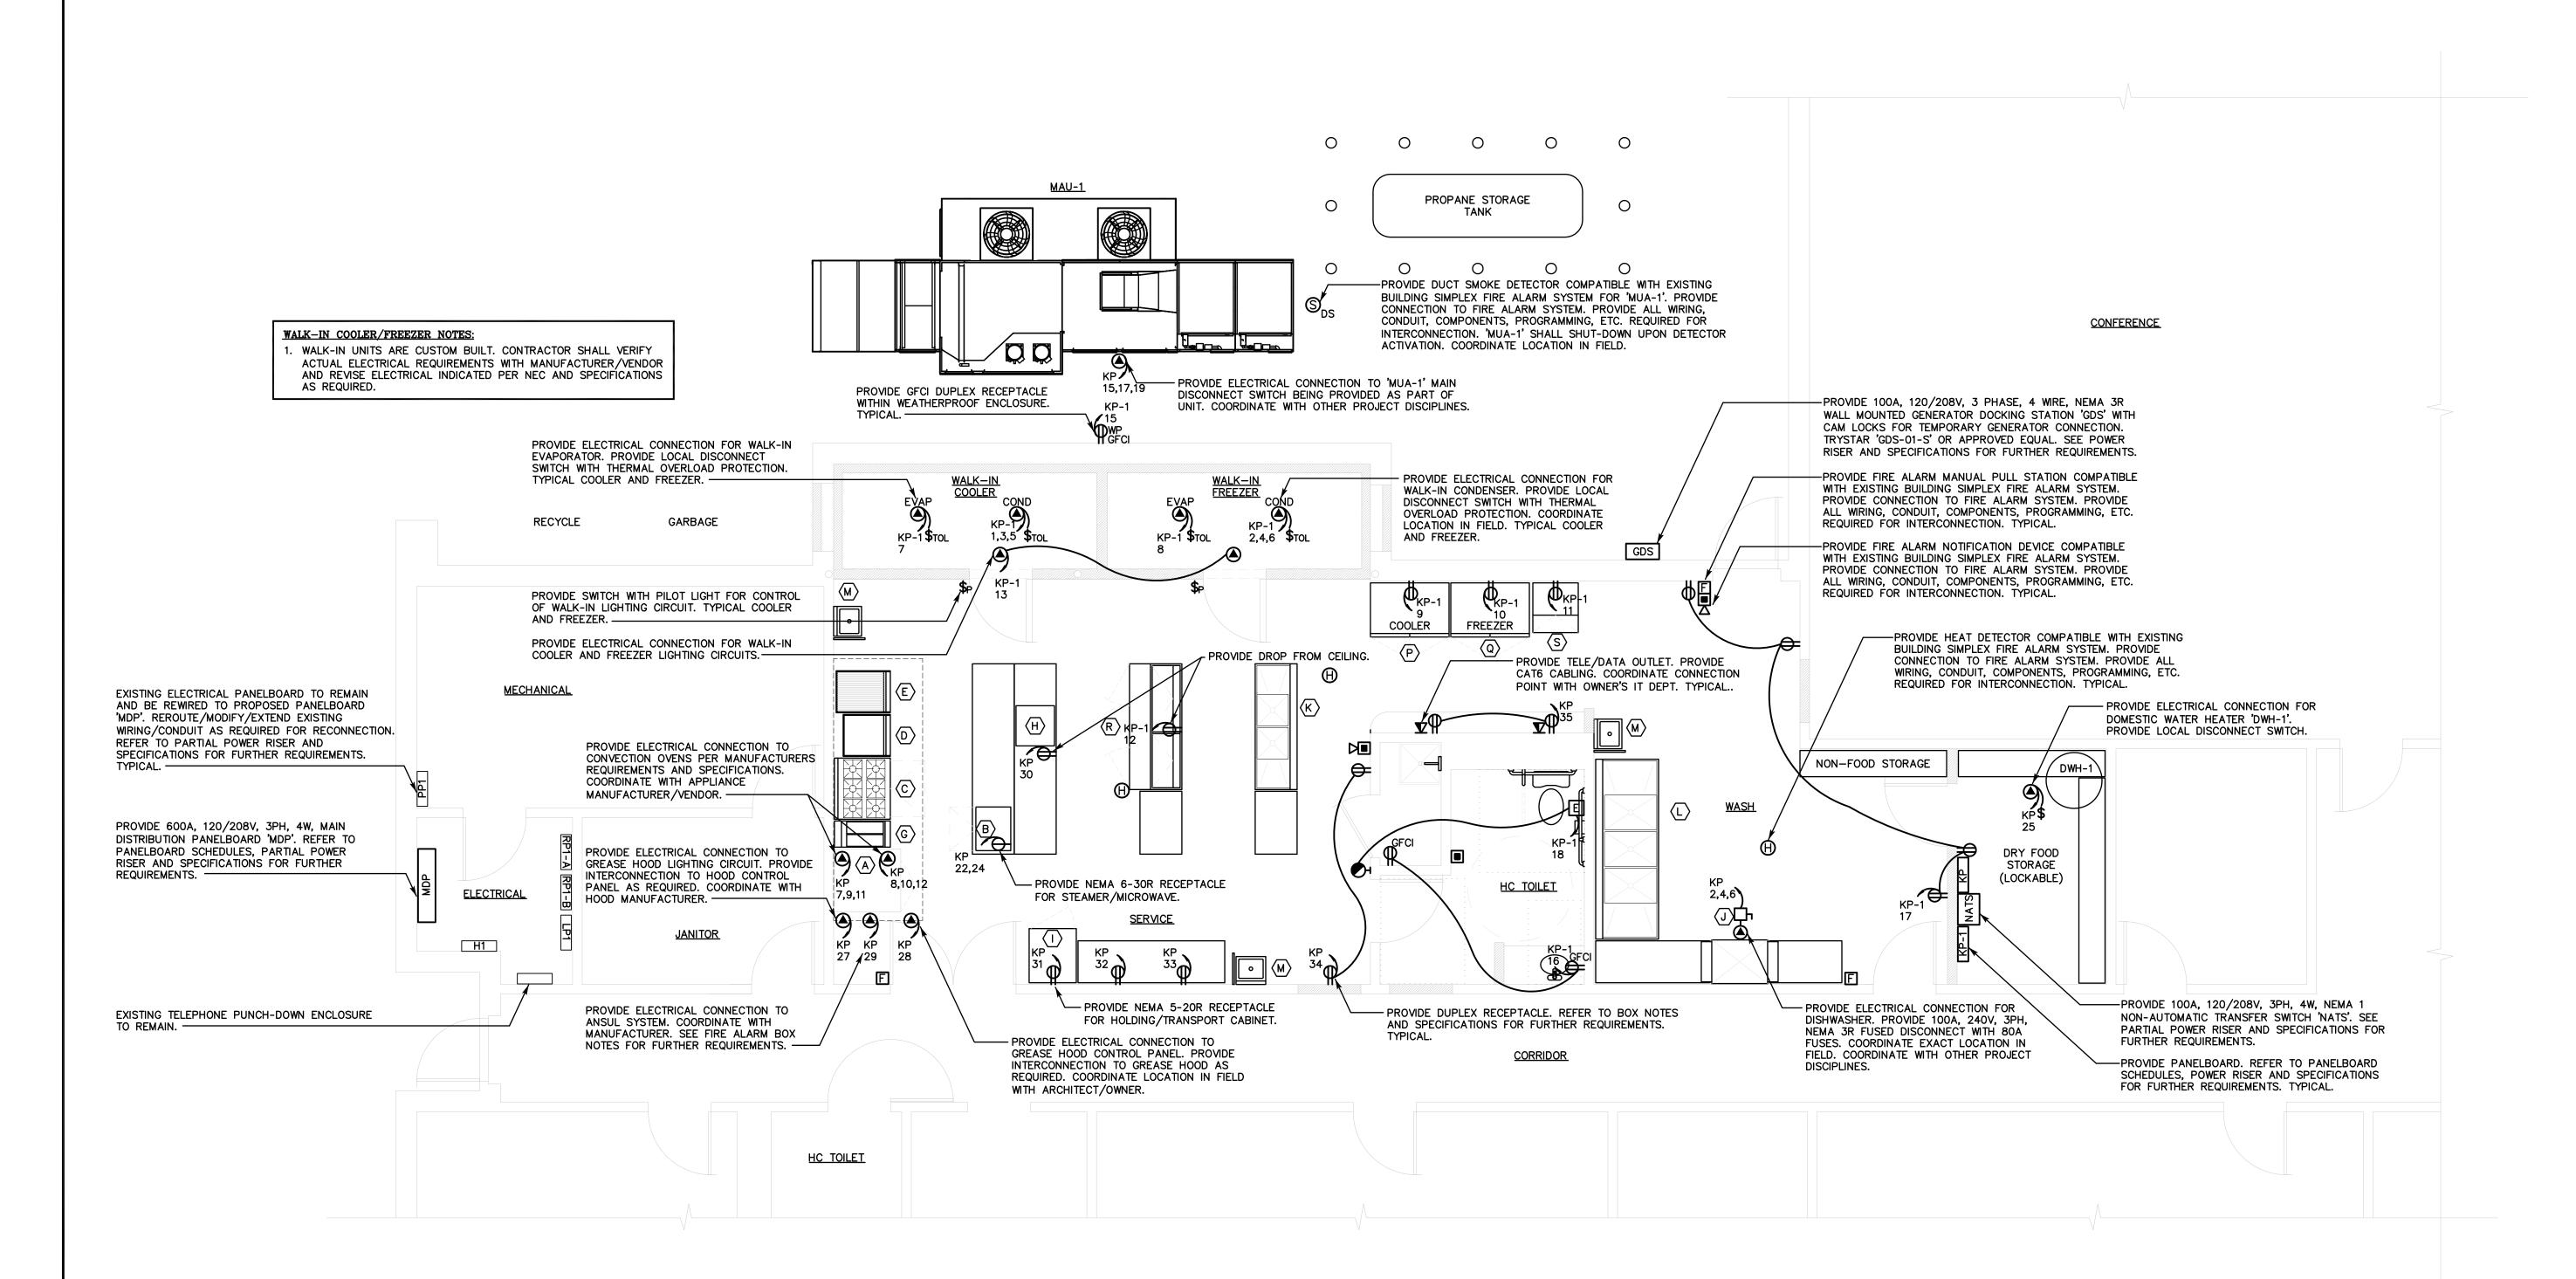

FIRST FLOOR ELECTRICAL PLAN SCALE: 1/4"=1'-0"

'-0"

OTE:

THE CONTRACTOR(S) SHALL VISIT THE PROJECT SITE PRIOR TO BIDDING, NOTING EXISTING CONDITIONS AND EQUIPMENT. IF SAID EQUIPMENT IS NOT BEING REMOVED AS PART OF PROJECT OR IS NOTED AS EXISTING TO REMAIN AND IMPEDES PROVIDING PROPOSED EQUIPMENT AND/OR PROVIDING PROPOSED SCOPE OF WORK. EQUIPMENT SHALL BE TEMPORARY RELOCATED AND COMPLETELY REINSTALLED AFTER PROPOSED SCOPE OF WORK IS COMPLETED. THIS SHALL BE PART OF BASE BID AND CONTRACTOR'S SHALL BID ACCORDINGLY, NO ADDITIONAL COMPENSATION WILL BE CONSIDERED FOR RELATED WORK OR COORDINATION WITH EXISTING CONDITIONS.

SECURITY SYSTEM NOTES:

CONTRACTOR SHALL PROVIDE OUTLET BOXES, CONDUIT AND CABLING FOR ONE (1) DOOR CONTACT AND THREE (3) MOTION DETECTORS FOR SECURITY SYSTEM FROM RESPECTIVE DEVICE BACK TO SECURITY SYSTEM PANEL. COORDINATE LOCATIONS AND REQUIREMENTS WITH OWNER/ARCHITECT.

VIDEO SURVEILLANCE NOTES:

CONTRACTOR SHALL PROVIDE OUTLET BOXES, CONDUIT AND CABLING FOR FOUR (4) VIDEO SURVEILLANCE CAMERAS FROM RESPECTIVE VIDEO CAMERA LOCATION TO NETWORK VIDEO RECORDER. COORDINATE LOCATIONS AND REQUIREMENTS WITH OWNER/ARCHITECT.

FIRE ALARM NOTES:


- PROVIDE CONNECTION OF PROPOSED ANSUL SYSTEM TO EXISTING SIMPLEX FIRE ALARM CONTROL PANEL (FACP). PROVIDE ALL ASSOCIATED WIRING, CONDUIT, PROGRAMMING, MODULES, RELAYS, ETC. REQUIRED.
- 2. PROVIDE INTERCONNECTIONS FOR PROPOSED EXHAUST FAN FOR HOOD AND MAKE-UP AIR UNIT TO ANSUL SYSTEM. UPON ACTIVATION OF ANSUL SYSTEM MAKE-UP AIR UNIT SHALL SHUT DOWN. EXHAUST FAN SHALL RUN UNLESS OTHERWISE DIRECTED BY FIRE MARSHAL. CONTRACTOR SHALL COORDINATE WITH FIRE MARSHAL. PROVIDE ALL ASSOCIATED WIRING, CONDUIT, PROGRAMMING, MODULES, RELAYS, ETC.
- B. PROVIDE INTERCONNECTIONS BETWEEN HOOD ANSUL SYSTEM AND SHUNT TRIP CIRCUIT BREAKERS FOR CONVECTION OVEN AND 'MUA-1'. ANSUL SYSTEM SHALL SHUNT TRIP BOTH CIRCUIT BREAKERS UPON ACTIVATION. PROVIDE ALL ASSOCIATED WIRING, CONDUIT, PROGRAMMING, MODULES, RELAYS, ETC. REQUIRED.
- 4. PROVIDE INTERCONNECTION BETWEEN ANSUL SYSTEM AND EMERGENCY LP GAS SHUT-OFF FOR GAS EQUIPMENT UNDER HOOD. UPON ANSUL SYSTEM ACTIVATION GAS SHUT-OFF SHALL SHUT. PROVIDE ALL ASSOCIATED WIRING, CONDUIT, PROGRAMMING, MODULES, RELAYS, ETC. REQUIRED. COORDINATE WITH OTHER PROJECT DISCIPLINES.
- 5. PROVIDE ALL ASSOCIATED WIRING, CONDUIT, PROGRAMMING, MODULES, RELAYS, ETC. REQUIRED FOR A COMPLETE AND FULLY FUNCTIONAL SYSTEM.

ELECTRICAL NOTES:

- . THE CONTRACTOR SHALL BE RESPONSIBLE FOR ALL WORK INCLUDING TOOLS, MATERIAL, MANPOWER, ETC. REQUIRED FOR COMPLETE AND PROPER INSTALLATION OF PROPOSED MATERIALS, FIXTURES AND/OR EQUIPMENT.
- DRAWINGS ARE DIAGRAMMATIC. CONTRACTOR SHALL VERIFY ALL LOCATIONS, QUANTITIES AND DIMENSIONS OF PROPOSED MATERIALS, FIXTURES AND/OR EQUIPMENT WITHIN AND AFFECTING PROJECT SCOPE OF WORK.
- 3. ALL WORK SHALL BE PERFORMED IN A SAFE AND ORDERLY MANNER WITH QUALIFIED AND LICENSED PERSONNEL IN ACCORDANCE WITH STATE AND LOCAL GOVERNING AUTHORITIES AND ALL APPLICABLE CODES AND STANDARDS. TYPICAL.
- 4. ROUTING OF ALL CONDUIT SHALL BE COORDINATED WITH EXISTING CONDITIONS, STRUCTURAL FRAMING ELEMENTS AND ALL OTHER PROJECT DISCIPLINES. TYPICAL
- 5. BUILDINGS WILL BE OCCUPIED DURING ALL PHASES OF CONSTRUCTION. ALL WORK WILL BE PERFORMED CAUSING MINIMAL DISRUPTION TO THE FACILITY. CONTAIN AND CONTROL CONSTRUCTION DEBRIS SO AS NOT TO INTERFERE WITH DAILY OPERATION OF BUILDING. KEEP EGRESS PATHS FREE AND CLEAR
- OPERATION OF BUILDING. KEEP EGRESS PATHS FREE AND CLEAR OF ANY OBSTRUCTIONS.

 7. ALL SERVICE DISRUPTIONS MUST BE SCHEDULED A MINIMUM OF 72 HOURS IN ADVANCE WITH THE OWNER'S REPRESENTATIVE.
- CONTRACTOR SHALL NOT DAMAGE ANY EXISTING EQUIPMENT, PIPING, OR ASSOCIATED ACCESSORIES WHICH ARE TO REMAIN.

 PROVIDE ALL REQUIRED PENETRATIONS. COORDINATE WITH EXISTING
- STRUCTURAL ELEMENTS. FIRE STOP ALL PENETRATIONS. TYPICAL INSTALL ALL EQUIPMENT AND ASSOCIATED ACCESSORIES PER NEC AND MANUFACTURER'S REQUIREMENTS.

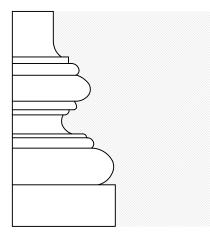

EVELYN COLE SMITH ARCHITECTS, LLC PO Box 182 134 Main St

Putnam, CT

860 315 9570

www.ecsarchitects.com

STAMP

CONSULTANT

SALAMONE & ASSOCIATES, P.C.

CONSULTING ENGINEERS

116 North Plains Industrial Road
Wallingford, Connecticut 06492
Phone: (203) 281-6895 Fax: (203) 287-8728

PROJECT

Proposed Commercial Kitchen

EASTCONN
376 Hartford Turnpike

Prepared for

EASTCONN 376 Hartford Turnpike Hampton, CT 06247

Hampton, CT 06247

REVISIONS

Date Description

First Floor Electrical

Plan

SHEET TITLE

PROJ. NO. 2018048

SCALE AS NOTED


DATE APRIL, 2019

DESIGNED FB

DRAWN FB

CHECKED JAS
SHEET

E-1

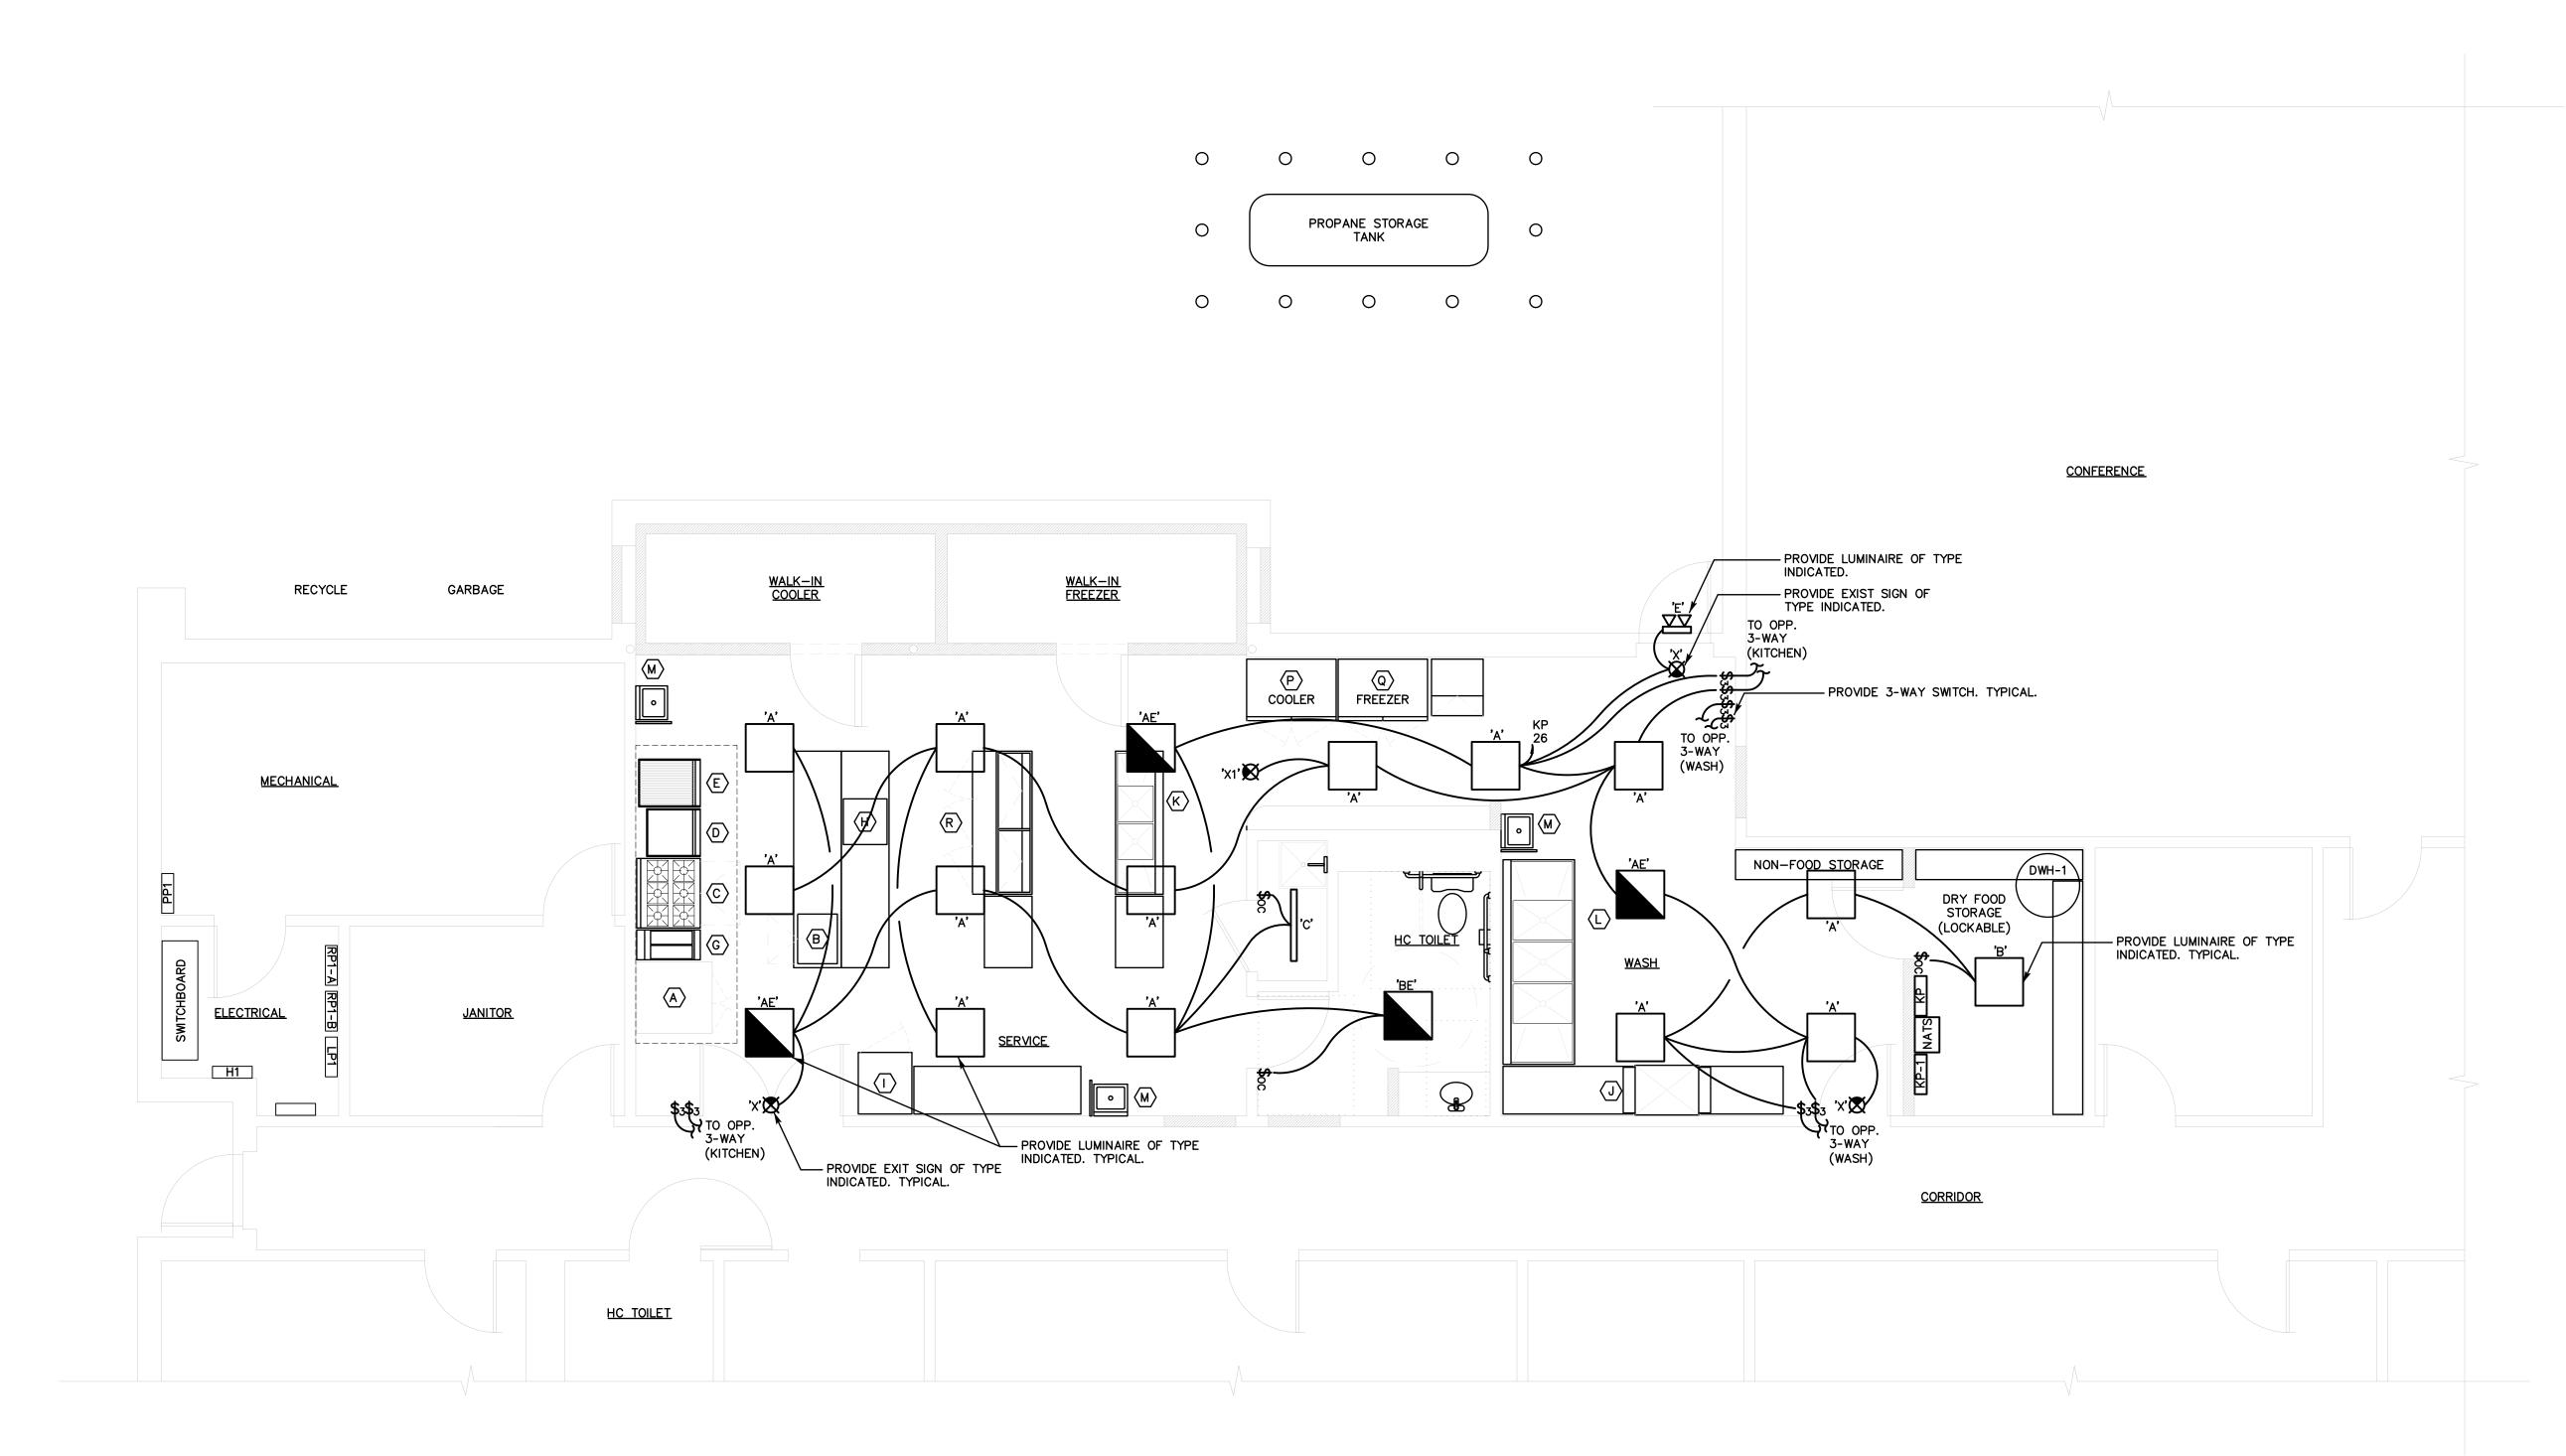

FIRST FLOOR LIGHTING PLAN
SCALE: 1/4"=1'-0"



THE CONTRACTOR(S) SHALL VISIT THE PROJECT SITE PRIOR TO BIDDING, NOTING EXISTING CONDITIONS AND EQUIPMENT. IF SAID EQUIPMENT IS NOT BEING REMOVED AS PART OF PROJECT OR IS NOTED AS EXISTING TO REMAIN AND IMPEDES PROVIDING PROPOSED EQUIPMENT AND/OR PROVIDING PROPOSED SCOPE OF WORK. EQUIPMENT SHALL BE TEMPORARY RELOCATED AND COMPLETELY REINSTALLED AFTER PROPOSED SCOPE OF WORK IS COMPLETED. THIS SHALL BE PART OF BASE BID AND CONTRACTOR'S SHALL BID ACCORDINGLY, NO ADDITIONAL COMPENSATION WILL BE CONSIDERED FOR RELATED WORK OR COORDINATION WITH EXISTING CONDITIONS.

ELECTRICAL NOTES:

- 1. THE CONTRACTOR SHALL BE RESPONSIBLE FOR ALL WORK INCLUDING TOOLS, MATERIAL, MANPOWER, ETC. REQUIRED FOR COMPLETE AND PROPER INSTALLATION OF PROPOSED MATERIALS, FIXTURES AND/OR EQUIPMENT.
- 2. DRAWINGS ARE DIAGRAMMATIC. CONTRACTOR SHALL VERIFY ALL LOCATIONS, QUANTITIES AND DIMENSIONS OF PROPOSED MATERIALS, FIXTURES AND/OR EQUIPMENT WITHIN AND AFFECTING PROJECT SCOPE OF WORK.
- 3. ALL WORK SHALL BE PERFORMED IN A SAFE AND ORDERLY MANNER WITH QUALIFIED AND LICENSED PERSONNEL IN ACCORDANCE WITH STATE AND LOCAL GOVERNING AUTHORITIES AND ALL APPLICABLE CODES AND STANDARDS. TYPICAL.
- 4. ROUTING OF ALL CONDUIT SHALL BE COORDINATED WITH EXISTING CONDITIONS, STRUCTURAL FRAMING ELEMENTS AND ALL OTHER PROJECT DISCIPLINES. TYPICAL
- . BUILDINGS WILL BE OCCUPIED DURING ALL PHASES OF CONSTRUCTION. ALL WORK WILL BE PERFORMED CAUSING MINIMAL DISRUPTION TO THE FACILITY. CONTAIN AND CONTROL CONSTRUCTION DEBRIS SO AS NOT TO INTERFERE WITH DAILY OPERATION OF BUILDING. KEEP EGRESS PATHS FREE AND CLEAR OF ANY OBSTRUCTIONS.
- ALL SERVICE DISRUPTIONS MUST BE SCHEDULED A MINIMUM OF 72 HOURS IN ADVANCE WITH THE OWNER'S REPRESENTATIVE. 8. CONTRACTOR SHALL NOT DAMAGE ANY EXISTING EQUIPMENT, PIPING, OR ASSOCIATED ACCESSORIES WHICH ARE TO REMAIN.
- PROVIDE ALL REQUIRED PENETRATIONS. COORDINATE WITH EXISTING STRUCTURAL ELEMENTS. FIRE STOP ALL PENETRATIONS. TYPICAL
 - INSTALL ALL EQUIPMENT AND ASSOCIATED ACCESSORIES PER NEC AND MANUFACTURER'S REQUIREMENTS.

EVELYN COLE SMITH ARCHITECTS, LLC PO Box 182 134 Main St

860 315 9570

Putnam, CT 06260

www.ecsarchitects.com

STAMP

SALAMONE

CONSULTANT

ASSOCIATES, P.C. CONSULTING ENGINEERS

116 North Plains Industrial Road Wallingford, Connecticut 06492 one: (203) 281-6895 Fax: (203) 287-8728

Proposed Commercial Kitchen

376 Hartford Turnpike

Hampton, CT 06247

PROJECT

EASTCONN

Prepared for

EASTCONN 376 Hartford Turnpike Hampton, CT 06247

REVISIONS Description Date

First Floor Lighting Plan

SHEET TITLE


PROJ. NO. 2018048

SCALE AS NOTED DATE APRIL, 2019

DESIGNED FB


DRAWN FB CHECKED JAS

SHEET

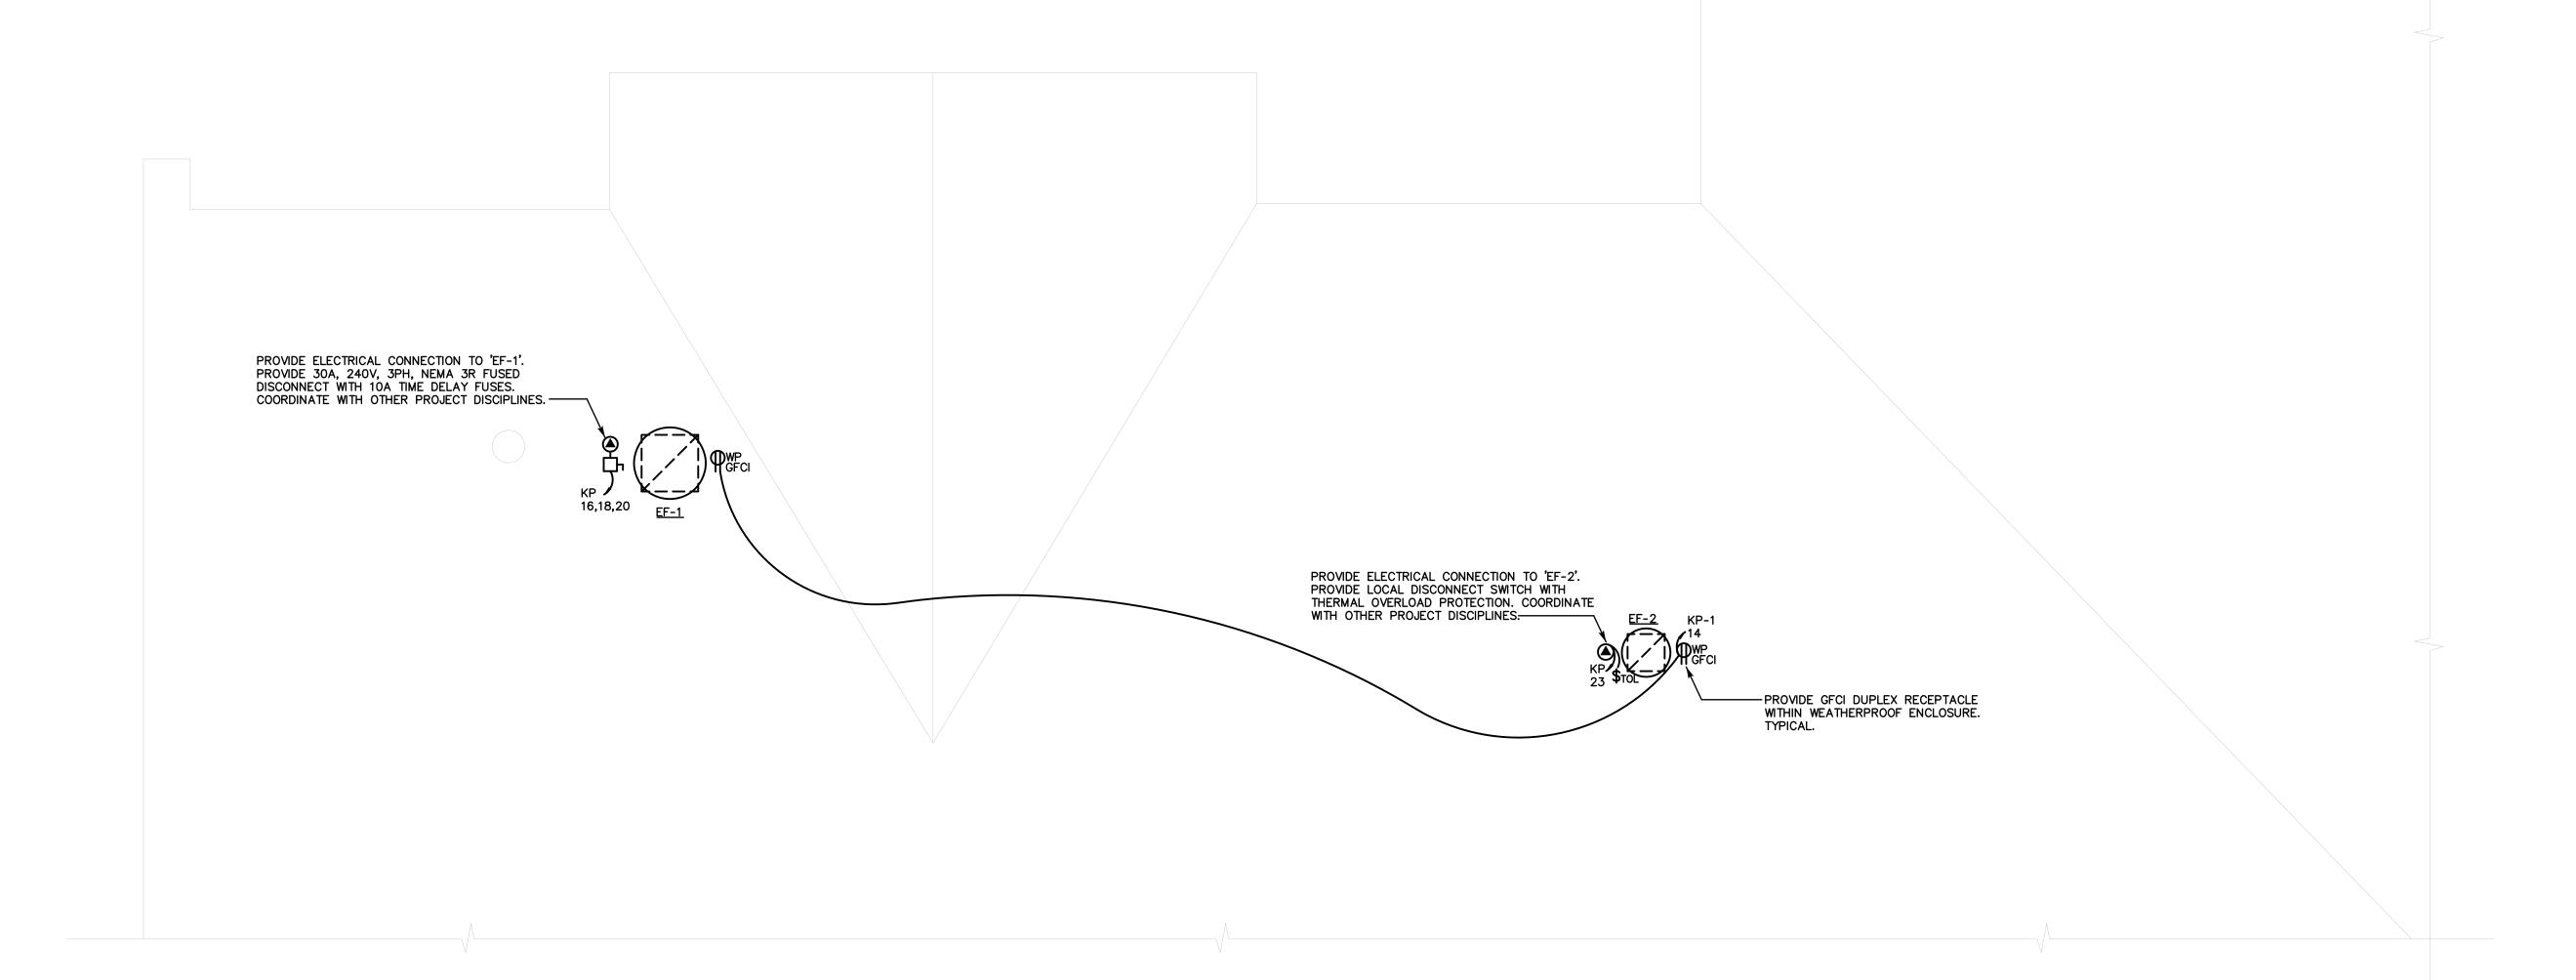

ROOF ELECTRICAL PLAN
SCALE: 1/4"=1'-0"



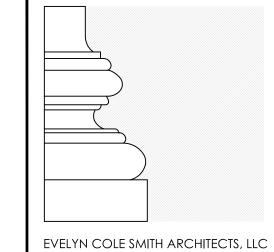

PO Box 182 134 Main St Putnam, CT 06260 860 315 9570

www.ecsarchitects.com

STAMP

CONSULTANT

SALAMONE & ASSOCIATES, P.C.

CONSULTING ENGINEERS

116 North Plains Industrial Road
Wallingford, Connecticut 06492
Phone: (203) 281-6895 Fax: (203) 287-8728

PROJECT

Proposed Commercial Kitchen

EASTCONN 376 Hartford Turnpike Hampton, CT 06247

Prepared for

EASTCONN 376 Hartford Turnpike Hampton, CT 06247

REVISIONS

	Date	Description

Roof Electrical Plan

SHEET TITLE

PROJ. NO. 2018048

SCALE AS NOTED

DATE APRIL, 2019

DESIGNED FB

DRAWN FB

CHECKED JAS


SHEET


E-3

	NELBOARD MDP	Class: Type:					Short Circuit Rating (Min.): • Remark:	42 KAIC
	SERVICE 120/208 Volts		3 Ph	ase 4	Wire		S/E Label: NO	
PA CON	NELBOARD IFIGURATION	600 AMPERE M Trim: SURFACE					Entrance: TOP/BOTTOM Equipment Ground Bus: YES	
	MAIN	Type: 600A/3P Wire Size: SEE					Enclosure: NEMA 1	
(BRANCH CIRCUITS	Branch Protect	ive Devic	es: (MOl	LDED CA	SE CIRCU	IT BREAKERS)	
Circ No	Circuit	Designation	KVA Load	Pole	Trip Amps	Frame Amps	Wire (min.)	See Remark
1	PANEL KP		98.3	3	400	400	SEE RISER	
2	EXIST PANEL	RP1A	-	3	225	225	MATCH EXISTING	
3			-	-	-	-		
4			-	-	-	-		
5			ı	-	-	-		
6			-	-	-	-		
7	EXIST PANEL	HP-1	-	3	225	225	MATCH EXISTING	
8	EXIST PANEL	PP-1	•	3	225	225	MATCH EXISTING	
9			-	-	-	-		
10			-	-	-	-		
11			-	-	-	-		
12			-	-	-	-		
13	PREPARED SP	ACE	ı	3	-	225		
14	PREPARED SP	ACE	ı	3	-	225		
15			ı	ı	-	•		
16			ı	ı	-	•		
17			ı	-	-	-		
18			ı	ı	-	ı		
19	EXIST PANEL		-	3	125	125	MATCH EXISTING	,c,
20	EXIST PANEL		•	3	125	125	MATCH EXISTING	,c,
21			ı	-	-	-		
22			-	ı	-	-		
23			ı	ı	-	ı		
24			ı	ı	-	-		
25	PREPARED SP	ACE	-	3	-	125		
26	PREPARED SP	ACE	-	3	-	125		
27			-	-	_	-		
28			1	-	-	-		
29			-	-	-	-		
30			-	_	-	-		
31	PREPARED SP	ACE	-	3	-	125		
32	SPD		-	3	30	100		
33			-	-	-	-		
34	SPD		-	-	-	-		
35			-	-	-	-		
36	SPD		-	-	-	-		
		TOTAL KVA:	-					1

- F	KP	Class: Type:					Short Circuit Rating (Min.): Remark:	22 KAIC
	SERVICE	120/208 Volts	3 Ph	nase 4	4 Wire		S/E Label: NO	
P.A CON	NELBOARD NFIGURATION	400 AMPERE M Trim: SURFACE	AIN BUS				Entrance: TOP/BOTTOM Equipment Ground Bus: YES	3
	MAIN	Type: 400A MC Wire Size: SEE					Enclosure: NEMA 1	
	BRANCH CIRCUITS	Branch Protecti	ve Devic	es: (MO	LDED CA	SE CIRCU	IIT BREAKERS)	
Circ No	Circuit	Designation	KVA Load	Pole	Trip Amps	Frame Amps	Wire (min.)	See Remo
1	PANEL KP-1		14.7	3	100	100	SEE RISER	
2	DISHWASHER		25.5	3	80	100	1"C, 3-#4 AWG + #8 GND	
3			-	-	-	-		
4			-	-	_	_		
5			-	-	-	-		1
6			-	-	-	-		
7	CONVECTION C	OVEN DBL STACK	13.8	3	40	100	3/4"C, 3-#8 AWG + #10 GND	,a,
8		OVEN DBL STACK	13.8	3	40	100	3/4°C, 3-#8 AWG + #10 GND	,a,
9			-	_	-	-		
10			-	_	-	_		
11			-	_	_	_		
12			_	_	_	_		
13	 		_	_	_	 		
14			-	_	_	 		
15	MUA-1		24.1	3	80	100	1"C, 3-#4 AWG + #8 GND	, ^A ,
16	EF-1		3.4	3	15	100	3/4°C, 4-#12 AWG	
17			-	_	-	-		
18			_	_	-	-		
19			_	_	_	 		
20			_	_	_	-		
21			_	_	-	-		
22	<u> </u>	ER/MICROWAVE	5.8	2	30	100	3/4"C, 3-#8 AWG	
23	EF-2	IN MICHOWAVE	0.4	1	15	100	3/4"C, 3-#12 AWG	
24			-			-		
25	DOMESTIC WAT	TED HEATED	0.6	1	15	100	3/4"C, 3-#12 AWG	
26		SH/STOR/RESTRM	1.2	1	20	100	3/4°C, 3-#12 AWG	
27	LTG-GREASE H		1.0	1	15	100	3/4°C, 3-#12 AWG	
28	.	CONTROL PANEL	0.6	1	15	100	3/4°C, 3-#12 AWG	+
	ANSUL FP SYS		1.2	1	20	100	3/4°C, 3-#12 AWG	
30	HOBART SLICE		0.5	1	20	100	3/4"C, 3-#12 AWG	
31	<u> </u>	ISPORT CABINET	2.0	1	25	100	3/4"C, 3-#12 AWG	
32	RECEPT-KITCH		0.4	1	20	100	3/4"C, 3-#10 AWG	
33	RECEPT-KITCH		0.4	1	20	100	3/4"C, 3-#12 AWG	
34	RECEPT-KITCH		0.4	1	20	100	3/4"C, 3-#12 AWG	
35	RECEPT-KITCH		0.4	1	20	100	3/4"C, 3-#12 AWG	-
36	PREPARED SP.		-	1	-	100		
37	PREPARED SP.		-	1	 	100		
38	SPD	, tol	-	1	30	100		+
<u> 38</u> 39	PREPARED SP.	ACF		1		100		
40	SPD SPD	NOL	<u>-</u>	1	-	100		+
41	PREPARED SP	ACF		1	-	100		-
42	SPD SPD	NOL	-	1	-	100		
+ ∠	ا عدم		98.3*			100	-	

	NELBOARD KP-1	Class: Type:					Short Circuit Rating (Min.): : Remark:	22 KAIC
	SERVICE	120/208 Volts	3 Pł	nase 4	4 Wire		S/E Label: NO	
	NELBOARD NFIGURATION	100 AMPERE M Trim: SURFACE					Entrance: TOP/BOTTOM Equipment Ground Bus: YES	
	MAIN	Type: 100/3P I Wire Size: SEE					Enclosure: NEMA 1	
1	BRANCH CIRCUITS	Branch Protecti	ive Devic	es: (MOI	LDED CA	SE CIRCU	IIT BREAKERS)	
Circ No	Circuit	Designation	KVA Load	Pole	Trip Amps	Frame Amps	Wire (min.)	See Remark
1	WALKIN COOLE	ER CONDENSER	2.7	3	20	100	3/4"C, 4-#12 AWG	' B'
2	WALKIN FREEZ	ER CONDENSER	2.7	3	20	100	3/4"C, 4-#12 AWG	'B'
3			-	-	-	-		
4			-	-	-	-		
5			-	-	-	-		
6			-	-	-	-		
7	WALKIN COOLE	R EVAPORATOR	0.7	1	15	100	3/4"C, 3-#12 AWG	'B'
8	WALKIN FREEZ	ER EVAPORATOR	0.7	1	15	100	3/4"C, 3-#12 AWG	'B'
9	REACH-IN REF	RIGERATOR	0.9	1	20	100	3/4"C, 3-#12 AWG	
10	REACH-IN FRE	EZER	1.6	1	20	100	3/4"C, 3-#12 AWG	
11	ICE MACHINE		1.4	1	20	100	3/4"C, 3-#12 AWG	
12	SANDWICH PRI	EP TABLE	1.2	1	20	100	3/4"C, 3-#12 AWG	
13	LTG-WALKIN C	OOLER/FREEZER	0.6	1	15	100	3/4"C, 3-#12 AWG	
14	RECEPT-ROOF		0.4	1	20	100	3/4°C, 3-#12 AWG	
15	RECEPT-MUA-	1	0.2	1	20	100	3/4°C, 3-#12 AWG	
16	RECEPT-RESTR	ROOM/JAN CLOSET	0.4	1	20	100	3/4°C, 3-#12 AWG	
17	RECEPT-WASH	/STORAGE	0.8	1	20	100	3/4°C, 3-#12 AWG	
18	RESTROOM CA	LL-FOR-AID	0.4	1	15	100	3/4°C, 3-#12 AWG	
19	PREPARED SP	ACE	-	1	-	100		
20	PREPARED SP	ACE	-	1	-	100		
21	PREPARED SP	ACE	-	1	-	100		
22	PREPARED SP	ACE	-	1	-	100		
23	PREPARED SP	ACE	-	1	-	100		
24	PREPARED SP	ACE	-	1	_	100		
25	PREPARED SP	ACE	-	1	-	100		
26	PREPARED SP	ACE	-	1	_	100		
27	PREPARED SP	ACE	-	1		100		
28	PREPARED SP	ACE	-	1	-	100		
29	PREPARED SP	ACE	-	1	_	100		
30	PREPARED SP	ACE	-	1		100		
		TOTAL KVA:	14.7					

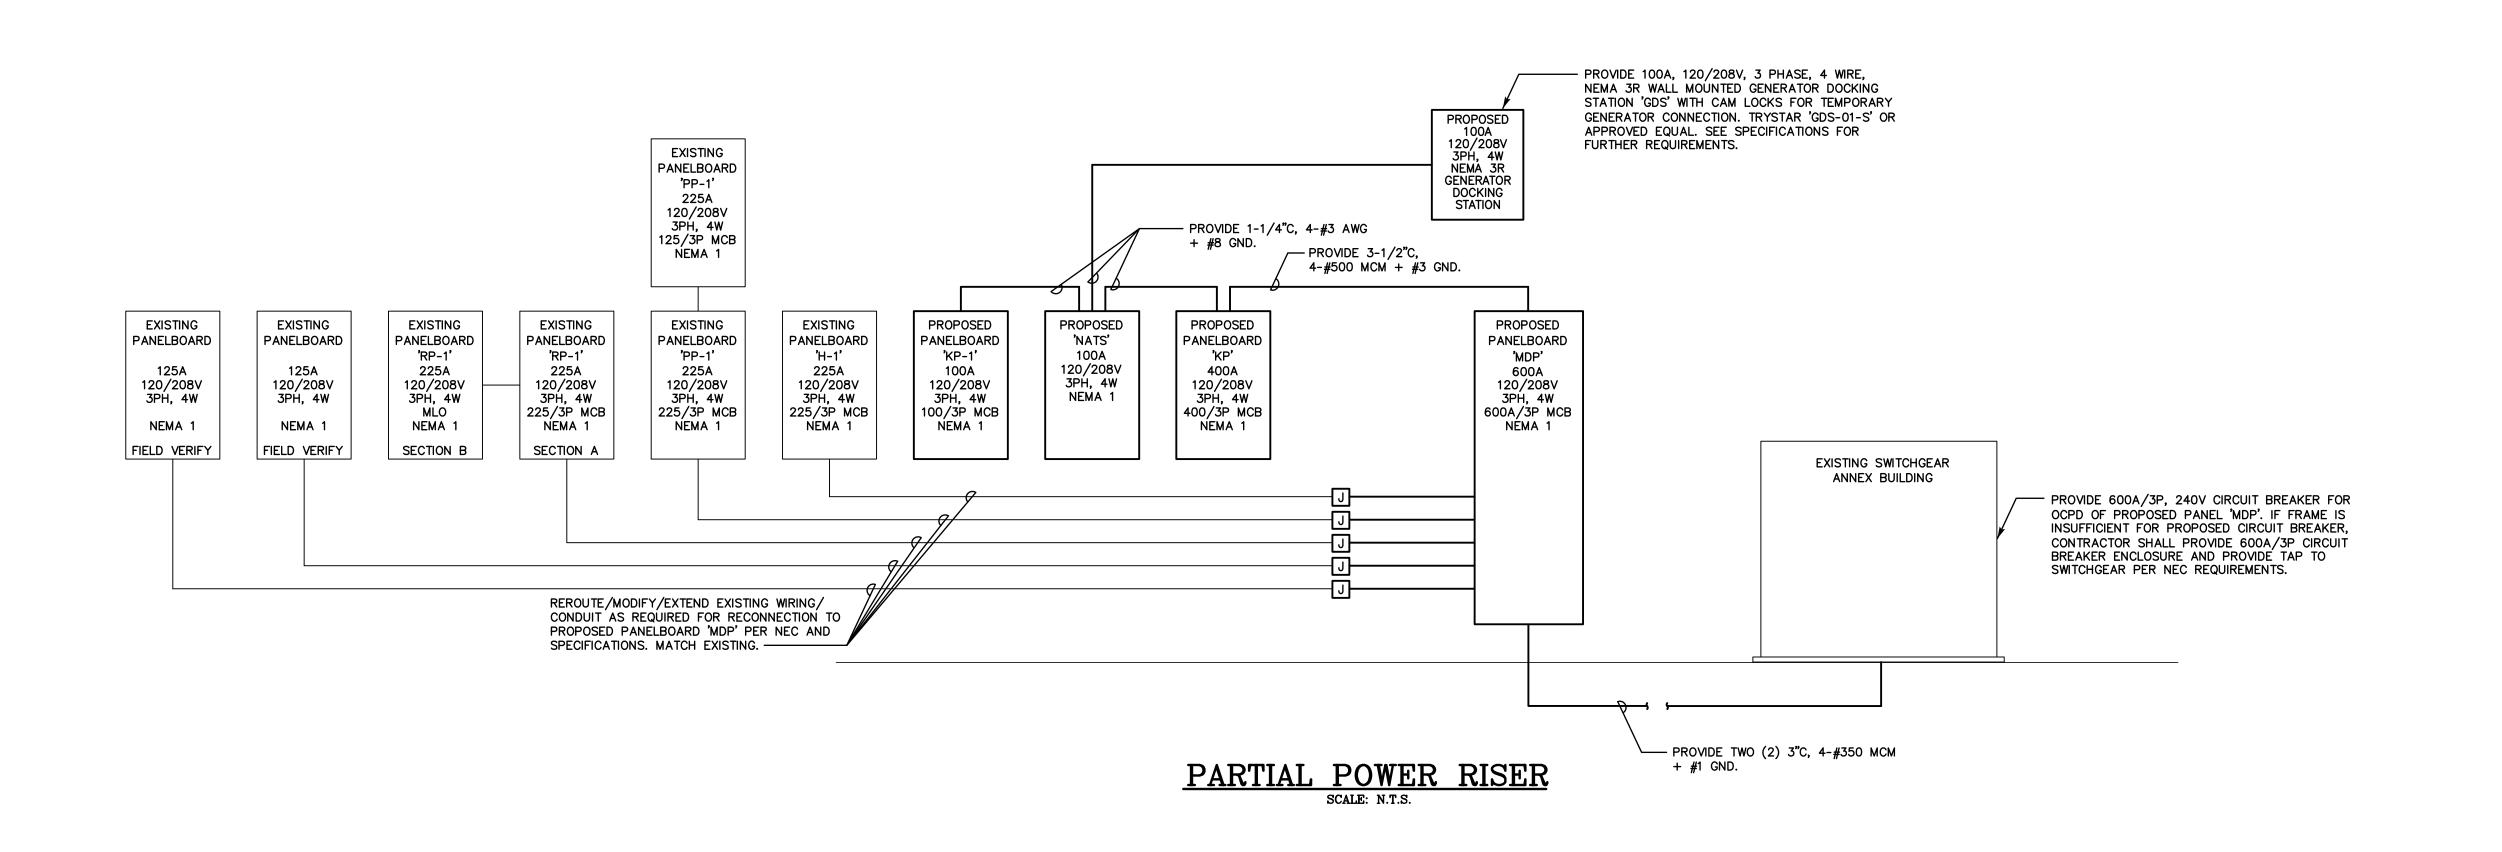

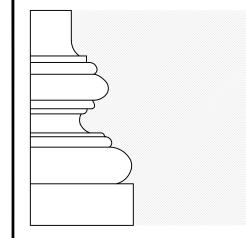

EVELYN COLE SMITH ARCHITECTS, LLC
PO Box 182
134 Main St
Putnam, CT
06260

www.ecsarchitects.com

STAMP

860 315 9570

CONSULTANT

SALAMONE &
ASSOCIATES, P.C.

CONSULTING ENGINEERS

116 North Plains Industrial Road
Wallingford, Connecticut 06492
Phone: (203) 281-6895 Fax: (203) 287-8728

PROJECT

Proposed Commercial Kitchen

EASTCONN 376 Hartford Turnpike Hampton, CT 06247

Prepared for

EASTCONN 376 Hartford Turnpike Hampton, CT 06247

Date Description

REVISIONS

Electrical Panelboard Schedules & Power Riser

SHEET TITLE

PROJ. NO. 2018048

SCALE AS NOTED

DESIGNED FB

DATE APRIL, 2019

DRAWN FB

CHECKED JAS

E-4

SHEET

ELECTRICAL SYMBOL LIST					
H⊠ OR ⊠	CEILING OR WALL MOUNTED EXIT SIGN WITH DIRECTIONAL ARROWS AS INDICATED ON PLANS				
×	EXIT SIGN SHADING INDICATES LIGHTED FACE				
-	DUPLEX RECEPTACLE GFCI - GROUND FAULT CIRCUIT INTERRUPTER IG - ISOLATED GROUND WP - WEATHERPROOF L - LOCKABLE COVER				
_	AUTOMATIC DOOR OPENER				
CR	CARD ACCESS READER				
(A)	SPECIAL PURPOSE CONNECTION				
S	SWITCH (NONE) - SINGLE POLE 2 - TWO POLE 3 - THREE WAY 4 - FOUR WAY D - DIMMER TOL - THERMAL OVERLOAD PROTECTION DEVICE K - KEYED K3 - KEYED 3 WAY LK - KEYED LOW VOLTAGE LK3 - KEYED 3 WAY LOW VOLTAGE OS - OCCUPANCY SENSOR				
	DISCONNECT SWITCH				
T	COMBINATION TELEPHONE/DATA OUTLET				
▼	DATA OUTLET				
D	INTRUSION DOOR CONTACT				
GB	INTRUSION GLASS BREAK SENSOR				
MD	INTRUSION WALL MOUNTED MOTION DETECTOR				
MD	INTRUSION CEILING MOUNTED MOTION DETECTOR				
□	SECURITY CAMERA				
⊖	SECURITY CAMERA WITHIN WEATHERPROOF DOME				
®	DOOR RELEASE				
	BRANCH CIRCUIT HOMERUN (ARROWS INDICATE CIRCUIT NUMBERS)				

F	RE ALARM SYMBOL LIST							
Э	HEAT DETECTOR							
F	MANUAL PULL STATION; MOUNT 48" A.F.F.							
SD	DS: SUPPLY DUCT DUCT MOUNTED SMOKE DETECTOR DR: RETURN DUCT							
	AUDIBLE/VISUAL NOTIFICATION DEVICE - MOUNT 7'-6" A.F.F.							
	VISUAL NOTIFICATION DEVICE - MOUNT 7'-6" A.F.F.							

CALL	FOR AID SYMBOL LIST						
E	EMERGENCY CALL DEVICE						
H	EMERGENCY CALL FOR AID LIGHT/HORN						

ELEC	CTRICAL ABBREVIATIONS
Α	AMPERES
A.F.F.	ABOVE FINISHED FLOOR
AWG	AMERICAN WIRE GAUGE
С	CONDUIT
CIR	CIRCUIT
E	EMERGENCY
FA	FIRE ALARM
FAAP	FIRE ALARM ANNUNCIATOR PANEL
FACP	FIRE ALARM CONTROL PANEL
G	GROUNDED
HP KAIC	HORSEPOWER
1	INTERRUPTING CAPACITY (KILOAMPERE)
KVA	KILOVOLT-AMPERE
KW	KILOWATT
NEC	NATIONAL ELECTRIC CODE
NEMA -	NATIONAL ELECTRICAL MANUFACTURERS ASS.
P	POLE
UL	UNDERWRITER'S LABORATORY
UTIL	UTILITY
V	VOLTS
VA	VOLT-AMPERES
W	WATTS
#	WIRE SIZE IN AWG, OR MCM WHEN INDICATED

UNDERGROUND

WARNING TAPE.

CONDUIT, SEE SCHEDULES AND DRAWINGS FOR SIZING


SAND (WITH NO STONES)-

7-1/2" MINIMUM SPACING

AND QUANTITY. TYP. —

TYPICAL.

LUMINAIRE SCHEDULE								
LTG. CODE	DESCRIPTIONS	VOLTS	CATALOG NO./ MANUFACTURER	MOUNTING	LAMP (G.E. OR EQUAL)			
'A'	2'X2' RECESSED HIGH OUTPUT LENSED LED FIXTURE. STEEL HOUSING, GASKETED DOOR. 5370 NOMINAL LUMENS DELIVERED. 3500K COLOR. HIGH EFFICIENCY DRIVER. WHITE FINISH. FIVE YEAR WARRANTY. UL LISTED WET LOCATIONS, FOOD ZONE,	120	CSEDO-22-45L35K-DCC-120-2F- 2H-SYM-FN KENALL	RECESSED/ CEILING	LED			
'AE'	NON-CONTACT. FIXTURE TYPE 'A' WITH EMERGENCY BATTERY PACK.	120	CSEDO-22-45L35K-DCC-120-2F- 2H-SYM-FN-LEL KENALL	RECESSED/ CEILING	LED			
'B'	2'X2' RECESSED LED FIXTURE. EXTRUDED ALUMINUM HOUSING, ACRYLIC DIFFUSER. 3800 NOMINAL LUMENS DELIVERED. 3500K COLOR. HIGH EFFICIENCY DRIVER. WHITE FINISH. FIVE YEAR WARRANTY. UL LISTED.	120	2FXP38L835-2-DS-UNIV-DIM PHILIPS DAY-BRITE	RECESSED/ CEILING	LED			
'BE'	FIXTURE TYPE 'B' WITH EMERGENCY BATTERY PACK.	120	2FXP38L835-2-DS-UNIV-DIM- EMLED7 PHILIPS DAY-BRITE	RECESSED/ CEILING	LED			
'C'	3"X3' SURFACE LED FIXTURE. STEEL HOUSING, ACRYLIC DIFFUSER. 3000 NOMINAL LUMENS DELIVERED. 3500K COLOR. HIGH EFFICIENCY DRIVER. WHITE FINISH. FIVE YEAR WARRANTY. UL LISTED.	UNV	FSS330L835-UNV-DIM PHILIPS DAYBRITE	SURFACE/ CEILING	LED			
'E'	FULLY ADJUSTABLE DUAL HEAD LED REMOTE EMERGENCY LIGHTING UNIT. UL LISTED WET LOCATIONS.	-	PRWLED2MV EVENLITE	EXTERIOR/ WALL	LED			
'X'	LED EXIT SIGN. WHITE HOUSING, RED LETTERING. LOW ENERGY CONSUMPTION. 90 MINUTE MAINTENANCE FREE BATTERY. SELF-TEST/SELF-DIAGNOSTICS. 5 YEAR WARRANTY. UL LISTED DAMP LOCATIONS.	UNV	RZR3-EM-R-1-WH-1B-SD EVENLITE	WALL	LED			
'X1'	LED EXIT SIGN. WHITE HOUSING, RED LETTERING. LOW ENERGY CONSUMPTION. 90 MINUTE MAINTENANCE FREE BATTERY. SELF-TEST/SELF-DIAGNOSTICS. 5 YEAR WARRANTY. UL LISTED DAMP LOCATIONS.	UNV	RZR3-EM-R-1-WH-CN-SD EVENLITE	CEILING	LED			
'X2'	LED EXIT SIGN. WHITE HOUSING, RED LETTERING. LOW ENERGY CONSUMPTION. 90 MINUTE MAINTENANCE FREE BATTERY. SELF-TEST/SELF-DIAGNOSTICS. REMOTE CAPABILITY, 5 YEAR WARRANTY. UL LISTED DAMP LOCATIONS.	UNV	RZR3-EM-R-1-WH-1B-SD- PRWLED2MV EVENLITE	WALL	LED			

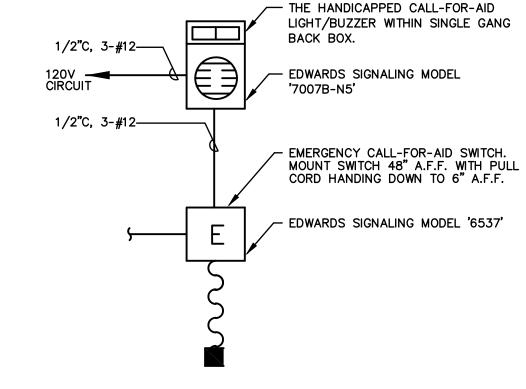

ELECTRICAL GENERAL NOTES

- 1. ALL WORK SHALL BE DONE IN ACCODANCE WITH THE 2017 EDITION OF THE NEC (NFPA 70) WITH STATE OF CONNECTICUT AMENDMENTS AND SUPPLEMENTS. 2. PROVIDE A COMPLETE AND OPERATIONAL ELECTRICAL SYSTEM INCLUDING
- ALL NECESSARY MATERIAL, LABOR AND EQUIPMENT. 3. ELECTRICAL PLANS AND DETAILS AND ONE LINE DIAGRAMS SHOW THE GENERAL LOCATION AND ARRANGEMENT OF THE ELECTRICAL SYSTEM. THEY ARE DIAGRAMMATIC AND DO NOT SHOW ALL CONDUIT BODIES, CONNECTORS, BENDS, FITTINGS, HANGERS AND ADDITIONAL PULL AND
 - 4. ALL EQUIPMENT AND MATERIAL SHALL BE LABELED, LISTED AND INSTALLED IN ACCORDANCE WITH THEIR LISTING.
- 5. THE CONTRACTOR SHALL OBTAIN ALL REQUIRED PERMITS AND ARRANGE FOR ALL REQUIRED INSPECTIONS IN ACCORDANCE WITH STATE AND LOCAL
- 6. ALL WORK SHALL BE DONE WITH LICENSED WORKMEN IN ACCORDANCE WITH
- STATE AND LOCAL GOVERNING AUTHORITIES. 7. THE DEFINITION OF ELECTRICAL TERMS USED SHALL BE AS DEFINED IN THE

8. THE TERM "INDICATED" SHALL MEAN "AS SHOWN ON CONTRACT DOCUMENTS

- 2017 EDITION OF THE NATIONAL ELECTRICAL CODE (NEC) WITH STATE OF CONNECTICUT AMENDMENTS.
- (SPECIFICATIONS, DRAWINGS AND RELATED ATTACHMENTS)". 9. THE TERM "PROVIDE" SHALL MEAN "TO FURNISH, INSTALL AND CONNECT
- COMPLETELY". 10. THE TERM "SIZE" SHALL MEAN ONE OR MORE OF THE FOLLOWING: "LENGTH,
- CURRENT AND VOLTAGE RATING, NUMBER OF POLES, NEMA SIZE AND OTHER SIMILAR ELECTRICAL CHARACTERISTICS". I. THE TERM "SPACE" ON PANELBOARD AND SWITCHBOARD SCHEDULES SHALL
- MEAN "PROVIDE SPACE TO INSTALL THE NUMBER OF POLES AND SIZE OF THE PROTECTIVE DEVICE INDICATED WITH ALL NECESSARY BUS AND FITTINGS TO INSTALL THE DEVICE AT SOME FUTURE DATE".
- 12. ELECTRICAL PLANS AND DETAILS DO NOT SHOW ALL INTERFERENCES AND CONDITIONS, VISIBLE AND/OR HIDDEN, THAT MAY EXIST; THUS REQUIRING THE CONTRACTOR TO INSPECT AND SURVEY THE SPACE/AREA BEFORE PERFORMING THE WORK.
- 13. COORDINATE ELECTRICAL WORK WITH OWNER.

GOVERNING AUTHORITIES.

- 14. COORDINATE ELECTRICAL WORK WITH OTHER DIVISIONS OF THIS PROJECT.
- 15. TURN OVER TO THE OWNER ALL MANUFACTURERS WARRANTIES FOR EQUIPMENT AND MATERIAL PROVIDED.
- 16. UNLESS OTHERWISE INDICATED, ALL ELECTRICAL EQUIPMENT HAS BEEN BASED ON GENERAL ELECTRIC PRODUCTS.
- 7. THE CONTRACTOR MAY SUBSTITUTE EQUIPMENT OF ANOTHER MANUFACTURER IF IT IS OF EQUAL QUALITY AND RATING, SUBJECT TO OWNER'S AND
- ENGINEER'S REVIEW AND ACCEPTANCE. 18. UNLESS OTHERWISE INDICATED, ALL ENCLOSURES FOR EQUIPMENT PROVIDED
- SHALL BE NEMA TYPE 1. 19. UNLESS OTHERWISE INDICATED, ALL CONDUCTORS TO BE COPPER THHN/THWN-2.
- 20. UNLESS OTHERWISE INDICATED, ALL OUTLET AND SWITCH BOXES TO BE CAST IRON WITH THREADED HUBS.
- 21. IN INTERIOR PROTECTED LOCATIONS, OUTLET AND SWITCH BOXES MAY BE
- 22. BEFORE SELECTING MATERIAL AND EQUIPMENT, AND PROCEEDING WITH WORK, INSPECT AREAS WHERE MATERIAL AND EQUIPMENT ARE TO BE INSTALLED TO INSURE SUITABILITY, AND CHECK NEEDED SPACE FOR PLACEMENT, CLEARANCES AND INTERCONNECTIONS.
- 23. UNLESS OTHERWISE INDICATED, ALL CONDUCTORS ARE NO. 12 AWG.
- 24. COORDINATE ELECTRICAL WORK WITH LOCAL UTILITY COMPANY.
- 25. CONTRACTOR RESPONSIBLE FOR PAYING LOCAL UTILITY COMPANY CHARGES. 26. CONDUIT SIZE FOR INDICATED CONDUCTORS SHALL BE BASED ON CHAPTER 9
- OF NEC. 27. THE CONTRACTOR MAY GROUP BRANCH CIRCUIT HOME RUN CONDUCTORS
- IN A SINGLE RACEWAY IN ACCORDANCE WITH NEC. 28. ALL BLANK COVER PLATES TO BE STAINLESS STEEL.
- 29. PROVIDE TRENCHING, SAND AND BACKFILL FOR ALL UNDERGROUND ELECTRICAL CONDUITS AND WIRING AS REQUIRED.



CALL-FOR-AID DETAIL SCALE: N.T.S.

TYPICAL TRENCH DETAIL SCALE: N.T.S.

- FILL TO MATCH EXISTING

DETAILS.

CONDITIONS. SEE SITE REPAIR

- CONDUIT DEPTHS SHALL BE AS LISTED

ELECTRIC CODE. REFER TO TECHNICAL


IN TABLE 300-5 OF THE NATIONAL

UTILIZATION LOCATIONS. MAINTAIN PROPER CLEARANCES FROM SEWER, NATURAL GAS, WATER AND OTHER


ALL CONDUITS BY DIVISION 26, TRENCHING BY DIVISION 12.

SPECIFICATIONS AS TO CONDUIT


UTILITIES AS REQUIRED.

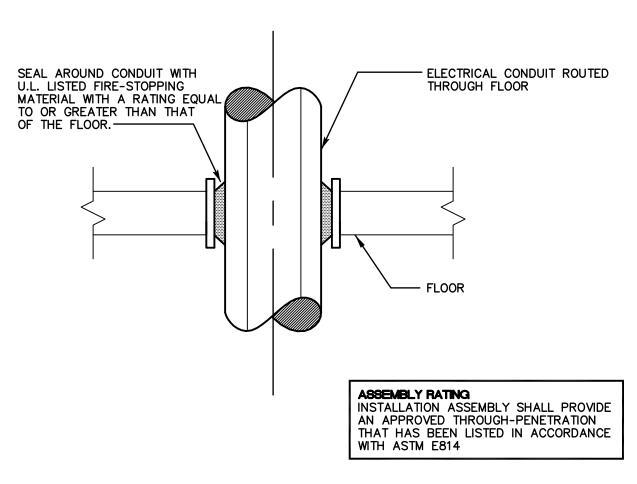

TYPICAL CONDUIT FLOOR PENETRATION DETAIL (UL XHEX C-AJ-1008)

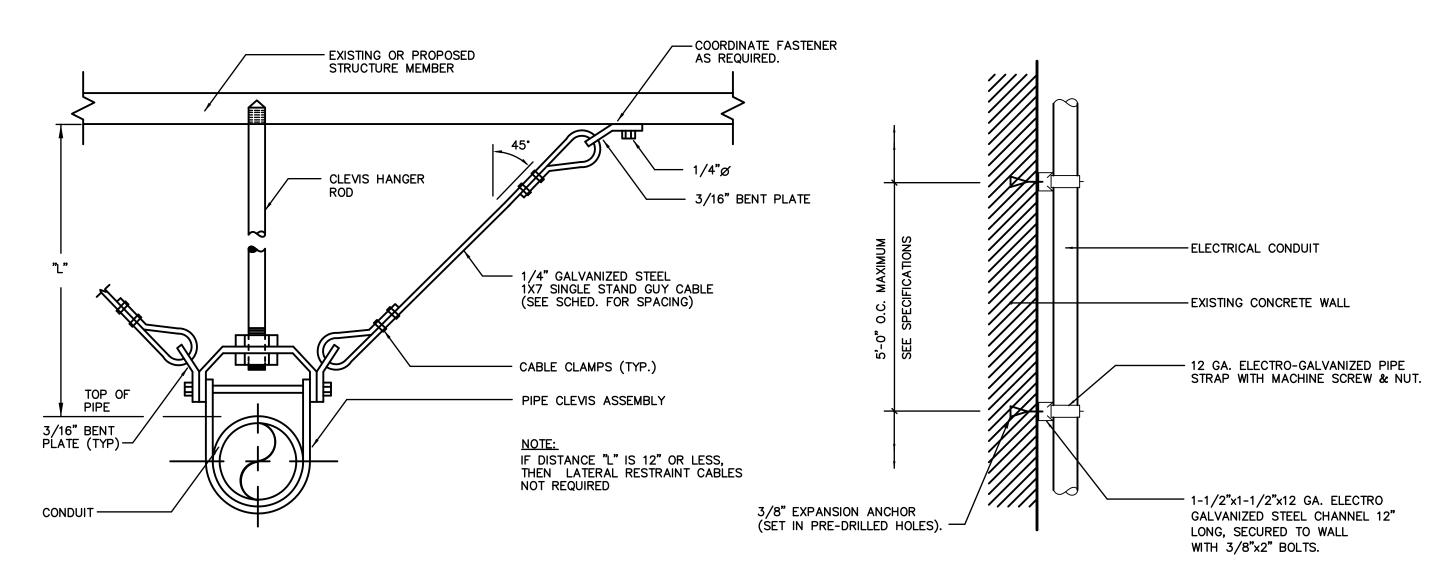

TYPICAL SEISMIC RESTRAINT ASSEMBLY OF SUSPENDED CONDUIT TYPICAL VERTICAL CONDUIT SUPPORT DETAIL

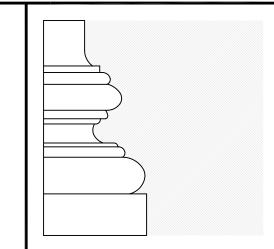

EVELYN COLE SMITH ARCHITECTS, LLC PO Box 182 134 Main St

Putnam, CT

860 315 9570

06260

www.ecsarchitects.com STAMP

CONSULTANT

SALAMONE ASSOCIATES, P.C.

CONSULTING ENGINEERS 116 North Plains Industrial Road Wallingford, Connecticut 06492 one: (203) 281-6895 Fax: (203) 287-8728

PROJECT

Proposed Commercial Kitchen

EASTCONN 376 Hartford Turnpike

Hampton, CT 06247

Prepared for

EASTCONN 376 Hartford Turnpike

Hampton, CT 06247

REVISIONS Description

SHEET TITLE

Electrical Schedules, Details, Symbols, Notes & Abbreviations

PROJ. NO. 2018048 SCALE AS NOTED DATE APRIL, 2019 DESIGNED FB DRAWN FB

CHECKED JAS SHEET

E-5

1 OF -

THAT HAS BEEN LISTED IN ACCORDANCE WITH ASTM E814 TYPICAL CONDUIT WALL PENETRATION DETAIL (UL XHEX C-AJ-1008)

SEAL AROUND CONDUIT WITH U.L. LISTED FIRE-STOPPING MATERIAL WITH A RATING EQUAL

TO OR GREATER THAN THAT

OF THE WALL. -

-FIRE RATED WALL, TYPICAL.

— ELECTRICAL CONDUIT ROUTED

THROUGH WALL.

ASSEMBLY RATING

INSTALLATION ASSEMBLY SHALL PROVIDE AN APPROVED THROUGH-PENETRATION