



# QUISENBERRY ARCARI MALIK LLC.

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Fire Alarm Upgrades at McKenna Court

MCKENNA COURT

# WALLINGFORD HOUSING AUTHORITY

BID SET: 04/15/2019

MCKENNA COURT

WALLINGFORD, CT

## LIST OF DRAWINGS

- G1.0 GENERAL NOTES
- FA3.1 SITE FIRE ALARM PLAN
- FA3.2 FIRE ALARM TYPICAL UNIT FLOOR PLAN AND RISER DIAGRAM
- FA3.3 COMMUNITY ROOM FIRE ALARM FLOOR PLAN

## CONSULTANTS

### MEP CONSULTANT:

ACORN CONSULTING ENGINEERING  
 244 Farms Village RD  
 West Simsbury, Connecticut 06092


## OWNER

HOUSING AUTHORITY OF  
 THE TOWN OF WALLINGFORD  
 45 TREMPER DRIVE  
 WALLINGFORD CONNECTICUT 06492  
 ROBERT WIEDENMANN, JR. VICE-CHAIRMAN  
 GERALDINE BRONNER TENANT COMMISSIONER  
 NICHOLAS LOMBARDI COMMISSIONER  
 JAMES LOUGHLIN COMMISSIONER  
 FRANK S. STELLATO COMMISSIONER

## LOCATION MAP

TRUE NORTH: 

PROJECT NORTH: 

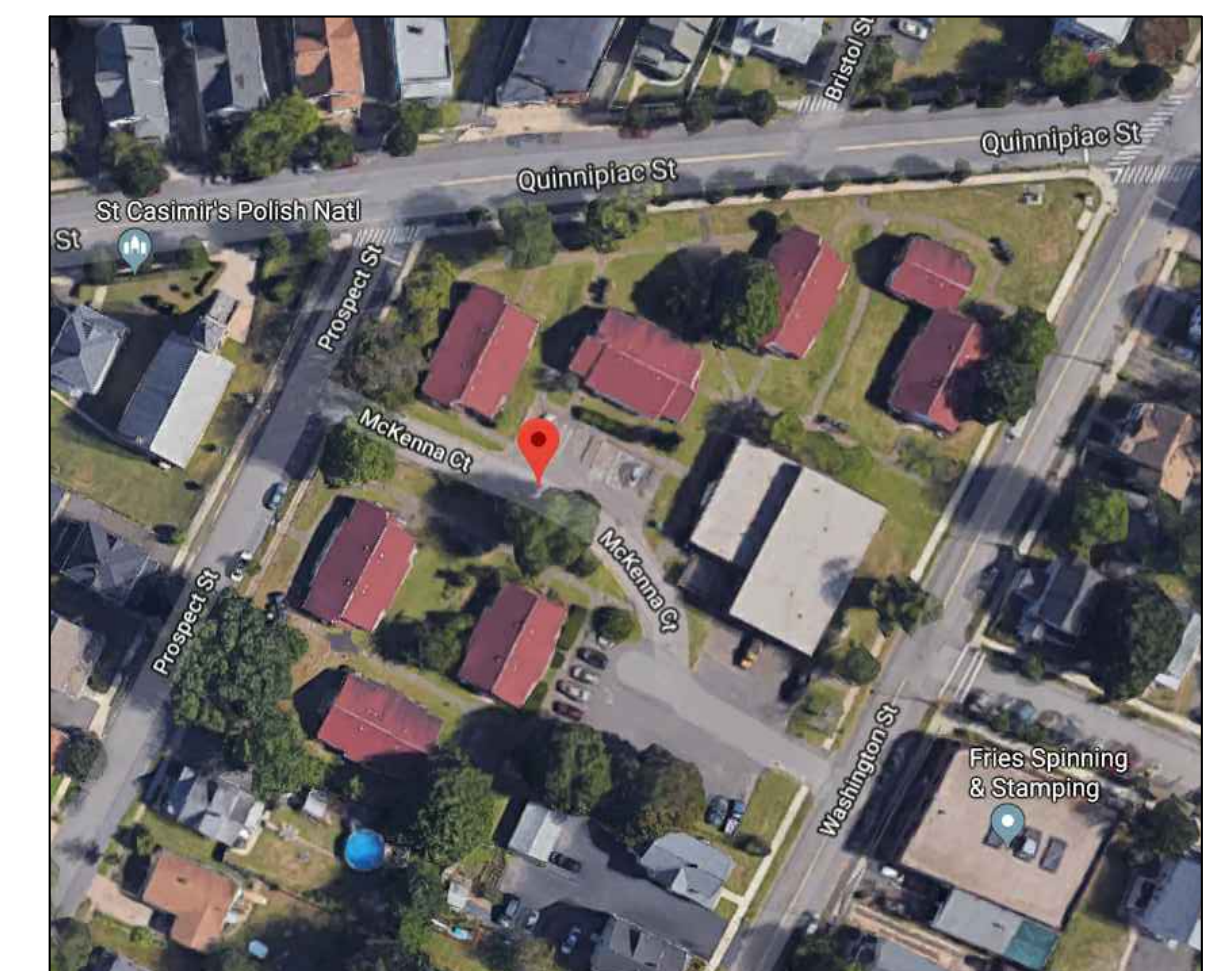

ABBREVIATIONS			
A.F.F.	Above Finish Floor	HGT.	Height
A.C.	Acoustic, Acoustical	H.M.	Hollow Metal
A.C.T.	Acoustical Tile	HORIZ.	Horizontal
A/C	Air Conditioning	H.B.	Hose Bibb
A.H.U.	Air Handling Unit	IN.	Inch
ALT.	Alternate	INCL.	Included
ALUM.	Aluminum	INFO.	Information
ALF.	Aluminum Frame	I.D.	Inside Diameter
ANCH.	Anchor, Anchorage	INSUL.	Insulation
AB.	Anchor Bolt	INT.	Interior
L	Angle	JT.	Joint
ANOD.	Anodized	K.P.	Kick Plate
APPR.	Approved	LAB.	Laboratory
ARCH.	Architect, Architectural	LAV.	Lavatory
ASB.	Asbestos	LTG.	Lighting
A.P.B.O.	As Provided By Owner	MACH.	Machine
A.S.B.O.	As Selected By Owner	MAINT.	Maintenance
ASPH.	Asphalt	MFRG.	Manufacturer
ASSY.	Assembly	M.B.D.	Marker Board
ASST.	Assistant	MAS.	Masonry
AUTO.	Automatic	M.O.	Masonry Opening
BM	Beam	MAT.	Material
BRG.	Bearing	MAX.	Maximum
BEV.	Bevel, Beveled	MECH.	Mechanical
BIT.	Bituminous	MEZZ.	Mezzanine
BLK.	Block	MIN.	Minimum
BLKG.	Blocking	MISC.	Miscellaneous
BD.	Board	N	North
BOT.	Bottom	N.I.C.	Not In Contract
B.O.	Bottom Of	N.T.S.	Not To Scale
B.E.J.	Brick Expansion Joint	OFF.	Office
BLDG.	Building	O.C.	On Center
B.U.R.	Built Up Roofing	O.H.	Overhead
CAB.	Cabinet	O.D.	Outside Diameter
C.U.H.	Cabinet Unit Heater	PTD.	Painted
CAP.	Capacity	PR.	Pair
CASE	Casement	P.T.D.	Paper Towel Dispenser
CLG.	Ceiling	PASS.	Passage
CLGHT.	Ceiling Height	PERP.	Perpendicular
CEM.	Cement	PLAS.	Plaster
CTR.	Center	PLAM.	Plastic Laminate
CL	Centerline	PL	Plate
C.T.	Ceramic Tile	PLUMB.	Plumbing
C.BD.	Chalk Board	PLYWD.	Plywood
CLO.	Closet	PVC.	Polyvinylchloride
COL.	Column	P.E.J.	Precast Expansion Joint
CONC.	Concrete	PREFAB.	Prefabricated
CONF.	Conference	QTY.	Quantity
CJ	Control Joint	Q.T.	Quarry Tile
CONT.	Continuous	RAD.	Radius
CONTR.	Contractor	RWC	Rain Water Conductor
CORR.	Corridor	RECV.	Receiving
CRS.	Course, Courses	REFR.	Refrigerator
DEG.	Degree	REINF.	Reinforce
DEMO.	Demolition	REM	Remove
DEPT.	Department	REQ'D	Required
DET.	Detail	REV.	Revised, Revision
DIA.	Diameter	R.	Riser
DIM.	Dimension	R.D.	Roof Drain
DIST.	Distance	RM.	Room
DR.	Door	S.N.D.	Sanitary Napkin Dispenser
DBL.	Double	S.N.R.	Sanitary Napkin Receptacle
D.H.	Double Hung	SCHED.	Schedule
DN	Down	SC.	Scupper
D.S.	Downspout	SECT.	Section
DWG.	Drawing	S.J.	Seismic Joint
D.F.	Drinking Fountain	SHT.	Sheet
EA	Each	SIM.	Similar
ELEC.	Electric, Electrical	S.D.	Soap Dispenser
EWC.	Electric Water Cooler	S.T.D.	Sound Transmission Class
EL	Elevation	S.T.C.	Sound Transmission Coefficient
ELEV.	Elevator	SPEC.	Specifications
EMERG.	Emergency	SQ.	Square
EQ.	Equal	S.F.	Square Feet
EQUIP.	Equipment	S.S.	Stainless Steel
EXIST.	Existing	STD.	Standard
E.T.R.	Existing To Remain	STL.	Steel
EXP.	Expansion	STOR.	Storage
E.J.	Expansion Joint	STRUCT.	Structure, Structural
EXT.	Exterior	S.STL.	Structural Steel
E.I.F.S.	Exterior Insulation Finish System	SUSP.	Suspend, Suspension
FT.	Feet, Foot	S.A.T.C.	Susp. Acoustic Tile Ceiling
F.R.G.P.	Fiber Reinforced Gypsum Panel	T.BD.	Tack Board
FIN.	Finish, Finished	THRU	Through
F.E.	Fire Extinguisher	T.P.D.	Toilet Paper Dispenser
F.R.	Fire Retardant	T.M.E.	To Match Existing
FPRFG.	Fireproofing	T&G	Tounge and Groove
FIXT.	Fixture	T.O.	Top Of
FLASH	Flashing	T.	Tread
FLR.	Floor	TYP.	Typical
F.D.	Floor Drain	U.L.	Underwriter's Laboratory
FLR.FIN.	Floor Finish	U.H.	Unit Heater
FTG.	Footing	U.V.	Unit Ventilator
FDN	Foundation	U.O.N.	Unless Otherwise Noted
FURN.	Furnish, Furnishings, Furniture	VEST.	Vestibule
FURR.	Furred, Furring	VCT.	Vinyl Composition Tile
GA.	Gauge	W.P.	Waterproofing
GALV.	Galvanized	W.W.F.	Welded Wire Fabric
GYP. BD.	Gypsum Board	W.BD.	White Board
G.C.	General Contractor	W	With
H.C.	Handicapped	WD.	Wood

ARCHITECTURAL SYMBOLS	
	EXISTING WALL
	WALL TO BE DEMOLISHED
	NEW STUD WALL
	NEW CMU WALL
	NEW FOUNDATION WALL
	ROOM NAME / ROOM NUMBER
	SECTION MARKER
	ELEVATION MARKER
	DOOR IDENTIFICATION
	WINDOW IDENTIFICATION
	WALL IDENTIFICATION
	COLUMN IDENTIFICATION
	ELEVATION MARKER
	EXISTING DOOR
	NEW DOOR

WALL NOTES	
1.	FIRECODE GYPSUM BOARD IN A ONE OR TWO HOUR RATED PARTITION MUST BEAR THE U.L. CLASSIFICATION.
2.	ALL FIRE AND SMOKE RESISTANT SEPARATIONS ARE TO EXTEND OR BE EXTENDED TO THE UNDERSIDE OF FLOOR OR ROOF DECK ABOVE, TYPICAL.
3.	FOR SMOKE RESISTANT SEPARATIONS, PROVIDE FIRE SAFING AND SEALANT AT FLOOR, ROOF DECK AND ALL PENETRATIONS TO PREVENT THE PASSAGE OF SMOKE.
4.	FOR ALL FIRE RATED PARTITIONS, PROVIDE FIRE SAFING AND SEALANT AT FLOOR, ROOF DECK AND ALL PENETRATIONS TO PREVENT THE PASSAGE OF SMOKE. THE FIRE SAFING AND SEALANT SYSTEM MUST MAINTAIN THE RATING OF THE SEPARATION
5.	AT ALL NON-RATED PARTITIONS, FILL ALL VOIDS INCLUDING METAL DECK FLUTES WHERE PARTITIONS MEET THE STRUCTURE ABOVE WITH BATT INSULATION.
6.	AT ALL NON-RATED PARTITIONS, FILL ALL VOIDS BETWEEN PIPES, ELECTRICAL CONDUITS, DUCTWORK, ETC. WHERE THEY PENETRATE WALLS, WITH BATT INSULATION
7.	PROVIDE SMOKE DAMPERS AT ALL MECHANICAL PENETRATIONS THROUGH ONE HOUR RATED SMOKE BARRIERS.
8.	PROVIDE FIRE DAMPERS AT ALL MECHANICAL PENETRATIONS THROUGH TWO HOUR FIRE RATED PARTITIONS.
9.	EXTEND ALL METAL STUD PARTITIONS UNDERSIDE OF DECK/STRUCTURE, UNLESS OTHERWISE NOTED.
10.	AT ALL NON-RATED PARTITIONS AND PARTITIONS WITH NO S.T.C. REQUIREMENTS, EXTEND SHEATHING TO THE FINISHED CEILING CONSTRUCTION, TYPICAL.
11.	SEE WALL SECTIONS FOR EXTERIOR WALL CONSTRUCTION

ELECTRICAL MOUNTING HEIGHTS	
1.	ALL DIMENSIONS ARE TO THE CENTER OF THE DEVICE UNLESS OTHERWISE NOTED. SEE ELECTRICAL DRAWINGS FOR TYPES AND LOCATIONS.
2.	RECEPTACLES: 18" A.F.F. (AT LOCATIONS ABOVE CASEWORK, MOUNT BOTTOM OF RECEPTACLE AT 2" ABOVE BACKSPASH, AT LOCATIONS BELOW CASEWORK, MOUNT AT 24" A.F.F.)
3.	WIREMOLD: 24" A.F.F. (AT LOCATIONS ABOVE CASEWORK, MOUNT BOTTOM OF WIREMOLD AT 2" ABOVE BACKSPASH)
4.	EXTERIOR RECEPTACLES: 24" A.F.F. (20" A.F.F.)
5.	SWITCHES: 48" A.F.F.
6.	BOILER EMERGENCY SWITCHES: 60" A.F.F.
7.	DATA / PHONE OUTLETS: 18" A.F.F.
8.	TV OUTLETS: 18" A.F.F. OR 18" BELOW FINISHED CEILING
9.	WALL PHONE: 48" A.F.F. TO CENTER OF EARPIECE
10.	SECURITY KEYPAD: 48" A.F.F.
11.	MICROPHONE WALL JACK: 18" A.F.F.
12.	FIRE ALARM PULL STATION: 48" A.F.F.
13.	FIRE ALARM VISUAL / AUDIO INDICATING UNITS: 6"-8" TO BOTTOM OF UNIT
14.	AREA OF REFUGE CALL STATION: 48" A.F.F.
15.	EMERGENCY SHUT-OFF SWITCH / PUSH BUTTON: 48" A.F.F.
16.	EMERGENCY CALL SWITCH: 36" A.F.F.
17.	EMERGENCY CALL BELL / LIGHT: +/- 7'-6" A.F.F. - CENTER ABOVE DOOR

CODES	
INTERNATIONAL BUILDING CODE	2012
IBC CONNECTICUT SUPPLEMENT	2016
INTERNATIONAL EXISTING BUILDING CODE	2012
INTERNATIONAL MECHANICAL CODE	2012
INTERNATIONAL PLUMBING CODE	2012
NFPA 70 NATIONAL ELECTRIC CODE	2014
INTERNATIONAL ENERGY CONSERVATION CODE	2012
REHABILITATION ACT 1973, SECTION 504 INCLUDING UNIFORM FEDERAL ACCESSIBILITY STANDARDS (UFAS) AND SECTION 504 REGULATIONS	
ICC/ANSI A117.1 - 2009 INCLUDING THE CURRENT CONNECTICUT BASIC BUILDING CODE	
THE AMERICANS WITH DISABILITIES ACT, TITLE II, INCLUDING THE AMERICANS WITH DISABILITIES ACT ACCESSIBILITY GUIDELINES (ADAAG) AND ADA REGULATIONS	
(H) CURRENT CONNECTICUT PUBLIC HEALTH CODES	
(O) CURRENT O.S.H.A. - TITLE 29 LABOR	
(GS) CONNECTICUT GENERAL STATUTES	

GENERAL NOTES	
1.	GENERAL CONTRACTOR TO NOTIFY ARCHITECT OF ANY INCONSISTENCIES IN THE DRAWINGS, EXISTING CONDITIONS OR THE PROPOSED CONSTRUCTION IMMEDIATELY.
2.	GENERAL CONTRACTOR TO TAKE AND VERIFY ALL DIMENSIONS AND CONDITIONS ON THE JOB AND SHALL BE HELD RESPONSIBLE FOR THE SAME.
3.	ALL NOTES AND DIMENSIONS DESIGNATED AS "TYP." OR "TYPICAL" APPLY TO ALL SIMILAR CONDITIONS THROUGHOUT THE PROJECT.
4.	THESE PLANS ARE NOT TO BE SCALED FOR CONSTRUCTION PURPOSES. DIMENSION LINES AND NOTES SUPERSEDE ALL SCALED REFERENCES.
5.	ALL DIMENSIONS ARE TO FACE OF MASONRY, FACE OF STUD AND CENTERLINE OF STRUCTURAL STEEL COLUMNS UNLESS OTHERWISE NOTED.
6.	PROVIDE A DIVIDER STRIP AT ALL DOOR THRESHOLDS WHERE TWO DIFFERENT FINISHES MEET UNLESS OTHERWISE NOTED.
7.	CONTRACTOR WILL BE ALLOWED TO WORK IN MAXIMUM (4) APARTMENT UNITS AT A TIME.
8.	TENANTS WILL BE ALLOWED TO OCCUPY UNDISTURBED AREAS OF THEIR APARTMENTS DURING CONSTRUCTION. CONTRACTOR IS TO ENSURE AN OPERABLE TOILET IS AVAILABLE TO THE TENANT AT THE END OF WORKING HOURS.

FINISHES	
GYPSUM BOARD	
1.	PROVIDE AND INSTALL GYPSUM WALL BOARD IN ACCORDANCE WITH AMERICAN STANDARD SPECIFICATIONS FOR THE APPLICATION AND FINISHING OF GYPSUM WALLBOARD, AS APPROVED BY THE AMERICAN STANDARDS ASSOCIATION, LATEST EDITION. APPLICABLE PARTS THEREOF ARE HEREBY MADE A PART OF THIS SPECIFICATION EXCEPT WHERE MORE STRINGENT REQUIREMENTS ARE CALLED FOR IN THE SPECIFICATION, IN LOCAL CODES OR BY THE MANUFACTURER OF THE GYPSUM WALLBOARD, WHOSE REQUIREMENTS SHALL BE FOLLOWED.
2.	PROVIDE AND INSTALL MOISTURE-RESISTANT GYPSUM WALLBOARD WHERE REQUIRED. PROVIDE TYPE X GYPSUM BOARD AS CALLED FOR ON THE DRAWINGS.
PAINT	
1.	APPLICATION OF PAINT OR OTHER COATING SHALL BE IN STRICT ACCORDANCE WITH MANUFACTURER'S INSTRUCTIONS. READY-MIXED PAINT SHALL NOT BE THINNED, EXCEPT AS PERMITTED IN THE APPLICATION INSTRUCTIONS AND WITH PRIOR APPROVAL.
FLOORING MATERIAL	
1.	INSTALL CERAMIC TILE OR NATURAL STONE TILE IN COMPLIANCE WITH PERTINENT RECOMMENDATIONS CONTAINED IN THE TILE COUNCIL OF AMERICA "HANDBOOK FOR CERAMIC TILE INSTALLATION" AND MANUFACTURER'S INSTRUCTIONS.
2.	PROVIDE MANUFACTURER APPROVED UNDERLAYMENT FOR ALL FLOORING TYPES CALLED OUT IN CONTRACT DOCUMENTS

DEMOLITION NOTES	
1.	REMOVE ALL MATERIALS, ASSEMBLIES AND CONSTRUCTED ELEMENTS AS REQUIRED TO ACCOMMODATE THE NEW CONSTRUCTION.
2.	PROTECT ALL EXISTING FINISHES AND SPACES NOT AFFECTED BY THE CONSTRUCTION OR DIRECTLY ADJACENT TO THE CONSTRUCTION. ALL EXISTING FINISHES AFFECTED BY THE DEMOLITION WORK ARE TO BE RETURNED TO A STATE OF FINISH EQUIVALENT TO THAT PRIOR TO COMMENCEMENT OF THE WORK.
3.	PROVIDE DUST-PROOF PARTITIONS SEPARATING THE DEMOLITION AND WORK AREAS FROM AREAS UNAFFECTED BY THE CONSTRUCTION.
4.	CLEAN ALL AREAS OF THE PROJECT PERIODICALLY TO MAINTAIN A SAFE AND CLEAR WORKING ENVIRONMENT. PROVIDE FINAL CLEANING OF THE ENTIRE PROJECT SITE AT THE COMPLETION OF THE PROJECT WORK.
5.	PROVIDE TEMPORARY SHORING OR BRACING AS REQUIRED TO PROPERLY COMPLETE THE WORK. COORDINATE SHORING WITH ALL SUB-CONTRACTORS, AND NOTIFY THE ARCHITECT OF ANY PROBLEMS OR CONCERNS IMMEDIATELY.
6.	ENSURE THAT EXISTING MECHANICAL AND ELECTRICAL SYSTEMS CONTINUE TO FUNCTION AS PRACTICAL THROUGHOUT THE CONSTRUCTION PROCESS. COORDINATE WITH THE OWNER DIRECTLY ANY TIME PERIODS DURING WHICH ESSENTIAL SERVICES MAY BE NON-FUNCTIONING OR DISCONNECTED.
7.	REMOVE EXISTING ROOF AND SIDING AS REQUIRED TO ACCOMMODATE THE NEW CONSTRUCTION. ERECT TEMPORARY BARRIERS OR PROTECTIONS AS NECESSARY TO PROTECT THE EXISTING BUILDING FROM THE ELEMENTS DURING THE CONSTRUCTION PROCESS.

ELECTRICAL NOTES	
1.	ELECTRICAL CONTRACTOR SHALL VERIFY EXISTING CONDITIONS PRIOR TO COMMENCING WORK.
2.	ELECTRICAL CONTRACTOR SHALL DESIGN, PURCHASE AND INSTALL ALL NEW COMPONENTS AS REQUIRED TO PROPERLY SERVICE THE SPACE(S) AFFECTED BY THIS CONSTRUCTION PROJECT. IF THE MODIFICATION OF EXISTING ELECTRICAL SYSTEMS IS NECESSARY, SUCH MODIFICATIONS SHALL NOT ADVERSELY AFFECT THE OPERATION OF THESE SYSTEMS.
3.	COORDINATE ELECTRICAL WORK WITH THE WORK OF OTHER TRADES. DO NOT ALTER THE WORK OF PREVIOUS TRADES WITHOUT PRIOR APPROVAL.
4.	PERFORM ALL NEW ELECTRICAL WORK IN ACCORDANCE WITH LOCAL CODES AND ACCEPTED STANDARDS OF PRACTICE.
5.	COORDINATE THE FINAL LOCATION OF ALL ELECTRICAL DEVICES AND THEIR INTENDED OPERATION WITH THE OWNER.

**CRITICAL NEEDS IMPROVEMENTS AT:**  
**McKENNA COURT**  
**WALLINGFORD HOUSING AUTHORITY**  
**WALLINGFORD, CT**  
**McKENNA COURT**

Sheet Description:  
**GENERAL NOTES**

Issue Dates: 3/25/19

Project #: **1929**      Drawn By: **bap**

Sheet #:  
**G1.0**

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PROJECT DESCRIPTION FOR:  
**MCKENNA APT. REHAB**  
 CITY / TOWN  
 STREET ADDRESS


Sheet Description:  
 SITE FIRE  
 ALARM PLAN

Issue Dates:  
 Final Drawings - 03/29/2019

Project #: 19051  
 Drawn By: SES

Sheet #:

**FA3.1**

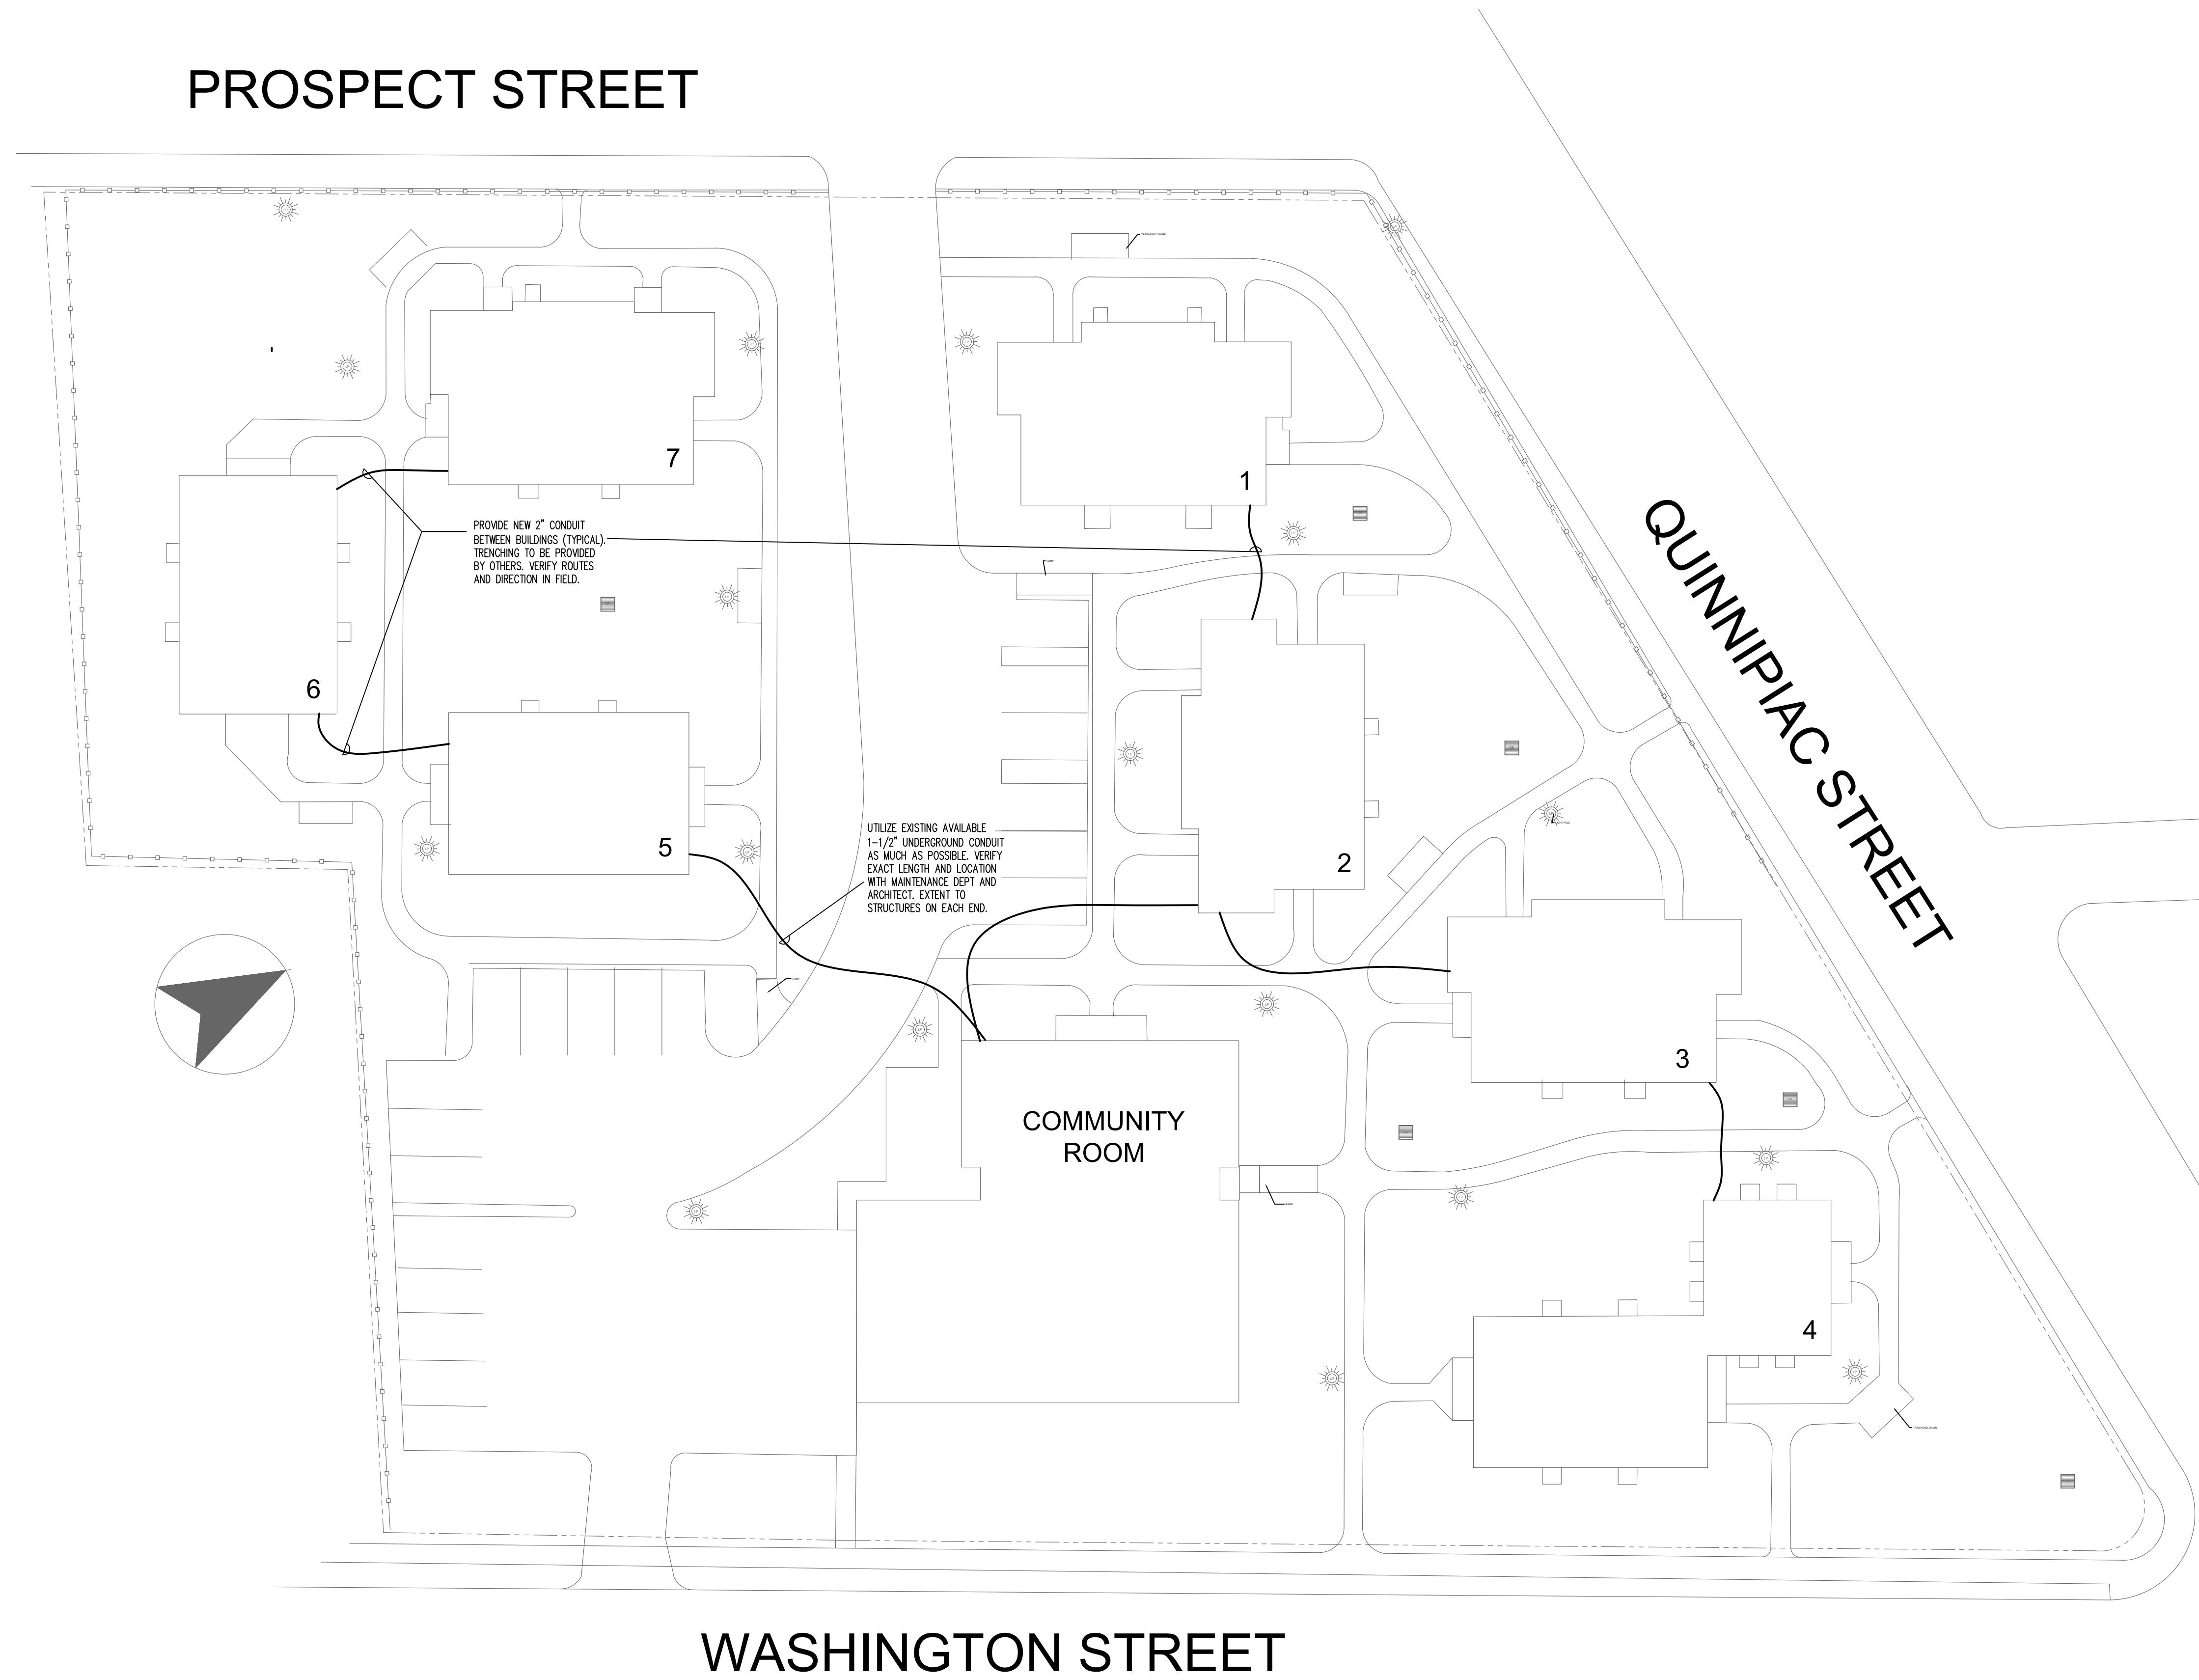

**SITE KEY PLAN**  
 SCALE: 20' = 1'-0"

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PROJECT DESCRIPTION FOR:  
**MCKENNA APT. REHAB**  
 CITY / TOWN  
 STREET ADDRESS


Sheet Description:  
 FIRE ALARM  
 TYPICAL UNIT  
 FLOOR PLAN AND  
 RISER DIAGRAM

Issue Dates:  
 Final Drawings - 03/29/2019


Project #: 19051  
 Drawn By: SES

Sheet #:

**FA3.2**


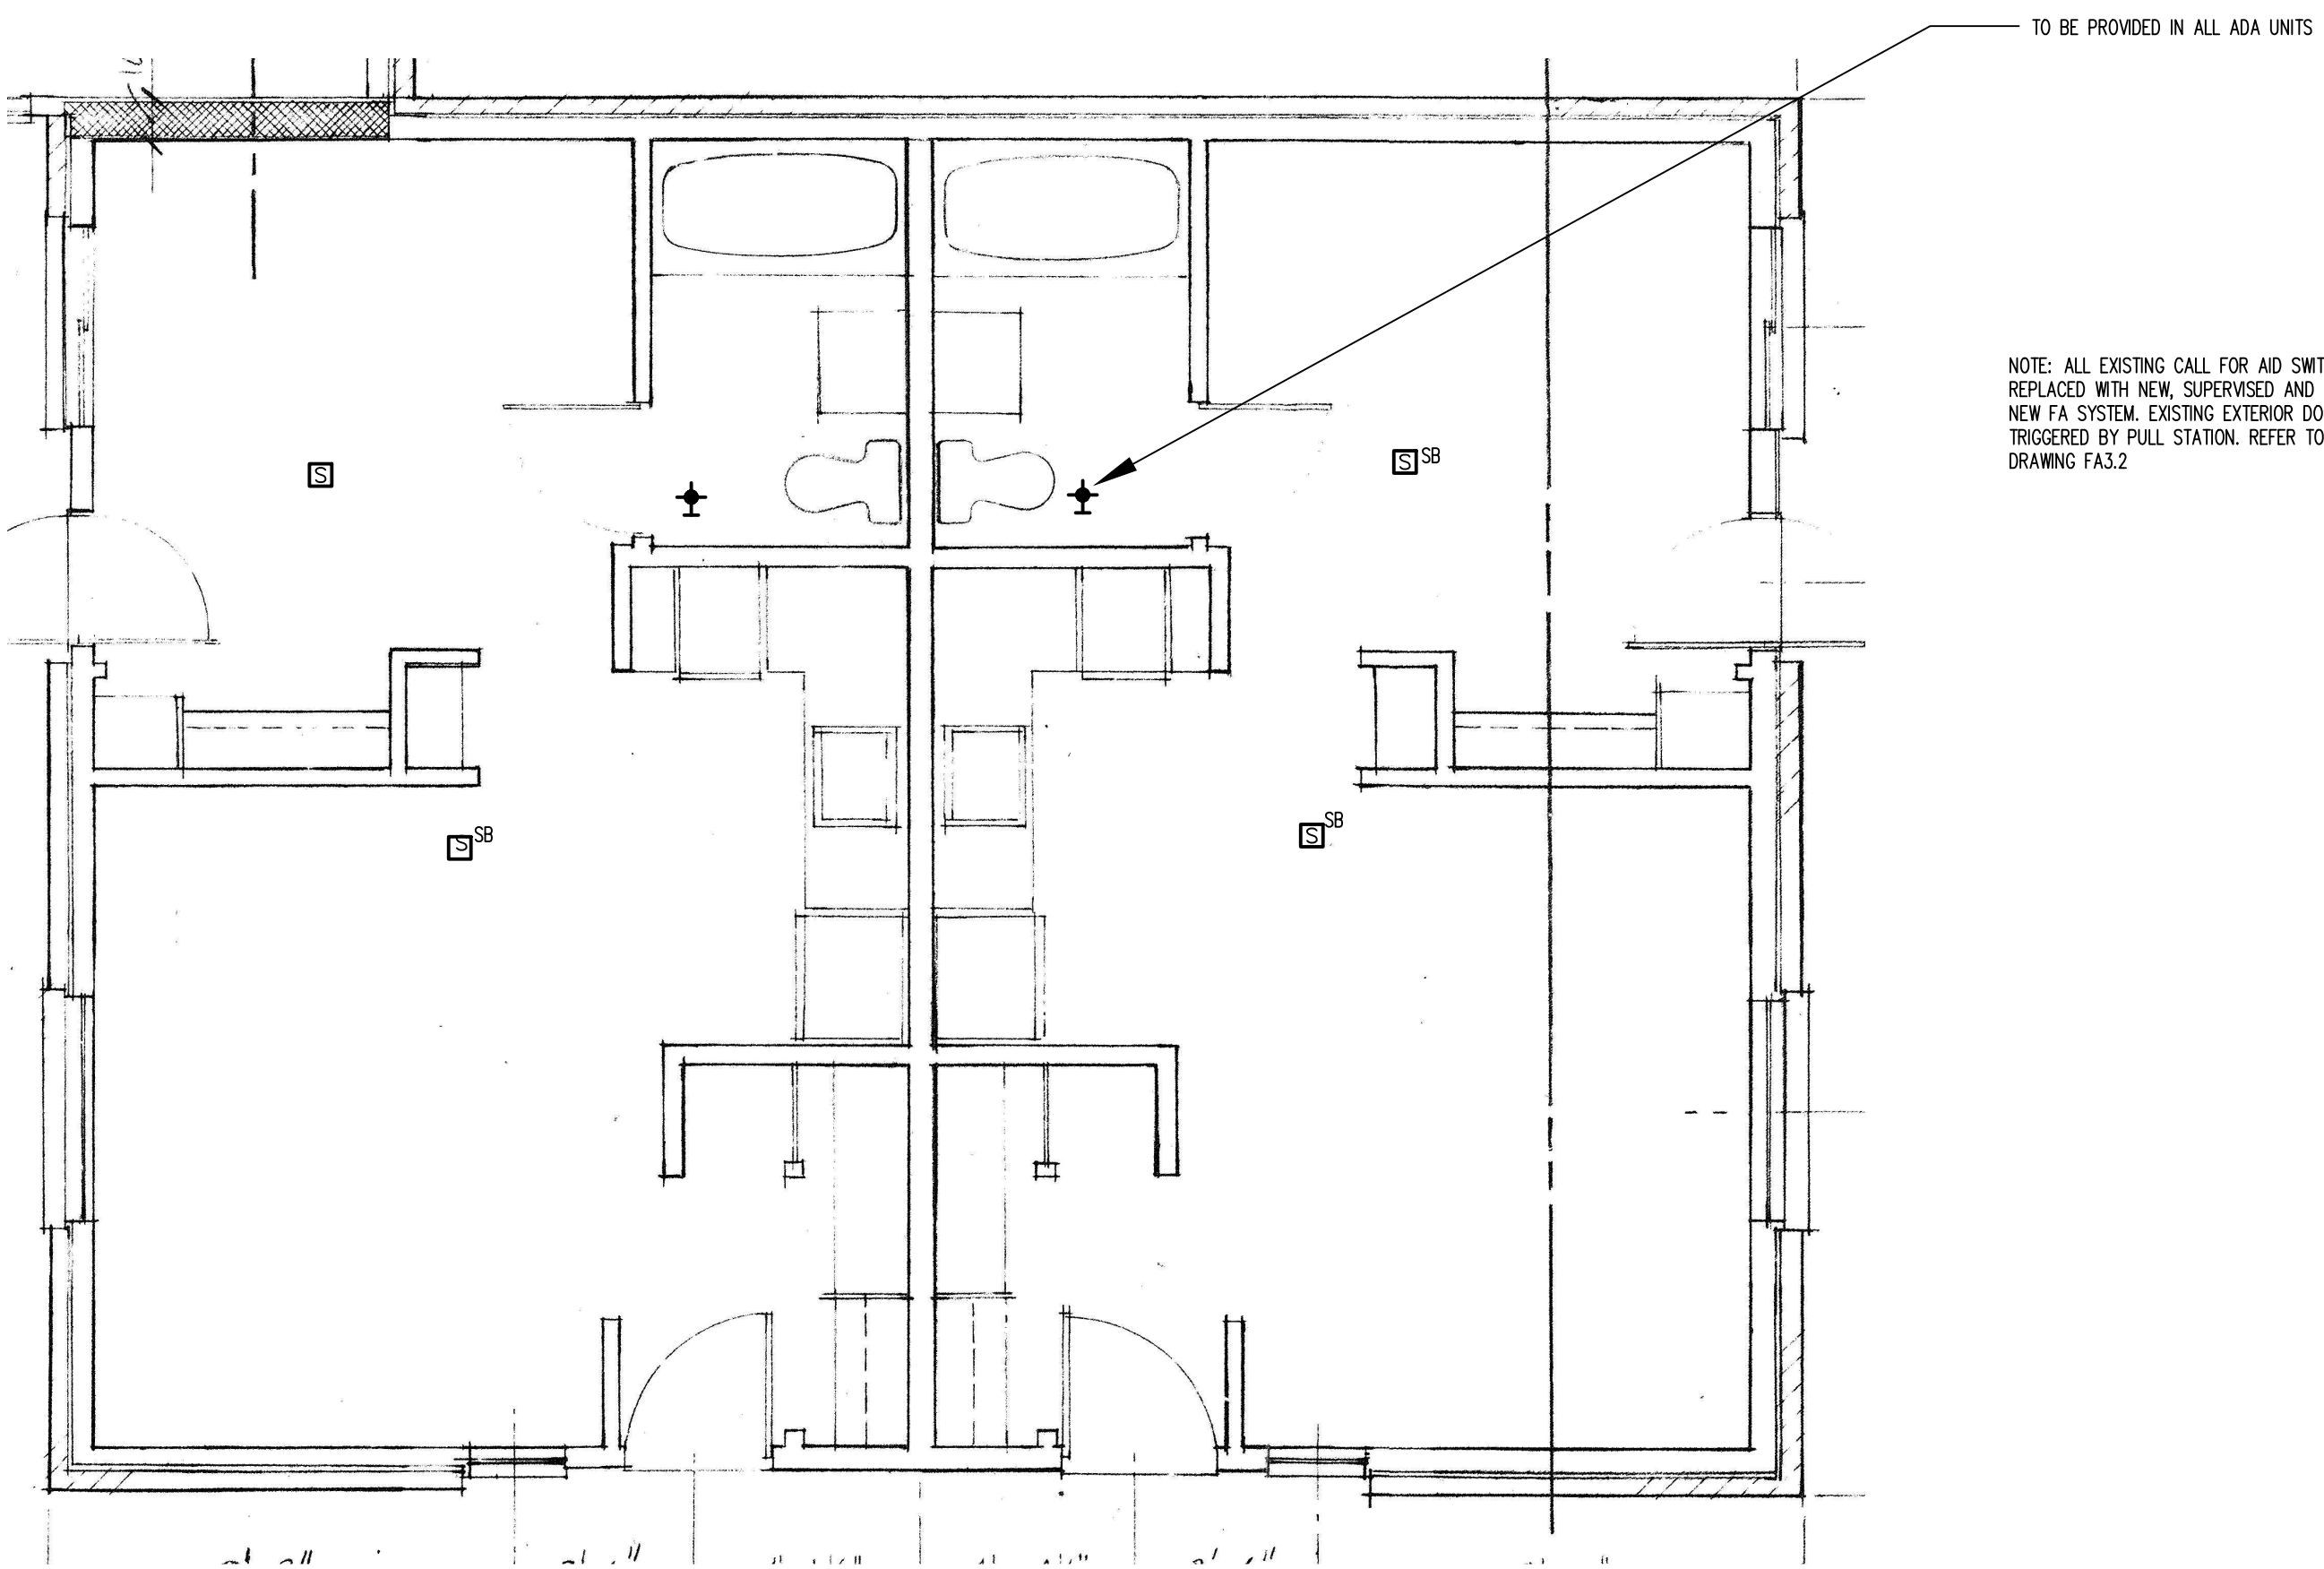


**TYPICAL 1 BEDROOM UNIT FLOOR PLAN**  
 SCALE: NTS

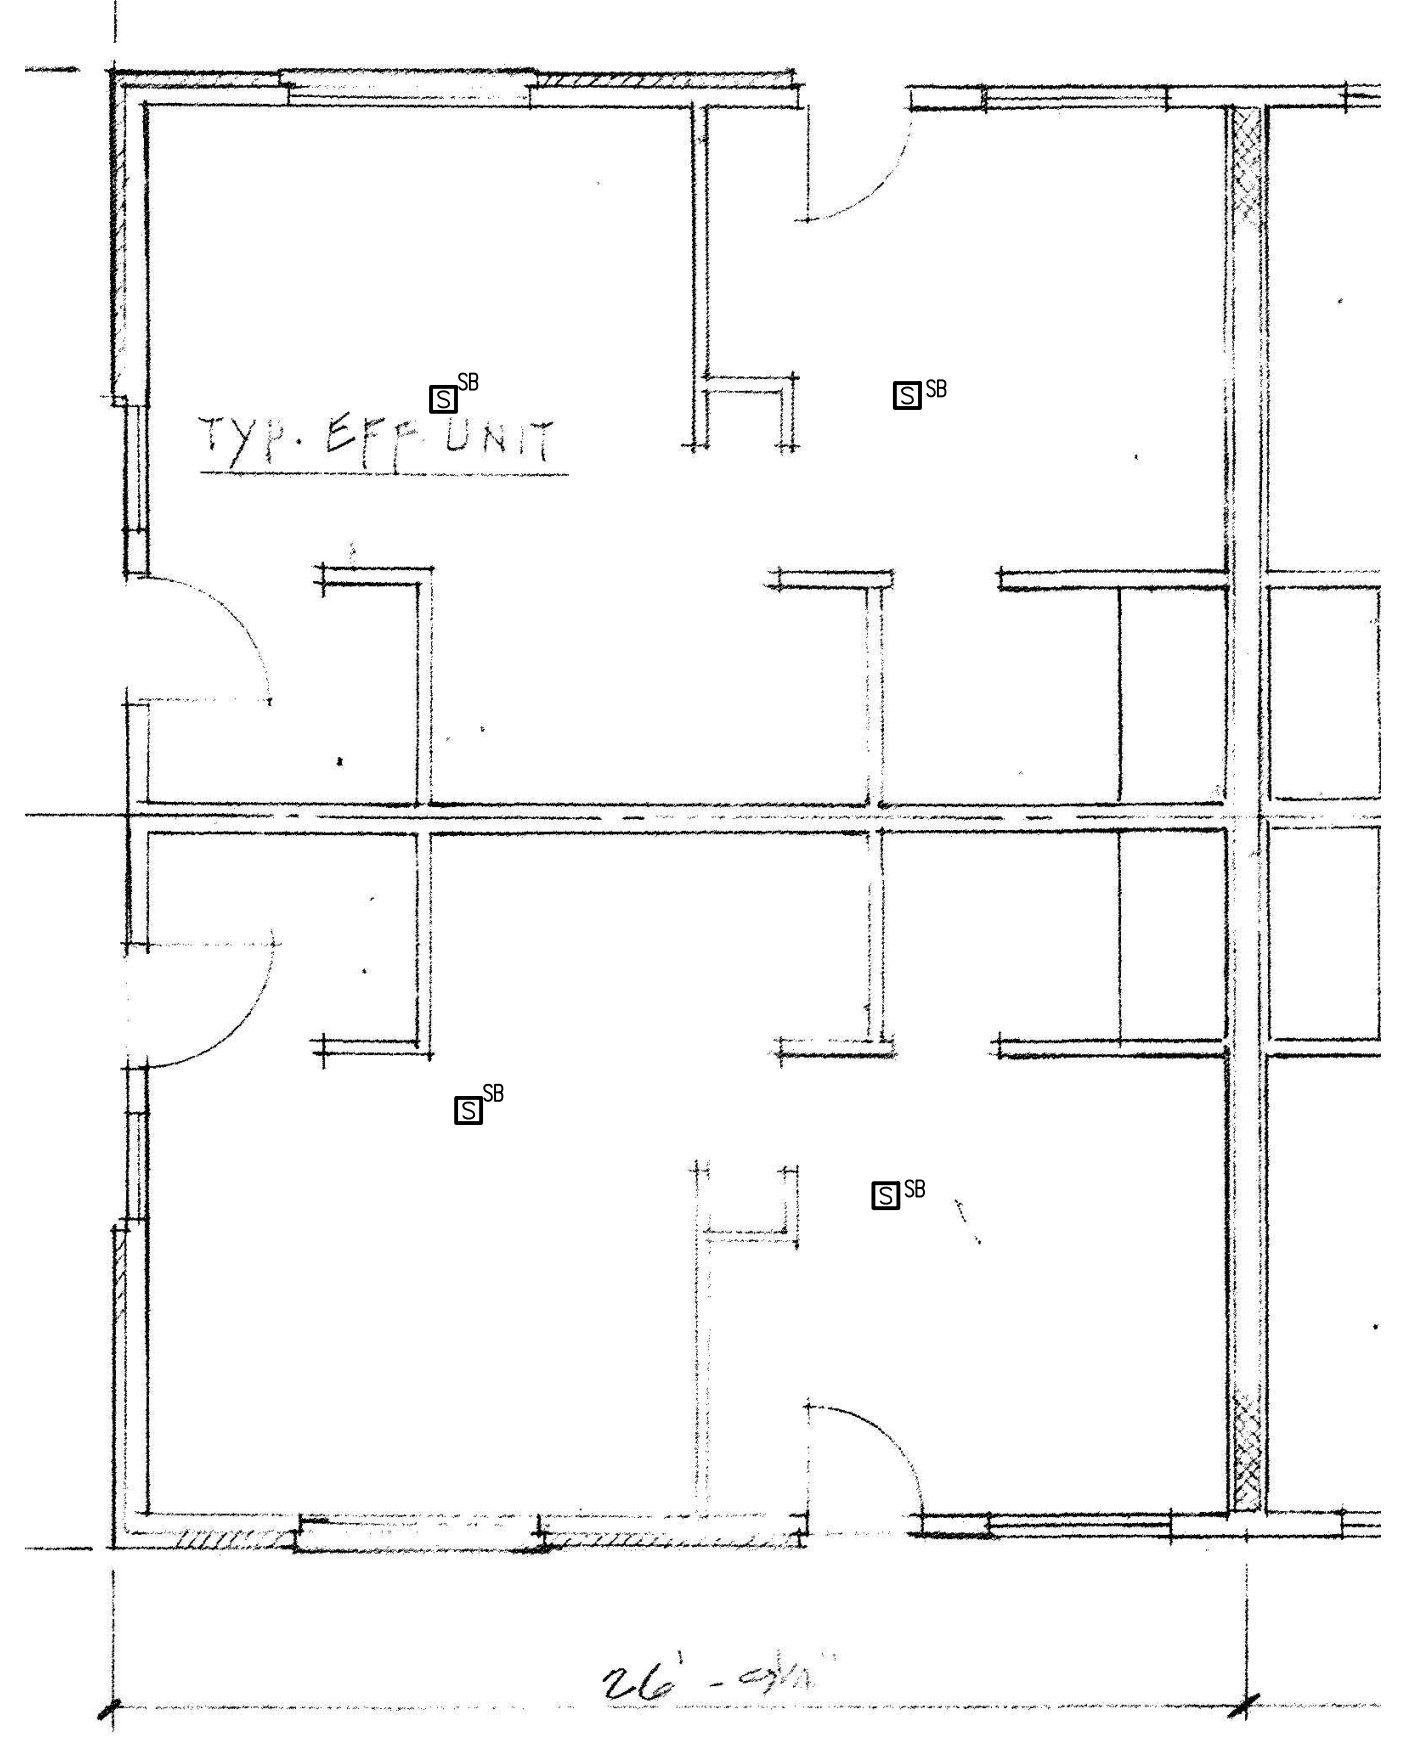


**TYPICAL EFFICIENCY UNIT FLOOR PLAN**

TO BE PROVIDED IN ALL ADA UNITS  
 NOTE: ALL EXISTING CALL FOR AID SWITCHES WILL BE REPLACED WITH NEW, SUPERVISED AND CONNECTED TO THE NEW FA SYSTEM. EXISTING EXTERIOR DOME LIGHTS WILL BE TRIGGERED BY PULL STATION. REFER TO RISER DIAGRAM ON DRAWING FA3.2

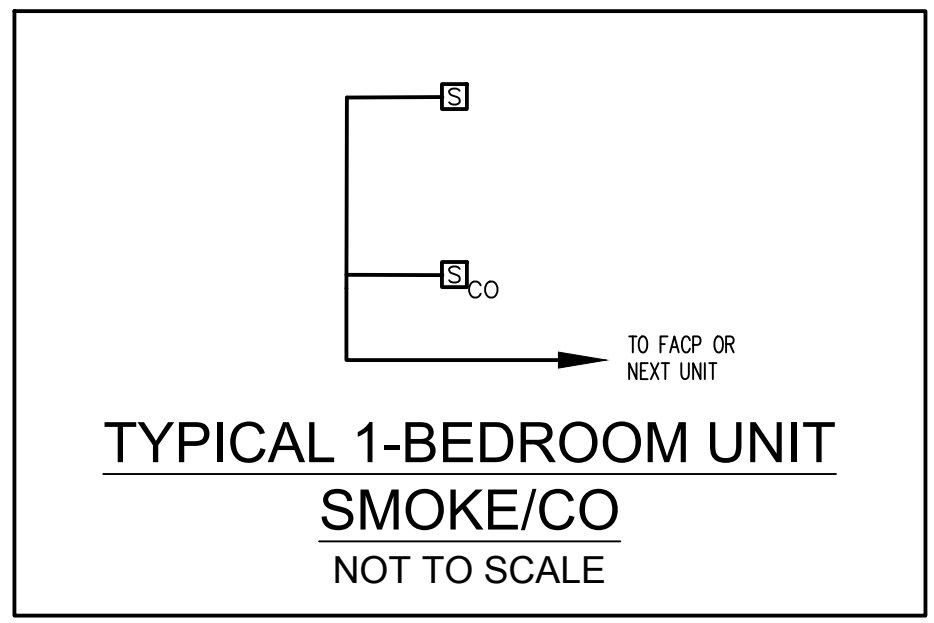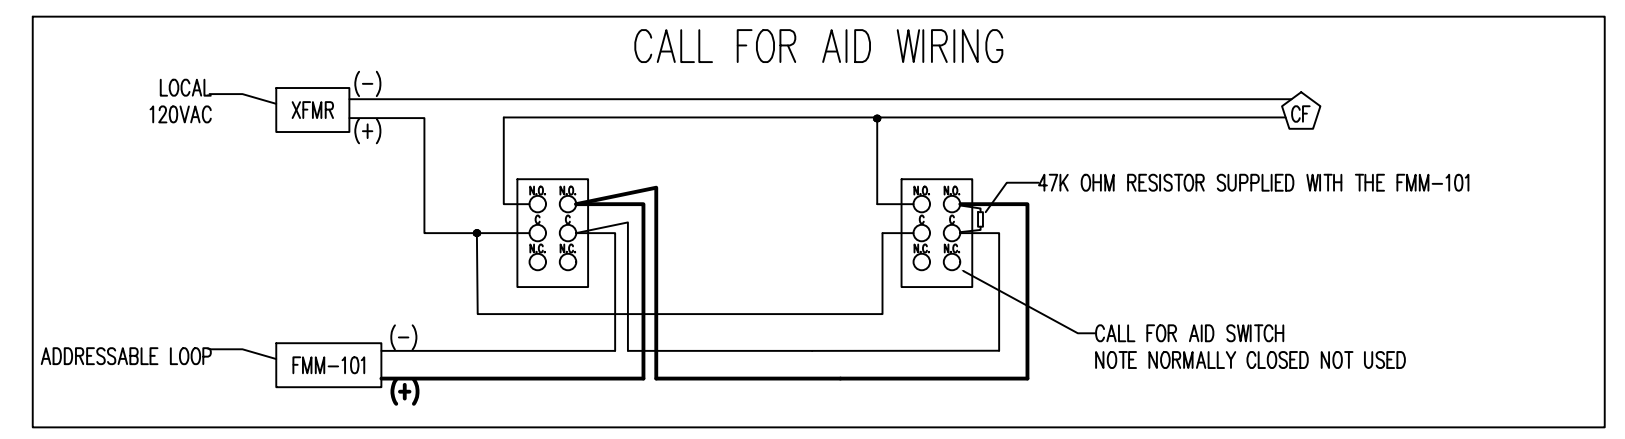

FIRE ALARM SYMBOL LIST	
⚡	STROBE LIGHT
☐ LF	FIRE ALARM COMBINATION HORN/STROBE; LF DENOTES LOW FREQUENCY HORN/STROBE
☐ S	FIRE ALARM COMBINATION SPEAKER/STROBE
☐ LF	FIRE ALARM HORN; LF DENOTES LOW FREQUENCY HORN.
M	FIRE ALARM MAG DOOR HOLDER
F	FIRE ALARM MANUAL PULL STATION
TS	FIRE ALARM TAMPER SWITCH
FS	FIRE ALARM FLOW SWITCH
S CO SB	FIRE ALARM SMOKE DETECTOR; CO DENOTES CO DETECTOR; SB DENOTES SOUNDER BASE
H	FIRE ALARM HEAT DETECTOR
S CO	STAND ALONE INTERCONNECTED, BATTERY BACK-UP 120 VOLT SMOKE DETECTOR; CO DENOTES COMBINATION CO/SMOKE DETECTOR
CFA	CALL FOR AID SWITCH
CF	CALL FOR AID DOME LIGHT
R	END OF LINE RESISTOR
MI	ADDRESSABLE UNIT INTERFACE

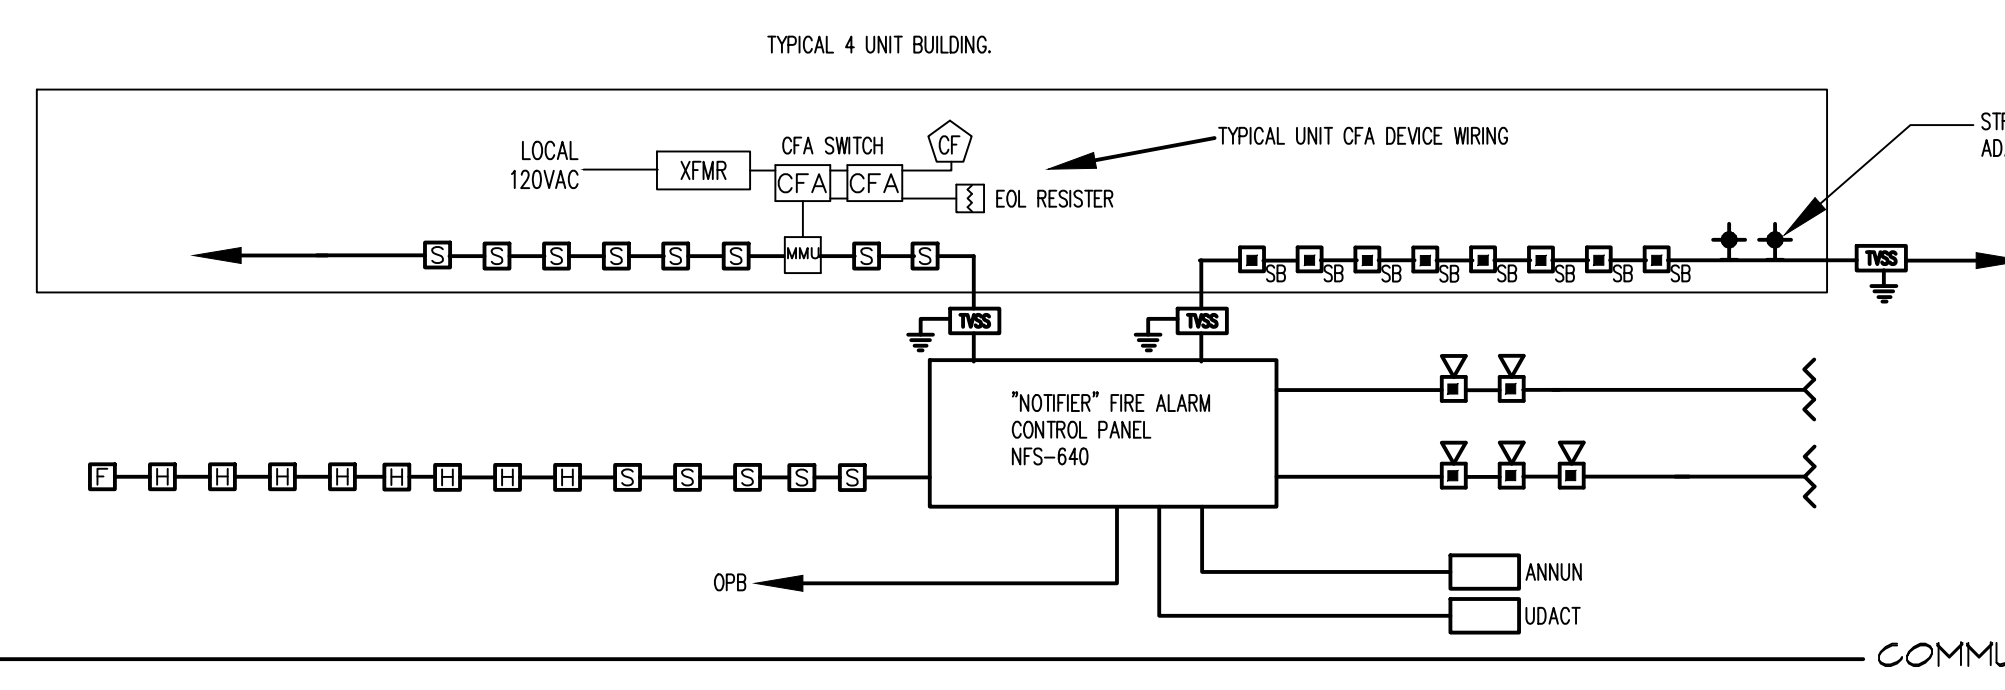

**FIRE ALARM SYSTEM NOTES:**  
 A SIGNAL DETECTED BY A UNIT SMOKE/CO DETECTOR SHALL ACTIVATE ASSOCIATED UNIT ANNUNCIATORS ONLY; A GENERAL ALARM SIGNAL SHALL ACTIVATE ALL ANNUNCIATORS AND ALSO NOTIFY THE FIRE DEPT.  
 H/C UNITS SHALL BE PROVIDED WITH STROBES LIGHTS IN UNIT BEDROOMS; ALL OTHER UNITS SHALL BE ADAPTABLE WITH JUNCTION BOXES PROVIDED IN BEDROOMS WITH CONDUIT AND PULL STRING TO ACCESSIBLE LOCATION OUTSIDE UNIT.  
 PROVIDE ONE HEAT DETECTOR FOR EACH SPRINKLER HEAD IN ELEVATOR MACHINE ROOMS; COORDINATE EXACT NUMBER OF HEADS WITH SPRINKLER CONTRACTOR; LOCATE HEAT DETECTORS WITHIN 2 FEET OF SPRINKLER HEAD AND CONNECT INTO SHUNT-TRIP POWER SYSTEM

**FIRE ALARM RISER DIAGRAMS**  
 NOT TO SCALE

NOTE:  
 CENTRAL ARRANGEMENT SHOWS  
 CONFORM QUANTITIES WITH FLOOR PLANS AND VICE-VERSA  
 PROVIDE TWO DEDICATED PHONE LINES FOR FA3P



**FLOOR PLAN**  
SCALE: 1/4" = 1' 0"

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PROJECT DESCRIPTION FOR:  
**MCKENNA APT. REHAB**  
CITY / TOWN  
STREET ADDRESS

Sheet Description:  
COMMUNITY ROOM  
FIRE ALARM FLOOR  
PLAN

Issue Dates:  
Final Drawings - 03/29/2019

Project #: 19051  
Drawn By: SES

Sheet #:

**FA3.3**