


**WORK IN THIS STAGE**


- CLEAR AND GRUB THROUGHOUT PROJECT
  - INSTALL WATER SHUT OFF VALVES
  - PERFORM TEMP. SIGNALIZATION SITE 1 & SITE 2
  - REMOVE AND STORE MAST ARM ASSEMBLIES
  - INSTALL PAVEMENT MARKINGS AND SHIFT TRAFFIC WEST
  - REMOVE TEMP. BITUMINOUS SIDEWALK
  - REMOVE TEMP. PROTECTIVE FENCING ON EXISTING TPCBC
  - RELOCATE AND PROVIDE ADDITIONAL TPCBC AND REINSTALL PROTECTIVE FENCE ON BARRIER
- PERFORM SEQUENTIALLY FROM NORTHBOUND TO SOUTHBOUND ACTIVITIES AS FOLLOWS:
- RELOCATE IMS CONDUITS UNDER EXISTING SIDEWALK TO ACCOMMODATE INSTALLATION OF TEMP. STEEL BEAM SUPPORTS
  - REMOVE ABANDONED WATER MAIN
  - INSTALL TEMP. BEAM SUPPORT OVER EAST SIDEWALK AND WATER MAIN
  - PERFORM STRUCTURE STEEL HEAT STRAIGHTENING AND INSTALL ADDITIONAL STRUCTURAL STEEL MEMBERS
  - RELOCATE TEMP. BEAM SUPPORT TO SPAN 1 AND REPEAT THE ABOVE

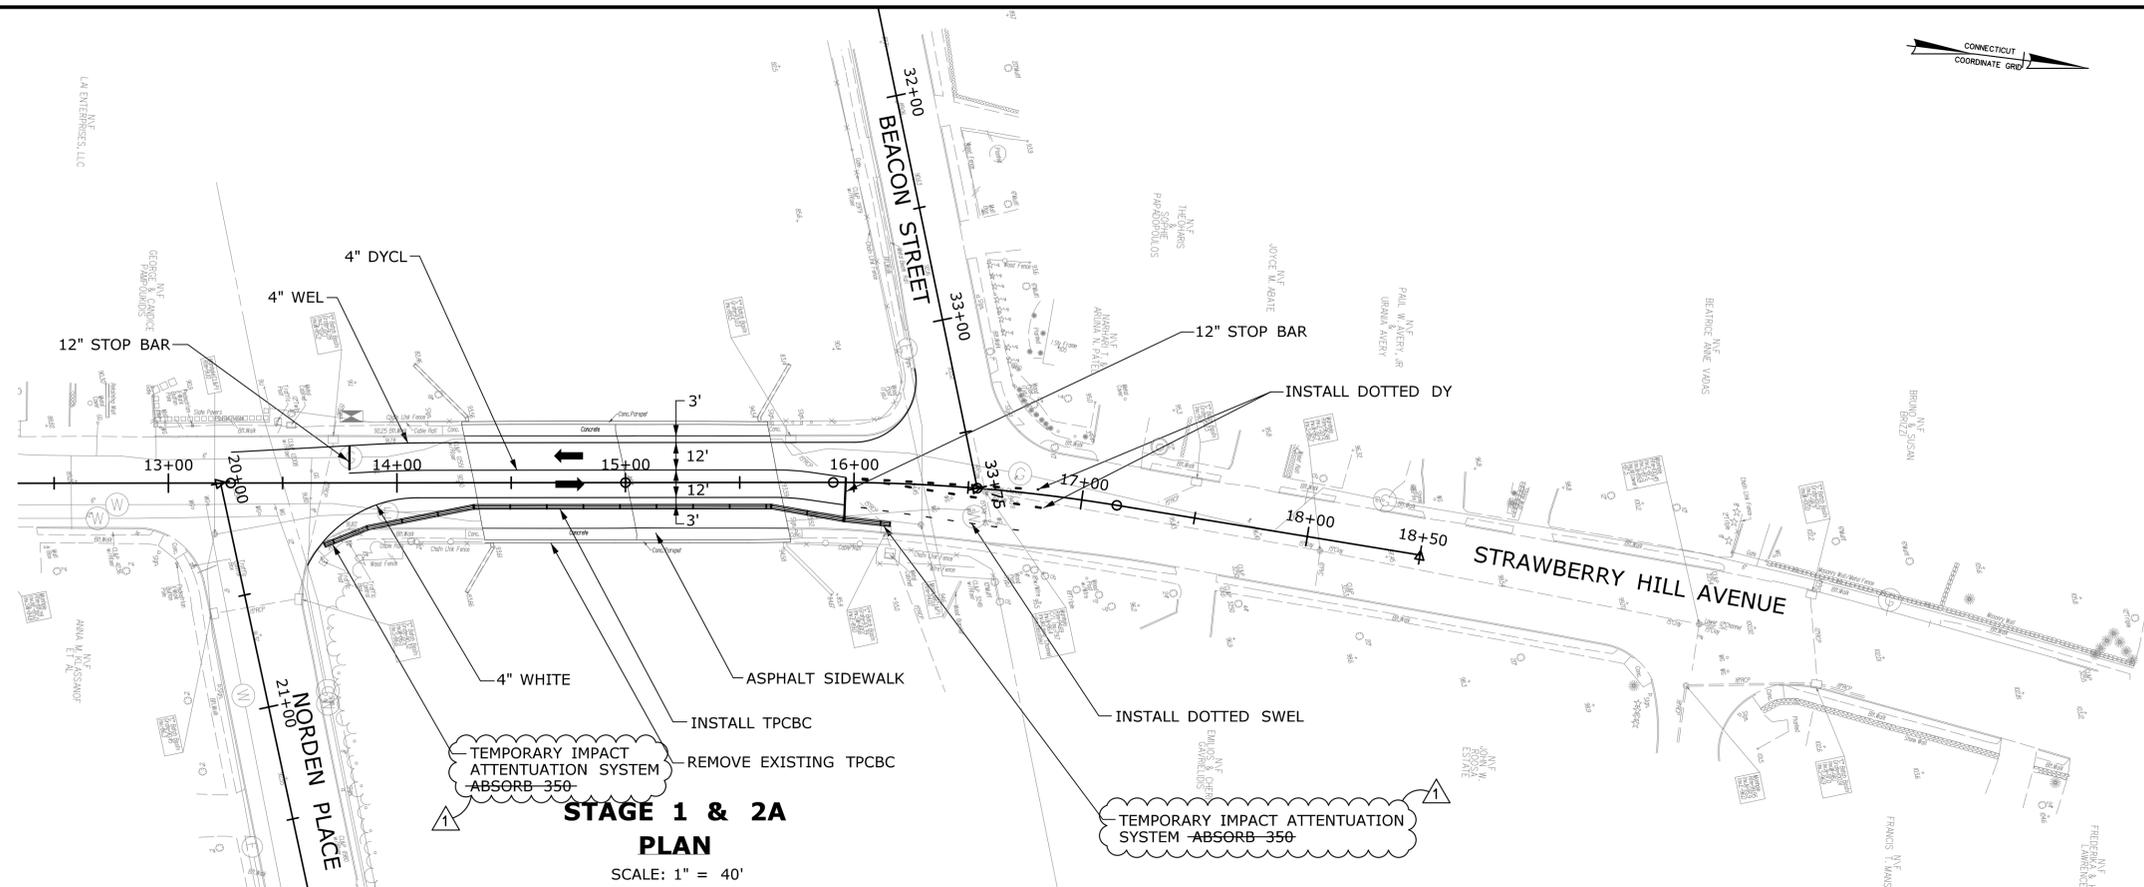

**STAGE 1 & 2A PLAN**  
SCALE: 1" = 40'

**WORK IN THIS STAGE**

- REMOVE EXISTING BRIDGE PROTECTIVE FENCE
- REINFORCE AND INSTALL TEMP. 7' PROTECTIVE FENCE ON TOP OF EXISTING BRIDGE PARAPET
- EXTEND TEMP. PROTECTIVE FENCING NORTH AND SOUTH OF BRIDGE
- CONSTRUCT TEMP. WOOD WALKWAY OVER WATER MAIN
- RELOCATED TPCBC OFF BRIDGE TO BEACON STREET
- INSTALL 15"x32" TPCBC - STRUCTURE (EAST) ALONG WOOD SIDEWALK
- PERFORM TEMP. SIGNALIZATION SITE 1 & SITE 2
- SHIFT TRAFFIC; BEACON STREET TO THE NORTH AND STRAWBERRY HILL AVENUE TO THE EAST
- INSTALL 15"x32" TPCBC - STRUCTURE (WEST) AND TPCBC ALONG STRAWBERRY HILL AVENUE AND DOWN BEACON STREET
- REMOVE MBR & ROW FENCE ALONG BEACON STREET AND WEST SIDE OF BRIDGE
- INSTALL NEW DRAINAGE FACILITIES THROUGHOUT PROJECT
- REMOVE NOISE WALL SECTIONS
- INSTALL TEMP. DECK SUPPORT
- MILL I-95 FOR MPT STAGE SHIFT AND RESET CB TOPS
- PERFORM FULL DEPTH CONCRETE PAVEMENT REPAIRS
- PAVE I-95 HIGHWAY
- INSTALL PAVEMENT MARKINGS AND SHIFT TRAFFIC
- INSTALL TPCBC ALONG I-95 SHOULDERS NORTHBOUND & SOUTHBOUND
- CONSTRUCT NEW IMS FOUNDATION
- INSTALL NORTH/SOUTHBOUND ABUTMENT GROUND ANCHOR SYSTEMS
- REMOVE MEDIAN SOIL AND DEPOSIT ALONG BEACON STREET EMBANKMENT
- CONSTRUCT MEDIAN ACCESS GRAVEL
- INSTALL MEDIAN CONCRETE PIER INFILLS

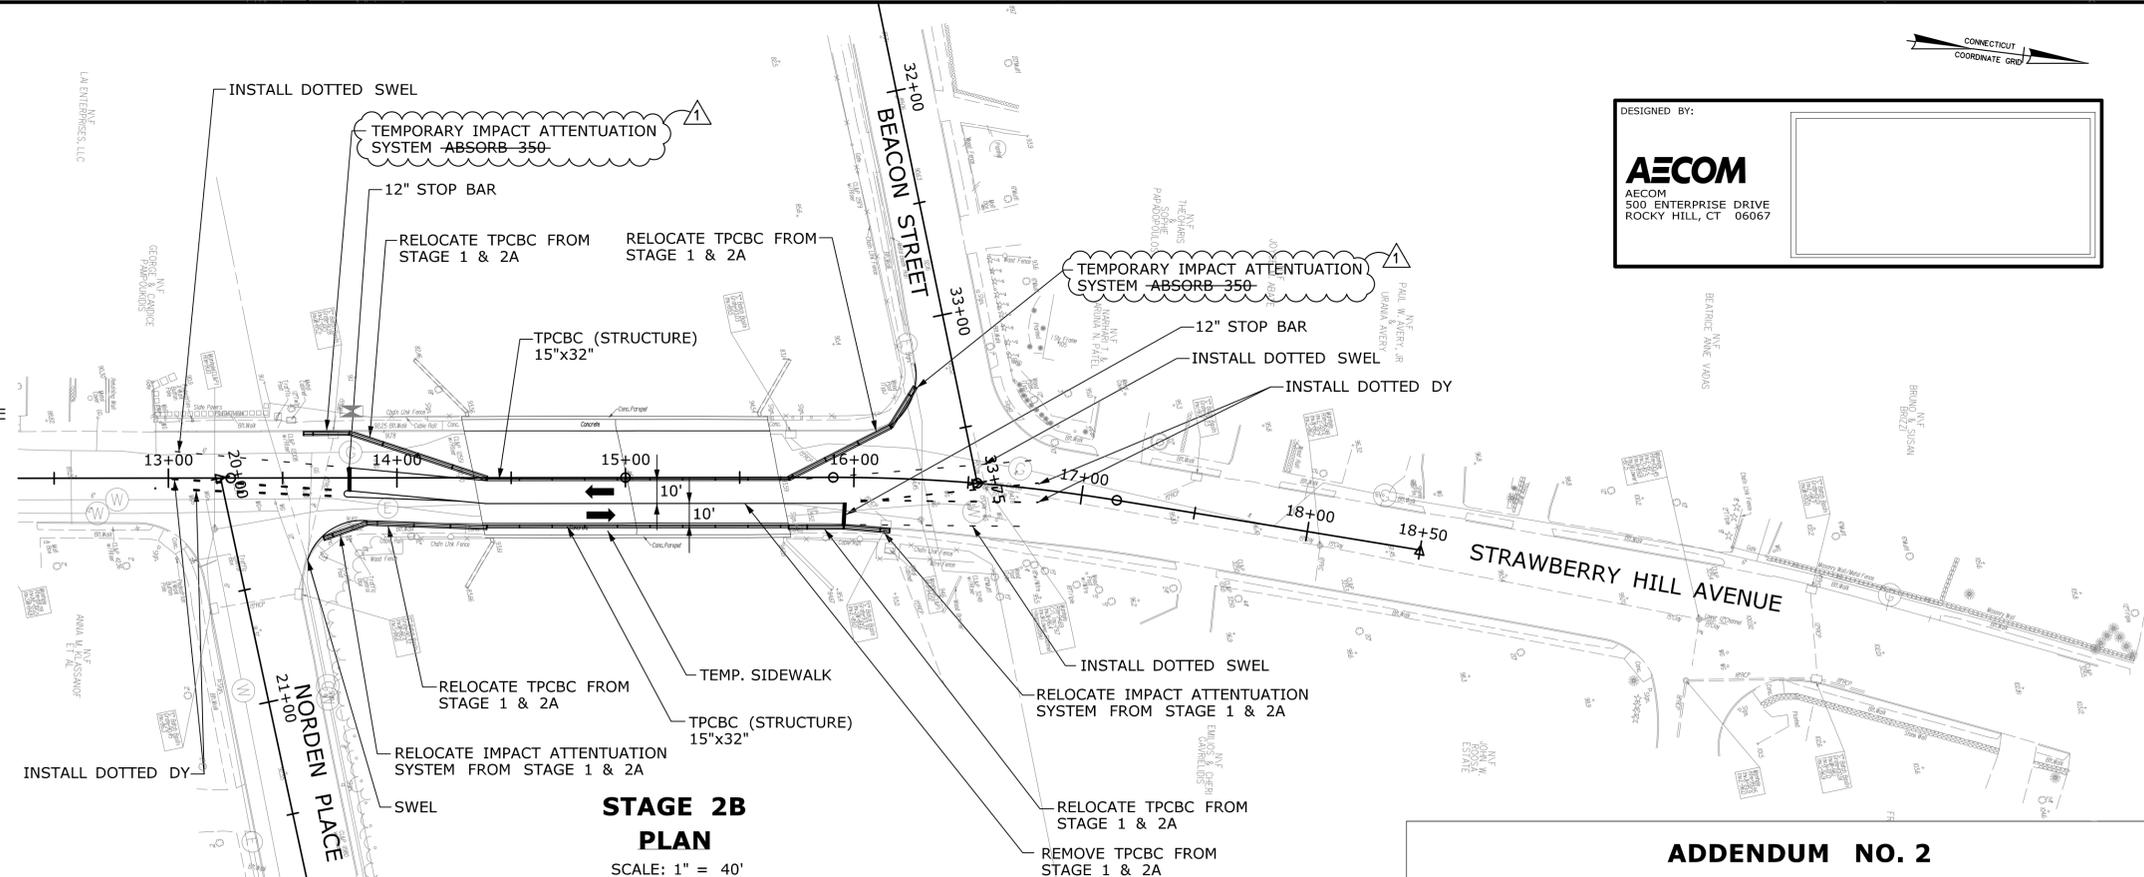

**STAGE 2B PLAN**  
SCALE: 1" = 40'

DESIGNED BY:

**AECOM**  
AECOM  
500 ENTERPRISE DRIVE  
ROCKY HILL, CT 06067

**ADDENDUM NO. 2**

1/28/2019 P:\Projects\Combod\36937900\500 CADD-GIS-Graphics\510 CADD\510.03 Highways\MSta\_Contract\_Sheet\_Sheet102-MPT-02-A2.dgn

REV.	DATE	REVISION DESCRIPTION	SHEET NO.
1	1/23/19	REVISED NOTES	05.06.A2
2	12/21/18	REVISED TEMP. IMPACT ATTENUATORS	05.06.A1

THE INFORMATION, INCLUDING ESTIMATED QUANTITIES OF WORK, SHOWN ON THESE SHEETS IS BASED ON LIMITED INVESTIGATIONS BY THE STATE AND IS IN NO WAY WARRANTED TO INDICATE THE CONDITIONS OF ACTUAL QUANTITIES OF WORK WHICH WILL BE REQUIRED.

Plotted Date: 1/28/2019

DESIGNER/DRAFTER:  
**S. HARLEY**

CHECKED BY:  
**J. KEEFE**

SCALE AS NOTED

**STATE OF CONNECTICUT**  
**DEPARTMENT OF TRANSPORTATION**

STATE OF CONNECTICUT PROFESSIONAL ENGINEER

Filename: ...\\HW\_MSH\_102\_363\_MPT-02-A2.dgn

AECOM  
500 ENTERPRISE DRIVE  
ROCKY HILL, CT 06067

PROJECT TITLE:  
**REHABILITATION OF BRIDGE 00061**  
**STRAWBERRY HILL AVENUE**  
**OVER I-95**

TOWN:  
**NORWALK**

DRAWING TITLE:  
**M&PT**  
**STRAWBERRY HILL AVE**

PROJECT NO.  
**102-363**

DRAWING NO.  
**MPT-02**

SHEET NO.  
**05.06.A2**