
King Philip Middle School Roof Replacement Project The Town Of West Hartford

100 King Philip Drive West Hartford, Connecticut 06117

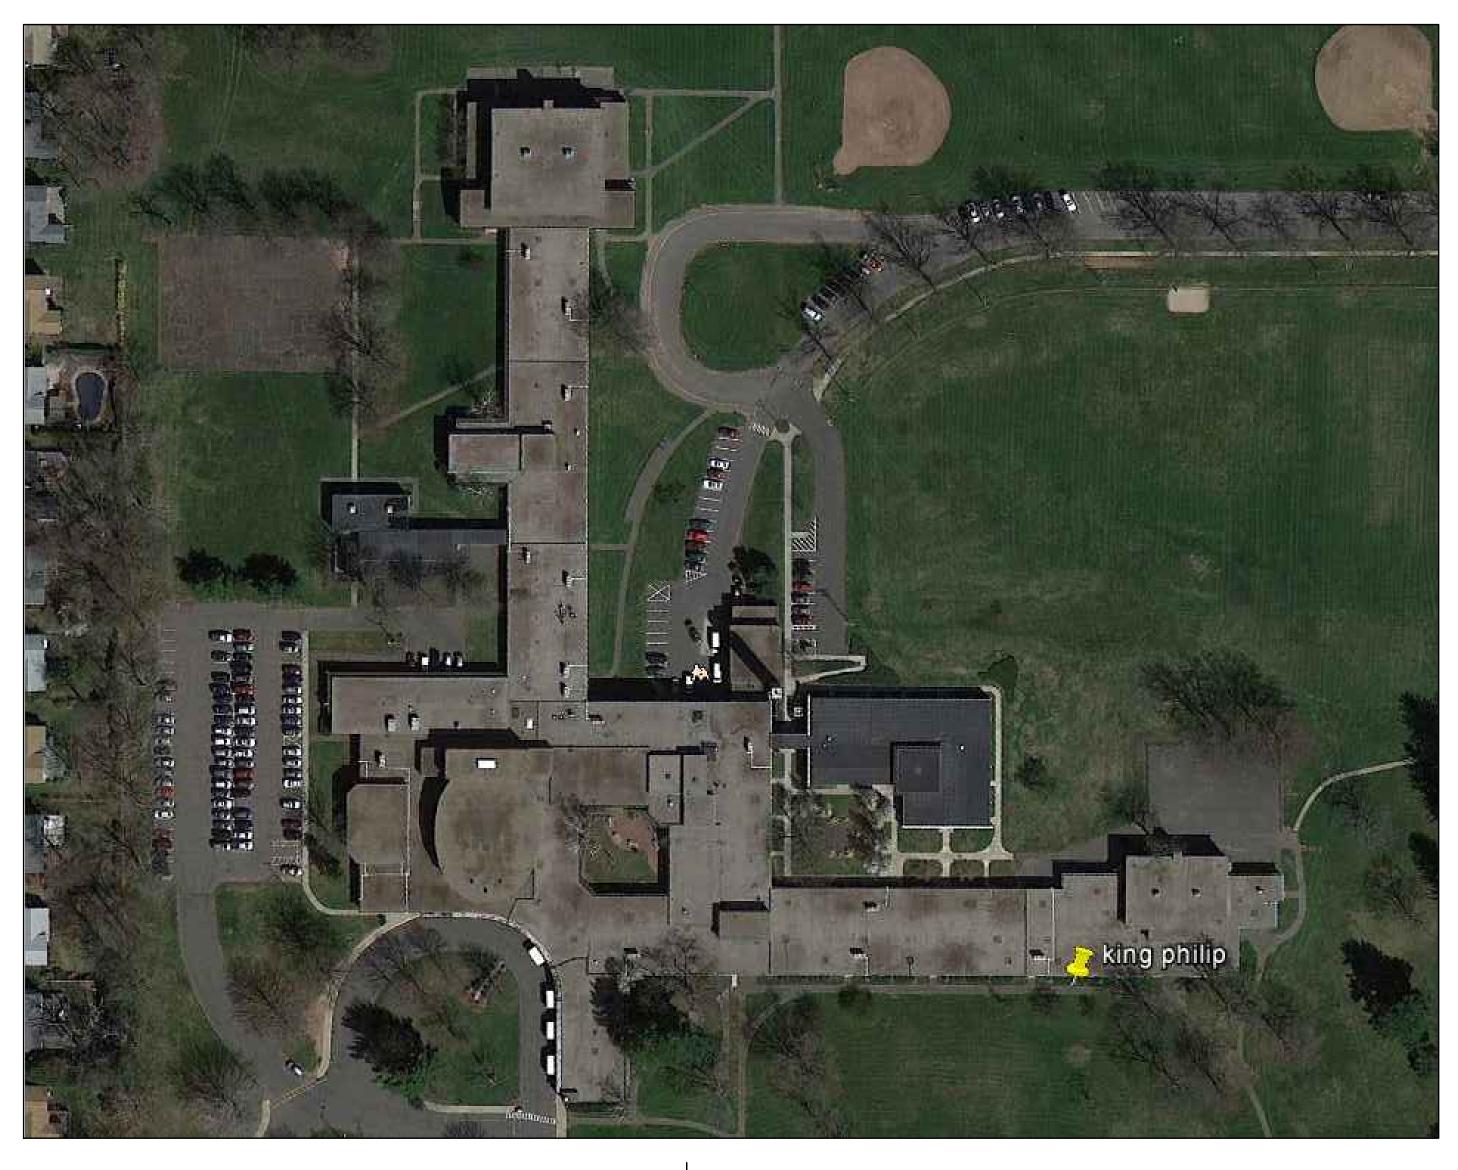

DRAWING LIST:

- Cover Sheet
- C1 Code Information
- A1 Overall Roof Plan
- A2 Roof Plan
- A3 Roof Details
- RP-1 Asbestos & PCB Abatement Plan





SILVER / PETRUCELLI + ASSOCIATES

Architects / Engineers / Interior Designers

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Date: 03/25/2015

Issued for Bid: May 4, 2018


CODE INFORMATION		CONSTRUCTION NOTES &>	DEMOLITION NOTES (1)->	SYMBOL LEGEND
DATE OF ORIGINAL CONSTRUCTION 1955 DATE OF ADDITION 1999	12. MINIMUM PLUMBING FIXTURE COUNT (I.P.C. Chapter 4) For each type of occupancy per entire facility Group "A3" occupancy (Design Load = NA) Required Provided	1. HORIZONTAL ROOF LEADER (MATCH DIAMETER OF EXISTING) ABOVE CEILING SLOPED @ 18"/FT MIN. TIE VERTICAL LEADERS INTO EXISTING PIPING AS REQUIRED. SEAL ALL PENETRATIONS THROUGH WALLS W/FIRE PUTTY AS REQUIRED BY CODE. PATCH & REPAIR	REMOVE THE FOLLOWING @ ALL ROOF AREAS: 1. REMOVE ALL INDICATED EXISTING BUILT UP ROOF	- PLAN, SECTION, DETAIL OR ELEVATION NUMBER - SHEET NUMBER EXISTING OUTLINE OF BUILDING.
1. GROUP CLASSIFICATION (Chapter 3) (Primary) E-EDUCATIONAL	W/C Male W/C Female NA NA NA	ALL AREAS DAMAGED BY INSTALLATION OF NEW PIPING. 2. WALKWAY PADS TO BE INSTALLED. SEE PROJECT MANUAL FOR ADDITIONAL INFORMATION.	MEMBRANE & BALLAST.	SLOPE - INDICATES SLOPE DIRECTION OF TAPERED INSULATION AT 12"/FT. MI
(Incidental) A2-ASSEMBLY	Lavs NA NA	3. CONTRACTOR TO PROVIDE A SPECIFIED QUANTITY OF CONCRETE DECK REPAIR \$	2. REMOVE ALL INDICATED EXISTING ROOF INSULATION DOWN TO EXISTING CONCRETE DECKS.	SL: - TAPERED INSULATION CRICKET SLOPED @ 1" PER FOOT.
2. CONSTRUCTION TYPE (Chapter 6) Minimum Type Required 5B		REPLACEMENT. SEE PROJECT MANUAL FOR ADDITIONAL INFORMATION.	3. REMOVE ALL INDICATED WOOD BLOCKING.	H.P. HIGH - INDICATES HIGH POINT OF INSULATION.
Actual Type Provided (existing)	W/C Unisex Lavs Unisex NA NA NA NA	4. EXISTING METAL SHIP LADDER TO REMAIN. SCRAPE, PRIME & PAINT. SEE PROJECT MANUAL.	4. REMOVE ALL INDICATED METAL FLASHING.	O E.R.D EXISTING ROOF DRAIN TO BE REMOVED SEE DEMOLITION NOTES.
(new) 2B	Group "E" occupancy, (Design Load = NA)	5. INSTALL NEW ELECTRICAL WIRING/PVC CONDUIT CASING, REFRIGERANT PIPING, INSULATION & PVC JACKET ON NEW PIPING. CONNECT TO REINSTALLED MECH. UNIT. SEE PROJECT MANUAL.	5. REMOVE EXISTING MECHANICAL UNIT CURBS.6. REMOVE ALL INDICATED ROOF DRAINS, SUMPS & ALL	MN.R.D ROOF DRAIN & SUMP TO BE INSTALLED SEE DETAIL A/A3.
3. BUILDING HEIGHT (Chapter 5) Allowable Height (story/feet) 3/75'-O"	W/C NA NA	6. NOT USED.	INDICATED SCUPPERS.	O V.S EXISTING VENT STACK TO REMAIN SEE DETAIL B/A3.
Actual Height (story/feet) 1/25'-O" (Stories Above Grade) 1	Lavs D/F NA NA NA NA (Total Design Load for entire facility = NA)	7. REMOVE EXISTING METAL THROUGH-WALL FLASHING/WEEP HOLES. REMOVE FIVE (5) COURSES OF EXISTING MASONRY WALL, TEMPORARILY SUPPORT & INSTALL NEW THROUGH-WALL FLASHING & WEEP VENTS. INSTALL NEW BRICK. SEE DETAIL N/A3.	7. REMOVE INDICATED PORTION OF BRICK WALL, EXISTING METAL THROUGH-WALL FLASHING & EXISTING WEEP HOLES. SEE CONSTRUCTION NOTE #7.	E.M.U. #1 - EXISTING ROOF TOP MECHANICAL UNIT TO REMAIN SEE CONST. #13 E.M.U. #2 - EXISTING ROOF TOP MECHANICAL UNIT TO REMAIN SEE DETAIL E/
4. BUILDING AREA (Chapter 5)	Yes No 13. ENTIRE BUILDINGS SPRINKLERED X	8. EXISTING DOOR TO REMAIN. TEMPORARILY REMOVE & REINSTALL IF NEEDED FOR ROOFING OPERATIONS. SEE DETAIL Q/A3 SIM.	8. REMOVE ALL EXISTING ASPHALT COATING \$/OR EXISTING PAINT \$ METAL FLASHING ON ALL INDICATED	P.P PITCH POCKET TO BE INSTALLED SEE DETAIL C/A3.
a) Building Area (first) Existing construction sq.ft.	Yes No 14. THRESHOLD BUILDING CONDITIONS X	9. TEMPORARILY REMOVE EXISTING MECH. UNIT & STORE IN SAFE LOCATION DURING ROOFING OPERATIONS. REINSTALL EXIST MECH. UNIT IN EXIST. LOCATION. REMOVE EXISTING CURB &	CONCRETE OVERHANGS. SEE CONSTRUCTION NOTE #10.	- WALKWAY PADS SEE CONSTRUCTION NOTE #2.
New construction sq.ft. Total floor 182,598 sq.ft.	15. CODES TO WHICH THIS PROJECT WAS DESIGNED	FASTEN NEW MECHANICAL UNIT CURB TO EXISTING DECK. SEE DETAIL F/A3.	9. REMOVE & DISPOSE OF EXISTING ELECTRICAL WIRING/CONDUIT & REFRIGERANT PIPING/CONDUIT &	E.S EMERGENCY SCUPPER SEE DETAIL S/A3.
	State Building Code w/Supplement	10. RAKE & RE-CAULK ALL EXISTING EXPANSION JOINTS LOCATED ON ALL CONCRETE OVERHANGS. SEE DETAILS T/A3, U/A3, V/A3, W/A3 & Y/A3.	SUPPORTS.	E.C EXISTING CHIMNEY SEE DETAIL M/A3.
TOTAL (ALL FLOORS) 182,598 sq.ft.	State Fire Code w/Supplement	11. INSTALL NEW METAL DOWNSPOUTS @ ALL INDICATED SCUPPER LOCATIONS. SEE PROJECT MANUAL FOR ADDITIONAL INFORMATION.		R.D ROOF DIVIDER SEE DETAIL G/A3
5. AREA MODIFICATIONS TO TABLE 503 (for each separate building as defined by fire walls and/or exterior walls)	State Fire Code w/Supplement 2009 AMEND. 2005 CT State Health Code MOST CURRENT	12. INSTALL NEW CONCRETE SPLASHBLOCKS @ ALL INDICATED METAL DOWNSPOUT		N.H.R.L HORIZONTAL ROOF DRAIN LEADER SEE CONSTRUCTION NOTE #1.
NA	OSHA MOST CURRENT	LOCATIONS. SEE PROJECT MANUAL FOR ADDITIONAL INFORMATION. 13. 13.CONTRACTOR SHALL REPLACE ALL OR PROVIDE NEW ROOF TOP EQUIPMENT		S.C SCUPPER W/METAL COLLECTION BOX SEE DETAIL Y/A3.
6. CASE 1 - SINGLE OCCUPANCY OR NONSEPARATED USES (302.3.1) (Allowable Area 506.4)	Section 504	DISCONNECT SWITCHES IN THIS PROJECT SCOPE. NEW SWITCHES SHALL BE NON-FUSED, NEMA 3R RATED & SHALL MATCH THE VOLTAGE & CURRENT RATINGS OF THE EQUIPMENT		E.D EXISTING DOOR SEE CONSTRUCTION NOTE #8.
7. CASE 2 - MIXED OCCUPANCY SEPARATED USES (302.3.2)	16. BUILDING AREAS FOR GRANT CALCULATION (ENTIRE FACILITY)	SERVED. NEW DISCONNECT SWITCHES SHALL BE MOUNTED TO A NON-REMOVABLE PANEL ON THE EQUIPMENT SERVED OR THE CONTRACTOR SHALL PROVIDE A SUITABLE UNI-STRUT		E.J EXPANSION JOINT SEE DETAIL L/A3.
(Allowable Area 506.4) NA	(measured to inside face of exterior walls)	SUPPORT FOR PROPER MOUNTING. IN ALL CASES, THE NEW DISCONNECT SWITCH SHALL BE WITHIN VIEW OF THE EQUIPMENT SERVED. MODIFY & EXTEND BRANCH CIRCUIT WIRING AS REQ'D. FOR INSTALLATION OF THE DISCONNECT SWITCH. NEW SWITCH MATERIALS &		C.C CONDUIT CURB SEE DETAIL J/A3.
8. FIRE-RESISTANCE RATED REQUIREMENTS FOR BUILDING ELEMENTS	Existing unrenovated construction sq.ft. Existing renovated construction sq.ft.	INSTALLATION SHALL BE COMPLIANT W/APPLICABLE REQUIREMENTS OF THE CURRENT NEC ARTICLES APPLICABLE REQUIREMENTS OF THE CURRENT NEC 424.19, 430 PART IX \$ 440		E.W EXISTING WINDOW SEE DETAIL Q/A3 SIM.
(Table 601, See Code Plans for specific designations)	Existing being demolishedsq.ft. Total existing constructionsq.ft.	PART I. SEE DETAIL D/A3 & PROJECT MANUAL.		E.M.F EXISTING METAL FLUE SEE DETAIL K/A3.
1 Structural frame: including columns, girders, trusses O Hr(s)	Total new construction sq.ft. Total facility sq.ft.	ROOF AREAS		E.M.C MECHANICAL UNIT LOCATED ON CURB SEE CONSTRUCTION NOTE #
2 Bearing walls: Exterior (Table 602) Hr(s) Hr(s)	Total facilitysq.ft. Open Areas (not included in total facility)	ROOF "A" 2,193 SF. ROOF "B" 9,488 SF.		E.L EXIST. METAL LADDER SEE CONSTRUCTION NOTE #4.
3 Nonbearing walls & partitions	NA NA sq.ft.	ROOF "C" 15,810 SF. ROOF "D" 1,655 SF.		G.W EXISTING GUY WIRE TO REMAIN SEE DETAIL C/A3 SIM.
Exterior (Table 602) O/1 Hr(s) 4 Nonbearing walls & partitions	17 TOTAL CONCEDITOTED BUILDING AREA	ROOF "E" 8,646 SF. ROOF "F" 1,655 SF. ROOF "G" 3,344 SF.		LL EXISTING LOUVER SEE DETAIL Q/A3 SIM.
Interior Hr(s) 5 Floor Construction (including	17. TOTAL CONSTRUCTED BUILDING AREA (outside face of exterior walls including open areas above)	TOTAL: 47,791 SF.		D.S METAL DOWNSPOUT SEE CONSTRUCTION NOTE #11.
supporting beams & joists) — — — Hr(s) 6 Roof Construction (including	FIRE SAFETY CODE DATA:	THIS AREA IS APPROXIMATE- V.I.F. ROOFS "A", "B", "C", "D", USE GROUP: E		S.B CONCRETE SPLASH BLOCK SEE CONSTRUCTION NOTE #12.
supporting beams & joists)	1. CLASSIFICATION OF OCCUPANCY EDUCATIONAL/ASSEMBLY 2. MINIMUM CONSTRUCTION REQUIRED 5B	E", "F", "G" CONSTRUCTION CLASS: 2B BASIC WIND SPEED: 110 MPH		
9. OCCUPANCY LOAD Design Total for Basement NA	ACTUAL CONSTRUCTION PROVIDED	OUTSIDE AIR O.17 SURFACE ROUGHNESS EXPOSURE: B EPDM O.33 IMPORTANCE FACTOR: 1.15		ROOF 'A' ────
Total Exit Capacity for Basement NA Design Total for First Floor NA	3. NOTIFICATION / ALARMS YES NO (CFSC 2005, NFPA 72, NATIONAL FIRE ALARM CODE 2002)	COVER BOARD 2.20 AVG. 4" POLYISO INSUL. 26.4 FACTORY MUTUAL ENGINEERING & RESEARCH CORPORATION (FM): ROOF		
Total Exit Capacity for First Floor NA Design Total for Building NA	4. DETECTION YES X NO (CFSC 2005, NFPA 72, NATIONAL FIRE ALARM CODE 2002)	CONCRETE DECK 1.23 ASSEMBLY CLASSIFICATION OF INSIDE AIR O.61 NON-COMBUSTIBLE CONSTRUCTION, WIND URL SET BEOLISEMENT OF 1-60 FOR FIELD		NIC.
Total Exit Capacity for Building NA	5. EXTINGUISHMENT REQUIREMENTS YES X NO (NFPA 13, 2002)	R TOTAL: 30.94 UPLIFT REQUIREMENT OF 1-60 FOR FIELD, 1-90 FOR PERIMETER AND 1-120 FOR CORNERS, IN ACCORDANCE WITH FM		
		ENERGY CONSERVATION PROPERTY LOSS PREVENTION DATA SHEETS 1-28.		
10 MODIFICATIONS NOT	MEANS OF EGRESS MAXIMUM FLOOR AREA ALLOWANCES PER OCCUPANT	IECC CODE REQUIREMENT R-VALUE TOTAL CONNECTICUT ZONE 5A CREC REQUIREMENT: ROLL OLD OR LESS		• ROOF BY
10. MODIFICATIONS Approved Approved Approved	IBC TABLE 1004.1.2 USE FLOOR AREA IN S.F. PER OCCUPANT	CBSC REQUIREMENT: R24 = U .O42 OR LESS		
Not Approved Approved	1. CLASSROOMS <u>20 S.F. NET</u>	GENERAL NOTES		
	2. SHOPS & VOCATIONAL <u>50 S.F. NET</u>3. ASSEMBLY	1. ALL ROOFS TO RECEIVE 12" PER FOOT TAPERED RIGID INSULATION MINIMUM UNLESS OTHERWISE NOTED.		
Approved Approved	WITHOUT FIXED SEATS 7 S.F. NET	2. FIELD VERIFY ALL DIMENSIONS & PERFORM TEST CUTS AT EACH ROOF PRIOR TO THE BID.		
	TABLES AND CHAIRS <u>15 S.F. NET</u> 4. PLATFORMS <u>15 S.F. NET</u>	3. ALL MATERIALS ARE NEW UNLESS OTHERWISE NOTED "EXISTING".		NIC.
	5. LIBRARY	4. ALL WOOD BLOCKING, PLYWOOD & NAILERS TO BE PRESSURE TREATED. (P.T.)		
11. ACCESSIBLE BUILDING Designated Non Designated	READING ROOMS <u>50 S.F. NET</u> STACK AREA <u>100 S.F. GROSS</u>	5. ALL WOOD BLOCKING INDICATED IN DETAILS IS TO BE ANCHORED TO THE EXISTING STRUCTURE.		
	6. LOCKER ROOMS <u>50 S.F. GROSS</u>	6. ALL MEMBRANE FLASHING INDICATED IS TO EXTEND A MINIMUM OF 8". (VERTICAL OR HORIZONTAL) 7. CONTRACTOR IS TO SURVEY THE EXISTING ROOF DECKS W/A LEVEL (AFTER DEMOLITION) TO		• ROOF 'C'
	7. MECHANICAL AREAS <u>300 S.F. GROSS</u> 8. STORAGE <u>300 S.F. GROSS</u>	VERIFY THE SLOPES INDICATED ON PLAN ARE ACCURATE. NOTIFY ARCHITECT IMMEDIATELY OF ANY DISCREPANCIES PRIOR TO PERFORMING ANY ADDITIONAL ROOFING OPERATIONS.		
	9. BUSINESS AREAS 100 S.F. GROSS	8. CONTRACTOR IS TO INSPECT THE UNDERSIDE OF ALL ROOF DECKS PRIOR TO ROOFING OPERATIONS TO INSURE THAT NO INTERIOR MATERIALS, EQUIPMENT, FINISHES OR OBJECTS WILL		
	10. Courtyards 15 S.F. NET MAXIMUM LENGTH OF EXIT TRAVEL 1. I.B.C. TABLE 1015.1 250 FEET	BE PIERCED OR DAMAGED. 9. CONTRACTOR ASSUMES ALL RESPONSIBILITY OF ITEMS INTERIOR & EXTERIOR THAT MAY BECOME DAMAGED DURING THE COURSE OF DEMOLITION/ CONSTRUCTION & WILL REPLACE ANY		NG NG
		# ALL ITEMS #/OR DAMAGED EQUIPMENT W/NO ADDITIONAL COST TO OWNER. 10. SITE AREAS DISTURBED SHALL BE CLEANED # RE-LEVELED, W/LAWN AREAS MAGNETICALLY RAKED TO REMOVE ANY METAL DEBRIS # RE-SEEDED AS REQUIRED TO MATCH ADJACENT		NIC. NIC.
		CONDITIONS. 11. CONTRACTOR ASSUMES ALL RESPONSIBILITY FOR CLEAN UP OF ROOFING MATERIALS & DEBRIS THAT PENETRATES THE INTERIOR ENVELOPE OF THE BUILDING W/NO ADDITIONAL COST TO THE	<u>ROOF 12'</u>	NIC NIC NIC
		OWNER. 12. SNAKE/CLEAN OUT ALL EXISTING VERTICAL & HORIZONTAL STORM WATER LEADERS OUT TO		NIC
		NEAREST MAN HOLE ON SITE OUTSIDE OF BUILDING.	NIC.	
		13. ALL CRICKETS ARE TO BE SLOPED @ A MINIMUM OF 1" PER FOOT & COORDINATE CRICKETS AROUND EXISTING HVAC UNITS AS REQUIRED TO AVOID PONDING.	NIC.	NIC.
		14. CONTRACTOR IS RESPONSIBLE FOR THE REMOVAL & RE-INSTALLATION OF ALL HVAC UNITS INCLUDING ANY ELECTRICAL OR MECHANICAL CONNECTIONS. THIS MAY INCLUDE THE EXTENSION OF EXISTING ELECTRICAL & DUCTWORK SYSTEMS TO ACCOMMODATE NEW MECHANICAL UNIT CURBING & NEW ROOFING SYSTEM.	NIC.	NIC NIC
		15. Shake/clean out all existing vent stack before the installation of metal sleeve.		
		16. ALL DRAIN PIPING IS INSULATED ABOVE THE CEILINGS. THE EXACT ROUTE WILL BE DETERMINED IN THE FIELD, MAKE MINOR ADJUSTMENT IN THE ROUTE AT NO ADDITIONAL COST TO OWNER.	ROOF TO	NIC NIC NIC
		17. NEW INSULATION TO BE A MINIMUM 112" AT ALL EXISTING & NEW ROOF DRAINS.	AREA IN SCOPE	NIC NIC
		18. ALL ANTENNAS, CONDUITS & ANY OTHER OBJECTS TO REMAIN AFFECTED BY SCOPE OF WORK,		NIC NIC NIC
		TO BE REMOVED & REINSTALLED. 19. CONTRACTOR MUST VISIT SITE & ROOF AREA(S) TO BECOME FAMILIARIZED WITH THE ENTIRE	AREA NOT IN SCOPE	
		SCOPE OF WORK & ADJACENT SITE AREAS PRIOR TO BID.	ROOF KEY PLAN	
			SCALE: NONE NORTH	
Title:	•	Devision: Description:	Date: Pavisod Du	o Title:
Town Of West Hartford		RUCELLI + ASSOCIATES Revision: Description: PHASE "2" OF "2" PHASE "2" OF "2" PHASE "2" OF "2" PHASE "2" OF "2" PHASE "3" OF "3" PHASE "3" PH	Date: Revised By:	Date: Drawing Number: 1/8/2016
	Archite	ects/ Engineers/ Interior Designers		ode Information Scale:

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K. LINSLEY Project Number:



14. CONTRACTOR IS RESPONSIBLE FOR THE REMOVAL & RE-INSTALLATION OF ALL HVAC UNITS INCLUDING ANY ELECTRICAL OR MECHANICAL CONNECTIONS. THIS MAY INCLUDE THE EXTENSION OF EXISTING ELECTRICAL & DUCTWORK SYSTEMS TO ACCOMMODATE NEW MECHANICAL E.D. - EXISTING DOOR. SEE CONSTRUCTION NOTE #8. UNIT CURBING & NEW ROOFING SYSTEM. E.J. - EXPANSION JOINT. SEE DETAIL L/A3. 15. SNAKE/CLEAN OUT ALL EXISTING VENT STACK BEFORE THE INSTALLATION OF METAL SLEEVE. C.C. - CONDUIT CURB. SEE DETAIL J/A3. 16. ALL DRAIN PIPING IS INSULATED ABOVE THE CEILINGS. THE EXACT ROUTE WILL BE DETERMINED IN THE FIELD, MAKE MINOR ADJUSTMENT IN THE ROUTE AT NO ADDITIONAL COST TO OWNER. E.W. - EXISTING WINDOW. SEE DETAIL Q/A3 SIM. 17. NEW INSULATION TO BE A MINIMUM 4" AT ALL EXISTING & NEW ROOF DRAINS. E.M.F. - EXISTING METAL FLUE. SEE DETAIL K/A3. 18. ALL ANTENNAS, CONDUITS & ANY OTHER OBJECTS TO REMAIN AFFECTED BY SCOPE OF WORK, TO BE REMOVED & REINSTALLED. E.M.C. - MECHANICAL UNIT LOCATED ON CURB. SEE CONSTRUCTION NOTE #9. 19. CONTRACTOR MUST VISIT SITE & ROOF AREAS TO BECOME FAMILIARIZED WITH THE ENTIRE SCOPE OF WORK & ADJACENT SITE AREAS PRIOR E.L. - EXIST. METAL LADDER. SEE CONSTRUCTION NOTE #4. G.W. - EXISTING GUY WIRE TO REMAIN. SEE DETAIL C/A3 SIM. LL. - EXISTING LOUYER. SEE DETAIL Q/A3 SIM. D.S. - METAL DOWNSPOUT. SEE CONSTRUCTION NOTE #11. S.B. - CONCRETE SPLASHBLOCK. SEE CONSTRUCTION NOTE #12. ROOF AREAS ROOF "A" 7,699 SF. ROOF "E" 2,950 SF. ROOF "B" 851 SF. ROOF "F" 1.923 SF. ROOF "C" 3,857 SF. ROOF "G" 3,011 SF. ROOF "D" 8,828 SF. TOTAL: 29,119 SF. THIS AREA IS APPROXIMATE - V.I.F. ENERGY CONSERVATION IECC CODE REQUIREMENT R-YALUE TOTAL CONNECTICUT ZONE 5A CBSC REQUIREMENT: CONTINUOUS R25 CODE INFORMATION USE GROUP : E CONSTRUCTION CLASS: 2B BASIC WIND SPEED: 110 MPH RISK CATEGORY #3 134 MPH FACTORY MUTUAL ENGINEERING & RESEARCH CORPORATION (FM): ROOF ASSEMBLY CLASSIFICATION OF NON-COMBUSTIBLE CONSTRUCTION, WIND UPLIFT REQUIREMENT OF 1-60 FOR FIELD, 1-90 FOR PERIMETER AND 1-120 FOR CORNERS. IN ACCORDANCE WITH FM PROPERTY LOSS PREVENTION DATA SHEETS 1-28. ROOFS: "A", "B", "C", "D", "E", "F", "G" OUTSIDE AIR 0.33 COVER BOARD 4" POLYISO INSUL METAL DECK INSIDE AIR R TOTAL: 30.94

SYMBOL LEGEND

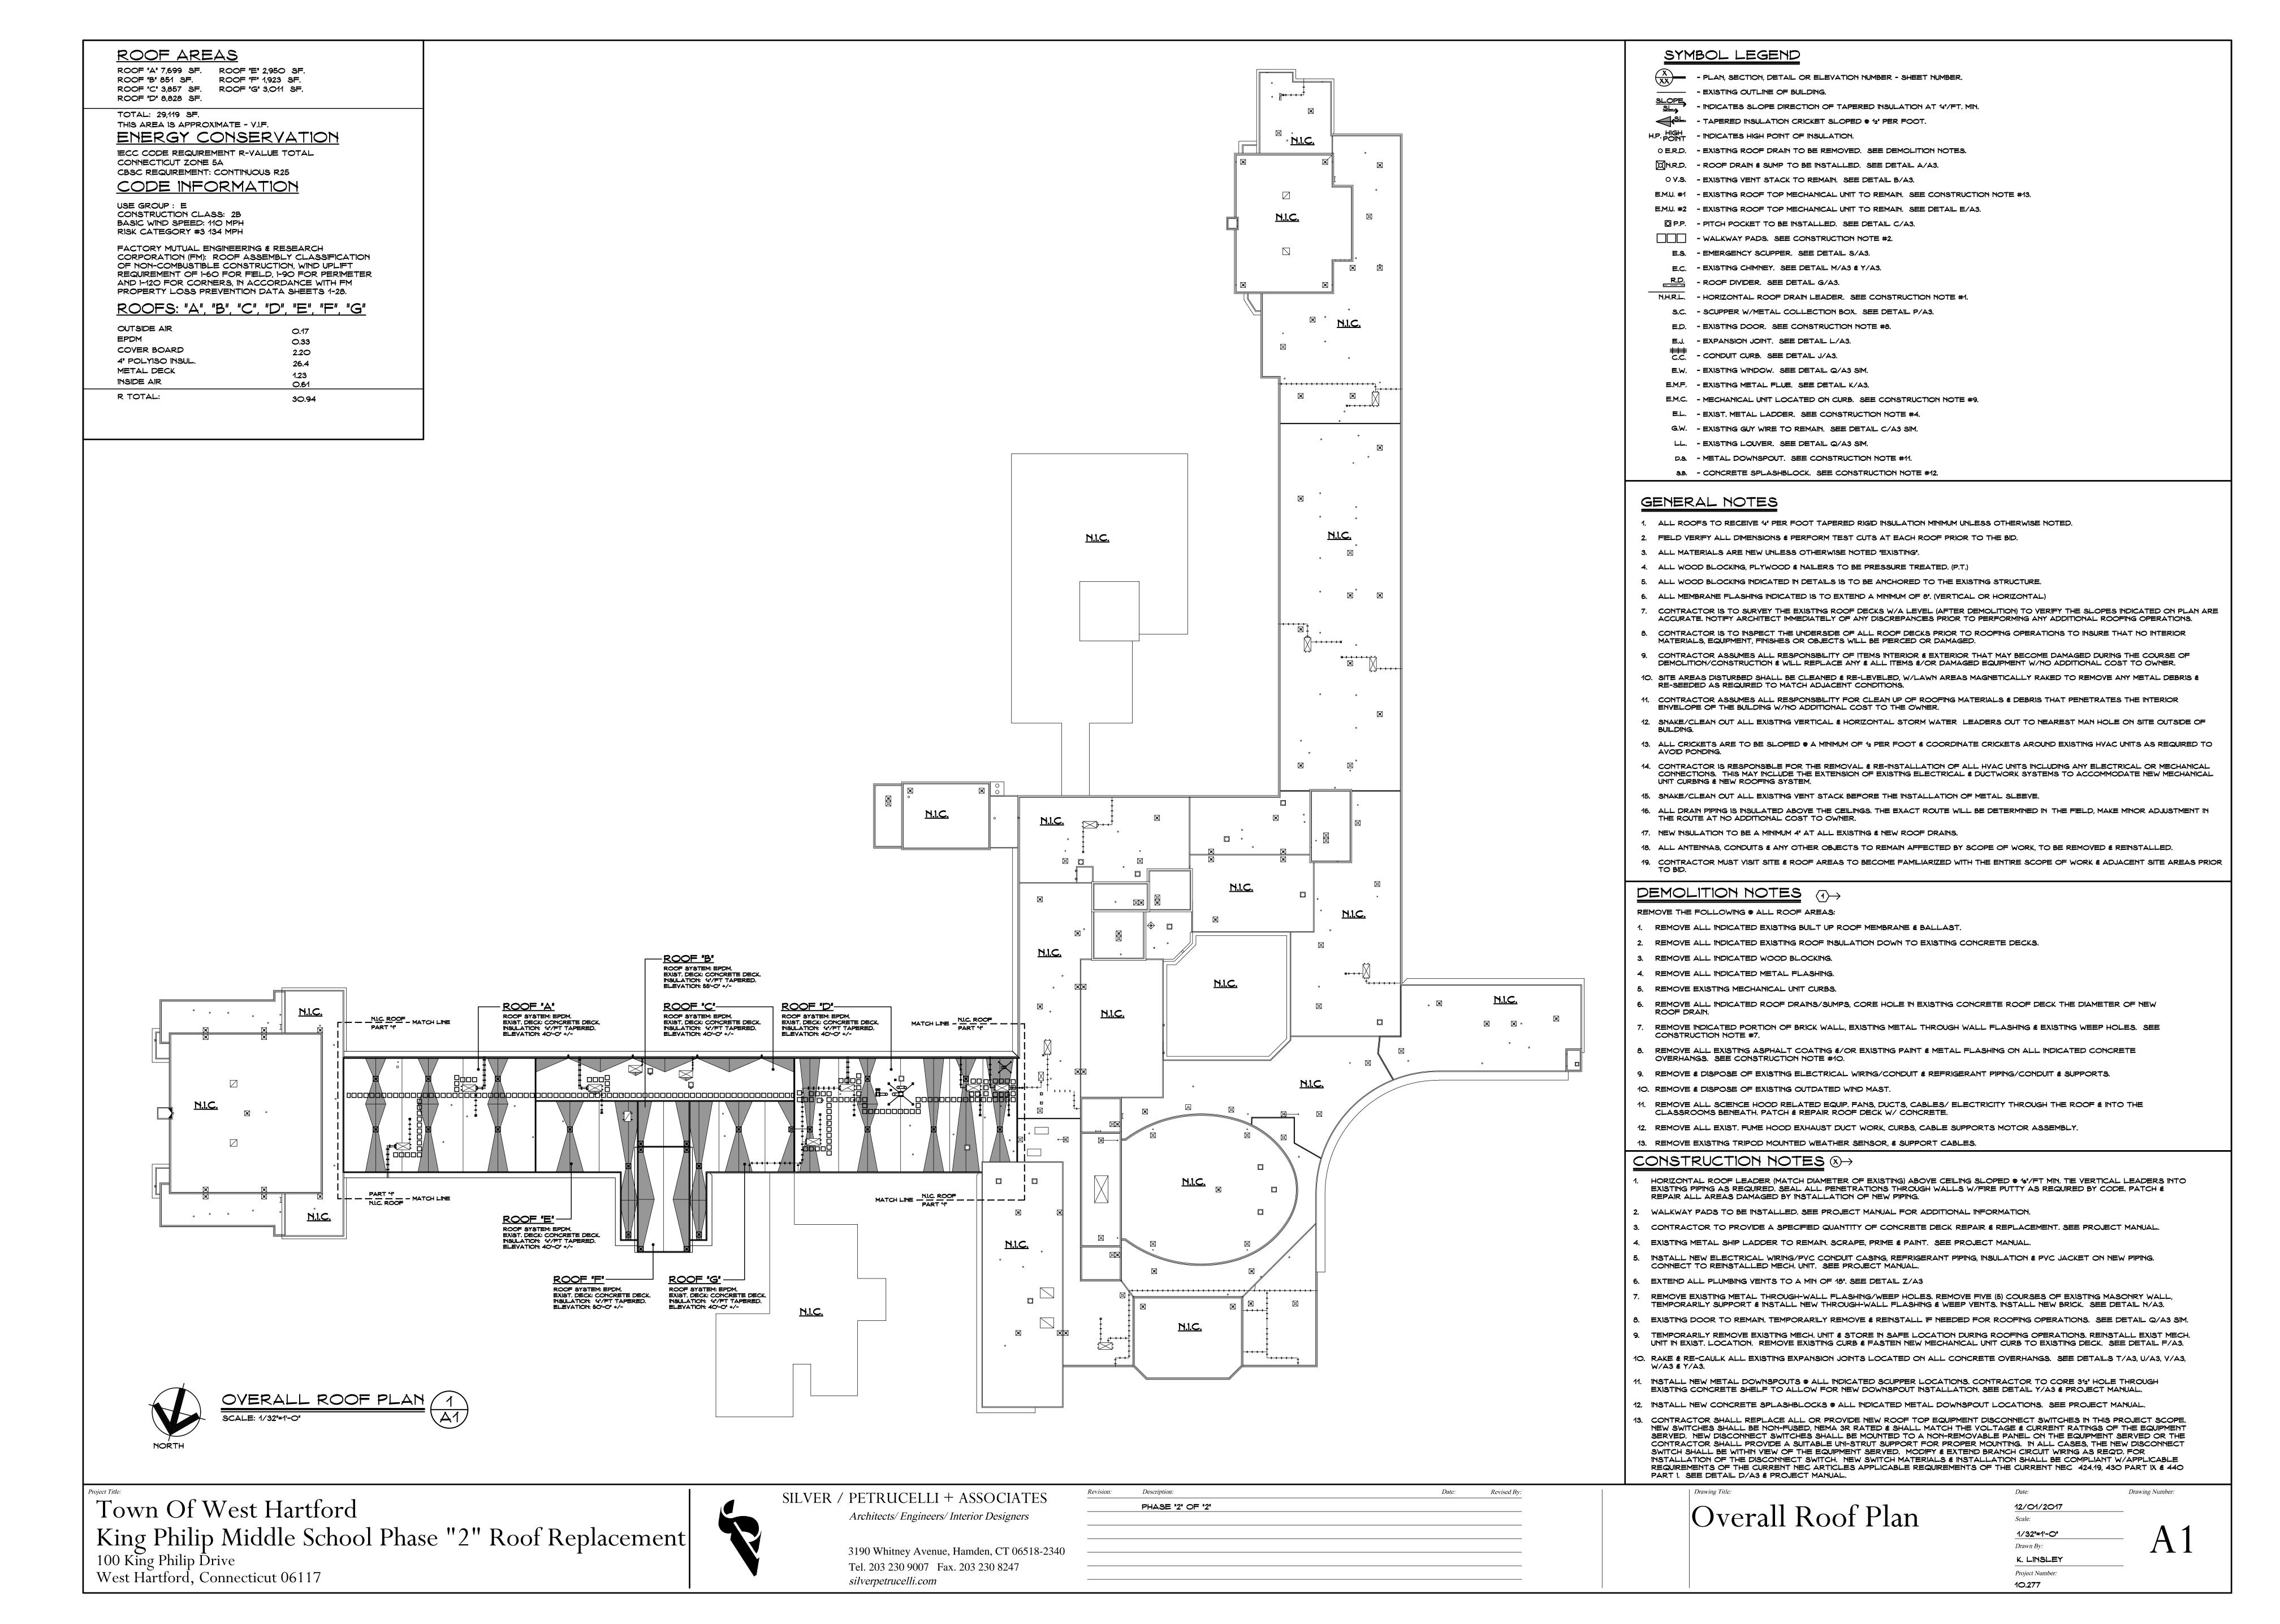- EXISTING OUTLINE OF BUILDING.

H.P. POINT - INDICATES HIGH POINT OF INSULATION.

 $\frac{X}{XX}$ - PLAN, SECTION, DETAIL OR ELEVATION NUMBER - SHEET NUMBER.

- TAPERED INSULATION CRICKET SLOPED @ 12" PER FOOT.

O E.R.D. - EXISTING ROOF DRAIN TO BE REMOVED. SEE DEMOLITION NOTES.

E.M.U. #2 - EXISTING ROOF TOP MECHANICAL UNIT TO REMAIN. SEE DETAIL E/A3.

N.H.R.L. - HORIZONTAL ROOF DRAIN LEADER. SEE CONSTRUCTION NOTE #1.

S.C. - SCUPPER W/METAL COLLECTION BOX. SEE DETAIL P/A3.

M.R.D. - ROOF DRAIN & SUMP TO BE INSTALLED. SEE DETAIL A/A3.

O V.S. - EXISTING VENT STACK TO REMAIN. SEE DETAIL B/A3.

P.P. - PITCH POCKET TO BE INSTALLED. SEE DETAIL C/A3.

- WALKWAY PADS. SEE CONSTRUCTION NOTE #2.

E.S. - EMERGENCY SCUPPER. SEE DETAIL S/A3.

R.D. - ROOF DIVIDER. SEE DETAIL G/A3.

E.C. - EXISTING CHIMNEY. SEE DETAIL M/A3 & Y/A3.

- INDICATES SLOPE DIRECTION OF TAPERED INSULATION AT 4"/FT. MIN.

E.M.U. #1 - EXISTING ROOF TOP MECHANICAL UNIT TO REMAIN. SEE CONSTRUCTION NOTE

GENERAL NOTES DEMOLITION NOTES (1) 1. ALL ROOFS TO RECEIVE 14" PER FOOT TAPERED RIGID INSULATION MINIMUM UNLESS OTHERWISE NOTED. REMOVE THE FOLLOWING @ ALL ROOF AREAS: 2. FIELD VERIFY ALL DIMENSIONS & PERFORM TEST CUTS AT EACH ROOF PRIOR TO THE BID.

3. ALL MATERIALS ARE NEW UNLESS OTHERWISE NOTED "EXISTING".

RE-SEEDED AS REQUIRED TO MATCH ADJACENT CONDITIONS.

AVOID PONDING.

ENVELOPE OF THE BUILDING W/NO ADDITIONAL COST TO THE OWNER.

4. ALL WOOD BLOCKING, PLYWOOD & NAILERS TO BE PRESSURE TREATED. (P.T.)

MATERIALS, EQUIPMENT, FINISHES OR OBJECTS WILL BE PIERCED OR DAMAGED.

5. ALL WOOD BLOCKING INDICATED IN DETAILS IS TO BE ANCHORED TO THE EXISTING STRUCTURE.

6. ALL MEMBRANE FLASHING INDICATED IS TO EXTEND A MINIMUM OF 8". (VERTICAL OR HORIZONTAL)

CONTRACTOR IS TO SURVEY THE EXISTING ROOF DECKS W/A LEVEL (AFTER DEMOLITION) TO VERIFY THE SLOPES INDICATED ON PLAN ARE

ACCURATE, NOTIFY ARCHITECT IMMEDIATELY OF ANY DISCREPANCIES PRIOR TO PERFORMING ANY ADDITIONAL ROOFING OPERATIONS.

CONTRACTOR IS TO INSPECT THE UNDERSIDE OF ALL ROOF DECKS PRIOR TO ROOFING OPERATIONS TO INSURE THAT NO INTERIOR

CONTRACTOR ASSUMES ALL RESPONSIBILITY OF ITEMS INTERIOR & EXTERIOR THAT MAY BECOME DAMAGED DURING THE COURSE OF

DEMOLITION/CONSTRUCTION & WILL REPLACE ANY & ALL ITEMS &/OR DAMAGED EQUIPMENT W/NO ADDITIONAL COST TO OWNER.

10. SITE AREAS DISTURBED SHALL BE CLEANED & RE-LEVELED, W/LAWN AREAS MAGNETICALLY RAKED TO REMOVE ANY METAL DEBRIS &

12. SNAKE/CLEAN OUT ALL EXISTING VERTICAL & HORIZONTAL STORM WATER LEADERS OUT TO NEAREST MAN HOLE ON SITE OUTSIDE OF

13. ALL CRICKETS ARE TO BE SLOPED 9 A MINIMUM OF 12 PER FOOT & COORDINATE CRICKETS AROUND EXISTING HYAC UNITS AS REQUIRED TO

11. CONTRACTOR ASSUMES ALL RESPONSIBILITY FOR CLEAN UP OF ROOFING MATERIALS & DEBRIS THAT PENETRATES THE INTERIOR

1. REMOVE ALL INDICATED EXISTING BUILT UP ROOF MEMBRANE & BALLAST.

2. REMOVE ALL INDICATED EXISTING ROOF INSULATION DOWN TO EXISTING CONCRETE DECKS.

3. REMOVE ALL INDICATED WOOD BLOCKING.

4. REMOVE ALL INDICATED METAL FLASHING 5. REMOVE EXISTING MECHANICAL UNIT CURBS.

6. REMOVE ALL INDICATED ROOF DRAINS/SUMPS, CORE HOLE IN EXISTING CONCRETE ROOF DECK THE DIAMETER OF NEW ROOF DRAIN.

REMOVE INDICATED PORTION OF BRICK WALL, EXISTING METAL THROUGH WALL FLASHING & EXISTING WEEP HOLES. SEE CONSTRUCTION NOTE #7.

REMOVE ALL EXISTING ASPHALT COATING \$/OR EXISTING PAINT \$ METAL FLASHING ON ALL INDICATED CONCRETE OVERHANGS. SEE CONSTRUCTION NOTE #10.

9. REMOVE & DISPOSE OF EXISTING ELECTRICAL WIRING/CONDUIT & REFRIGERANT PIPING/CONDUIT & SUPPORTS.

REMOVE ALL SCIENCE HOOD RELATED EQUIP. FANS, DUCTS, CABLES/ ELECTRICITY THROUGH THE ROOF & INTO THE

13. REMOVE EXISTING TRIPOD MOUNTED WEATHER SENSOR, & SUPPORT CABLES.

10. REMOVE & DISPOSE OF EXISTING OUTDATED WIND MAST.

CLASSROOMS BENEATH. PATCH & REPAIR ROOF DECK W/ CONCRETE. 12. REMOVE ALL EXIST. FUME HOOD EXHAUST DUCT WORK, CURBS, CABLE SUPPORTS MOTOR ASSEMBLY. CONSTRUCTION NOTES ®>

W/A3 € Y/A3.

INFORMATION.

HORIZONTAL ROOF LEADER (MATCH DIAMETER OF EXISTING) ABOVE CEILING SLOPED ® 16"/FT MIN. TIE VERTICAL LEADERS INTO EXISTING PIPING AS REQUIRED. SEAL ALL PENETRATIONS THROUGH WALLS W/FIRE PUTTY AS REQUIRED BY CODE. PATCH & REPAIR ALL AREAS DAMAGED BY INSTALLATION OF NEW PIPING.

2. WALKWAY PADS TO BE INSTALLED. SEE PROJECT MANUAL FOR ADDITIONAL INFORMATION. CONTRACTOR TO PROVIDE A SPECIFIED QUANTITY OF CONCRETE DECK REPAIR & REPLACEMENT. SEE PROJECT MANUAL FOR

ADDITIONAL INFORMATION.

4. EXISTING METAL SHIP LADDER TO REMAIN. SCRAPE, PRIME & PAINT. SEE PROJECT MANUAL. 5. INSTALL NEW ELECTRICAL WIRING/PVC CONDUIT CASING, REFRIGERANT PIPING, INSULATION € PVC JACKET ON NEW PIPING. CONNECT TO REINSTALLED MECH. UNIT. SEE PROJECT MANUAL.

REMOVE EXISTING METAL THROUGH-WALL FLASHING/WEEP HOLES. REMOVE FIVE (5) COURSES OF EXISTING MASONRY WALL, TEMPORARILY SUPPORT & INSTALL NEW THROUGH-WALL FLASHING & WEEP VENTS, INSTALL NEW BRICK, SEE DETAIL N/A3.

8. EXISTING DOOR TO REMAIN. TEMPORARILY REMOVE & REINSTALL IF NEEDED FOR ROOFING OPERATIONS. SEE DETAIL Q/A3 SIM.


10. RAKE & RE-CAULK ALL EXISTING EXPANSION JOINTS LOCATED ON ALL CONCRETE OVERHANGS. SEE DETAILS T/A3, U/A3, V/A3,

9. TEMPORARILY REMOVE EXISTING MECH. UNIT & STORE IN SAFE LOCATION DURING ROOFING OPERATIONS. REINSTALL EXIST MECH. UNIT IN EXIST. LOCATION. REMOVE EXISTING CURB & FASTEN NEW MECHANICAL UNIT CURB TO EXISTING DECK. SEE DETAIL F/A3.

11. INSTALL NEW METAL DOWNSPOUTS @ ALL INDICATED SCUPPER LOCATIONS. SEE PROJECT MANUAL FOR ADDITIONAL

12. INSTALL NEW CONCRETE SPLASHBLOCKS @ ALL INDICATED METAL DOWNSPOUT LOCATIONS. SEE PROJECT MANUAL FOR

13. 13.CONTRACTOR SHALL REPLACE ALL OR PROVIDE NEW ROOF TOP EQUIPMENT DISCONNECT SWITCHES IN THIS PROJECT SCOPE. NEW SWITCHES SHALL BE NON-FUSED, NEMA 3R RATED & SHALL MATCH THE VOLTAGE & CURRENT RATINGS OF THE EQUIPMENT SERVED. NEW DISCONNECT SWITCHES SHALL BE MOUNTED TO A NON-REMOVABLE PANEL ON THE EQUIPMENT SERVED OR THE CONTRACTOR SHALL PROVIDE A SUITABLE UNI-STRUT SUPPORT FOR PROPER MOUNTING. IN ALL CASES, THE NEW DISCONNECT SWITCH SHALL BE WITHIN VIEW OF THE EQUIPMENT SERVED. MODIFY & EXTEND BRANCH CIRCUIT WIRING AS REQ'D. FOR INSTALLATION OF THE DISCONNECT SWITCH. NEW SWITCH MATERIALS & INSTALLATION SHALL BE COMPLIANT W/APPLICABLE REQUIREMENTS OF THE CURRENT NEC ARTICLES APPLICABLE REQUIREMENTS OF THE CURRENT NEC 424.19, 430 PART IX & 440 PART I. SEE DETAIL D/A3 € PROJECT MANUAL.

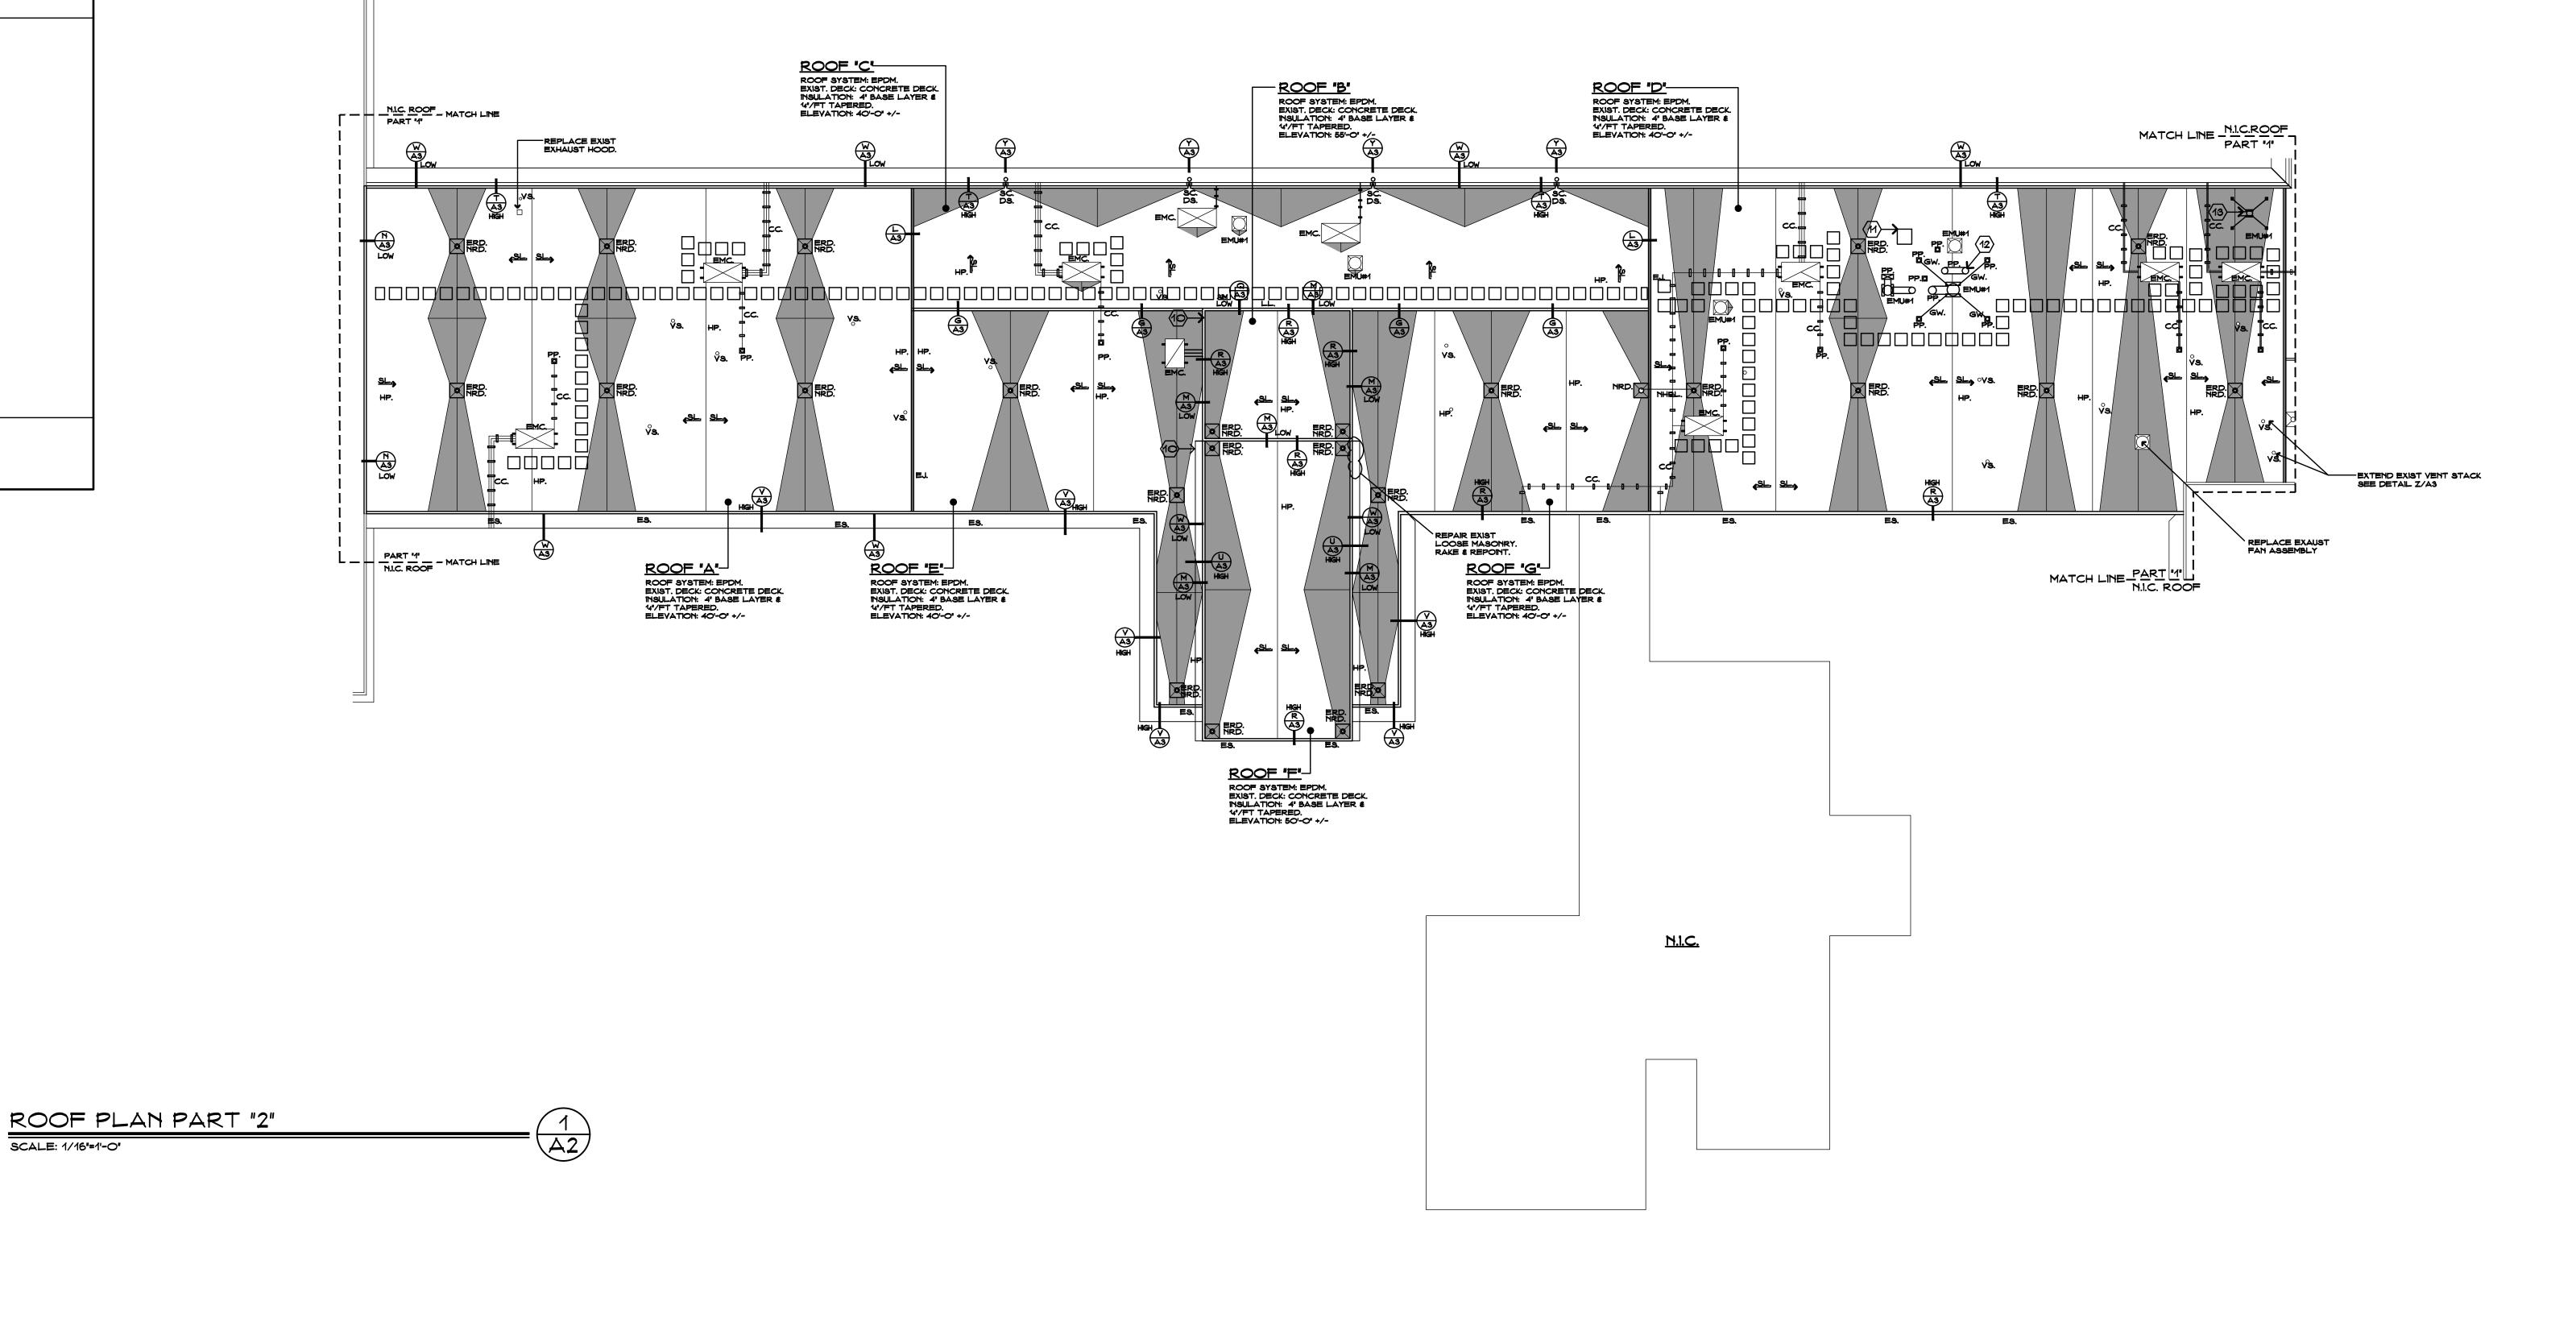

Town Of West Hartford King Philip Middle School Roof Replacement
100 King Philip Drive
West Hartford, Connecticut 06117


SCALE: 1/16"=1'-0"


SILVER / PETRUCELLI + ASSOCIATES Architects/ Engineers/ Interior Designers

> 3190 Whitney Avenue, Hamden, CT 06518-2340 Tel. 203 230 9007 Fax. 203 230 8247 silverpetrucelli.com

Roof Plan Part "1"

Drawing Number: 12/01/2017 K. LINSLEY Project Number

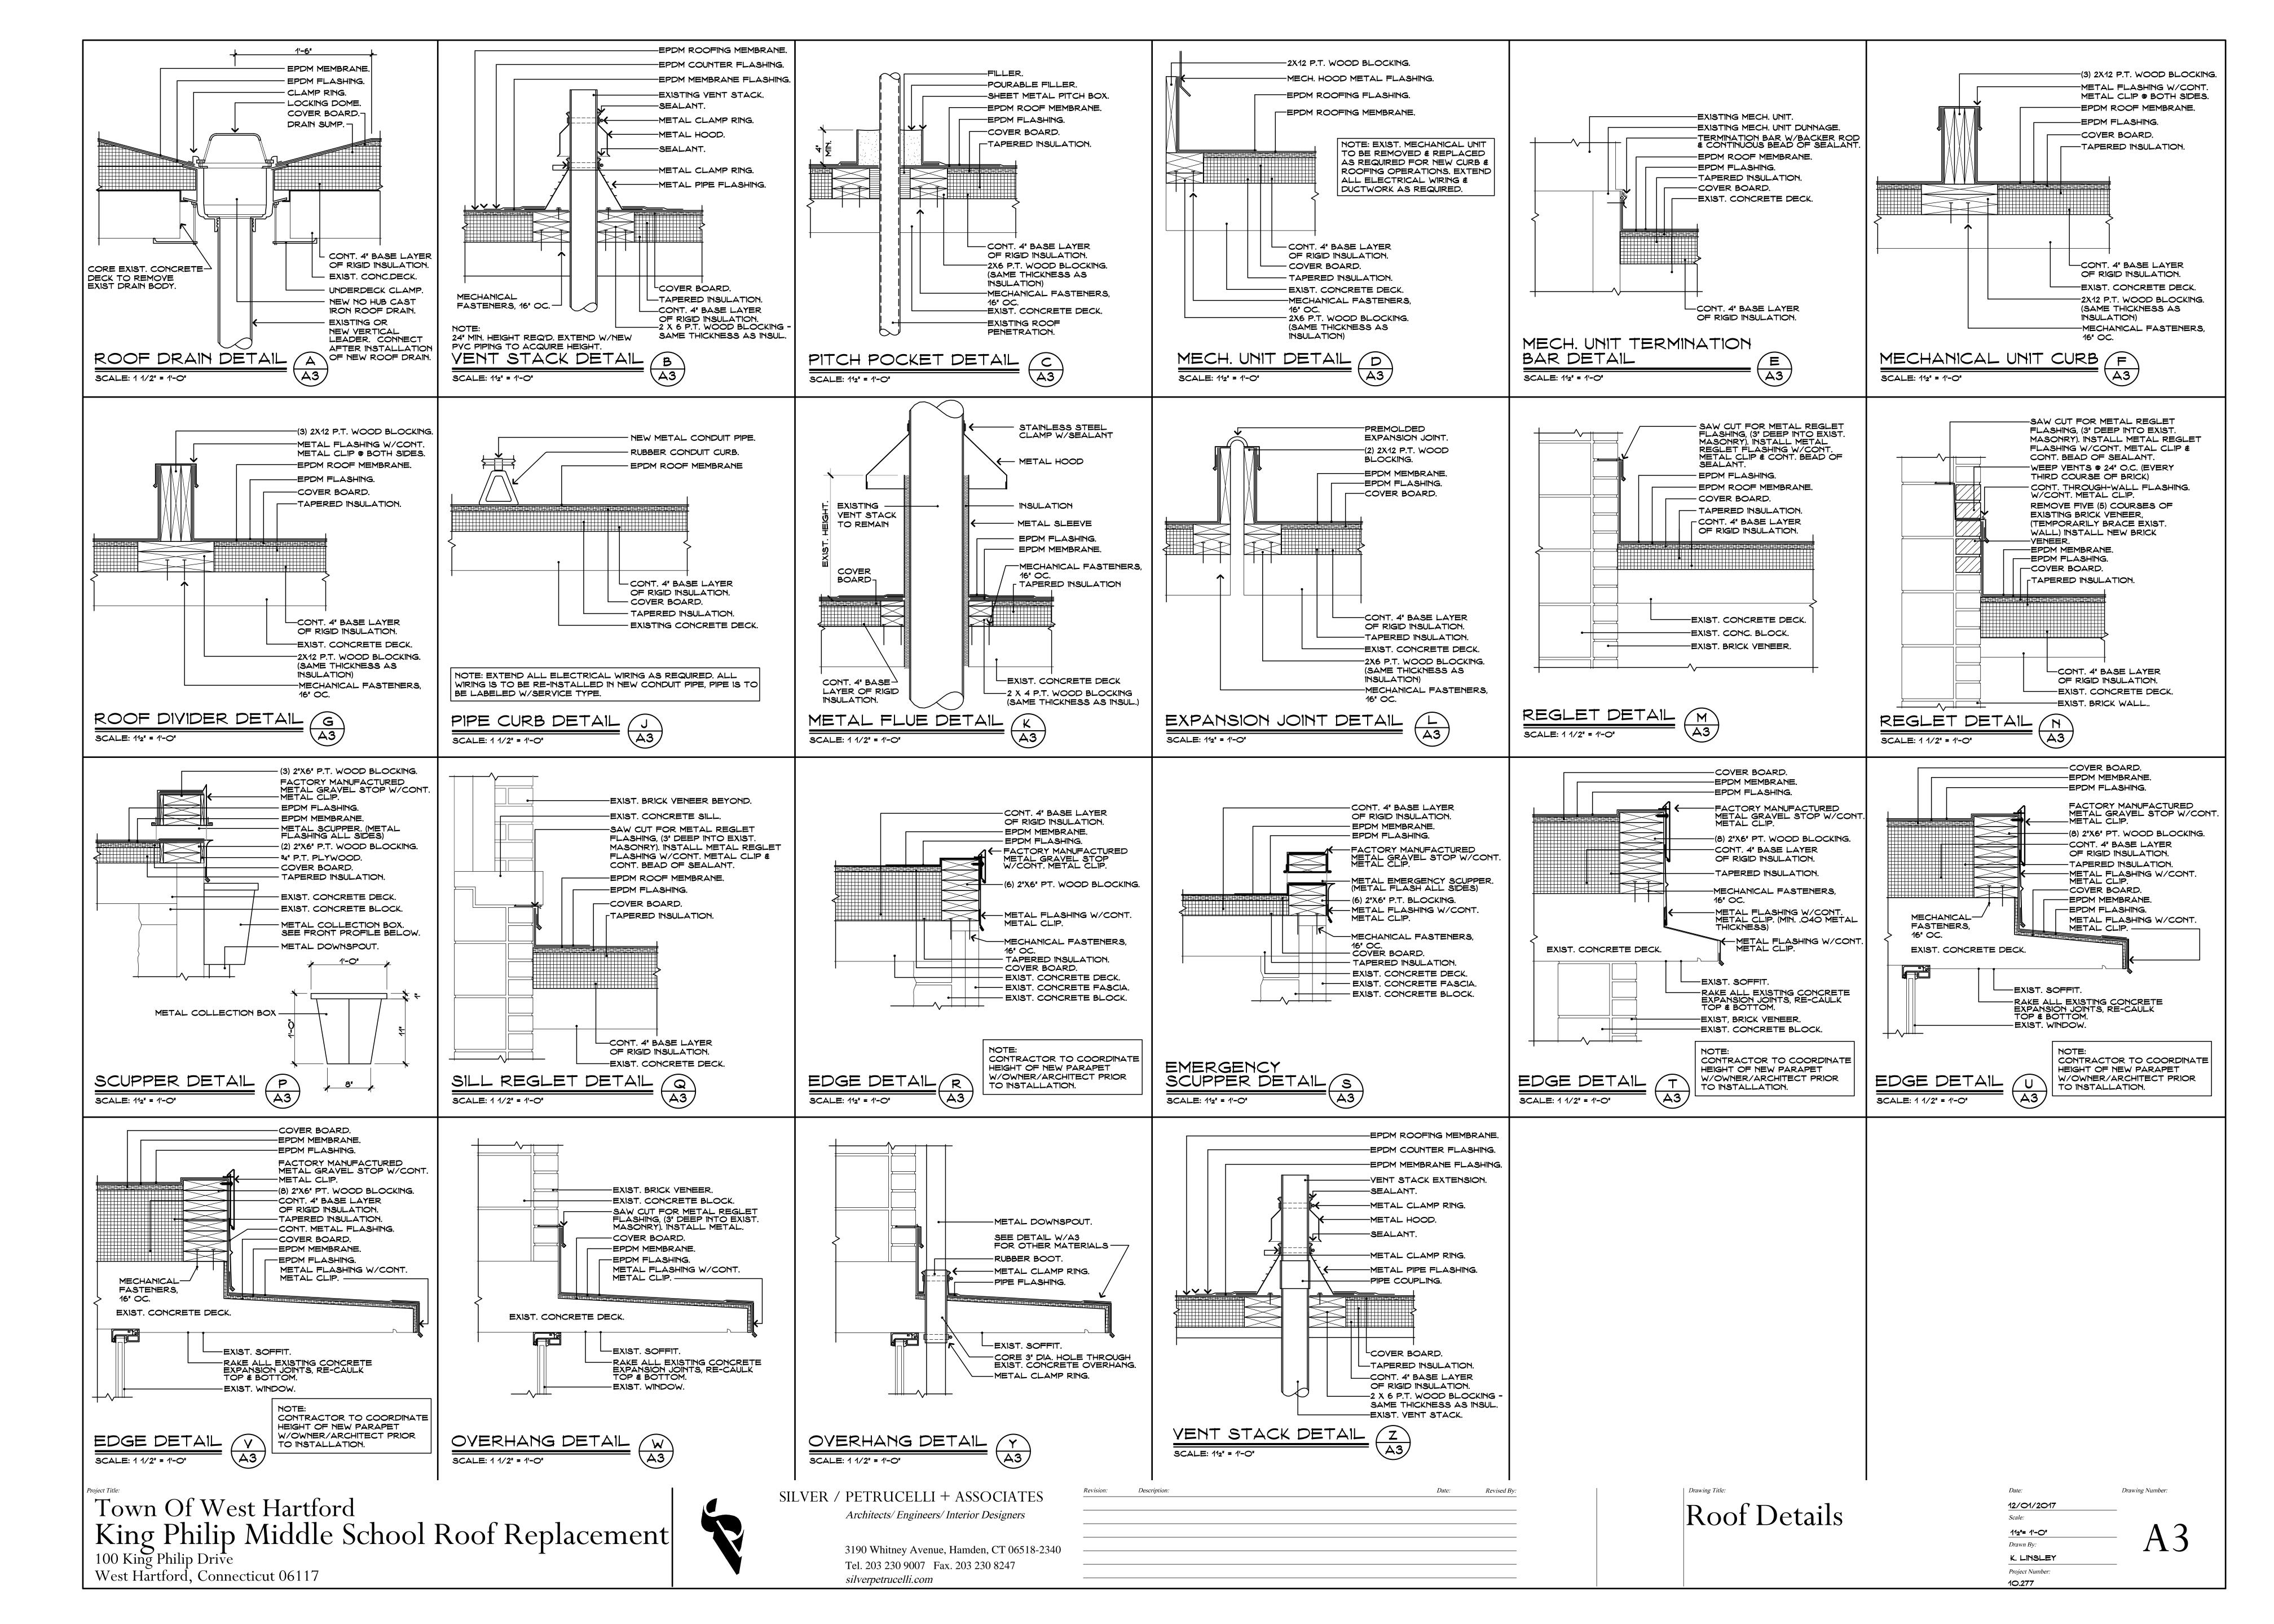

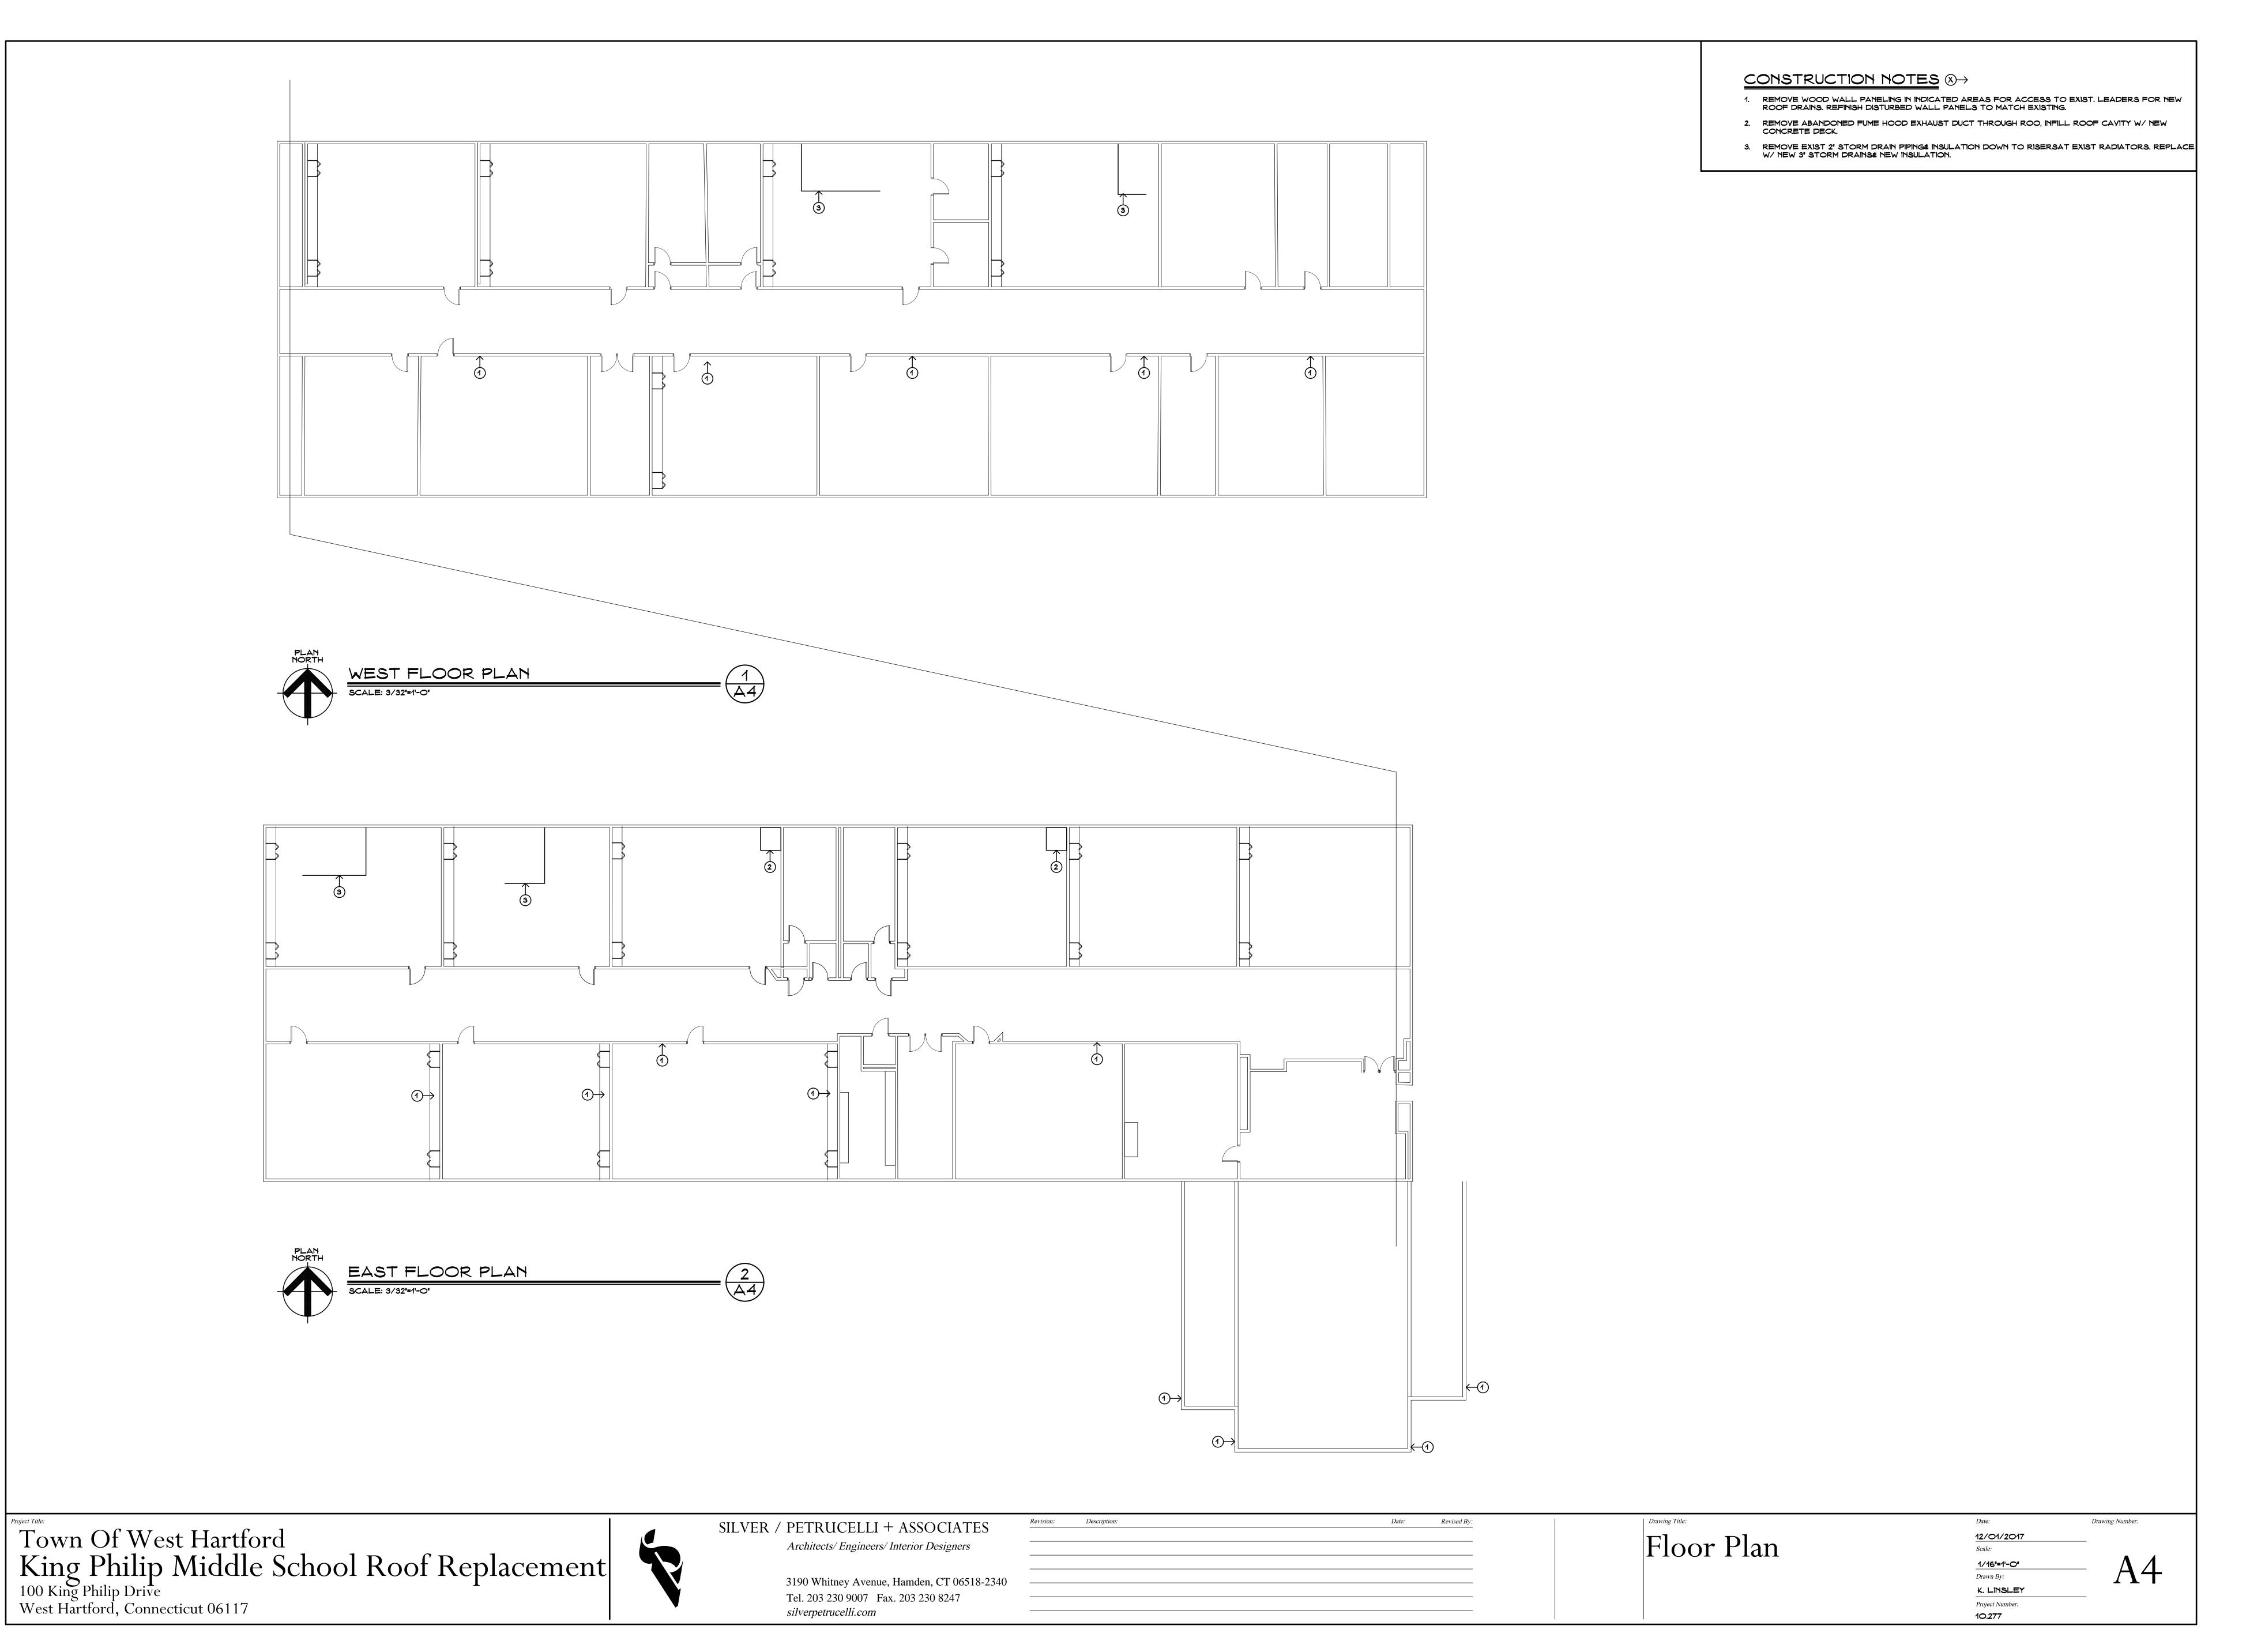

GENERAL NOTES:

REMOVE CAULK FROM CONCRETE DECK SEAMS. DISPOSE OF AS REGULATED ASBESTOS. REMOVE DISLODGED CAULK AND SOIL CONTAMINATED FROM GROUND BELOW. DISPOSE OF AS REGULATED ASBESTOS.

---- REMOVE CAULK AND FLASHING FROM REGLETS AND DISPOSE OF AS REGULATED ASBESTOS.


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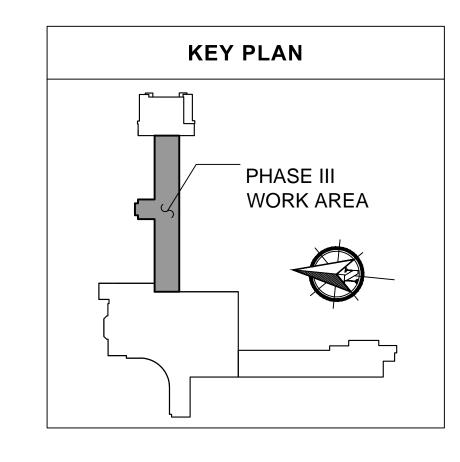
REMOVE ASPHALT FLASHING CEMENT FROM VENT BASES AND REPAIR AREAS. DISPOSE OF AS REGULATED ASBESTOS.


REMOVE 2-PLY BITUMINOUS ROOFING. CLEAN RESIDUAL ROOFING FROM CONCRETE DECK. DISPOSE OF AS CONNECTICUT REGULATED (PCB) WASTE.

REMOVE PITCH POCKETS FROM HVAC PENETRATIONS. CLEAN RESIDUAL PITCH FROM ROOF AND HVAC COMPONENTS. DISPOSE OF AS REGULATED ASBESTOS WASTE.

REMOVE FLASHING CEMENT AND DISPOSE OF AS CONNECTICUT REGULATED PCB WASTE.



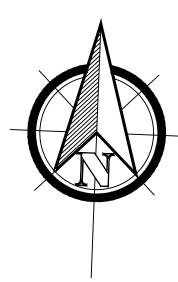

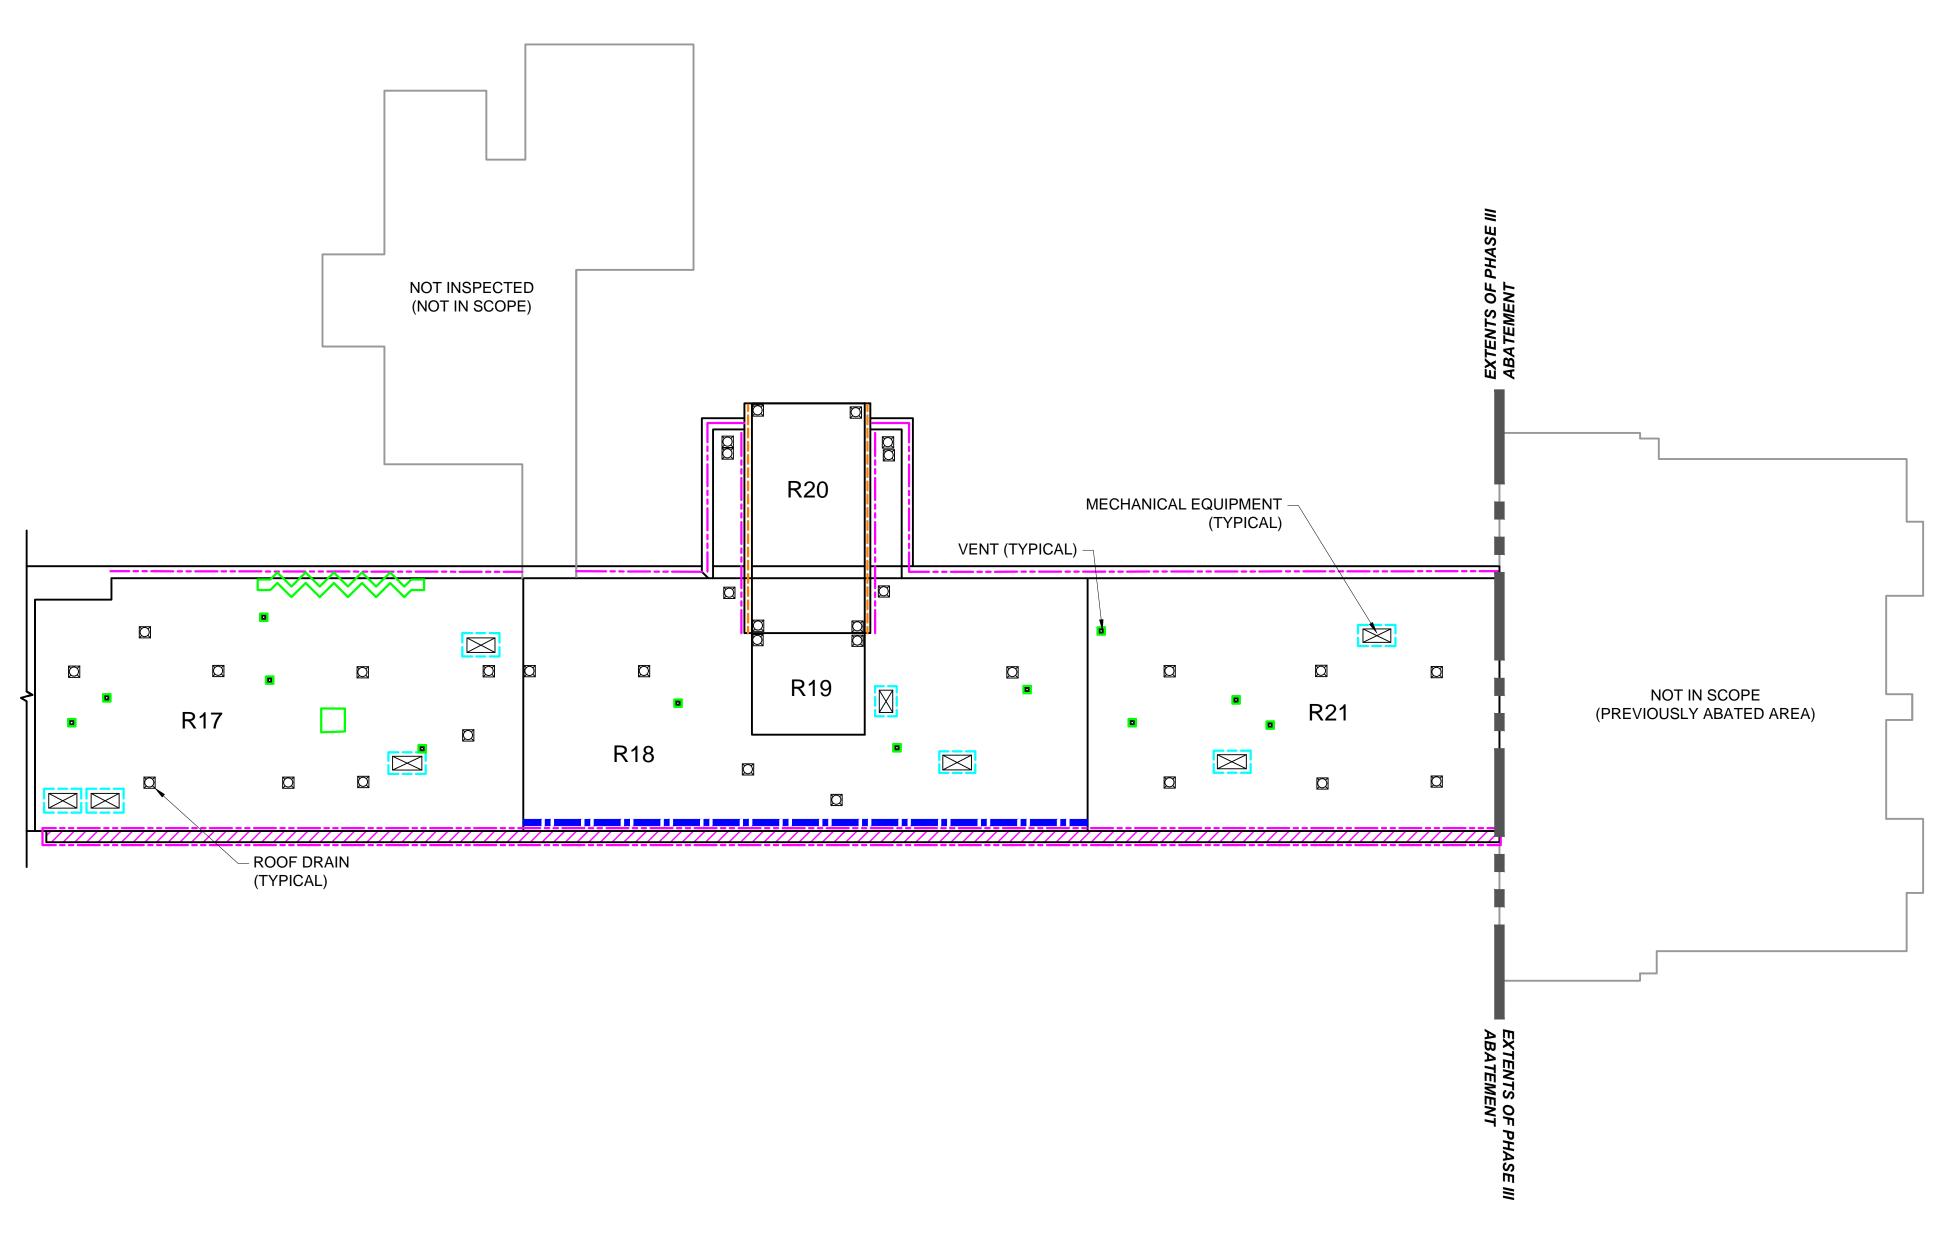

PHASE III WORK AREA

NOT TO SCALE

SHEET NO.

REVISIONS DATE:

JO. DATE: DESCRIPTION DRAWI
SCALE
REVIEV
REVIEV

PHILLIP MIDDLE SCHOOL REPLACEMENT - PHASE III

ING PHILLIP MIDDLE
SCHOOL
100 KING PHILLIP DRIVE
EST HARTFORD, CONNECTICUT

EAGLE
Environmental, Inc.
TH MAIN STREET, SUITE 3
VILLE, CONNECTICUT 06786
39-8257

ASBESTOS AND PCB ABATEMENT PLAN

ASBI