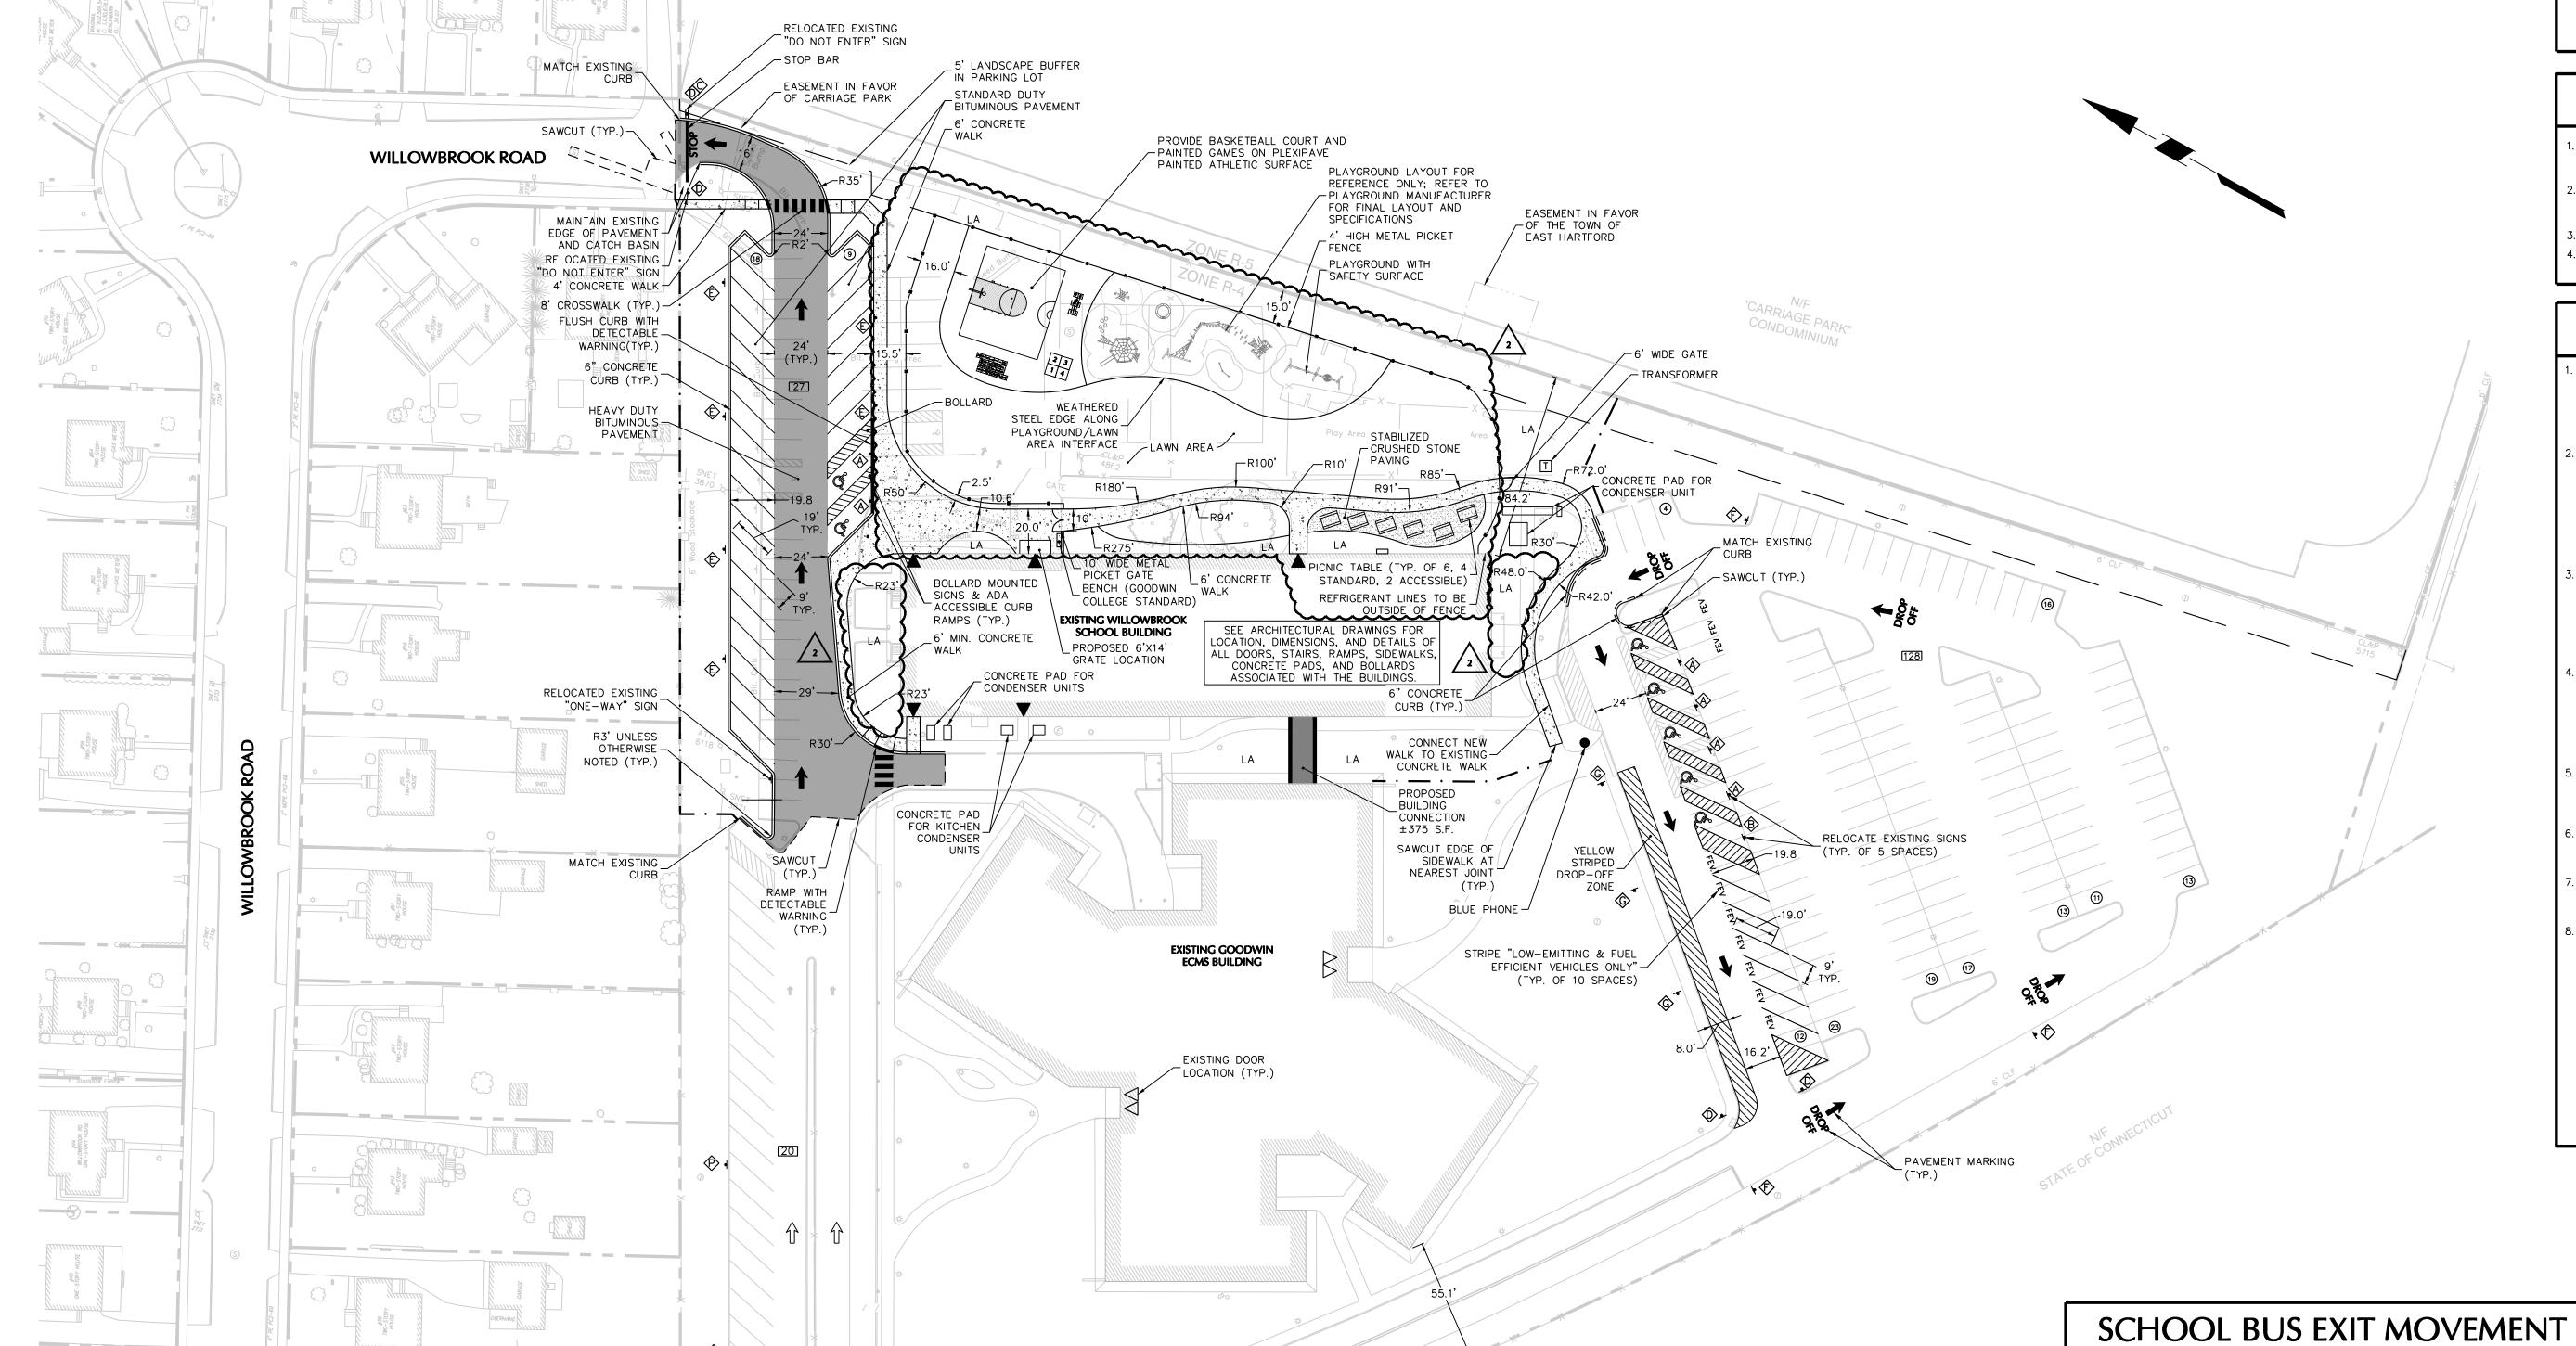


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LEGEND				
	EXISTING	PROPOSED		
PROPERTY LINE				
R.O.W LINE				
ZONE LINE				
SETBACK LINE				
BUILDING LINE	<u>/////////////</u>			
DOOR LOCATION	$\nabla$	▼		
CURB LINE				
FENCE	xxx	×××		
TRAFFIC SIGN	0 0	•		
SIGN DESIGNATION		♠		
PARKING SPACE COUNT		9 50		
BOLLARD	•			
TRANSFORMER		Ī		
CONCRETE SIDEWALK/PAD				
STANDARD DUTY ASPHALT PAVEMENT				
HEAVY DUTY ASPHALT PAVEMENT				
TRAFFIC DIRECTIONAL ARROW (FOR INFORMATION ONLY)		Î		
TRAFFIC DIRECTIONAL ARROW (PAVEMENT MARKING)	1	<b>1</b>		
LANDSCAPED PLANTING AREA		LA		

## **GENERAL NOTES**

- EXISTING CONDITIONS SHOWN OBTAINED FROM A SURVEY TITLED BOUNDARY AND TOPOGRAPHIC SURVEY GOODWIN COLLEGE PROPERTIES ON ENSIGN STREET AND WILLOWBROOK ROAD BY ZURIC, CARR AND ASSOCIATES, INC. DATED APRIL 6, 2016. ACCORDING TO FEMA MAP TITLED "FLOOD INSURANCE RATE MAP HARTFORD COUNTY, CONNECTICUT" PANEL 507 OF 675, MAP NUMBER 09003C0507G EFFECTIVE DATE SEPTEMBER 16, 2011 THE ENTIRE SITE FALLS WITHIN FEMA ZONE X (UNSHADED).
- . ALL EXISTING SIGNAGE TO REMAIN UNLESS OTHERWISE NOTED. ANY WORK PERFORMED IN THE RIGHT OF WAY WILL REQUIRE A STREET EXCAVATION PERMIT FROM THE TOWN OF EAST HARTFORD AND MUST CONFORM TO TOWN STANDARDS.

## **CONTRACTOR NOTES**

THESE PLANS REPRESENT OVERALL SITEWORK REQUIRED FOR PROJECT CONSTRUCTION. THE WORK TO BE PERFORMED IS AS SHOWN ON THE DRAWINGS. THE CONTRACTOR IS RESPONSIBLE FOR MEANS AND METHODS OF CONSTRUCTION: AS SUCH, THESE PLANS MAY NOT COMPLETELY REPRESENT ALL SPECIFIC SITE DETAILS OF INSTALLATION REQUIRED FOR SITEWORK CONSTRUCTION. CONTRACTOR IS RESPONSIBLE TO PROVIDE ALL IMPROVEMENTS REQUIRED TO ACHIEVE CONSTRUCTION DEPICTED ON THESE PLANS.

THE CONTRACTOR SHALL ACCEPT THE SITE AS IS. THE CONTRACTOR SHALL MAKE AND SHALL BE DEEMED TO HAVE MADE A THOROUGH SITE INSPECTION IN ORDER TO FIELD CHECK EXISTING SITE CONDITIONS, CORRELATE CONDITIONS WITH THE DRAWINGS AND RESOLVE ANY POSSIBLE CONSTRUCTION CONFLICTS WITH THE OWNER AND OWNER'S ENGINEER PRIOR TO COMMENCEMENT OF WORK. THIS INCLUDES A TOPOGRAPHIC SURVEY OF ANY AREAS THE CONTRACTOR REQUIRES ADDITIONAL TOPOGRAPHIC INFORMATION. ANY CONDITIONS THAT DIFFER FROM THE EXISTING CONDITIONS SHOWN ON THE DRAWINGS THAT ARE NOT BROUGHT TO THE ATTENTION OF THE OWNER AND OWNER'S ENGINEER PRIOR TO THE START OF WORK SHALL NOT BE CONSIDERED GROUNDS FOR

THE CONTRACTOR SHALL PROVIDE WRITTEN REQUESTS FOR INFORMATION TO THE OWNER AND OWNER'S ENGINEER PRIOR TO THE CONSTRUCTION OF ANY SPECIFIC SITEWORK ITEM IF ANY SITEWORK ITEM DEPICTED ON THE PLANS WARRANTS ADDITIONAL ENGINEERING INFORMATION REQUIRED FOR CONSTRUCTION AND IS NOT RELATED TO MEANS AND METHODS OF CONSTRUCTION. THE CONTRACTOR SHALL BE RESPONSIBLE FOR SITEWORK ITEMS INSTALLED DIFFERENTLY THAN INTENDED AS DEPICTED ON THE PLANS IN THE ABSENCE OF SUBMITTING AND RECEIVING REVIEWS AND/OR DIRECTION ON WRITTEN REQUESTS FOR INFORMATION.

IT IS SPECIFICALLY NOTED THAT INFORMATION RELATED TO ELEVATIONS AND PROPOSED UTILITIES (SUCH AS ROADWAY GRADES, INVERT ELEVATIONS, RIM ELEVATIONS, GRATE ELEVATIONS, BUILDING FINISHED FLOOR ELEVATIONS, ETC.) MAY BE FOUND IN MORE THAN ONE LOCATION ON THE DRAWINGS. CONTRACTOR SHALL REVIEW ALL PLANS, PROFILES AND ANY INFORMATION/DATA TABLES FOR CONSISTENCY PRIOR TO CONSTRUCTION. ANY INCONSISTENCIES OR DISCREPANCIES THAT ARE FOUND SHALL IMMEDIATELY BE BROUGHT TO THE ATTENTION OF THE OWNER'S ENGINEER IN WRITING REQUESTING CLARIFICATION PRIOR TO CONSTRUCTION.

THERE ARE ADDITIONAL NOTES, SPECIFICATIONS AND REQUIREMENTS CONTAINED THROUGHOUT THE PLAN SET, AS WELL AS REFERENCES TO SPECIFICATIONS FROM APPLICABLE GOVERNING AUTHORITIES AND INDUSTRY STANDARDS. IT IS THE CONTRACTOR'S RESPONSIBILITY TO OBTAIN, REVIEW AND ADHERE TO ALL THESE DOCUMENTS.


CONTRACTOR SHALL SUBMIT SHOP DRAWINGS FOR ALL DRAINAGE AND UTILITY STRUCTURES AND MANUFACTURED PRODUCTS TO THE ENGINEER OF RECORD FOR REVIEW AND APPROVAL PRIOR TO COMMENCING WITH CONSTRUCTION.


CONTRACTOR IS SOLELY RESPONSIBLE FOR ALL MAINTENANCE OF TRAFFIC MEASURES (INCLUDING DESIGN AND PERMITTING) AS REQUIRED BY THE LOCAL, COUNTY, OR STATE AGENCY HAVING

THE CONTRACTOR IS REQUIRED TO KEEP DETAILED RECORDS OF THE CONSTRUCTION COMPLETED. SPECIFICALLY, ALL UNDERGROUND STRUCTURES, DRAINAGE, WATER, SANITARY, GAS, ELECTRIC, COMMUNICATIONS PIPING, CONDUIT OR APPURTENANCES AND ACCESSORIES AND ALL ABOVE GROUND FEATURES INCLUDING, BUT NOT LIMITED TO, FIRE HYDRANTS, WATER VALVES, DRAINAGE AND SEWER CLEANOUTS, LIGHT POLES AND SIGNS SHALL BE RECORDED BY A PROFESSIONAL LAND SURVEYOR REGISTERED IN THE STATE THAT THE WORK IS PERFORMED. ELEVATIONS OF TOP OF WATER PIPING SHALL BE RECORDED AT ALL BENDS, TEES, AND AT ALL STORM DRAINAGE AND SANITARY SEWER CROSSINGS. SANITARY SEWER TOP OR BOTTOM OF PIPE ELEVATIONS SHALL BE RECORDED AT ALL CROSSINGS WITH WATER AND STORM DRAINAGE PIPING. FINISHED GRADE ELEVATIONS AT ALL WATER VALVES, FIRE HYDRANTS, SANITARY MANHOLES, DRAINAGE STRUCTURES AND CLEANOUT LOCATIONS WILL BE RECORDED. CURB AND PAVEMENT FINISHED GRADE ELEVATIONS AT ALL HIGH AND LOW POINTS, ALONG SWALES, CENTERLINES OF ROADS OR DRIVE AISLES, AND IN PARKING AREAS, SHALL BE RECORDED. AS-BUILT SURVEYS OF THESE ITEMS SHALL BE PROVIDED TO THE ENGINEER OF RECORD WITHIN 30 DAYS OF CONSTRUCTION COMPLETION AND PRIOR TO FINAL PAYMENT BY THE OWNER. THE ENGINEER OF RECORD RESERVES THE RIGHT TO REVIEW THE AS-BUILT SURVEYS AND REQUIRE THE COMPLETED WORK CORRECTED, WHERE DEFICIENCIES WITH RESPECT TO THE CONSTRUCTION DRAWINGS AND THE LOCAL, COUNTY AND STATE STANDARDS ARE NOT ADHERED T Y THE CONTRACTORS WORK.

**SEE SHEET C1.20 FOR WORK** 

REQUIRED OFFSITE

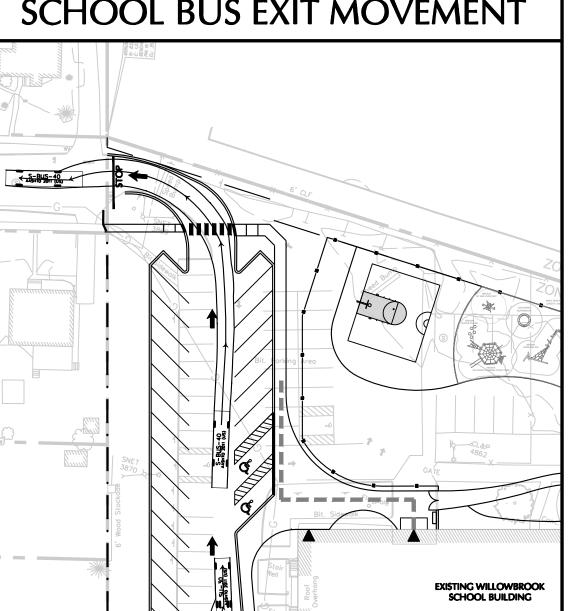

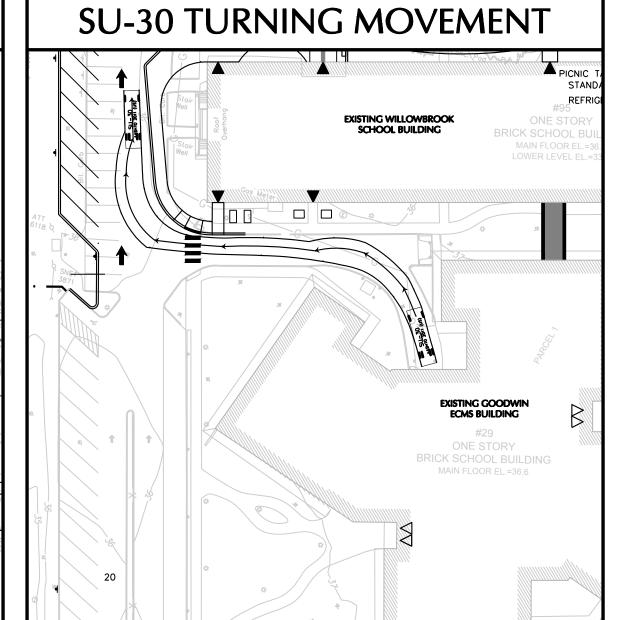

BID DOCUMENTS

SVIGALS + PARTNERS

84 Orange Street + New Haven, Connecticut

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Langan Engineering, Environmental, Surveying and Landscape Architecture, D.P.C. S.A.
Langan Engineering, Environmental, Surveying and Landscape Architecture, D.P.C.
Langan Engineering and Environmental Services, Inc.
Langan CT, Inc.
Langan International LLC
Collectively known as Langan

Date

9/5/17

4/13/18

**REVISION LOG:** 

No. Description

PROJECT NAME:

GOODWIN

ELEMENTARY

29 WILLOWBROOK ROAD,

EAST HARTFORD, CT 06118

COLLEGE

SCHOOL

SCG PROJECT

# 542-0005 MAG/N

1 BULLETIN 1

2 BULLETIN 15

203.786.5110 + www.svigals.com

DRAWING TITLE:

SITE PLAN

DATE: 02/09/2017 JOB NO: 1576.00

DRAWING NO:

Filename: \\langan.com\data\\NHV\data7\140132701\Cadd Data - 140132701\SheetFiles\140132701-CS101-0101.dwg Date: 4/13/2018 Time: 10:34 User: javeni Style Table: Langan.stb Layout: C1.00

LEGEND				
	EXISTING	PROPOSED		
PROPERTY LINE	— —			
BUILDING LINE	7//////////////////////////////////////			
CURB LINE				
LIMIT OF GRADING		<b>- · - · -</b>		
CONTOUR	100	100		
SPOT ELEVATION	× 101.1	× 101.1		
STORM MANHOLE	D	•		
CATCH BASIN		ш ш		
STORM SEWER PIPE				
CLEANOUT		° C.O.		
DOOR LOCATION		lacktriangledown		
ACCESSIBLE ROUTE				

\_\_\_12" RCP ⊚ 0.5%

└PIPE 8" HDPE @

210 LF COLLECTOR PIPE

8" HDPE @ 0.5%

INV = 30.0

SLOPES WITHIN BASKETBALL COURT COURT AREA (INCLUDING 5 BUFER) NOT TO EXCEED 1%).

INV = 30.9

91 LF

ONE STORY 12" HDPE BRICK SCHOOL BUILDING © 0.5%

COLLECTOR PIPE -

8" HDPE @ 0.5%

ONE STORY

MAIN FLOOR EL.=36.0

-GR = 35.5

**EXISTING GOODWIN ECMS BUILDING** 

#29

ONE STORY BRICK SCHOOL BUILDING MAIN FLOOR EL.=36.6

LIMIT OF GRADING

🖫 (TYP.)

77 LE

" HDPE —

INV=31.0 30 LF 12" 231 LF COLLECTO HDPE 0 0.5% P PIPE 12" HDPE

12" HDPE-

CONNECT EXISTING DOWNSPOUT

PIPE USING TRANSPION BOOT

EXISTING WILLOWBROOK (TYP.)

PROVIDE MINIMUM

2' OF COVER

SCHOOL BUILDING

WILLOWBROOK ROAD

CAR PORT

\* INV⇒30.1

....96 LF 18" RCP —

<sup>8</sup>@ 0,5% YD-10

GR = 34.7

INV = 30.3

ZHEOL

12" RCP -/ @ 1.0%

GR=34.8-

8 LF

12" RCP —/ @ 1.0% / 107 LF

GR = 34.5 +

**a** 0.5%

EXCEED 2.0% WITHIN

ACCESSIBLE PARKING

ACCESSIBLE ROUTES

SPACES AND

## **GENERAL NOTES**

- EXISTING CONDITIONS SHOWN OBTAINED FROM A SURVEY TITLED BOUNDARY AND TOPOGRAPHIC SURVEY GOODWIN COLLEGE PROPERTIES ON ENSIGN STREET AND WILLOWBROOK ROAD BY ZURIC, CARR AND ASSOCIATES, INC. DATED APRIL 6, 2016.
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- . ALL EXISTING SIGNAGE TO REMAIN UNLESS OTHERWISE NOTED. . ANY WORK PERFORMED IN THE RIGHT OF WAY WILL REQUIRE A STREET EXCAVATION PERMIT FROM

# **GRADING & DRAINAGE NOTES**

- ALL PROPOSED STORM DRAINAGE PIPING TO UTILIZE WATER-TIGHT JOINTS.
- LOCATIONS AND ELEVATIONS OF ROOF LEADERS SHOULD BE COORDINATED WITH ARCHITECTURAL DRAWINGS PRIOR TO CONSTRUCTION.

THE TOWN OF EAST HARTFORD AND MUST CONFORM TO TOWN STANDARDS.

- INTERSECTIONS, BENDS AND UPSTREAM ENDS.
- . ALL REQUIRED STORM LATERALS SERVICING THE BUILDINGS SHALL BE COORDINATED AND CONSTRUCTED TO WITHIN FIVE FEET OF EACH BUILDING LATERAL ENTRANCE LOCATION AT THE INVERTS NOTED. ANY NECESSARY EXTENSIONS, RELOCATIONS, OR CORRECTIONS WITHIN FIVE FEET OF
- THE SIZES OF ALL DRAINAGE STRUCTURES HAVE BEEN DESIGNED TO ACCOMMODATE PIPE SIZES AND CONFIGURATIONS AS SHOWN. IN THE EVENT THAT PIPE SIZES OR CONFIGURATIONS ARE PROPOSED TO
- STORM DRAINAGE PIPING INSTALLATION SHALL COMMENCE AT THE FURTHEST DOWNSTREAM POINT AND PROCEED UPSTREAM "IN THE DRY".

# **ABBREVIATIONS**

ABBREVIATIONS ARE AS FOLLOWS: CLF = CHAIN LINK FENCE TYP = TYPICAL CB = CATCH BASINMH = MANHOLERCP = REINFORCED CONCRETE PIPE HDPE = HIGH DENSITY POLYETHYLENE PIPE DIP = DUCTILE IRON PIPE

CMP = CORRUGATED METAL PIPE

THESE PLANS REPRESENT OVERALL SITEWORK REQUIRED FOR PROJECT CONSTRUCTION. THE WORK TO BE

- THE CONTRACTOR SHALL ACCEPT THE SITE AS IS. THE CONTRACTOR SHALL MAKE AND SHALL BE DEEMED TO HAVE MADE A THOROUGH SITE INSPECTION IN ORDER TO FIELD CHECK EXISTING SITE CONDITIONS, CORRELATE CONDITIONS WITH THE DRAWINGS AND RESOLVE ANY POSSIBLE CONSTRUCTION CONFLICTS WITH THE OWNER AND OWNER'S ENGINEER PRIOR TO COMMENCEMENT OF WORK, THIS INFORMATION. ANY CONDITIONS THAT DIFFER FROM THE EXISTING CONDITIONS SHOWN ON THE DRAWINGS THAT ARE NOT BROUGHT TO THE ATTENTION OF THE OWNER AND OWNER'S ENGINEER PRIOR TO THE
- THE CONTRACTOR SHALL PROVIDE WRITTEN REQUESTS FOR INFORMATION TO THE OWNER AND OWNER'S ENGINEER PRIOR TO THE CONSTRUCTION OF ANY SPECIFIC SITEWORK ITEM IF ANY SITEWORK ITEM DEPICTED ON THE PLANS WARRANTS ADDITIONAL ENGINEERING INFORMATION REQUIRED FOR CONSTRUCTION AND IS NOT RELATED TO MEANS AND METHODS OF CONSTRUCTION. THE CONTRACTOR SHALL BE RESPONSIBLE FOR SITEWORK ITEMS INSTALLED DIFFERENTLY THAN INTENDED AS DEPICTED ON THE PLANS IN THE ABSENCE OF SUBMITTING AND RECEIVING REVIEWS AND/OR DIRECTION ON WRITTEN
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- THERE ARE ADDITIONAL NOTES, SPECIFICATIONS AND REQUIREMENTS CONTAINED THROUGHOUT THE PLAN SET, AS WELL AS REFERENCES TO SPECIFICATIONS FROM APPLICABLE GOVERNING AUTHORITIES AND INDUSTRY STANDARDS. IT IS THE CONTRACTOR'S RESPONSIBILITY TO OBTAIN, REVIEW AND ADHERE TO
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- 3. CLEANOUTS SHALL BE PROVIDED FLUSH TO GRADE AT ALL LOCATIONS OF ROOF DRAIN
- THE BUILDING NECESSARY TO COMPLETE CONNECTION OF LATERALS TO THE BUILDINGS SHALL BE MADE BY THE BUILDING CONTRACTOR.
- BE MODIFIED BY THE CONTRACTOR, THE CONTRACTOR SHALL BE RESPONSIBLE FOR PROVIDING APPROPRIATE SIZED STRUCTURES INCLUDING SHOP DRAWINGS AND SUBMITTALS.

INV = INVERTLF = LINEAR FEETC.O. = CLEANOUTF.E. = FLARED ENDTS = TOP OF STAIRSBS = BOTTOM OF STAIRSTW = TOP OF WALL

LEV = LOW EMITTING VEHICLE BW = BOTTOM OF WALL

# **CONTRACTOR NOTES**

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- CONTRACTOR SHALL SUBMIT SHOP DRAWINGS FOR ALL DRAINAGE AND UTILITY STRUCTURES AND MANUFACTURED PRODUCTS TO THE ENGINEER OF RECORD FOR REVIEW AND APPROVAL PRIOR TO COMMENCING WITH CONSTRUCTION.
- FEATURES INCLUDING, BUT NOT LIMITED TO, FIRE HYDRANTS, WATER VALVES, DRAINAGE AND SEWER CLEANOUTS, LIGHT POLES AND SIGNS SHALL BE RECORDED BY A PROFESSIONAL LAND SURVEYOR REGISTERED IN THE STATE THAT THE WORK IS PERFORMED. ELEVATIONS OF TOP OF WATER PIPING SHALL BE RECORDED AT ALL BENDS, TEES, AND AT ALL STORM DRAINAGE AND SANITARY SEWER CROSSINGS. SANITARY SEWER TOP OR BOTTOM OF PIPE ELEVATIONS SHALL BE RECORDED AT ALL CROSSINGS WITH WATER AND STORM DRAINAGE PIPING. FINISHED GRADE ELEVATIONS AT ALL WATER VALVES, FIRE HYDRANTS, SANITARY MANHOLES, DRAINAGE STRUCTURES AND CLEANOUT LOCATIONS WILL BE RECORDED. CURB AND PAVEMENT FINISHED GRADE ELEVATIONS AT ALL HIGH AND LOW POINTS, ALONG SWALES, CENTERLINES OF ROADS OR DRIVE AISLES, AND IN PARKING AREAS, SHALL BE RECORDED. AS-BUILT SURVEYS OF THESE ITEMS SHALL BE PROVIDED TO THE ENGINEER OF RECORD WITHIN 30 DAYS OF CONSTRUCTION COMPLETION AND PRIOR TO FINAL PAYMENT BY THE OWNER. THE ENGINEER OF RECORD RESERVES THE RIGHT TO REVIEW THE AS-BUILT SURVEYS AND REQUIRE THE COMPLETED WORK CORRECTED, WHERE DEFICIENCIES WITH RESPECT TO THE CONSTRUCTION DRAWINGS AND THE LOCAL, COUNTY AND STATE STANDARDS ARE NOT ADHERED TO BY THE CONTRACTORS WORK.

### **REVISION LOG:**

No. Description 4/13/18 1 BULLETIN 15

SVIGALS + PARTNERS

84 Orange Street + New Haven, Connecticut

LANGAN

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NEW JERSEY NEW YORK CONNECTICUT PENNSYLVANIA OHIO WASHINGTON, DC FLORIDA TEXAS CALIFORNIA ABU DHABI ATHENS DOHA DUBAI ISTANBUL PANAMA LONDON

Langan Engineering, Environmental, Surveying and Landscape Architecture, D.P.C. S.A.
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Langan Engineering and Environmental Services, Inc.
Langan CT, Inc.
Longan International LLC
Collectively known as Langan

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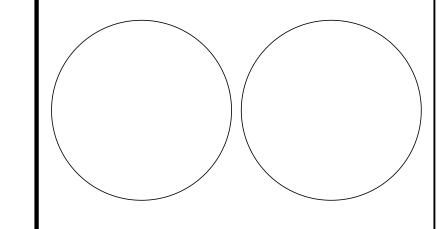
PROJECT NAME:

# GOODWIN COLLEGE ELEMENTARY SCHOOL

29 WILLOWBROOK ROAD, EAST HARTFORD, CT 06118

SCG PROJECT # 542-0005 MAG/N

BID DOCUMENTS




DRAWING TITLE:

GRADING & DRAINAGE

JOB NO: 1576.00

DRAWING NO:



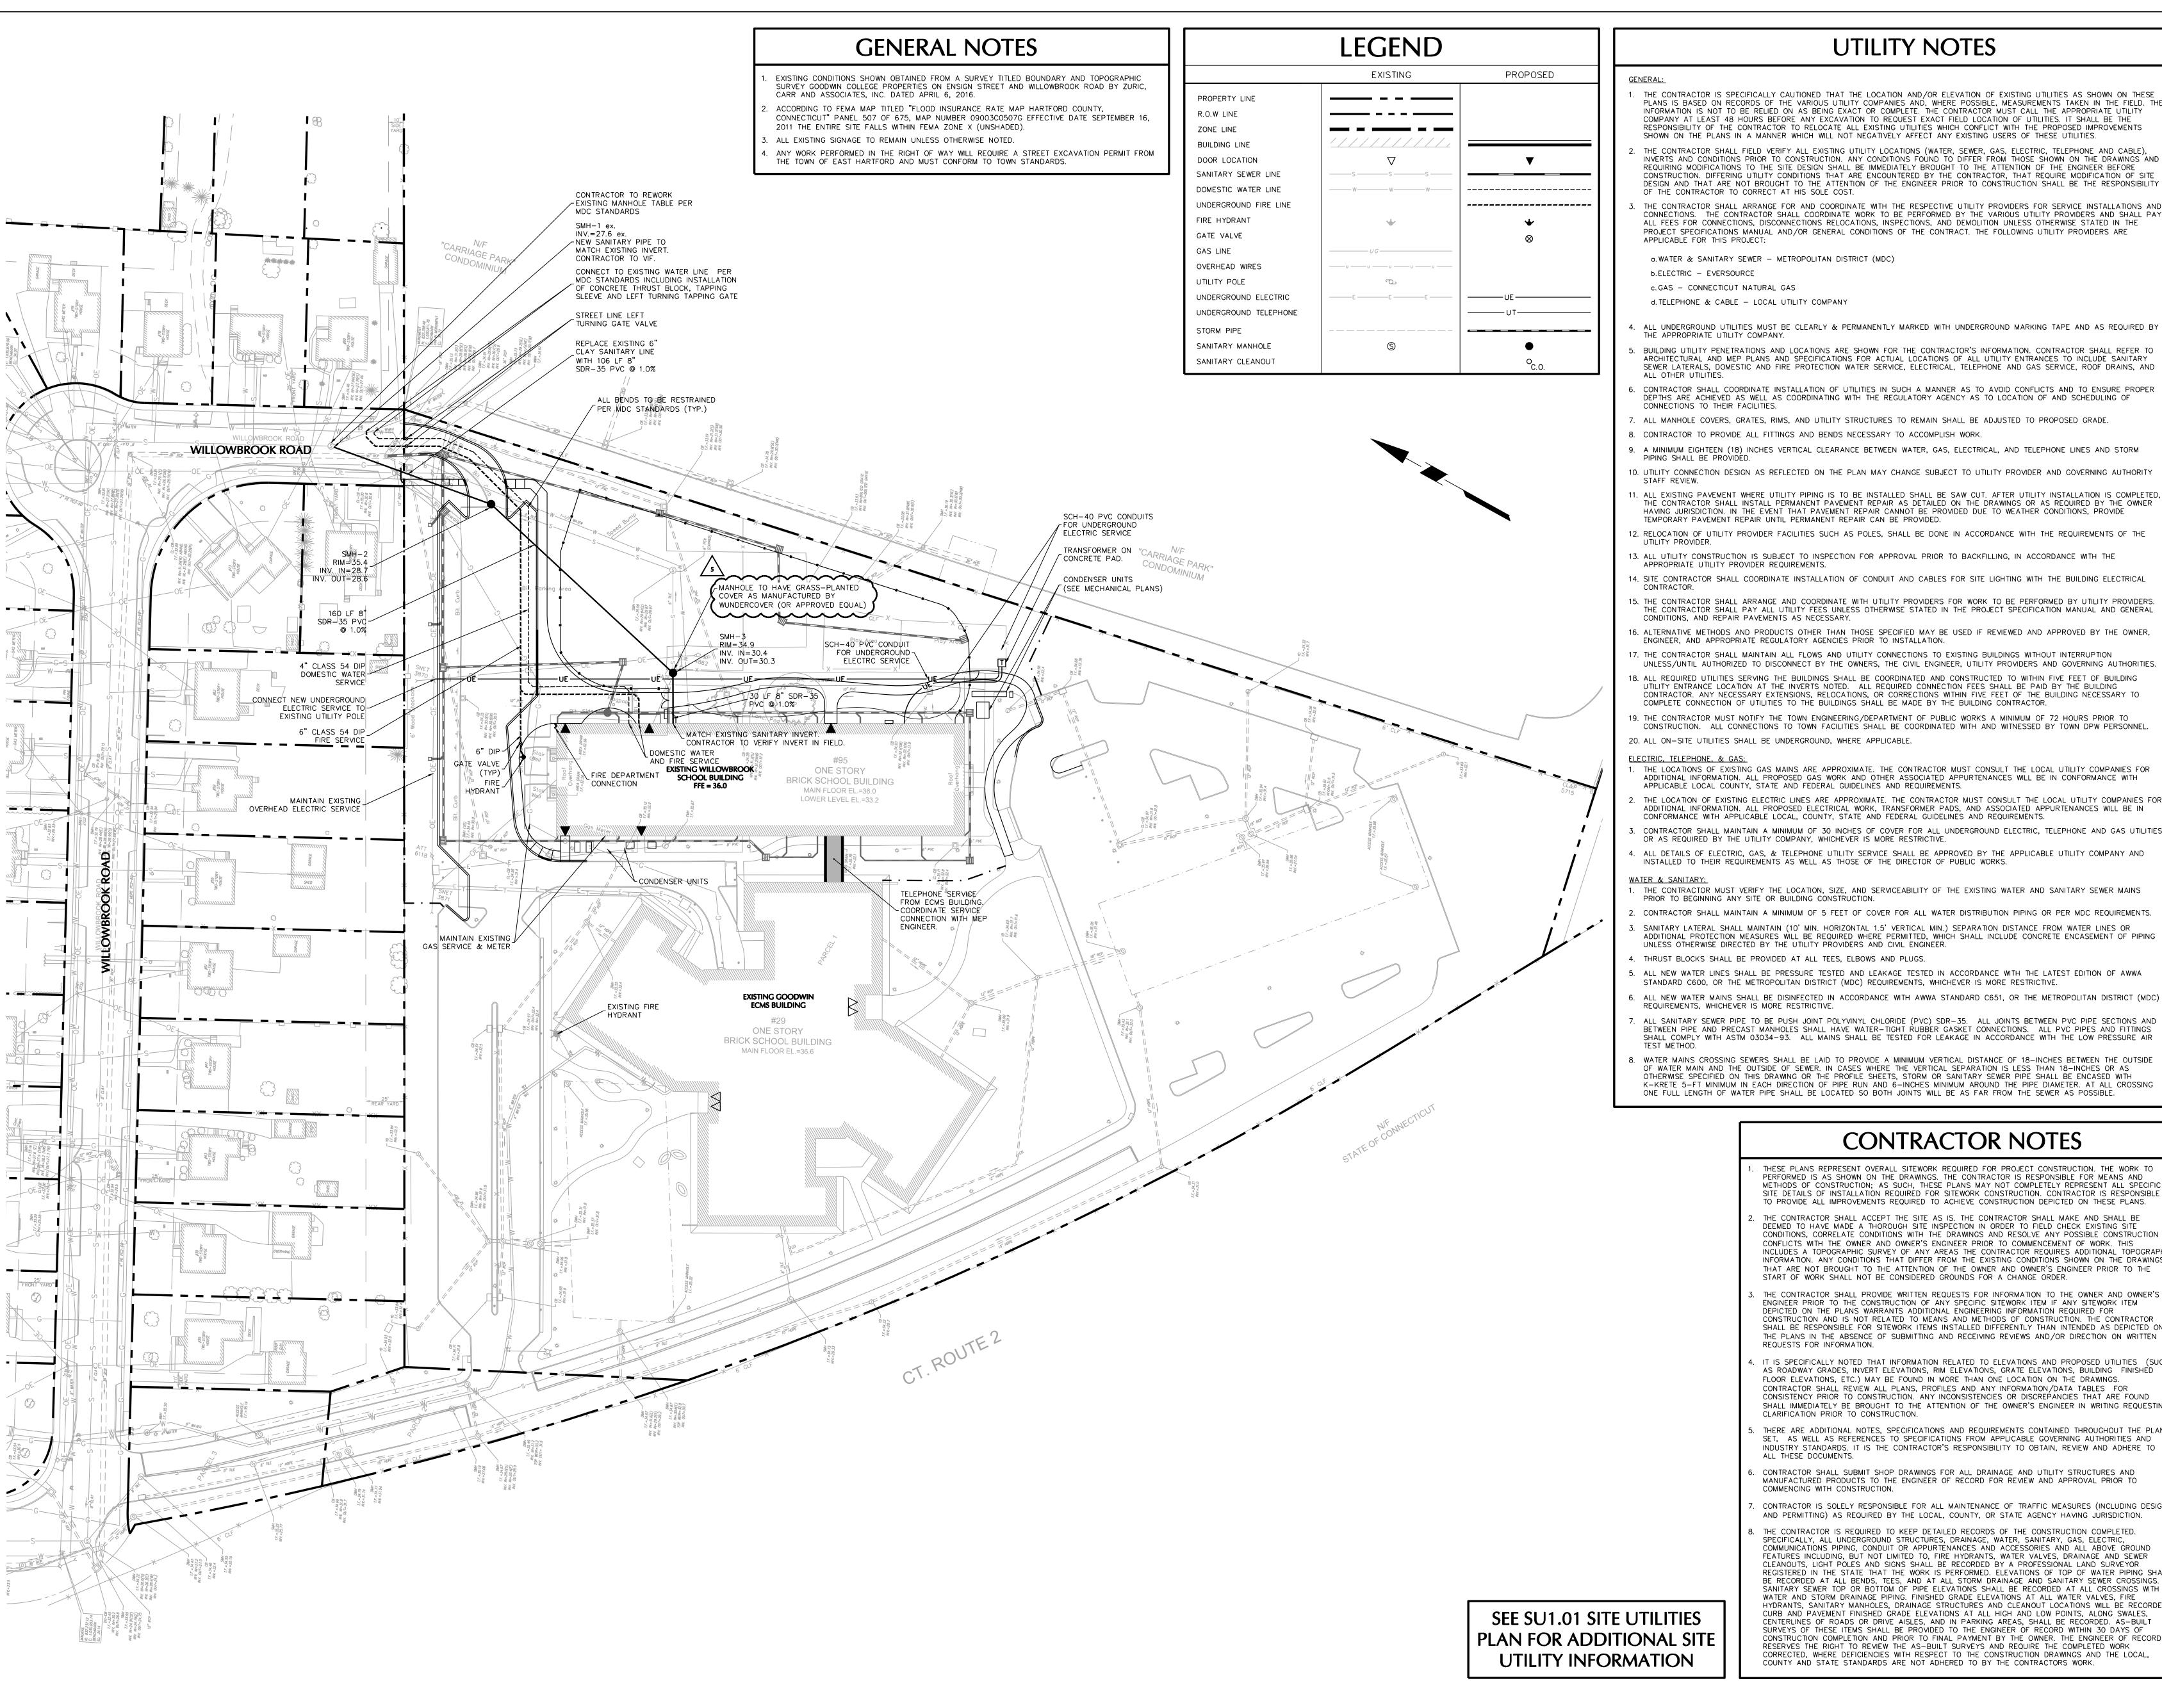

## **UTILITY NOTES**

THE CONTRACTOR IS SPECIFICALLY CAUTIONED THAT THE LOCATION AND/OR ELEVATION OF EXISTING UTILITIES AS SHOWN ON THESE PLANS IS BASED ON RECORDS OF THE VARIOUS UTILITY COMPANIES AND, WHERE POSSIBLE, MEASUREMENTS TAKEN IN THE FIELD. THE INFORMATION IS NOT TO BE RELIED ON AS BEING EXACT OR COMPLETE. THE CONTRACTOR MUST CALL THE APPROPRIATE UTILITY COMPANY AT LEAST 48 HOURS BEFORE ANY EXCAVATION TO REQUEST EXACT FIELD LOCATION OF UTILITIES. IT SHALL BE THE RESPONSIBILITY OF THE CONTRACTOR TO RELOCATE ALL EXISTING UTILITIES WHICH CONFLICT WITH THE PROPOSED IMPROVEMENTS SHOWN ON THE PLANS IN A MANNER WHICH WILL NOT NEGATIVELY AFFECT ANY EXISTING USERS OF THESE UTILITIES.

- THE CONTRACTOR SHALL FIELD VERIFY ALL EXISTING UTILITY LOCATIONS (WATER, SEWER, GAS, ELECTRIC, TELEPHONE AND CABLE). INVERTS AND CONDITIONS PRIOR TO CONSTRUCTION. ANY CONDITIONS FOUND TO DIFFER FROM THOSE SHOWN ON THE DRAWINGS AND REQUIRING MODIFICATIONS TO THE SITE DESIGN SHALL BE IMMEDIATELY BROUGHT TO THE ATTENTION OF THE ENGINEER BEFORE CONSTRUCTION. DIFFERING UTILITY CONDITIONS THAT ARE ENCOUNTERED BY THE CONTRACTOR, THAT REQUIRE MODIFICATION OF SITE DESIGN AND THAT ARE NOT BROUGHT TO THE ATTENTION OF THE ENGINEER PRIOR TO CONSTRUCTION SHALL BE THE RESPONSIBILITY
- THE CONTRACTOR SHALL ARRANGE FOR AND COORDINATE WITH THE RESPECTIVE UTILITY PROVIDERS FOR SERVICE INSTALLATIONS AND CONNECTIONS. THE CONTRACTOR SHALL COORDINATE WORK TO BE PERFORMED BY THE VARIOUS UTILITY PROVIDERS AND SHALL PAY ALL FEES FOR CONNECTIONS, DISCONNECTIONS RELOCATIONS, INSPECTIONS, AND DEMOLITION UNLESS OTHERWISE STATED IN THE PROJECT SPECIFICATIONS MANUAL AND/OR GENERAL CONDITIONS OF THE CONTRACT. THE FOLLOWING UTILITY PROVIDERS ARE

a. WATER & SANITARY SEWER - METROPOLITAN DISTRICT (MDC)

- b.ELECTRIC EVERSOURCE
- c. GAS CONNECTICUT NATURAL GAS d. TELEPHONE & CABLE - LOCAL UTILITY COMPANY
- ALL UNDERGROUND UTILITIES MUST BE CLEARLY & PERMANENTLY MARKED WITH UNDERGROUND MARKING TAPE AND AS REQUIRED BY THE APPROPRIATE UTILITY COMPANY.
- BUILDING UTILITY PENETRATIONS AND LOCATIONS ARE SHOWN FOR THE CONTRACTOR'S INFORMATION. CONTRACTOR SHALL REFER TO ARCHITECTURAL AND MEP PLANS AND SPECIFICATIONS FOR ACTUAL LOCATIONS OF ALL UTILITY ENTRANCES TO INCLUDE SANITARY SEWER LATERALS, DOMESTIC AND FIRE PROTECTION WATER SERVICE, ELECTRICAL, TELEPHONE AND GAS SERVICE, ROOF DRAINS, AND
- . CONTRACTOR SHALL COORDINATE INSTALLATION OF UTILITIES IN SUCH A MANNER AS TO AVOID CONFLICTS AND TO ENSURE PROPER DEPTHS ARE ACHIEVED AS WELL AS COORDINATING WITH THE REGULATORY AGENCY AS TO LOCATION OF AND SCHEDULING OF
- 7. ALL MANHOLE COVERS, GRATES, RIMS, AND UTILITY STRUCTURES TO REMAIN SHALL BE ADJUSTED TO PROPOSED GRADE.
- 8. CONTRACTOR TO PROVIDE ALL FITTINGS AND BENDS NECESSARY TO ACCOMPLISH WORK.
- PIPING SHALL BE PROVIDED. 10. UTILITY CONNECTION DESIGN AS REFLECTED ON THE PLAN MAY CHANGE SUBJECT TO UTILITY PROVIDER AND GOVERNING AUTHORITY
- TEMPORARY PAVEMENT REPAIR UNTIL PERMANENT REPAIR CAN BE PROVIDED. 12. RELOCATION OF UTILITY PROVIDER FACILITIES SUCH AS POLES, SHALL BE DONE IN ACCORDANCE WITH THE REQUIREMENTS OF THE
- 13. ALL UTILITY CONSTRUCTION IS SUBJECT TO INSPECTION FOR APPROVAL PRIOR TO BACKFILLING, IN ACCORDANCE WITH THE APPROPRIATE UTILITY PROVIDER REQUIREMENTS.
- 14. SITE CONTRACTOR SHALL COORDINATE INSTALLATION OF CONDUIT AND CABLES FOR SITE LIGHTING WITH THE BUILDING ELECTRICAL 15. THE CONTRACTOR SHALL ARRANGE AND COORDINATE WITH UTILITY PROVIDERS FOR WORK TO BE PERFORMED BY UTILITY PROVIDERS.
- THE CONTRACTOR SHALL PAY ALL UTILITY FEES UNLESS OTHERWISE STATED IN THE PROJECT SPECIFICATION MANUAL AND GENERAL CONDITIONS, AND REPAIR PAVEMENTS AS NECESSARY.
- 16. ALTERNATIVE METHODS AND PRODUCTS OTHER THAN THOSE SPECIFIED MAY BE USED IF REVIEWED AND APPROVED BY THE OWNER, ENGINEER, AND APPROPRIATE REGULATORY AGENCIES PRIOR TO INSTALLATION.
- UNLESS/UNTIL AUTHORIZED TO DISCONNECT BY THE OWNERS, THE CIVIL ENGINEER, UTILITY PROVIDERS AND GOVERNING AUTHORITIES. 18. ALL REQUIRED UTILITIES SERVING THE BUILDINGS SHALL BE COORDINATED AND CONSTRUCTED TO WITHIN FIVE FEET OF BUILDING UTILITY ENTRANCE LOCATION AT THE INVERTS NOTED. ALL REQUIRED CONNECTION FEES SHALL BE PAID BY THE BUILDING CONTRACTOR. ANY NECESSARY EXTENSIONS, RELOCATIONS, OR CORRECTIONS WITHIN FIVE FEET OF THE BUILDING NECESSARY TO COMPLETE CONNECTION OF UTILITIES TO THE BUILDINGS SHALL BE MADE BY THE BUILDING CONTRACTOR.
- 19. THE CONTRACTOR MUST NOTIFY THE TOWN ENGINEERING/DEPARTMENT OF PUBLIC WORKS A MINIMUM OF 72 HOURS PRIOR TO CONSTRUCTION. ALL CONNECTIONS TO TOWN FACILITIES SHALL BE COORDINATED WITH AND WITNESSED BY TOWN DPW PERSONNEL. O. ALL ON-SITE UTILITIES SHALL BE UNDERGROUND, WHERE APPLICABLE
- THE LOCATIONS OF EXISTING GAS MAINS ARE APPROXIMATE. THE CONTRACTOR MUST CONSULT THE LOCAL UTILITY COMPANIES FOR ADDITIONAL INFORMATION. ALL PROPOSED GAS WORK AND OTHER ASSOCIATED APPURTENANCES WILL BE IN CONFORMANCE WITH APPLICABLE LOCAL COUNTY, STATE AND FEDERAL GUIDELINES AND REQUIREMENTS. THE LOCATION OF EXISTING ELECTRIC LINES ARE APPROXIMATE. THE CONTRACTOR MUST CONSULT THE LOCAL UTILITY COMPANIES FOR
- ADDITIONAL INFORMATION. ALL PROPOSED ELECTRICAL WORK, TRANSFORMER PADS, AND ASSOCIATED APPURTENANCES WILL BE IN CONFORMANCE WITH APPLICABLE LOCAL, COUNTY, STATE AND FEDERAL GUIDELINES AND REQUIREMENTS. CONTRACTOR SHALL MAINTAIN A MINIMUM OF 30 INCHES OF COVER FOR ALL UNDERGROUND ELECTRIC, TELEPHONE AND GAS UTILITIES OR AS REQUIRED BY THE UTILITY COMPANY, WHICHEVER IS MORE RESTRICTIVE.
- . ALL DETAILS OF ELECTRIC, GAS, & TELEPHONE UTILITY SERVICE SHALL BE APPROVED BY THE APPLICABLE UTILITY COMPANY AND INSTALLED TO THEIR REQUIREMENTS AS WELL AS THOSE OF THE DIRECTOR OF PUBLIC WORKS.
- THE CONTRACTOR MUST VERIFY THE LOCATION, SIZE, AND SERVICEABILITY OF THE EXISTING WATER AND SANITARY SEWER MAINS
- PRIOR TO BEGINNING ANY SITE OR BUILDING CONSTRUCTION. . CONTRACTOR SHALL MAINTAIN A MINIMUM OF 5 FEET OF COVER FOR ALL WATER DISTRIBUTION PIPING OR PER MDC REQUIREMENTS.
- SANITARY LATERAL SHALL MAINTAIN (10' MIN. HORIZONTAL 1.5' VERTICAL MIN.) SEPARATION DISTANCE FROM WATER LINES OR ADDITIONAL PROTECTION MEASURES WILL BE REQUIRED WHERE PERMITTED, WHICH SHALL INCLUDE CONCRETE ENCASEMENT OF PIPING UNLESS OTHERWISE DIRECTED BY THE UTILITY PROVIDERS AND CIVIL ENGINEER.
- THRUST BLOCKS SHALL BE PROVIDED AT ALL TEES, ELBOWS AND PLUGS.

REQUESTS FOR INFORMATION.

CLARIFICATION PRIOR TO CONSTRUCTION.

- . ALL NEW WATER LINES SHALL BE PRESSURE TESTED AND LEAKAGE TESTED IN ACCORDANCE WITH THE LATEST EDITION OF AWWA STANDARD C600, OR THE METROPOLITAN DISTRICT (MDC) REQUIREMENTS, WHICHEVER IS MORE RESTRICTIVE.
- ALL NEW WATER MAINS SHALL BE DISINFECTED IN ACCORDANCE WITH AWWA STANDARD C651, OR THE METROPOLITAN DISTRICT (MDC) REQUIREMENTS, WHICHEVER IS MORE RESTRICTIVE.
- BETWEEN PIPE AND PRECAST MANHOLES SHALL HAVE WATER-TIGHT RUBBER GASKET CONNECTIONS. ALL PVC PIPES AND FITTINGS SHALL COMPLY WITH ASTM 03034-93. ALL MAINS SHALL BE TESTED FOR LEAKAGE IN ACCORDANCE WITH THE LOW PRESSURE AIR
- WATER MAINS CROSSING SEWERS SHALL BE LAID TO PROVIDE A MINIMUM VERTICAL DISTANCE OF 18-INCHES BETWEEN THE OUTSIDE OF WATER MAIN AND THE OUTSIDE OF SEWER. IN CASES WHERE THE VERTICAL SEPARATION IS LESS THAN 18-INCHES OR AS OTHERWISE SPECIFIED ON THIS DRAWING OR THE PROFILE SHEETS, STORM OR SANITARY SEWER PIPE SHALL BE ENCASED WITH K-KRETE 5-FT MINIMUM IN EACH DIRECTION OF PIPE RUN AND 6-INCHES MINIMUM AROUND THE PIPE DIAMETER. AT ALL CROSSING ONE FULL LENGTH OF WATER PIPE SHALL BE LOCATED SO BOTH JOINTS WILL BE AS FAR FROM THE SEWER AS POSSIBLE.

# **CONTRACTOR NOTES**

THESE PLANS REPRESENT OVERALL SITEWORK REQUIRED FOR PROJECT CONSTRUCTION. THE WORK TO PERFORMED IS AS SHOWN ON THE DRAWINGS. THE CONTRACTOR IS RESPONSIBLE FOR MEANS AND METHODS OF CONSTRUCTION; AS SUCH, THESE PLANS MAY NOT COMPLETELY REPRESENT ALL SPECIFIC SITE DETAILS OF INSTALLATION REQUIRED FOR SITEWORK CONSTRUCTION. CONTRACTOR IS RESPONSIBLE TO PROVIDE ALL IMPROVEMENTS REQUIRED TO ACHIEVE CONSTRUCTION DEPICTED ON THESE PLANS. THE CONTRACTOR SHALL ACCEPT THE SITE AS IS. THE CONTRACTOR SHALL MAKE AND SHALL BE

DEEMED TO HAVE MADE A THOROUGH SITE INSPECTION IN ORDER TO FIELD CHECK EXISTING SITE CONDITIONS, CORRELATE CONDITIONS WITH THE DRAWINGS AND RESOLVE ANY POSSIBLE CONSTRUCTION CONFLICTS WITH THE OWNER AND OWNER'S ENGINEER PRIOR TO COMMENCEMENT OF WORK. THIS INCLUDES A TOPOGRAPHIC SURVEY OF ANY AREAS THE CONTRACTOR REQUIRES ADDITIONAL TOPOGRAPHIC INFORMATION. ANY CONDITIONS THAT DIFFER FROM THE EXISTING CONDITIONS SHOWN ON THE DRAWINGS THAT ARE NOT BROUGHT TO THE ATTENTION OF THE OWNER AND OWNER'S ENGINEER PRIOR TO THE START OF WORK SHALL NOT BE CONSIDERED GROUNDS FOR A CHANGE ORDER.

- THE CONTRACTOR SHALL PROVIDE WRITTEN REQUESTS FOR INFORMATION TO THE OWNER AND OWNER'S ENGINEER PRIOR TO THE CONSTRUCTION OF ANY SPECIFIC SITEWORK ITEM IF ANY SITEWORK ITEM DEPICTED ON THE PLANS WARRANTS ADDITIONAL ENGINEERING INFORMATION REQUIRED FOR CONSTRUCTION AND IS NOT RELATED TO MEANS AND METHODS OF CONSTRUCTION. THE CONTRACTOR SHALL BE RESPONSIBLE FOR SITEWORK ITEMS INSTALLED DIFFERENTLY THAN INTENDED AS DEPICTED ON THE PLANS IN THE ABSENCE OF SUBMITTING AND RECEIVING REVIEWS AND/OR DIRECTION ON WRITTEN
- IT IS SPECIFICALLY NOTED THAT INFORMATION RELATED TO ELEVATIONS AND PROPOSED UTILITIES (SUCH AS ROADWAY GRADES, INVERT ELEVATIONS, RIM ELEVATIONS, GRATE ELEVATIONS, BUILDING FINISHED FLOOR ELEVATIONS, ETC.) MAY BE FOUND IN MORE THAN ONE LOCATION ON THE DRAWINGS. CONTRACTOR SHALL REVIEW ALL PLANS, PROFILES AND ANY INFORMATION/DATA TABLES FOR CONSISTENCY PRIOR TO CONSTRUCTION. ANY INCONSISTENCIES OR DISCREPANCIES THAT ARE FOUND SHALL IMMEDIATELY BE BROUGHT TO THE ATTENTION OF THE OWNER'S ENGINEER IN WRITING REQUESTING
- THERE ARE ADDITIONAL NOTES, SPECIFICATIONS AND REQUIREMENTS CONTAINED THROUGHOUT THE PLAN SET, AS WELL AS REFERENCES TO SPECIFICATIONS FROM APPLICABLE GOVERNING AUTHORITIES AND INDUSTRY STANDARDS. IT IS THE CONTRACTOR'S RESPONSIBILITY TO OBTAIN, REVIEW AND ADHERE TO
- CONTRACTOR SHALL SUBMIT SHOP DRAWINGS FOR ALL DRAINAGE AND UTILITY STRUCTURES AND MANUFACTURED PRODUCTS TO THE ENGINEER OF RECORD FOR REVIEW AND APPROVAL PRIOR TO
- . CONTRACTOR IS SOLELY RESPONSIBLE FOR ALL MAINTENANCE OF TRAFFIC MEASURES (INCLUDING DESIGN AND PERMITTING) AS REQUIRED BY THE LOCAL, COUNTY, OR STATE AGENCY HAVING JURISDICTION.
- THE CONTRACTOR IS REQUIRED TO KEEP DETAILED RECORDS OF THE CONSTRUCTION COMPLETED. SPECIFICALLY, ALL UNDERGROUND STRUCTURES, DRAINAGE, WATER, SANITARY, GAS, ELECTRIC, COMMUNICATIONS PIPING, CONDUIT OR APPURTENANCES AND ACCESSORIES AND ALL ABOVE GROUND FEATURES INCLUDING, BUT NOT LIMITED TO, FIRE HYDRANTS, WATER VALVES, DRAINAGE AND SEWER CLEANOUTS, LIGHT POLES AND SIGNS SHALL BE RECORDED BY A PROFESSIONAL LAND SURVEYOR REGISTERED IN THE STATE THAT THE WORK IS PERFORMED. ELEVATIONS OF TOP OF WATER PIPING SHAL BE RECORDED AT ALL BENDS, TEES, AND AT ALL STORM DRAINAGE AND SANITARY SEWER CROSSINGS. SANITARY SEWER TOP OR BOTTOM OF PIPE ELEVATIONS SHALL BE RECORDED AT ALL CROSSINGS WITH WATER AND STORM DRAINAGE PIPING, FINISHED GRADE ELEVATIONS AT ALL WATER VALVES, FIRE HYDRANTS, SANITARY MANHOLES, DRAINAGE STRUCTURES AND CLEANOUT LOCATIONS WILL BE RECORDED. CURB AND PAVEMENT FINISHED GRADE ELEVATIONS AT ALL HIGH AND LOW POINTS, ALONG SWALES, CENTERLINES OF ROADS OR DRIVE AISLES, AND IN PARKING AREAS, SHALL BE RECORDED. AS-BUILT SURVEYS OF THESE ITEMS SHALL BE PROVIDED TO THE ENGINEER OF RECORD WITHIN 30 DAYS OF

RESERVES THE RIGHT TO REVIEW THE AS-BUILT SURVEYS AND REQUIRE THE COMPLETED WORK CORRECTED, WHERE DEFICIENCIES WITH RESPECT TO THE CONSTRUCTION DRAWINGS AND THE LOCAL, COUNTY AND STATE STANDARDS ARE NOT ADHERED TO BY THE CONTRACTORS WORK.

CONSTRUCTION COMPLETION AND PRIOR TO FINAL PAYMENT BY THE OWNER. THE ENGINEER OF RECORD

SVIGALS + PARTNERS

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Langan Engineering and Environmental Services, Inc.
Langan Engineering and Environmental Services, Inc.
Langan International LLC
Collectively known as Langan

REVISION LOG:

No.	Description	Date
1	BULLETIN 1	9/5/17
2	BULLETIN 2	9/21/17
3	BULLETIN 5	10/05/17
4	BULLETIN 6	10/17/17
5	BULLETIN 15	4/13/18


PROJECT NAME:

# GOODWIN COLLEGE ELEMENTARY SCHOOL

29 WILLOWBROOK ROAD, EAST HARTFORD, CT 06118

SCG PROJECT # 542-0005 MAG/N

**BID DOCUMENTS** 

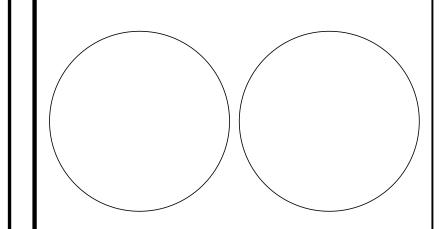


DRAWING TITLE:

**UTILITY PLAN** 

SCALE: 1"=40' DATE: 02/09/2017

JOB NO: 1576.00

DRAWING NO:

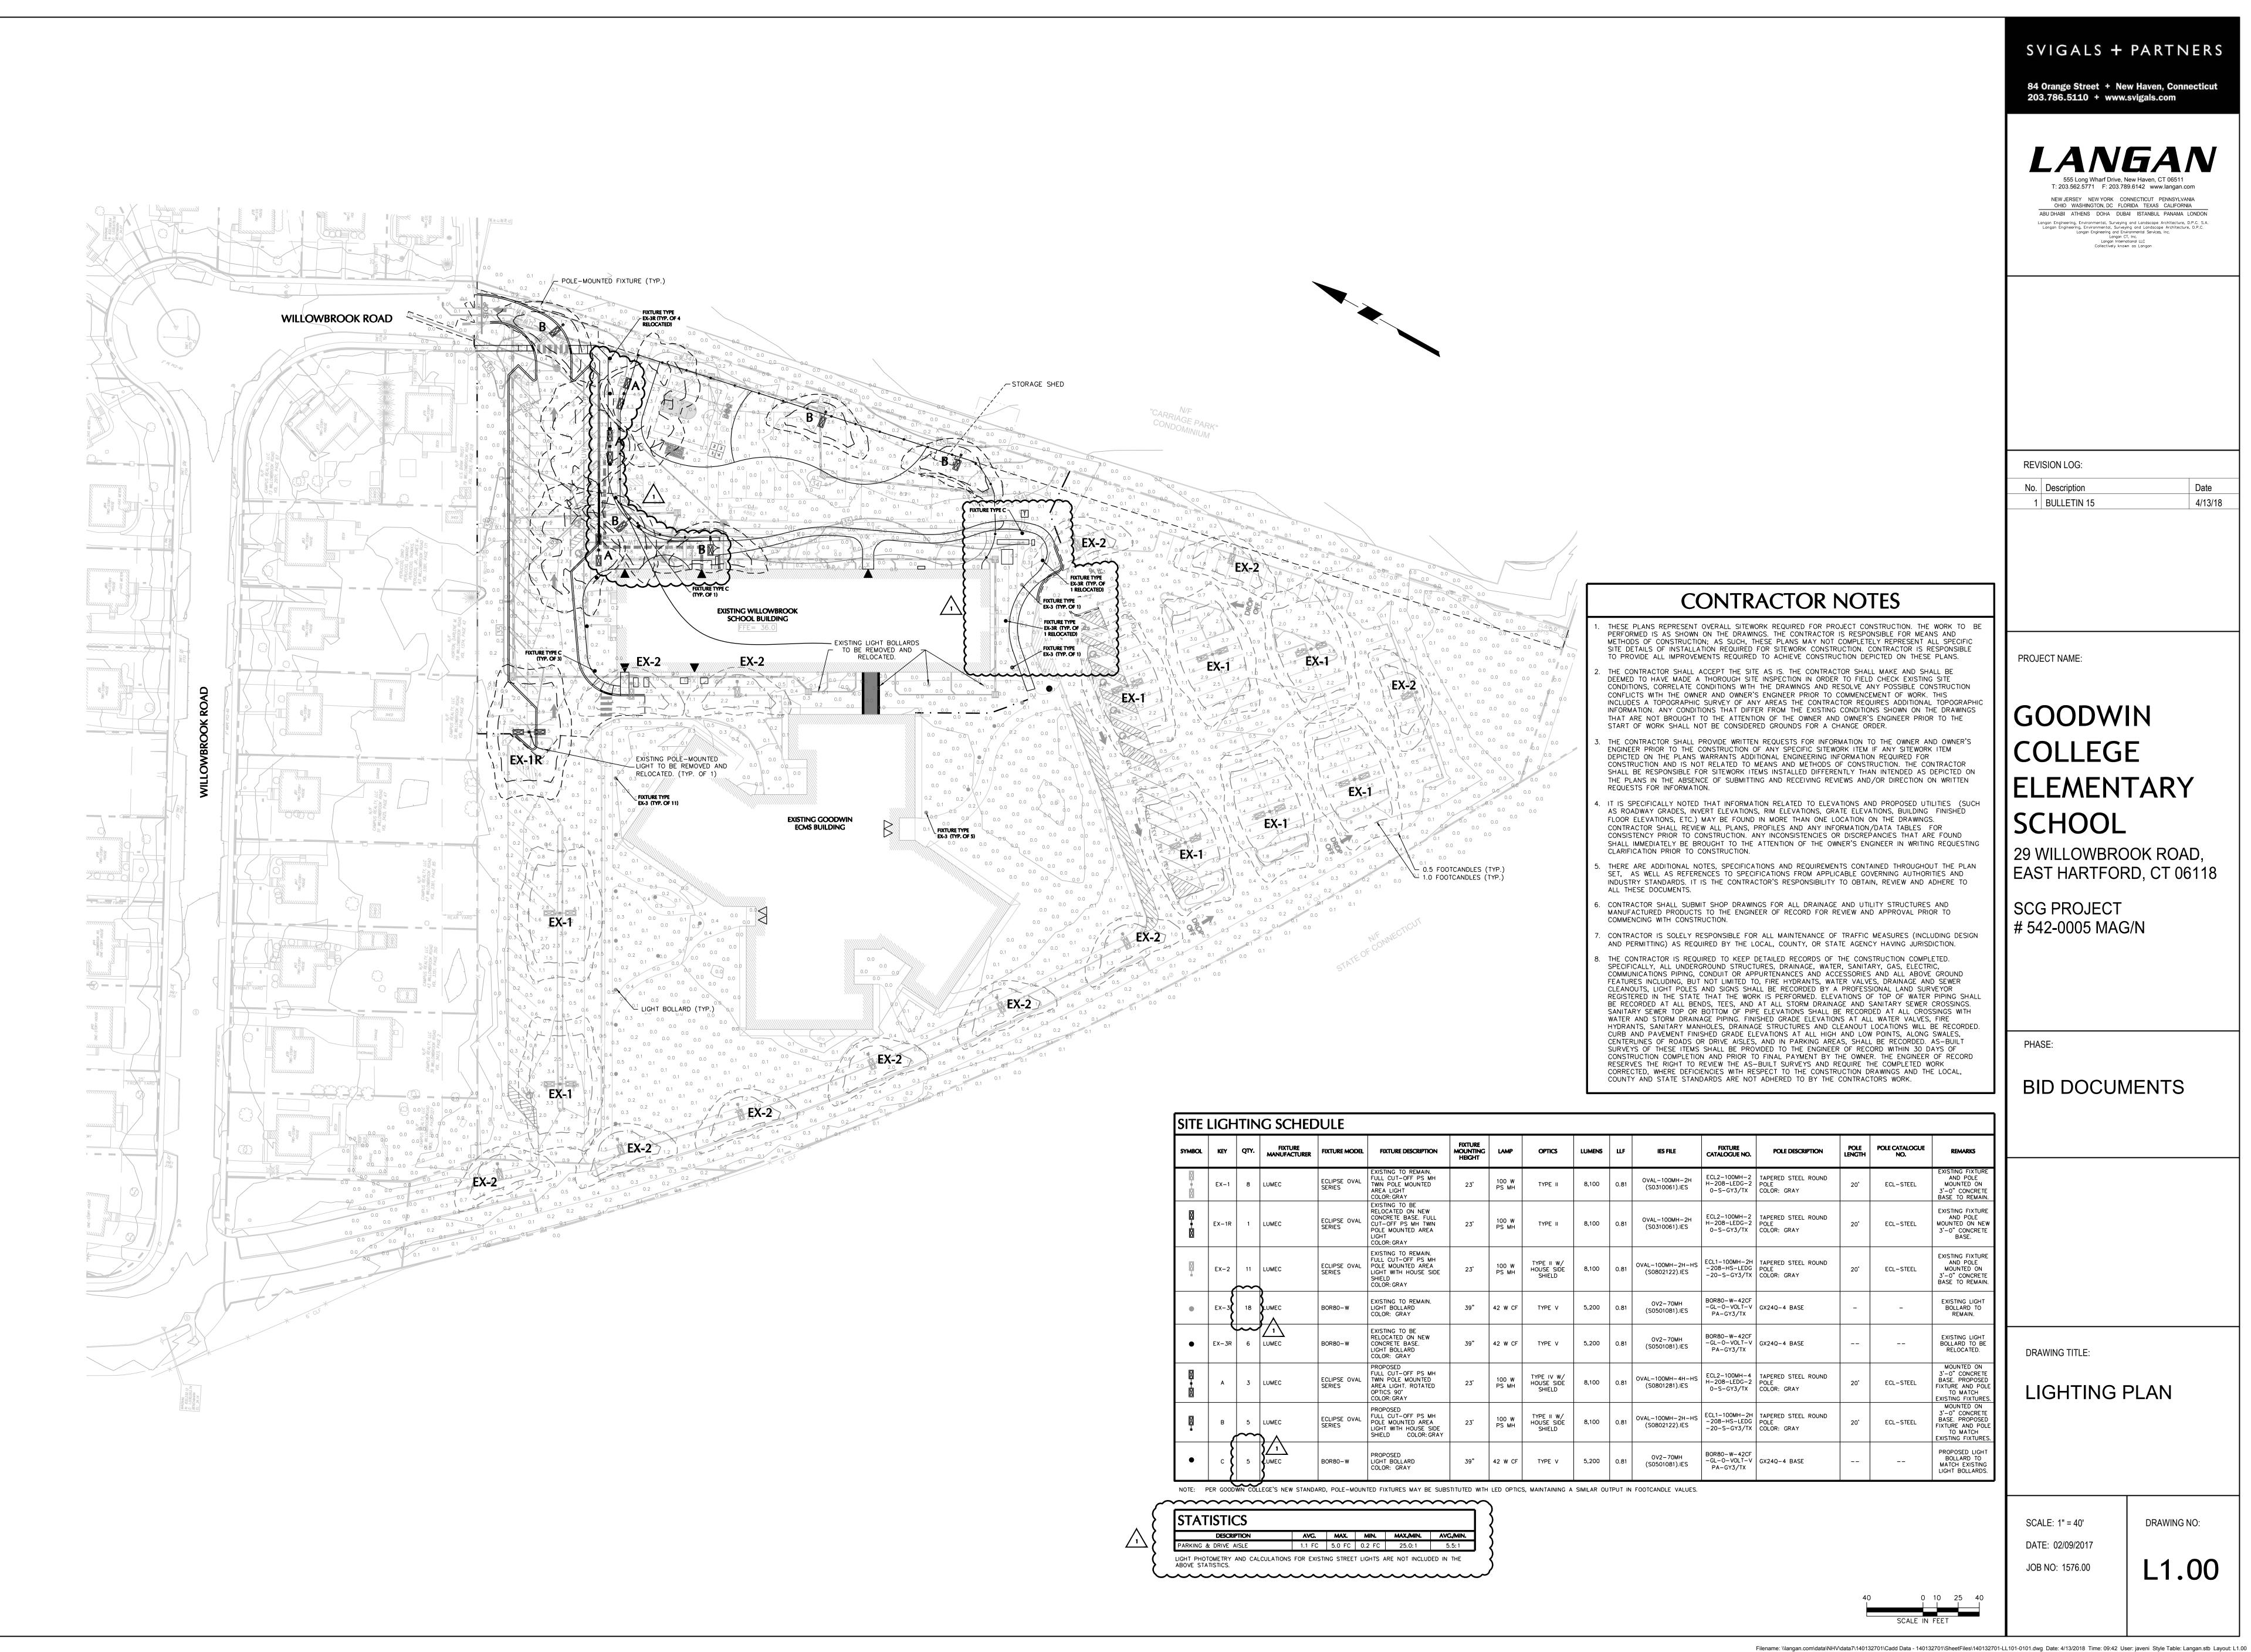


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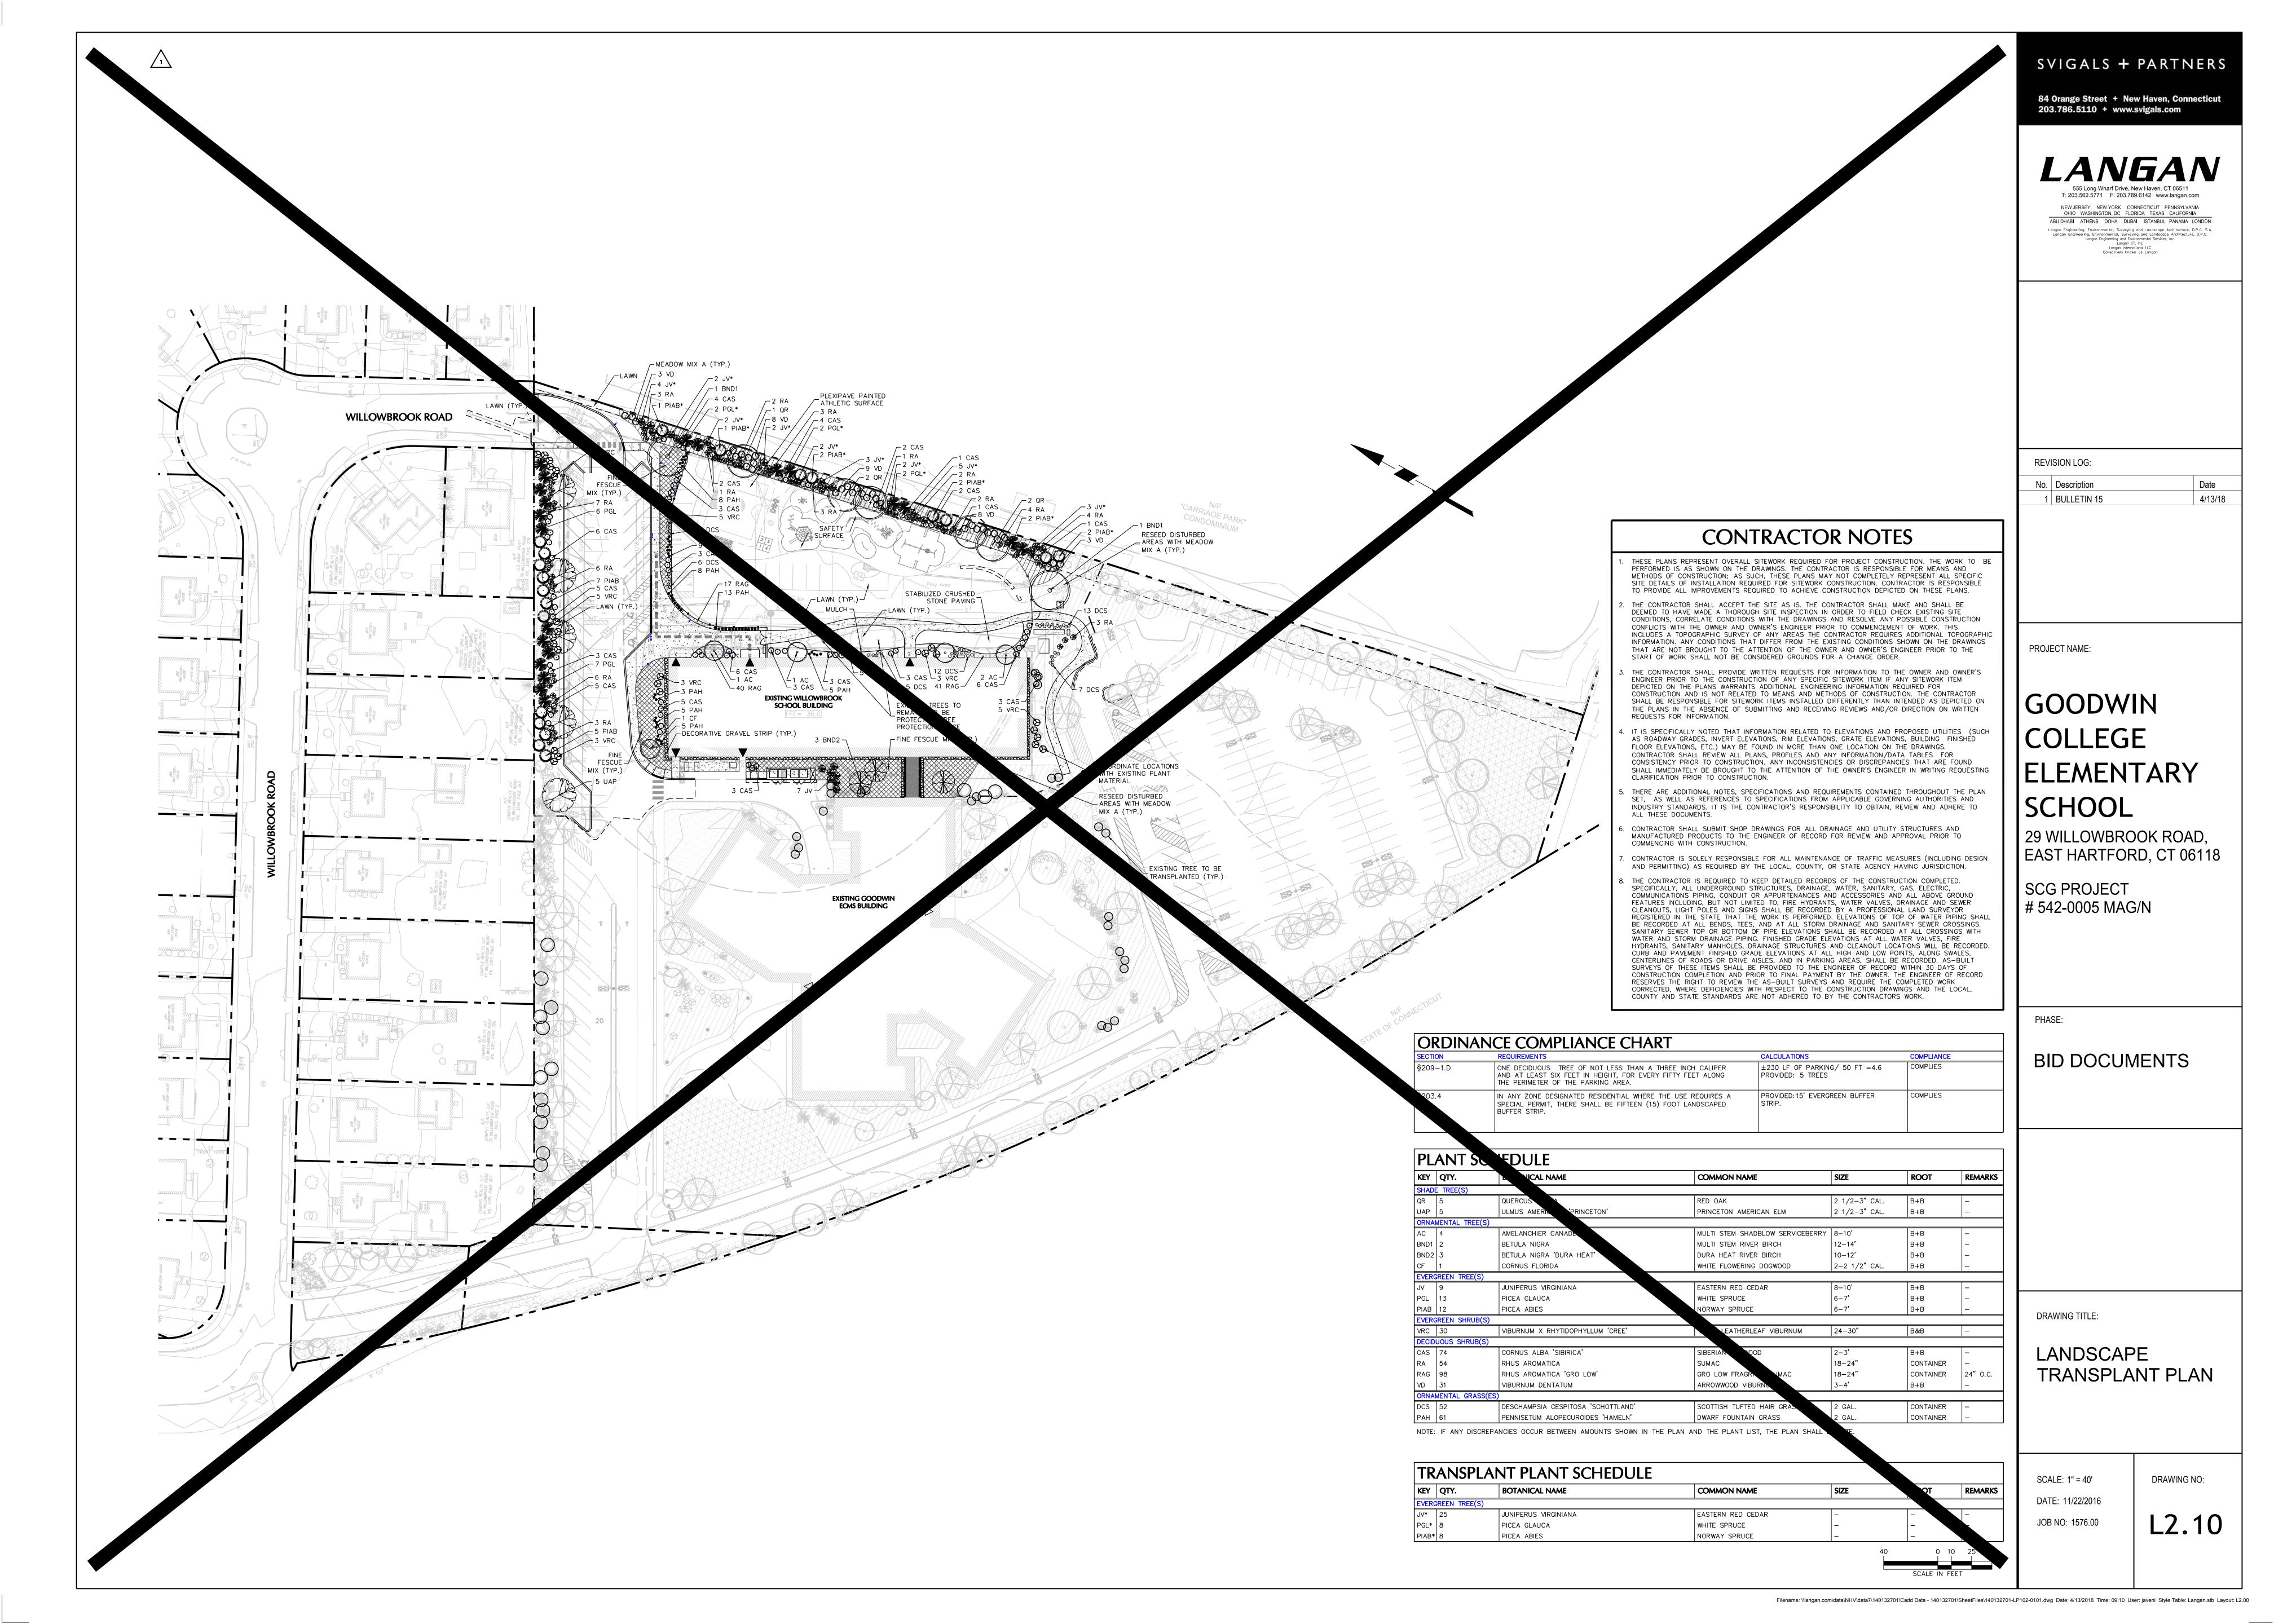
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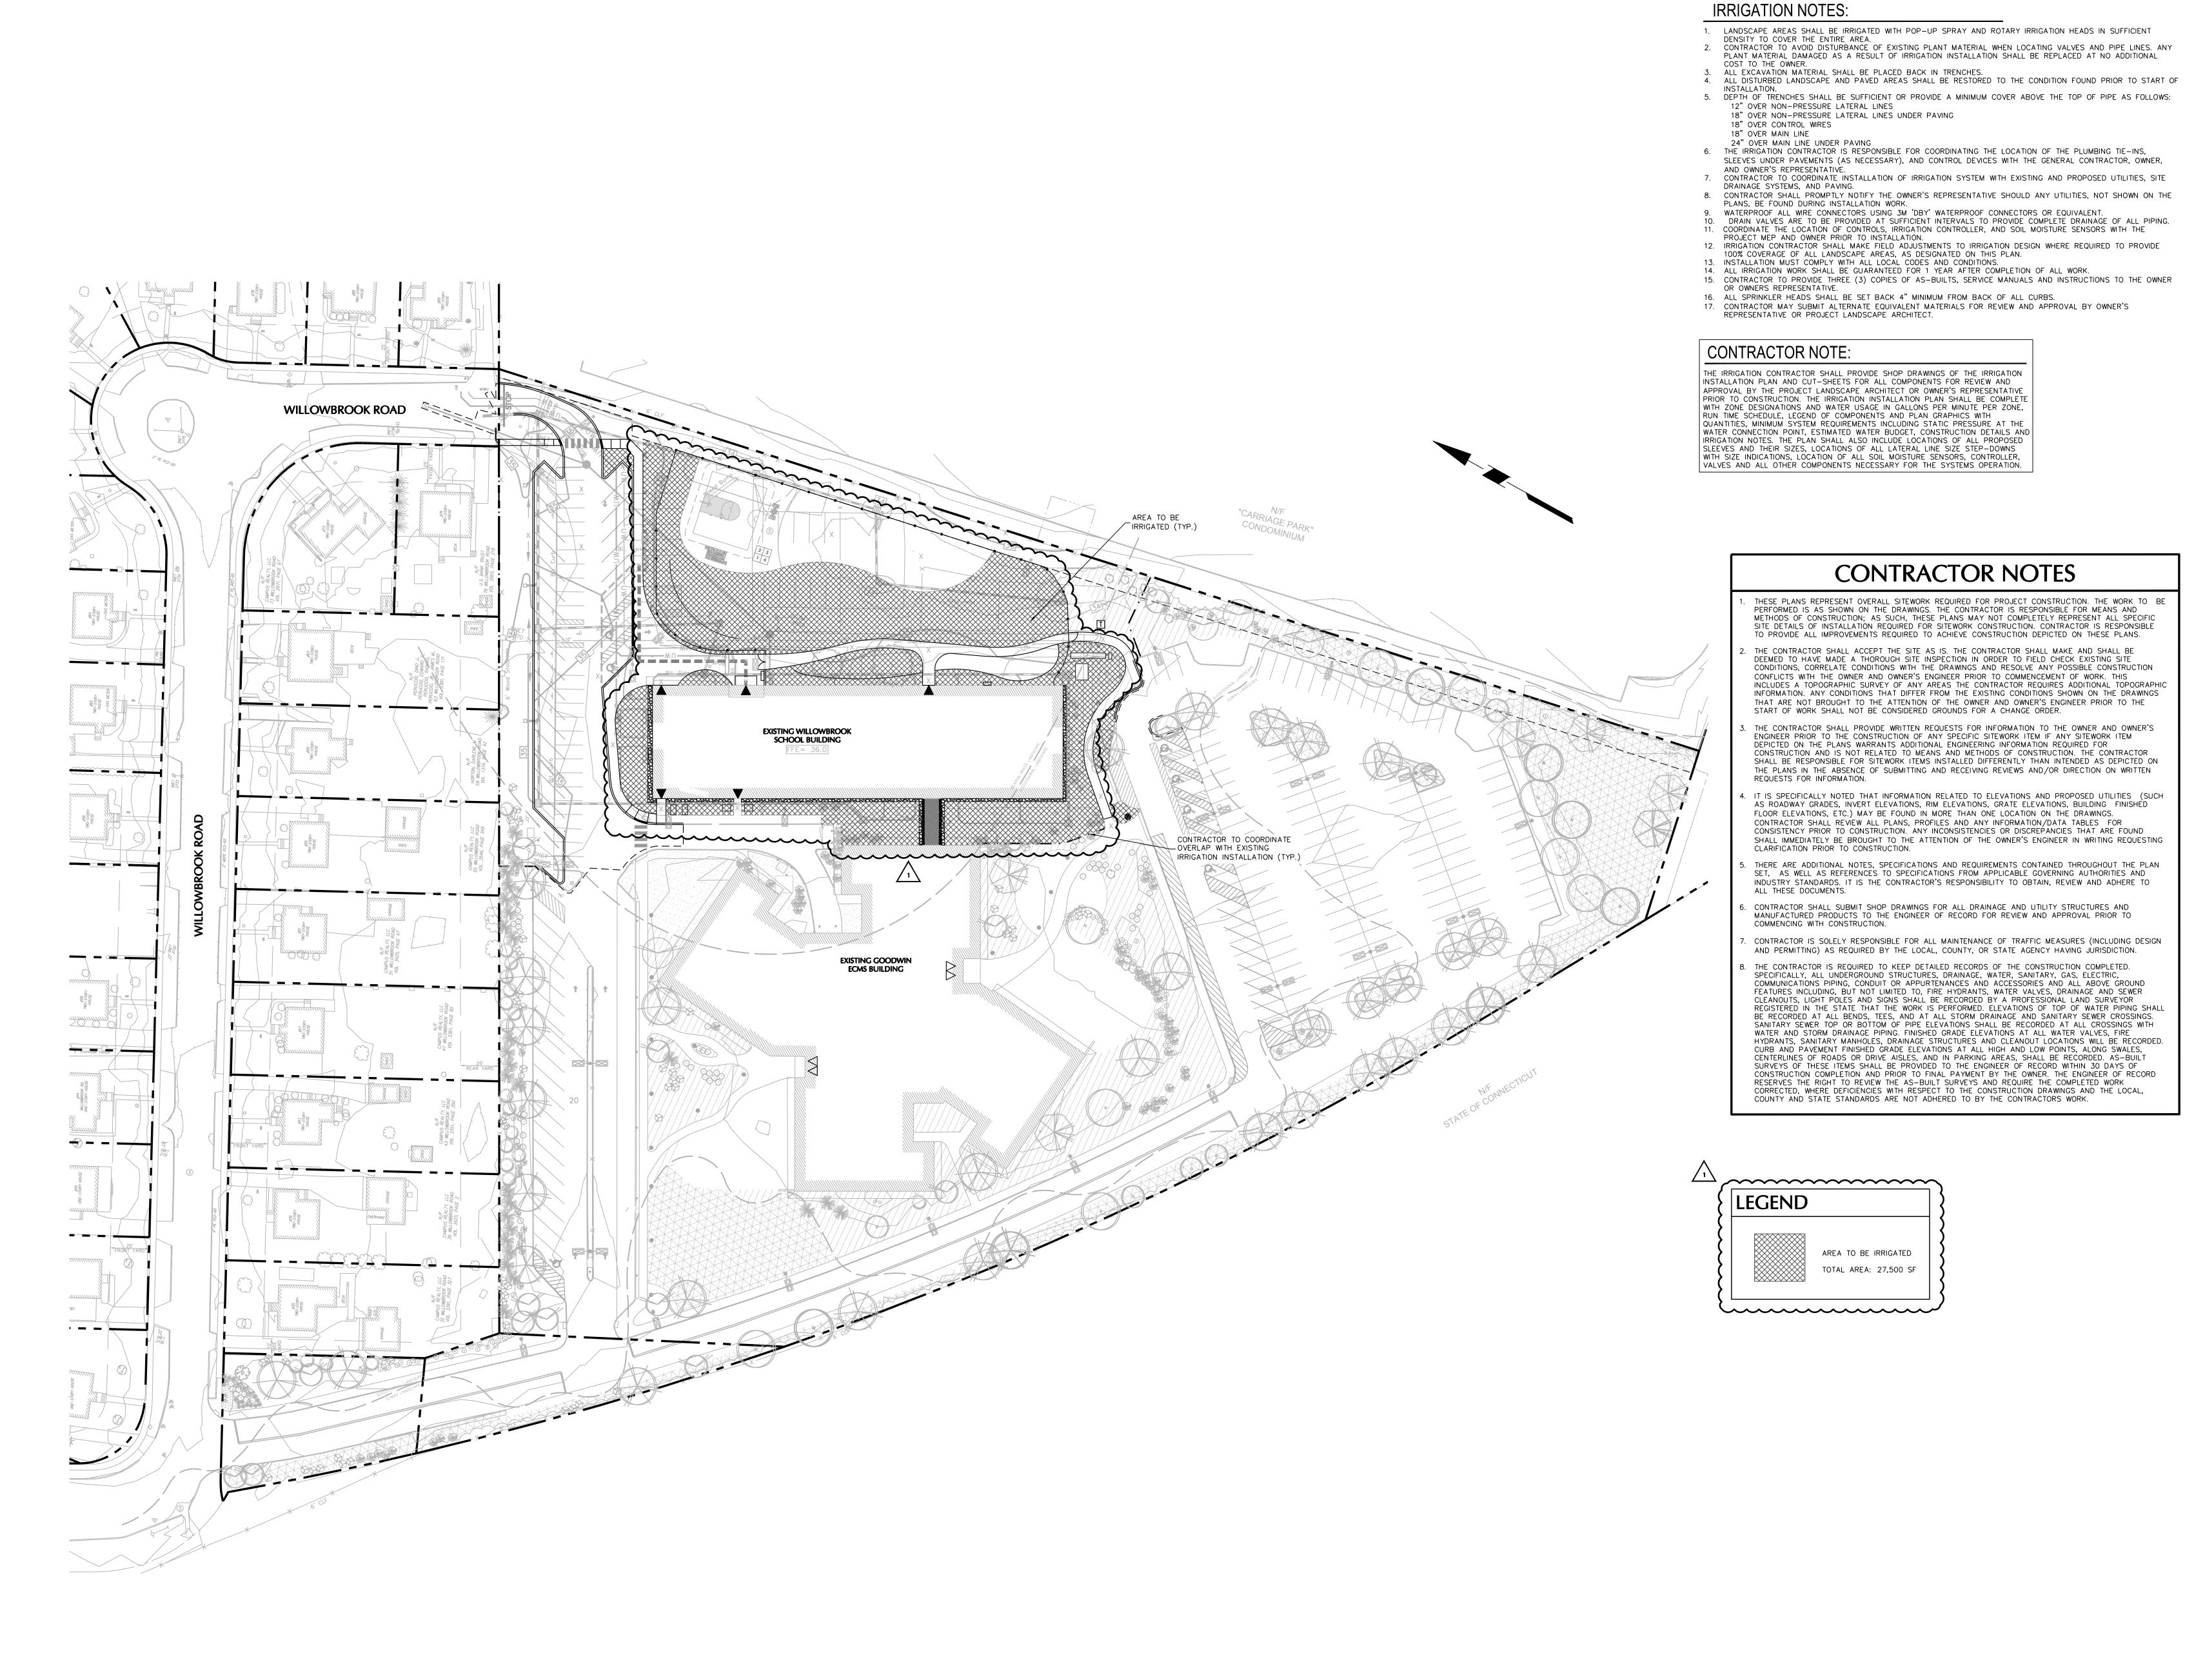
4/13/18

# ELEMENTARY

29 WILLOWBROOK ROAD,





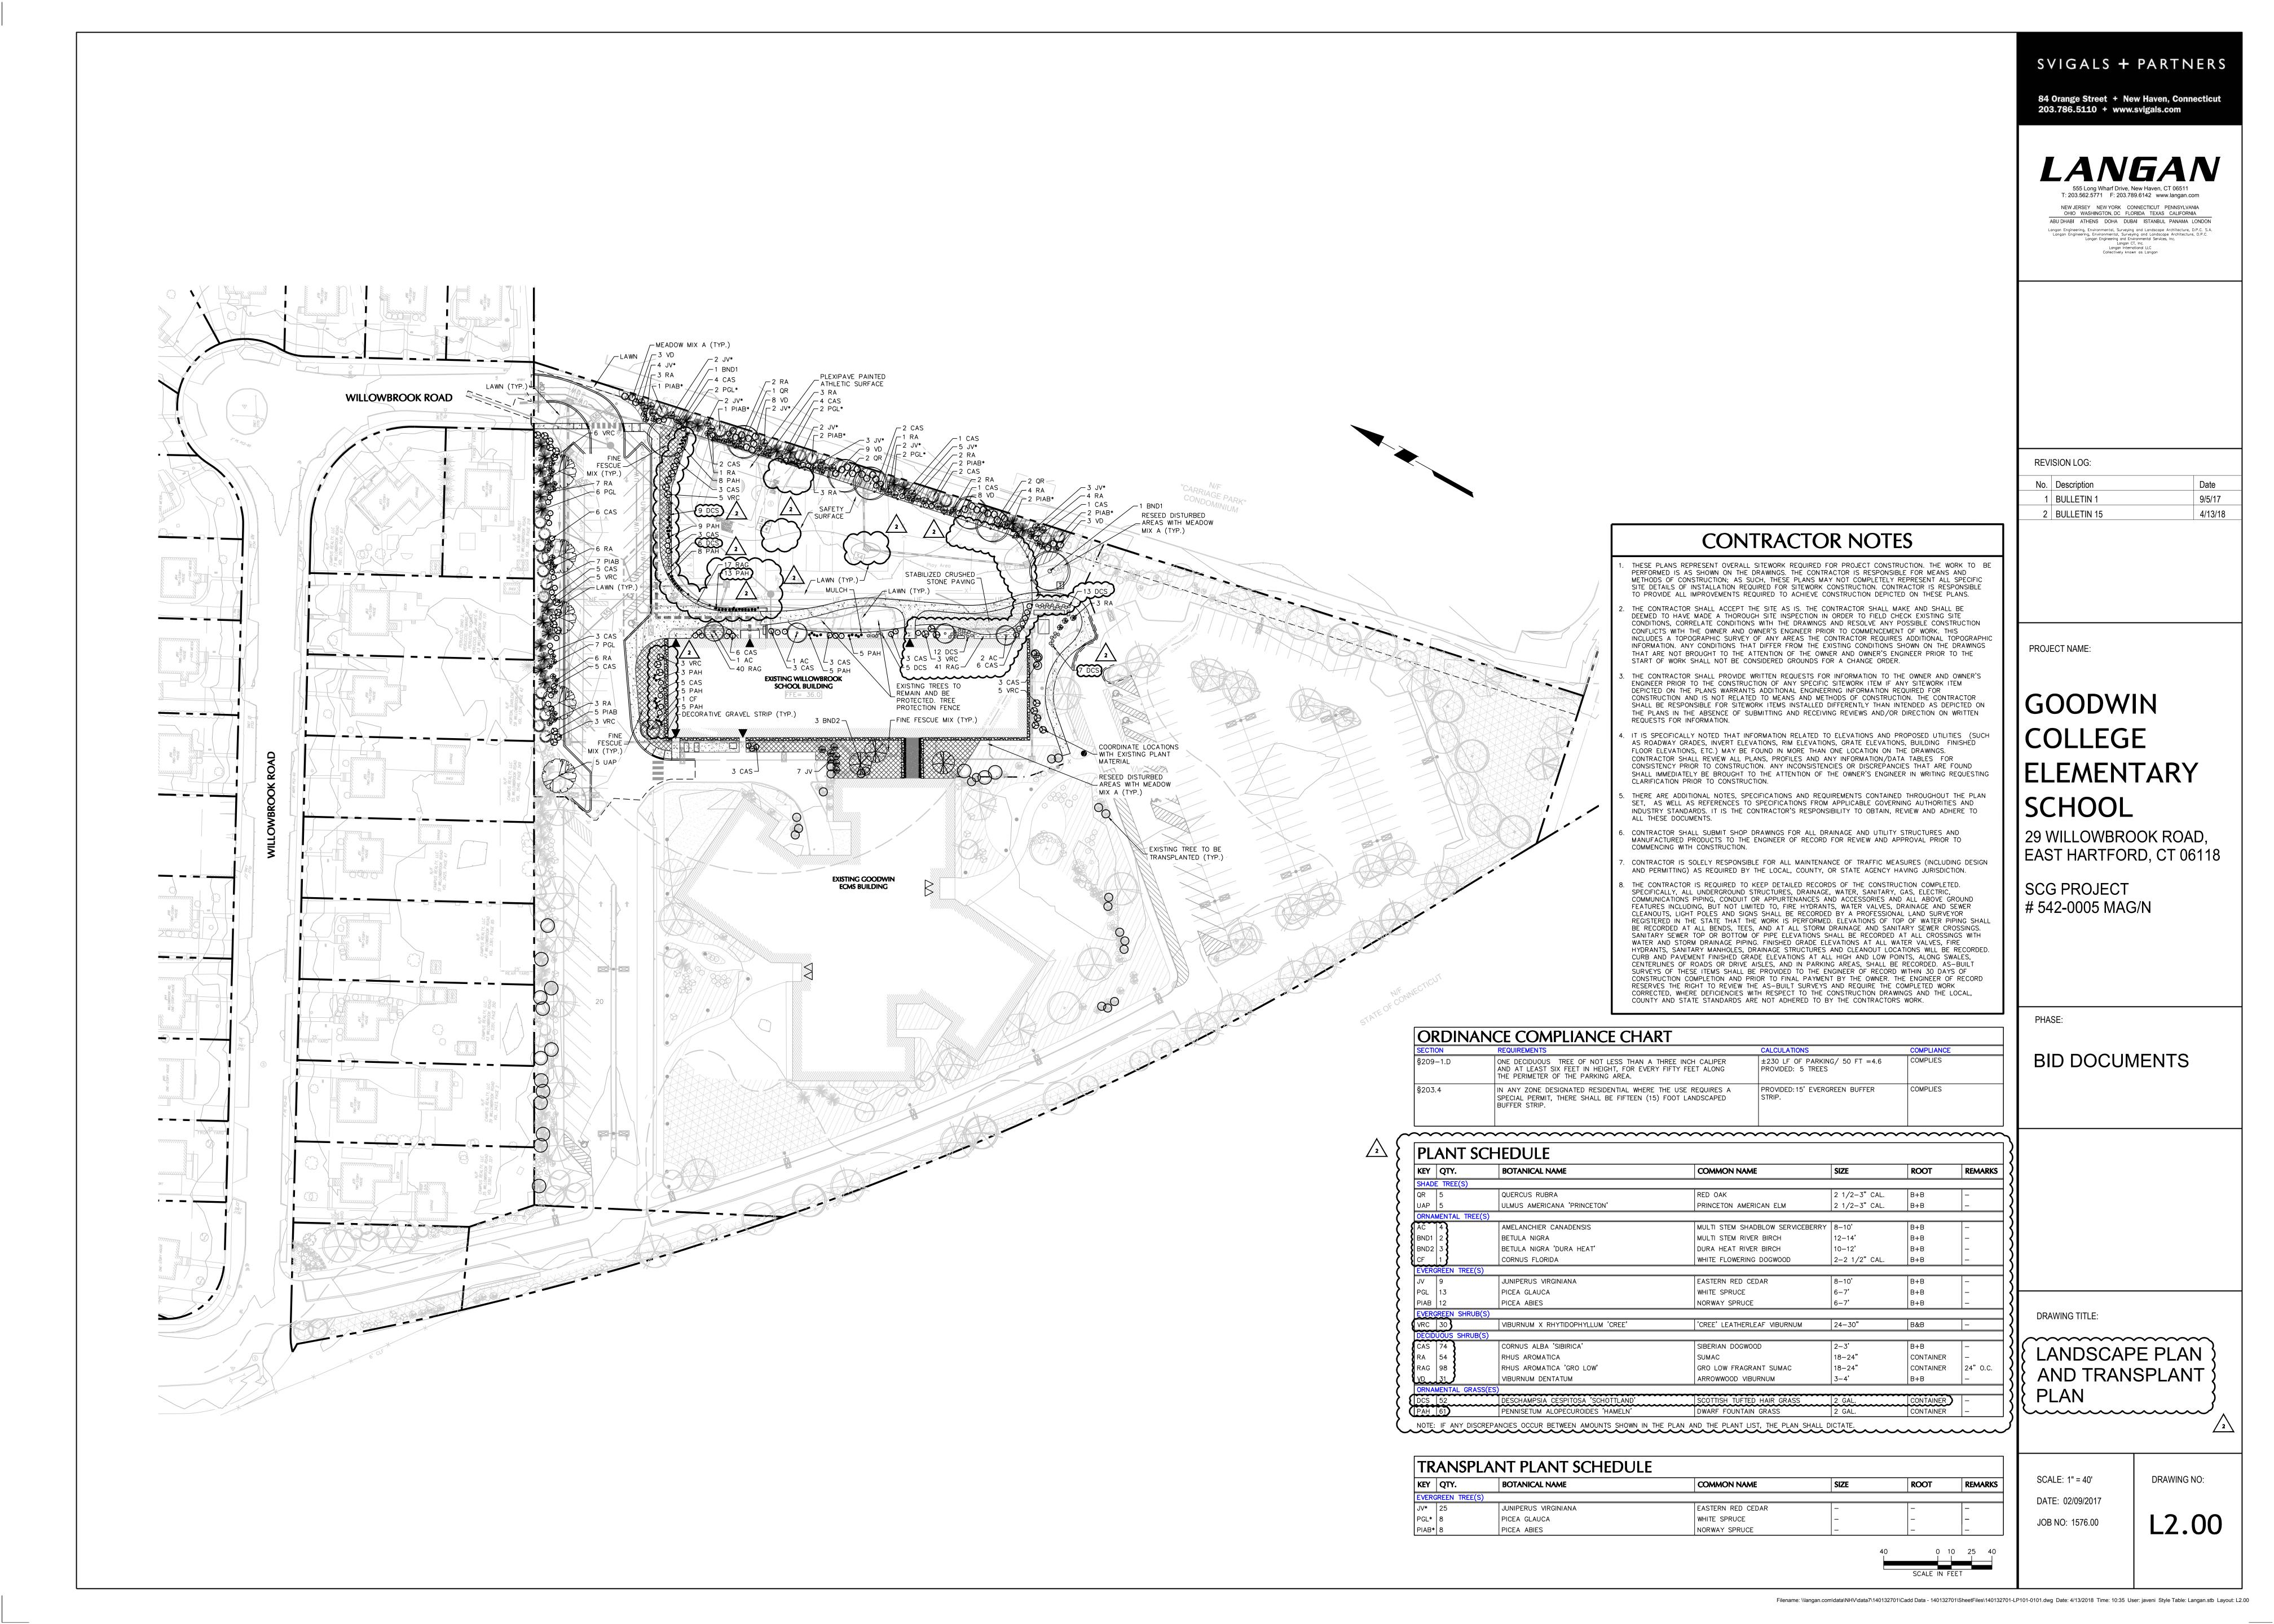

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REVISION LOG:

No.	Description	Date
1	BULLETIN 15	4/13/18

PROJECT NAME:

# GOODWIN COLLEGE ELEMENTARY SCHOOL

29 WILLOWBROOK ROAD, EAST HARTFORD, CT 06118

SCG PROJECT # 542-0005 MAG/N

PHASE:

BID DOCUMENTS

DRAWING TITLE:

IRRIGATED AREA PLAN

SCALE: 1"=40'

DATE: 02/09/2017

JOB NO: 1576.00

DRAWING NO: