
GOVERNOR NED LAMONT

DEPARTMENT OF ADMINISTRATIVE SERVICES JOSH GEBALLE COMMISSIONER

> **505 HUDSON STREET** LOWER GARAGE RAMP **RESTORATION PROJECT** HARTFORD, CONNECTICUT PROJECT NO. BI-2B-438

STATE OF CONNECTICUT

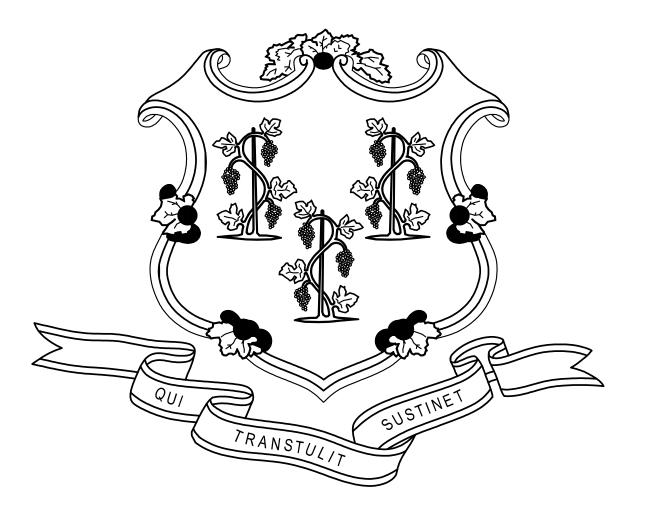


ENGINEER FREEMAN COMPANIES, LLC **36 JOHN STREET** HARTFORD, CT 06106 860-251-9550

CONTRACT DRAWINGS


NO.	TITLE
	COVER SHEET
B1.01	EXISTING CONDTIONS PLAN
B1.02	EXISTING CONDTIONS PLAN
C1.01	OVERALL SITE PLAN
C1.02	ENLARGED SITE PLAN
M0.01	ABREVIATIONS & SYMBOLS
MP1.01	DEMOLITION DRAWING
MP1.02	NEW WORK DRAWING
MP5.01	DETAILS AND SCHEDULES
MP5.02	DETAILS
MP6.01	FLOW DIAGRAMS
MP6.02	CONTROLS
E1.01	ELECTRICAL SITE PLAN


D.C.S BUILDING NUMBER 19064

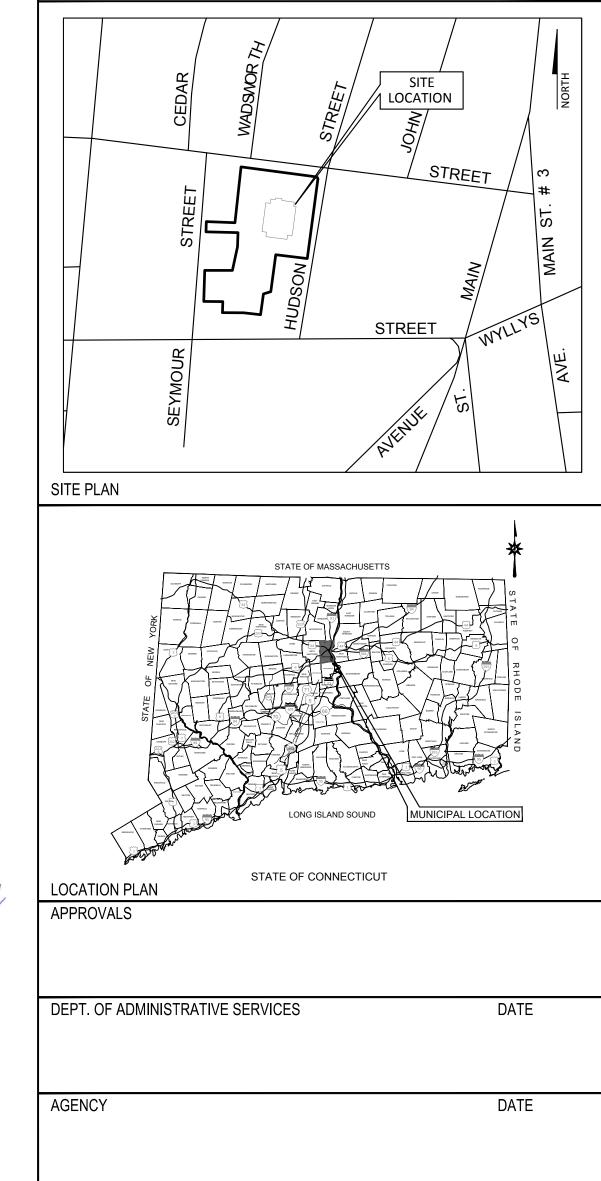






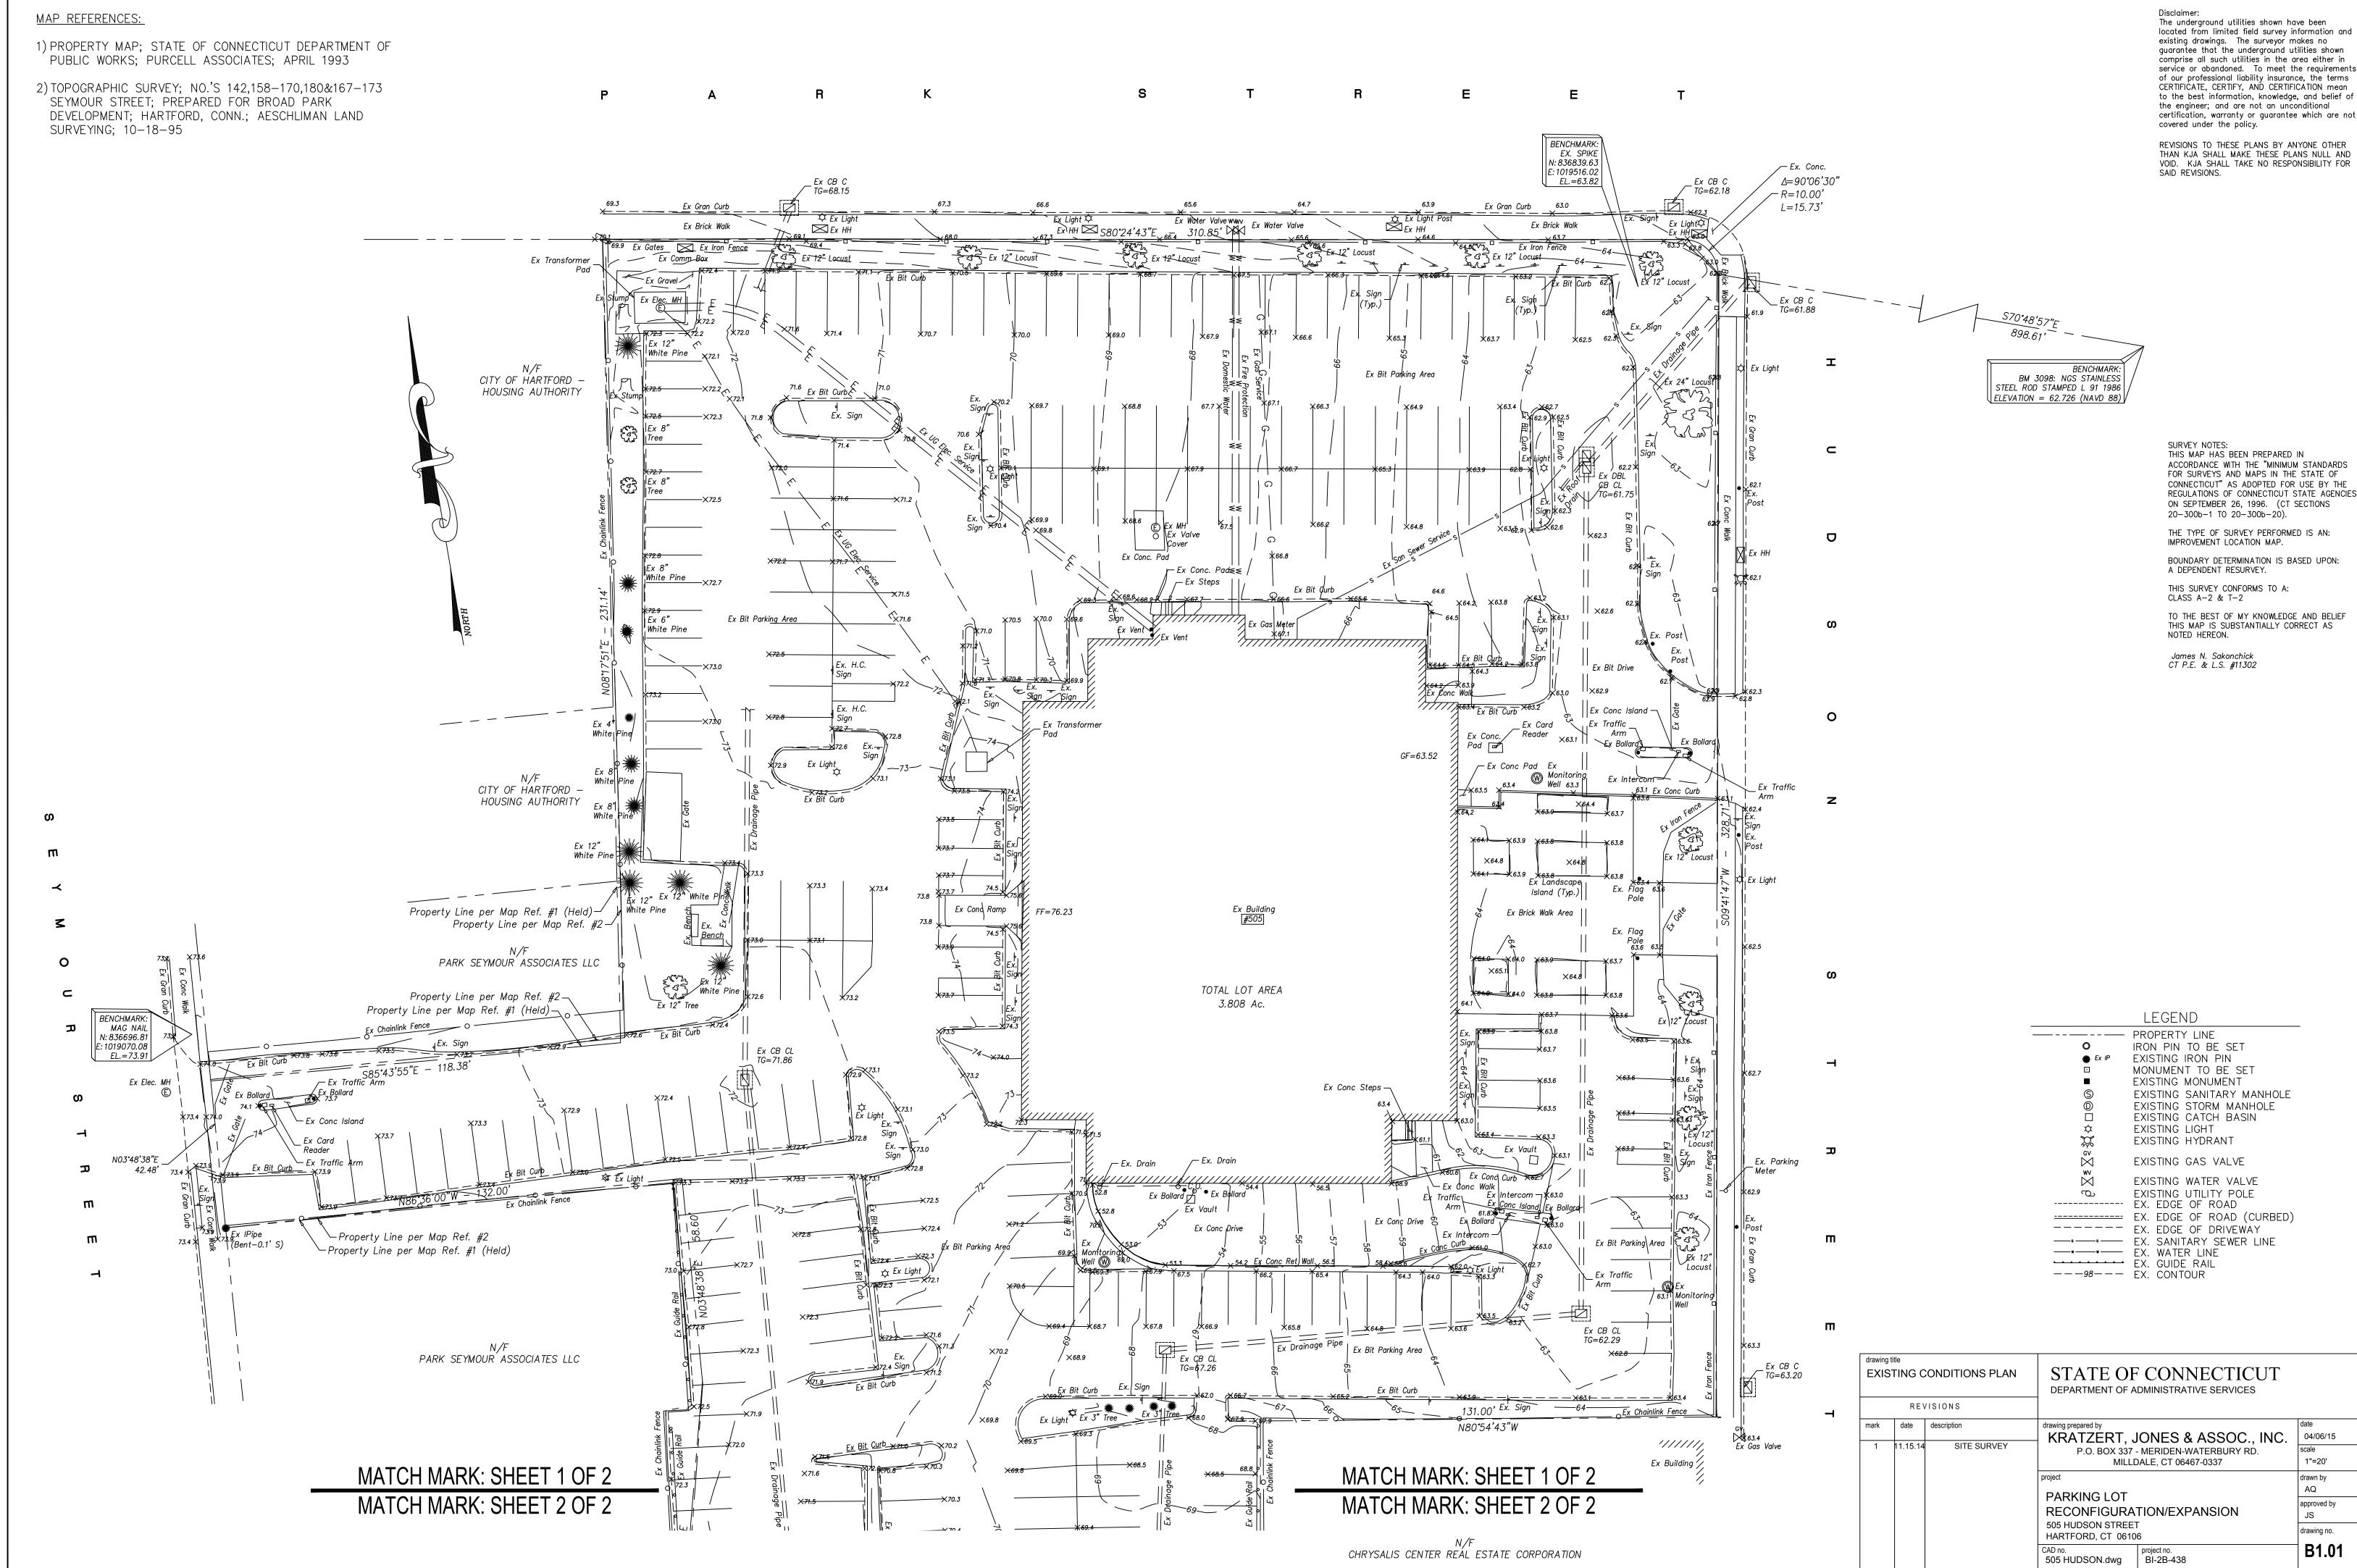

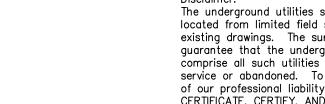

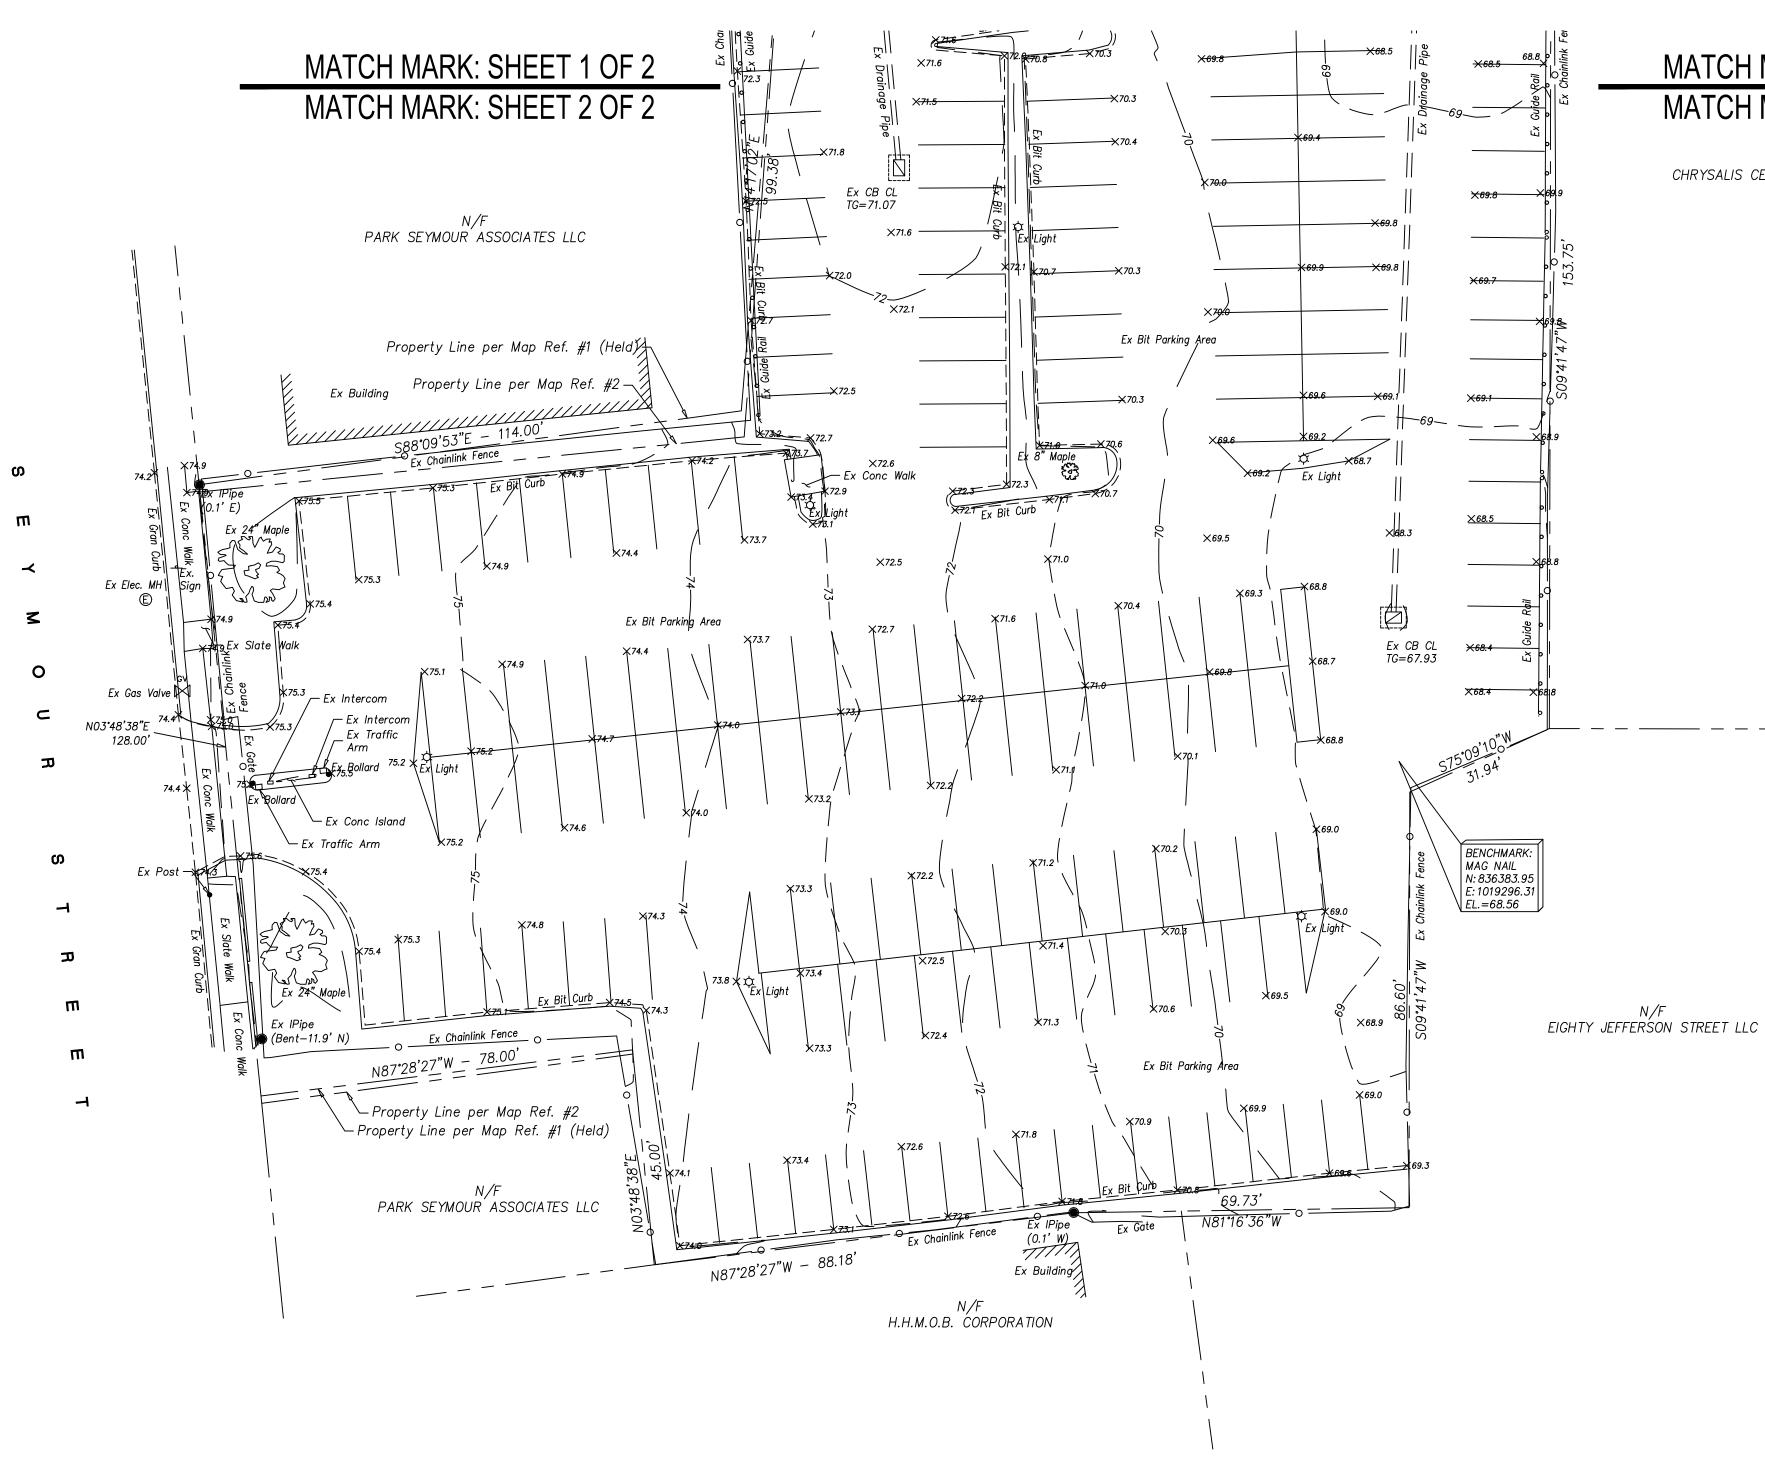

MATCH MARK: SHEET 1 OF 2 MATCH MARK: SHEET 2 OF 2

N/F CHRYSALIS CENTER REAL ESTATE CORPORATION

SURVEY NOTES: THIS MAP HAS BEEN PREPARED IN ACCORDANCE WITH THE "MINIMUM STANDARDS FOR SURVEYS AND MAPS IN THE STATE OF CONNECTICUT" AS ADOPTED FOR USE BY THE REGULATIONS OF CONNECTICUT STATE AGENCIES ON SEPTEMBER 26, 1996. (CT SECTIONS 20-300b-1 TO 20-300b-20).

Disclaimer: The underground utilities shown have been located from limited field survey information and existing drawings. The surveyor makes no

guarantee that the underground utilities shown comprise all such utilities in the area either in

service or abandoned. To meet the requirements of our professional liability insurance, the terms CERTIFICATE, CERTIFY, AND CERTIFICATION mean to the best information, knowledge, and belief of

the engineer; and are not an unconditional certification, warranty or guarantee which are not covered under the policy.

REVISIONS TO THESE PLANS BY ANYONE OTHER THAN KJA SHALL MAKE THESE PLANS NULL AND VOID. KJA SHALL TAKE NO RESPONSIBILITY FOR

SAID REVISIONS.

THE TYPE OF SURVEY PERFORMED IS AN: IMPROVEMENT LOCATION MAP.

BOUNDARY DETERMINATION IS BASED UPON: A DEPENDENT RESURVEY.

THIS SURVEY CONFORMS TO A: CLASS A-2 & T-2

TO THE BEST OF MY KNOWLEDGE AND BELIEF THIS MAP IS SUBSTANTIALLY CORRECT AS NOTED HEREON.


James N. Sakonchick CT P.E. & L.S. #11302

LEGEND

	PROPERTY LINE
0	IRON PIN TO BE SET
🔵 Ex IP	EXISTING IRON PIN
·	MONUMENT TO BE SET
	EXISTING MONUMENT
S	EXISTING SANITARY MANHOLE
Ō	EXISTING STORM MANHOLE
	EXISTING CATCH BASIN
¢	EXISTING LIGHT
ж	EXISTING HYDRANT
GV	
\bowtie	EXISTING GAS VALVE
wv	
\bowtie	EXISTING WATER VALVE
С	EXISTING UTILITY POLE
	EX. EDGE OF ROAD
<u></u>	EX. EDGE OF ROAD (CURBED)
	EX. EDGE OF DRIVEWAY
ss	EX. SANITARY SEWER LINE
ww	EX. WATER LINE
••••••	EX. GUIDE RAIL
98	EX. CONTOUR

drawing t EXIS	TING C			CONNECTICUT	
mark	date	description	drawing prepared by	ONES & ASSOC., INC.	date 04/06/15
1	11.15.14	SITE SURVEY	P.O. BOX 337 -	MERIDEN-WATERBURY RD. DALE, CT 06467-0337	scale 1"=20'
			project PARKING LOT		drawn by AQ
				TION/EXPANSION	approved by JS
			HARTFORD, CT 0610		drawing no. B1.02
			505 HUDSON.dwg	BI-2B-438	01.02



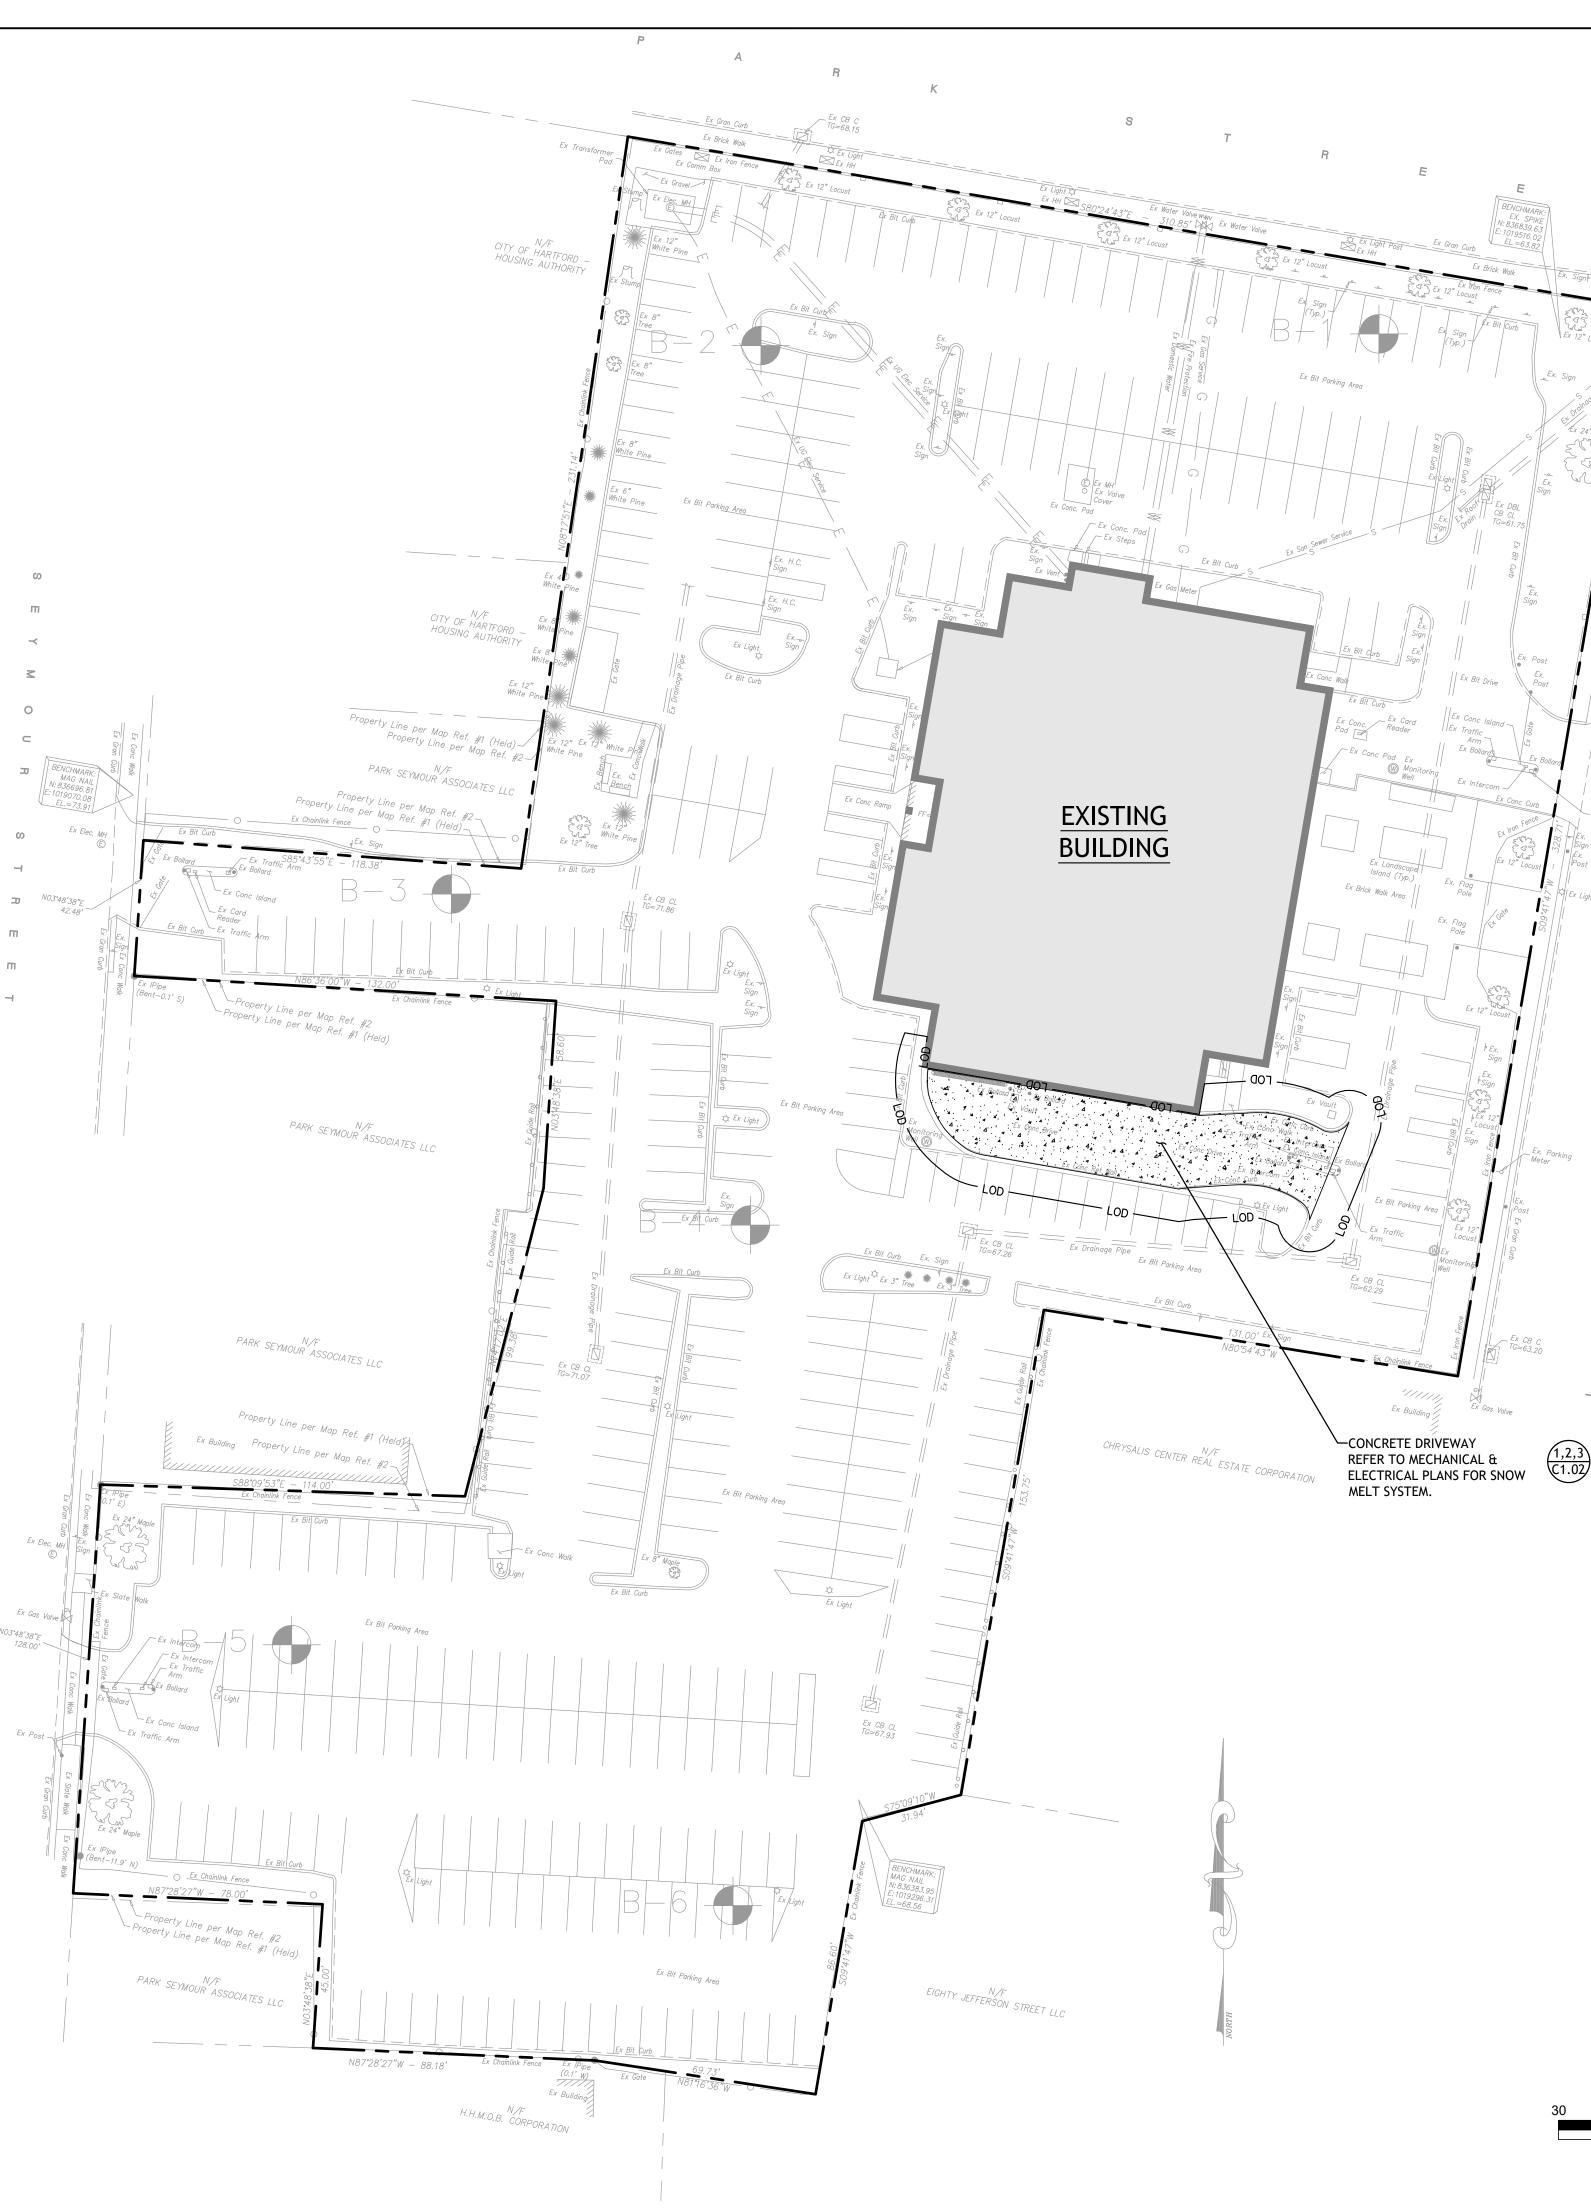



LEGEND

EXISTING BUILDING

LIMIT OF DISTURBANCE PROPERTY LINE/RIGHT OF WAY LINE



CONCRETE RAMP

SITE PLAN NOTES

- 1. ALL CONSTRUCTION SHALL COMPLY WITH PROJECT SPECIFICATION MANUAL; DAS STANDARDS AND THE HIERARCHY AS SPECIFIED IN DIV 01 OF THE SPECIFICATION. ALL CONSTRUCTION SHALL BE PERFORMED IN ACCORDANCE WITH ALL APPLICABLE OSHA, FEDERAL, STATE AND LOCAL REGULATIONS. 2. THE CONTRACTOR SHALL OBTAIN ALL CITY CONSTRUCTION PERMITS. THE CONTRACTOR SHALL POST ALL BONDS, PAY ALL FEES, PROVIDE PROOF OF INSURANCE AND PROVIDE TRAFFIC CONTROL NECESSARY FOR THIS WORK.
- 3. REFER TO PLANS, DETAILS AND PROJECT MANUAL FOR ADDITIONAL INFORMATION. THE CONTRACTOR SHALL VERIFY ALL SITE CONDITIONS IN THE FIELD AND CONTACT THE ENGINEER IF THERE ARE ANY QUESTIONS OR CONFLICTS REGARDING THE CONSTRUCTION DOCUMENTS AND/OR FIELD CONDITIONS SO THAT APPROPRIATE REVISIONS CAN BE MADE PRIOR TO BIDDING/CONSTRUCTION. ANY CONFLICT BETWEEN THE DRAWINGS AND SPECIFICATIONS SHALL BE CONFIRMED WITH THE OWNER'S CONSTRUCTION ADMINISTRATOR PRIOR TO CONSTRUCTION.
- 4. THE CONTRACTOR IS RESPONSIBLE FOR OBTAINING COPIES OF THE LATEST APPLICABLE STATE CODES AND FOLLOWING REGULATIONS AND RETAIN AT THE PROJECT SITE TO BE AVAILABLE FOR REFERENCE BY PARTIES WHO HAVE A REASONABLE NEED DURING SUBMITTALS, PLANNING, AND PROGRESS OF THE WORK, UNTIL SUBSTANTIAL COMPLETION.
- 5. THE CONTRACTOR SHALL SUBMIT SHOP DRAWINGS OF ALL PRODUCTS, MATERIALS PER PLANS AND SPECIFICATIONS TO THE OWNER AND ENGINEER FOR REVIEW AND APPROVAL PRIOR TO FABRICATION OR DELIVERY TO THE SITE. ALLOW A MINIMUM OF 14 WORKING DAYS FOR REVIEW. 6. SHOULD ANY UNKNOWN OR INCORRECTLY LOCATED EXISTING PIPING OR OTHER UTILITY BE UNCOVERED DURING EXCAVATION, CONSULT THE OWNER
- AND OWNER'S REPRESENTATIVE IMMEDIATELY FOR DIRECTIONS BEFORE PROCEEDING FURTHER WITH WORK IN THIS AREA. 7. DO NOT INTERRUPT EXISTING UTILITIES SERVICING FACILITIES OCCUPIED AND USED BY THE OWNER OR OTHERS DURING OCCUPIED HOURS, EXCEPT WHEN SUCH INTERRUPTIONS HAVE BEEN AUTHORIZED IN WRITING BY THE OWNER AND THE LOCAL MUNICIPALITY. INTERRUPTIONS SHALL ONLY OCCUR AFTER ACCEPTABLE TEMPORARY SERVICE HAS BEEN PROVIDED.
- 8. ALL SITE DIMENSIONS ARE REFERENCED TO THE FACE OF CURB OR EDGE OF PAVING AS APPLICABLE, UNLESS OTHERWISE NOTED.
- 9. THE CONTRACTOR SHALL PROVIDE AND MAINTAIN TRAFFIC CONTROL DEVICES FOR PROTECTION OF VEHICLES AND PEDESTRIANS CONSISTING OF DRUMS, BARRIERS, SIGNS, LIGHTS, FENCES, FLAGGERS AND UNIFORMED TRAFFIC OFFICERS AS REQUIRED OR AS ORDERED BY THE ENGINEER, AS REQUIRED BY THE LOCAL GOVERNING AUTHORITIES OR AS REQUIRED BY PERMIT STIPULATIONS.
- 10. THE CONTRACTOR SHALL ABIDE BY ALL OSHA, FEDERAL, STATE AND LOCAL REGULATIONS WHEN OPERATING CRANES, BOOMS, HOISTS, ETC. IN CLOSE PROXIMITY TO OVERHEAD ELECTRIC LINES. IF CONTRACTOR MUST OPERATE EQUIPMENT CLOSE TO ELECTRIC LINES, CONTACT POWER COMPANY TO MAKE ARRANGEMENTS FOR PROPER SAFEGUARDS. ANY UTILITY COMPANY FEES SHALL BE PAID FOR BY THE CONTRACTOR.
- 11. THE CONTRACTOR SHALL RESTORE ANY DRAINAGE STRUCTURE, PIPE, CONDUIT, PAVEMENT, CURBING, SIDEWALKS, LANDSCAPED AREAS OR SIGNAGE DISTURBED DURING CONSTRUCTION TO THEIR ORIGINAL CONDITION OR BETTER, AS APPROVED BY THE ENGINEER. 12. THE CONTRACTOR SHALL PROVIDE AS-BUILT RECORDS OF ALL CONSTRUCTION (INCLUDING UNDERGROUND UTILITIES) TO THE OWNER AT THE END OF
- CONSTRUCTION. 13. THE ENGINEER IS NOT RESPONSIBLE FOR SITE SAFETY MEASURES TO BE EMPLOYED DURING CONSTRUCTION. THE ENGINEER HAVE NO CONTRACTUAL DUTY TO CONTROL THE SAFEST METHODS OR MEANS OF THE WORK, JOB SITE RESPONSIBILITIES, SUPERVISION OF PERSONNEL OR TO SUPERVISE SAFETY AND DO NOT VOLUNTARILY ASSUME ANY SUCH DUTY OR RESPONSIBILITY.
- 14. THE CONTRACTOR SHALL COMPLY WITH OSHA CFR 29 PART 1926 FOR EXCAVATION TRENCHING AND TRENCH PROTECTION REQUIREMENTS. 15. EXISTING BOUNDARY AND TOPOGRAPHY IS BASED ON THE DRAWING TITLED "EXISTING CONDITIONS PLAN SCALE" DATED SEPTEMBER 10, 2014 BY
- KRATZERT, JONES & ASSOCIATES, INC. 16. INFORMATION ON EXISTING UTILITIES AND STORM DRAINAGE SYSTEMS HAS BEEN COMPILED FROM AVAILABLE INFORMATION INCLUDING UTILITY PROVIDER AND MUNICIPAL RECORD MAPS AND/OR FIELD SURVEY AND IS NOT GUARANTEED CORRECT OR COMPLETE. UTILITIES AND STORM DRAINAGE
- SYSTEMS ARE SHOWN TO ALERT THE CONTRACTOR TO THEIR PRESENCE AND THE CONTRACTOR IS SOLELY RESPONSIBLE FOR DETERMINING ACTUAL LOCATIONS AND ELEVATIONS OF ALL UTILITIES AND STORM DRAINAGE SYSTEMS INCLUDING SERVICES. PRIOR TO DEMOLITION OR CONSTRUCTION, THE CONTRACTOR SHALL CONTACT "CALL BEFORE YOU DIG" 72 HOURS BEFORE COMMENCEMENT OF WORK AT "(800) 922-4455" AND VERIFY ALL UTILITY AND STORM DRAINAGE SYSTEM LOCATIONS.
- 17. THE SITE IS CURRENTLY SERVICED BY PUBLIC WATER.
- 18. NO PART OF THE PROJECT PARCEL IS LOCATED WITHIN ANY FEMA DESIGNATED FLOOD HAZARD AREAS.
- 19. THERE ARE NO WETLANDS LOCATED ON THE SITE AS INDICATED BY NATIONAL WETLAND INVENTORY MAPPING.

drawing ti OVEF		SITE PLAN
	REV	VISIONS
mark	date	description
1	MAN KIS * PROTING	No. 23870

STATE OF CONNECTICUT DEPARTMENT OF ADMINISTRATIVE SERVICES

drawing prepared by FREEMAN COMPANIES, LLC 36 JOHN STREET HARTFORD, CT 06106

projec

02/20/2020 scale 1" = 30' drawn by MK approved by PAR drawing no. C1.01


SCALE IN FEET

GRAPHIC SCALE

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15

LOWER GARAGE RAMP RESTORATION 505 HUDSON STREET HARTFORD, CT 06106 CAD no. project no. BI-2B-438

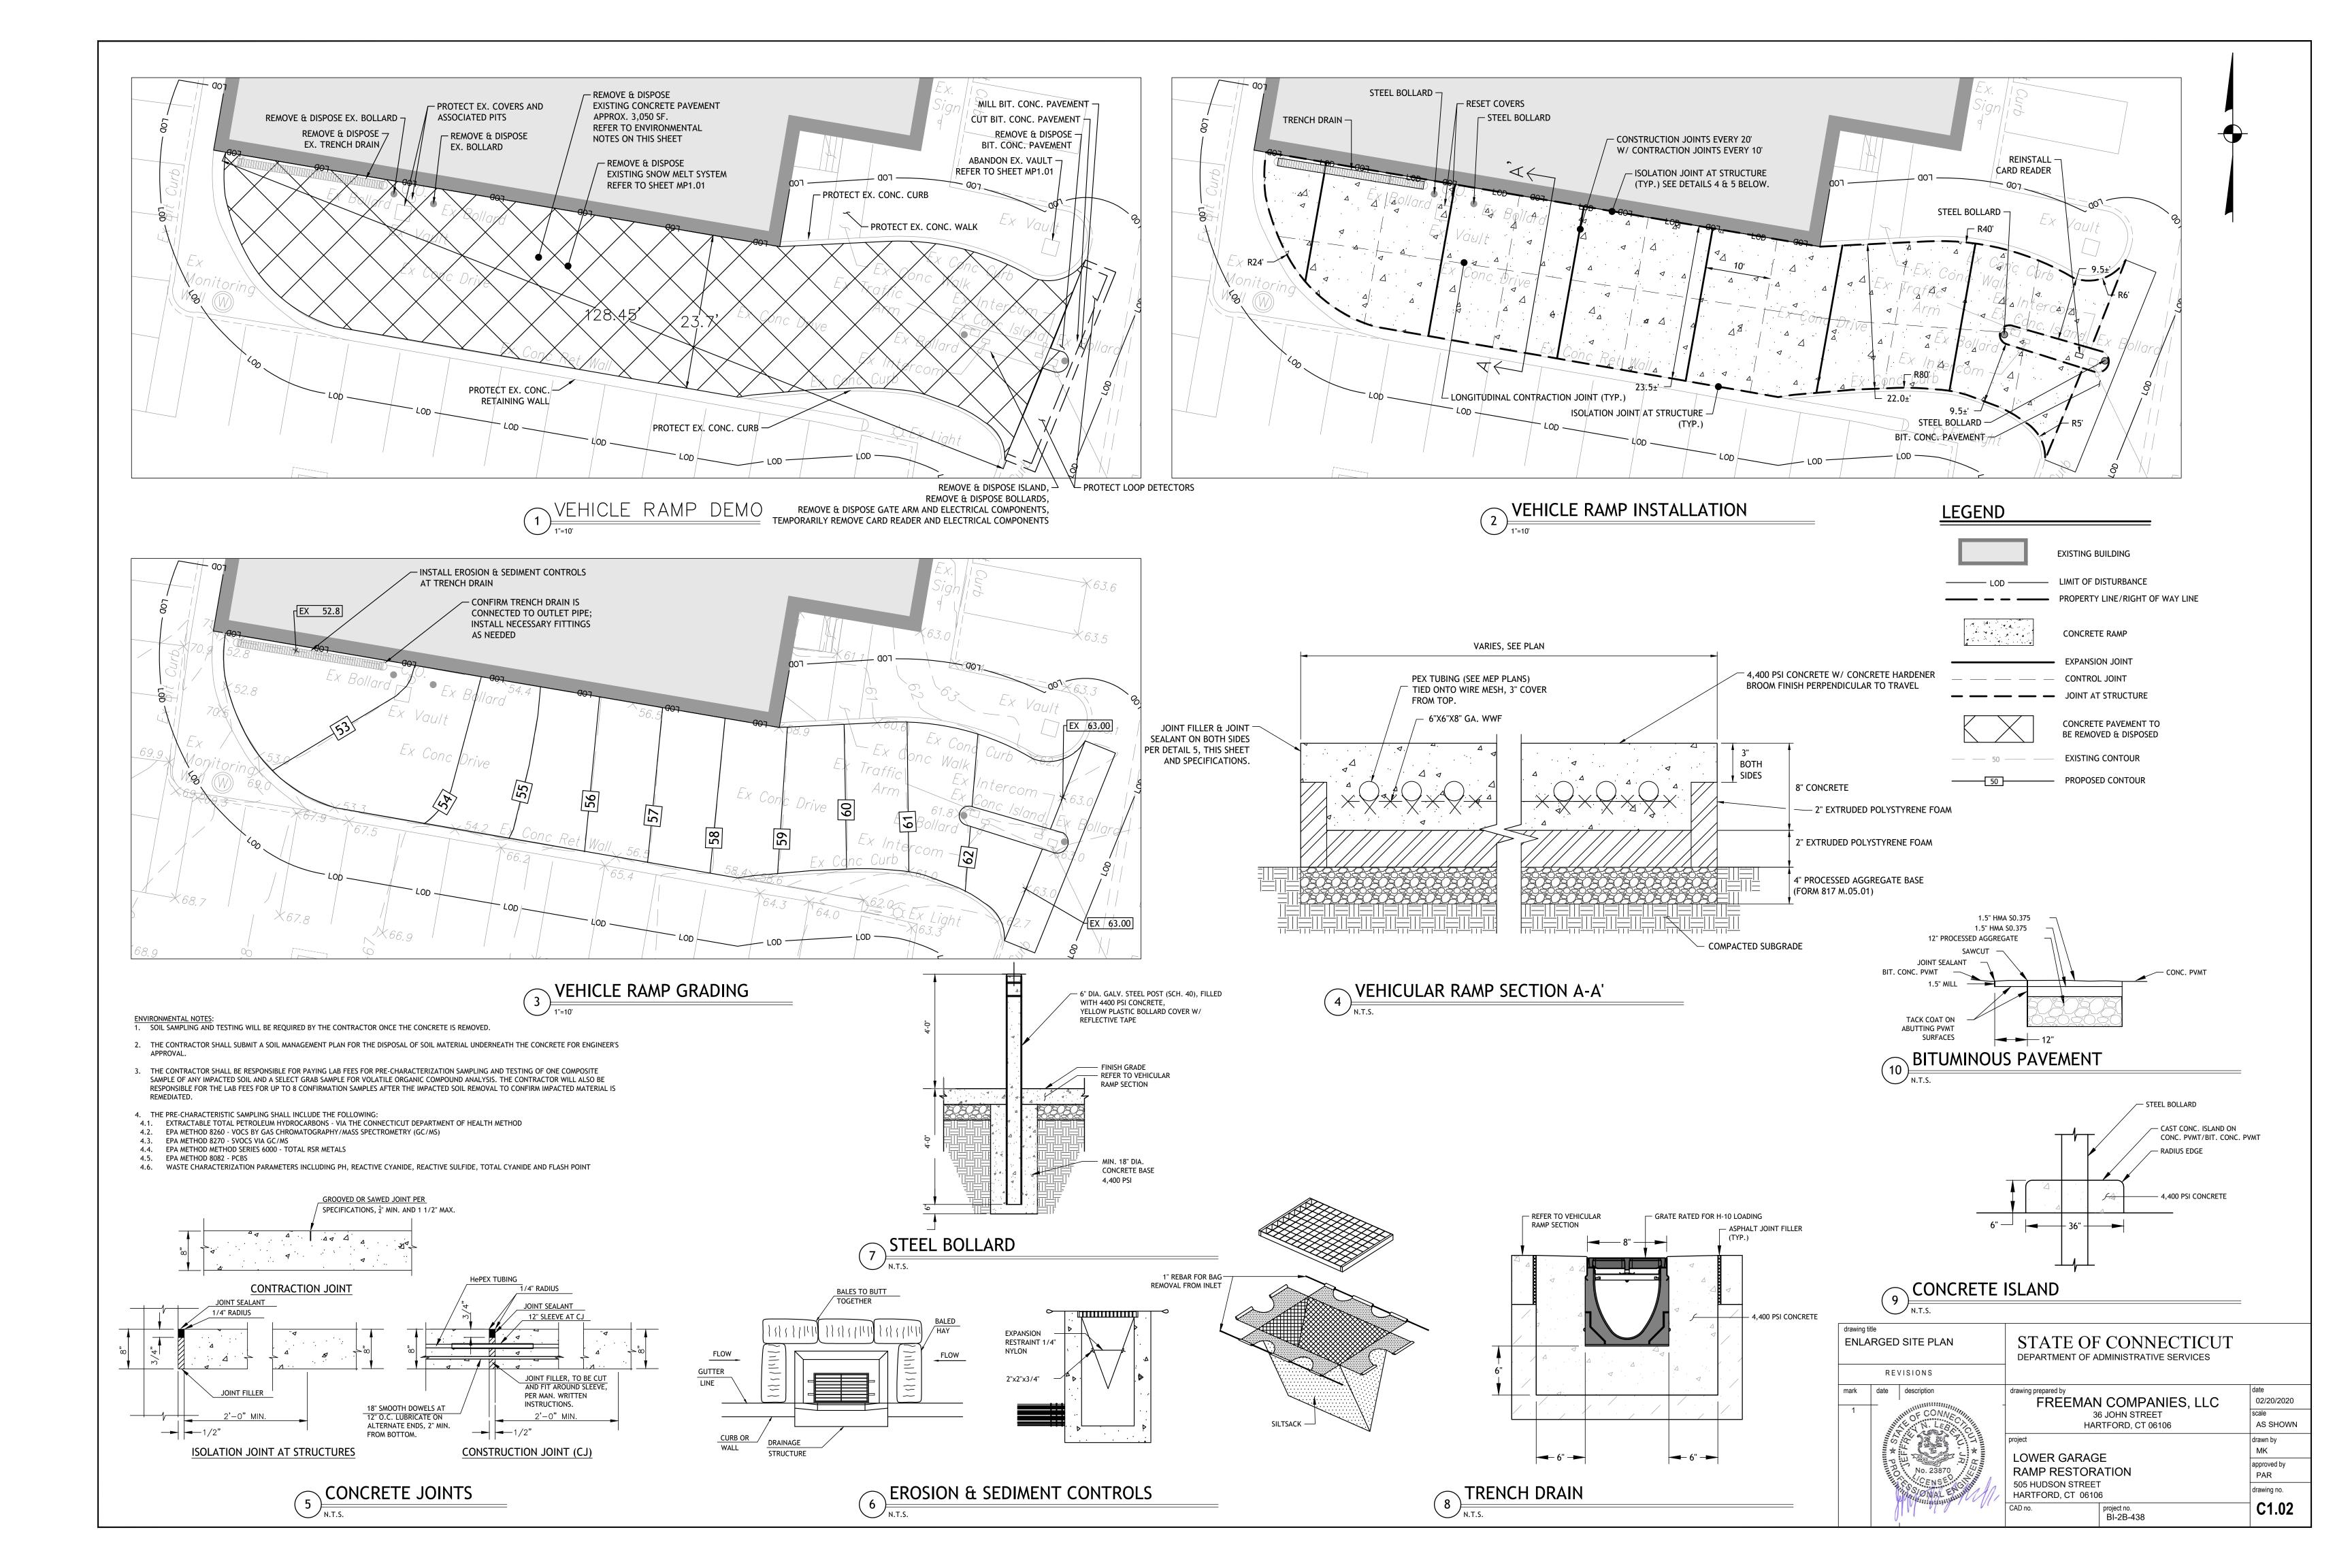

GENERAL DRAWING NOTES

1) THE INTENT OF THESE DOCUMENTS IS TO PROVIDE ENOUGH DETAIL FOR RESPONSIBLE CONTRACTORS TO PROVIDE COMPLETE MECHANICAL AND ELECTRICAL INSTALLATIONS. THE PLUMBING, HVAC AND ELECTRICAL SYSTEMS SHALL BE COMPLETE IN ALL RESPECTS: OPERATIONAL, TESTED, ADJUSTED, CALIBRATED, APPROVED BY AUTHORITIES HAVING JURISDICTION AND READY FOR BENEFICIAL USE BY THE OWNER

2) THE TRADES SHALL REVIEW ALL DRAWINGS BEFORE SUBMITTING BID. THE INFORMATION IS PROVIDED ON VARIOUS DRAWINGS, SCHEDULES AND SPECIFICATIONS (WHERE REQUIRED). INFORMATION ON THE EQUIPMENT PROVIDED DIRECTLY BY THE OWNER IS ALSO INCLUDED

3) THE INFORMATION PROVIDED IS DIAGRAMMATIC IN NATURE AND IS BASED ON DRAWINGS, SCHEDULES AND SITE INTERVIEWS CONDUCTED BY EBD ENGINEERING. THE DRAWINGS SHOW THE GENERAL ARRANGEMENT OF SYSTEMS AND ASSOCIATED PIPING AND ELECTRICAL INFRASTRUCTURE. THE INFORMATION IS PROVIDED TO DEPICT THE EXPECTED WORK UNDER THIS PROJECT. ANY MODIFICATION TO THE EQUIPMENT LAYOUT, REQUIRED FOR INSTALLATION, IS TO BE PERFORMED UNDER THE CONTRACT AT NO ADDITIONAL COST TO THE OWNER

4) PERFORM ALL WORK IN COMPLIANCE WITH APPLICABLE CODES, ORDINANCES AND THE REGULATORY AGENCIES HAVING JURISDICTION. IN CASES WHERE THE SCOPE OF WORK REQUESTS ITEMS IN EXCESS OF CODE, THE SCOPE OF WORK SHALL BE FOLLOWED

5) WHERE A CONFLICT OCCURS BETWEEN THE DOCUMENTS, IT SHALL BE BROUGHT TO THE ATTENTION OF THE ENGINEER

6) PROVIDE THE REQUIRED SLEEVES AND HANGERS FOR A SAFE, CODE COMPLIANT SYSTEM

7) REPAIR EXISTING CONCRETE FLOORS/HOUSEKEEPING PADS FOR NEW EQUIPMENT INSTALLATION

8) PROVIDE PIPING, DUCTWORK, VALVES AND VENTS, CONDUIT AND ALL OTHER ACCESSORIES AS REQUIRED FOR PROPER AND PROFESSIONAL SYSTEMS INSTALLATION

9) TEST AND BALANCE ALL MECHANICAL SYSTEMS AND PROVIDE BALANCING REPORT TO ENGINEER AND OWNER

10) PROVIDE THE REQUIRED CLEARANCES BETWEEN PIPING AND ELECTRICAL PANELS

11) ENSURE ADEQUATE SERVICE CLEARANCE FOR ALL EQUIPMENT AS REQUIRED BY THE MANUFACTURERS

12) PROVIDE PIPE EXPANSION COMPENSATION FOR THE VARIOUS PIPING SYSTEMS. SUBMIT ENGINEERED DETAILS FOR APPROVAL AND VERIFY INSTALLATION IS IN ACCORDANCE WITH CODE REQUIREMENTS. THE CONTRACTORS CONSULTING ENGINEER SHALL REVIEW THE INSTALLATION AND PROVIDE A WRITTEN REPORT ON THE FINDINGS

13) PROVIDE OFFSETS AND TRANSITIONS IN ALL PIPING, DUCTWORK AND CONDUIT, AS REQUIRED, FOR COORDINATION WITH BUILDING STEEL AND OTHER MECHANICAL/ELECTRICAL ITEMS

14) NO MECHANICAL OR ELECTRICAL SYSTEM COMPONENTS SHALL BE SUPPORTED FROM STRUCTURAL BASED FRAMES

15) THIS PROJECT INVOLVES THE REPLACEMENT/RENOVATION OF EXISTING EQUIPMENT WITHIN AN EXISTING FACILITY. BEFORE THE CONTRACTOR PROVIDES A BID, IT IS REQUIRED THAT THE CONTRACTOR VISIT THE SITE TO BECOME THOROUGHLY FAMILIAR WITH THE EXISTING CONDITIONS UNDER WHICH THE PROJECT WILL BE COMPLETED

16) CONTRACTOR SHALL BE HELD RESPONSIBLE FOR ASSUMPTIONS, OMISSIONS OR ERRORS MADE AS A RESULT OF FAILURE IN BECOMING FULLY FAMILIAR WITH THE EXISTING CONDITIONS

17) IT IS NOT THE INTENT OF THESE DRAWINGS TO SHOW EVERY DEVICE, APPURTENANCE, PIPE, ELECTRICAL FEEDER OR CONDUIT. SYSTEMS AND EQUIPMENT NOT BEING RE-USED SHALL BE DEMOLISHED AND REMOVED FROM THE SITE IN THEIR ENTIRETY, INCLUDING HANGERS, SUPPORT BASES, PADS, PIPES, CONDUITS, FEEDERS, INSULATION AND CONTROLS. EQUIPMENT, PIPING OR CONDUIT NOT UTILIZED SHALL NOT BE ABANDONED IN PLACE UNLESS SPECIFICALLY NOTED BY THE OWNER

18) RELOCATE EXISTING EQUIPMENT, DEVICES, PIPING, ELECTRICAL FEEDERS AND RELATED SYSTEMS AS REQUIRED FOR CONSTRUCTION. ALL RELOCATED EQUIPMENT SHALL BE PROTECTED AND SHALL BE REPLACED AND PLACED BACK INTO SERVICE POST CONSTRUCTION.

19) PROVIDE TEMPORARY CONNECTIONS AND SYSTEM MODIFICATIONS AS REQUIRED FOR CONSTRUCTION AND PHASING PURPOSES

20) PROVIDE BRANCH CIRCUITS FROM ELECTRICAL PANELS WITH SUFFICIENT CAPACITY AND SPACE FOR MISCELLANEOUS SYSTEMS

21) ALL NECESSARY STAGING AND MATERIAL STORAGE AREAS SHALL BE PROVIDED BY CONTRACTOR AND APPROVED BY OWNER

22) OBTAIN ALL NECESSARY PERMITS FOR COMPLETION OF THE WORK

23) PERFORM ALL NECESSARY CUTTING, PATCHING, REPAIRS AND PAINTING

24) ALL WORK TO BE PERFORMED WITH THE INTENT AS TO NOT TO INTERFERE WITH THE NORMAL OPERATION OF THE FACILITY. COORDINATE AS NECESSARY, SHUTDOWNS, WITH THE OWNER

25) PROVIDE ALL SUPPLEMENTAL STEEL AS NECESSARY TO TRANSFER LOADS OF EQUIPMENT AND PIPING TO THE BUILDING STRUCTURE

26) ALL INSTRUMENTS PROVIDED SHALL BE INSTALLED EASY ACCESS AND MAINTENANCE AND SHALL BE INSTALLED PER MANUFACTURERS REQUIREMENTS

27) PROVIDE VALVED DRAINS ON ALL WATER PIPING SYSTEM LOW POINTS

28) PROVIDE ALL MANUAL AIR VENTS WHERE REQUIRED TO VENT WATER SYSTEM HIGH POINTS

29) NO PIPING SMALLER THAN $\frac{3}{4}$ " EXCEPT AS NOTED

30) REPAIR, PATCH AND WATERPROOF ALL ROOF AND EXTERIOR WALL PENETRATIONS/MODIFICATIONS OR CUTTING OF ROOF TO ACCOMMODATE WORK UNDER THIS CONTRACT. ALL WORK SHALL BE PERFORMED SO AS TO NOT VOID ANY EXISTING WARRANTIES OR GUARANTEES

31) PRIME CONTRACTOR SHALL BE RESPONSIBLE FOR PROVIDING COORDINATED DRAWINGS BETWEEN ALL TRADES

32) ALL PIPING SYSTEMS SHALL BE THOROUGHLY CLEANED BEFORE PLACING IN OPERATION TO RID SYSTEM OF DIRT, PIPING COMPOUND, MILL SCALE, OIL AND ANY AND ALL OTHER MATERIAL FOREIGN TO WATER BEING CIRCULATED. THIS APPLIES EQUALLY AND ESPECIALLY TO SYSTEMS WHERE PHASES OR PORTIONS OF SYSTEMS ARE OPERATED DURING CONSTRUCTION

33) ALL DEMOLITION OR NEW WORK SHOWN ON THE PLAN, BUT NOT THE SCHEMATIC, OR VICE VERSA, SHALL BE INCLUDED AS IF SHOWN ON BOTH

34) ALL EQUIPMENT SHALL BE INSTALLED IN A NEAT, WORKMANLIKE MANNER, RECTILINEAR TO THE BUILDING STRUCTURE

COORDINATION WITH OTHER TRADES

1) ELECTRICAL, STRUCTURAL, SITE/CIVIL, CONTROLS

GENERAL SCOPE OF WORK

THE SCOPE OF WORK INCLUDED IN THESE DESIGN DOCUMENTS INCLUDE MODIFICATIONS FOR THE BUILDING LOCATED AT 505 HUDSON STREET IN HARTFORD, CT.

PROVIDE ALL LABOR AND MATERIALS AS REQUIRED FOR PROPER OPERATION OF NEW SYSTEMS. SCOPE OF WORK TO INCLUDE, BUT NOT BE LIMITED TO THE FOLLOWING: BASE BID PROJECT

THE BASE BID PROJECT SCOPE INCLUDES:

- 1) COORDINATION OF DEMOLITION AND REPLACEMENT OF EXISTING EQUIPMENT WITH STATE OF CONNECTICUT, BUILDING MANAGER AND GENERAL CONTRACTOR
- 2) LOCKOUT AND TAGOUT PROCEDURES PER STATE OF CONNECTICUT, BUILDING MANAGER AND CONTRACTOR EH&S GUIDELINES
- 3) CONTRACTOR SHALL RELOCATE ANY EXISTING PIPING OR EQUIPMENT, AS NECESSARY, TO ALLOW OR REMOVAL OF EXISTING AND INSTALLATION OF NEW EQUIPMENT
 4) CONTRACTOR SHALL PROVIDE TEMPORARY SUPPORTS, AS NECESSARY DURING CONSTRUCTION
- 5) CONTRACTOR SHALL SUPPLY ALL PROJECT RIGGING. RIGGER SHALL DETERMINE FINAL RIGGING PATH FOR ALL EQUIPMENT AND SHALL RETAIN A STRUCTURAL ENGINEER SUPPLEMENTARY STEEL AND SUPPORTS FOR THE BUILDING STRUCTURE AND SLABS AS REQUIRED TO RIG EXISTING EQUIPMENT OUT AND NEW EQUIPMENT INTO PLACE IF REQ
- 6) CONTRACTOR SHALL NOTE ANY PIPING THAT APPEARS TO BE DETERIORATED AND OF CONCERN TO THE CONTRACTOR SHALL BE BROUGHT TO THE ATTENTION OF THE STA
- 7) THE REMOVAL OF AN EXISTING HOT WATER TO GLYCOL, SNOW MELT PLATE AND FRAME HEAT EXCHANGER AND ASSOCIATED GLYCOL PUMP LOCATED IN A MECHANICALRO EXISTING PAD/FLOOR TO BE REPAIRED AND LEVEL TO ACCEPT NEW EQUIPMENT

8) DEMOLITION AND REMOVAL FROM SITE ALL DEMOLISHED MATERIAL

9) PROPER DISPOSAL OF ALL WATER AND GLYCOL

10) THE INSTALLATION OF A NEW, CONTRACTOR PROVIDED, SNOW MELT HEAT EXCHANGER (HOT WATER TO 40% PROPYLENE GLYCOL) ALONG WITH ASSOCIATED PIPING, INSU THERMOMETERS AND GAUGES

11) THE INSTALLATION OF A NEW CONTRACTOR SUPPLIED GLYCOL CIRCULATION PUMP, STRAINER, BALANCING VALVE, DISCONNECT, POWER WIRING, CONDUIT AND CONTROL

12) THE REPLACEMENT OF AN EXISTING ELECTRONIC HOT WATER CONTROL VALVE USED TO MAINTAIN THE DESIGN GLYCOL SUPPLY TEMPERATURE FROM THE PLATE AND FRA CONNECTED AND CONTROLLED VIA THE EXISTING TRANE BUILDING MANAGEMENT SYSTEM

13) THE REPLACEMENT OF THE TWO MAIN HOT WATER PUMP IMPELLERS

14) THE MODIFICATION OF THE EXISTING SNOW MELT GLYCOL SUPPLY AND RETURN PIPING TO ALLOW FOR A NEW SNOW MELT CIRCUIT FOR THE VEHICLE RAMP

15) COORDINATION WITH THE GENERAL CONTRACTOR FOR THE REMOVAL OF AN EXISTING CONCRETE VEHICLE RAMP LOCATED ON THE SOUTH SIDE OF THE BUILDING TO ALL MELT SYSTEM FOR THIS RAMP. THIS IS THE REPLACEMENT OF AN EXISTING SYSTEM AND AS SUCH, SOME EXISTINGCOMPONENTS ARE TO BE REUSED AND CONTRACTOR MUST EXISTING CONDITIONS

16) NEW, CONTRACTOR SUPPLIED PIPING, INSULATION, VALVES, FITTINGS, HANGERS, FLOOR AND WALL CORE BORING, SLEEVES, ETC FOR NEW 2" GLYCOL PIPING TO NEW SNO VEHICLE RAMP

17) THE INSTALLATION OF CONTRACTOR SUPPLIED 3/4" hepex tubing, staples, snow melt sensors, manifolds, balancing and shutoff values, thermometers and fully functional snow melt system

18) COORDINATION WITH THE GENERAL CONTRACTOR FOR PLACEMENT OF NEW VEHICLE RAMP CONCRETE PAD

19) MODIFICATION/EXPANSION OF THE EXISTING BUILDING MANAGEMENT SYSTEM (BMS) TO ALLOW FOR THE CONTROL OF THE NEW GLYCOL CIRCULATION PUMP BASED ON TI SUPPLIED SNOW MELT SENSOR

20) MODIFICATION/EXPANSION OF THE EXISTING BUILDING MANAGEMENT SYSTEM (BMS) TO ALLOW FOR MONITORING OF HOT WATER AND GLYCOL SUPPLY AND RETURN TEMP VEHICLE RAMP SNOW MELT SYSTEM

21) INSTALLATION OF CONTRACTOR SUPPLIED 40% GLYCOL SOLUTION FOR SNOW MELT SYSTEM

22) INSTALLATION OF CONTRACTOR SUPPLIED GLYCOL MAKEUP SYSTEM

23) ALL NEW PIPING SHALL BE MARKED AND LABELED FOR SERVICE AND FLOW DIRECTION

24) CONTRACTOR SHALL TEST, ADJUST, BALANCE AND COMMISSION THE HOT WATER AND GLYCOL SYSTEMS TO MATCH THE REQUIREMENTS OF THE BID DOCUMENTS. PLEASE A ADDITIONAL DETAILS

CODES LISTED BELOW APPLY TO ALL DRAWINGS FOR THIS PROJECT

1) 2015 INTERNATIONAL BUILDING CODE

- 2) 2015 INTERNATIONAL EXISTING BUILDING CODE
- 3) 2015 INTERNATIONAL PLUMBING CODE
- 4) 2015 INTERNATIONAL MECHANICAL CODE
- 5) 2015 INTERNATIONAL ENERGY CONSERVATION CODE

6) 2016 CONNECTICUT FIRE SAFETY CODE

7) 2015 CONNECTICUT FIRE PREVENTION CODE

8) 2009 ICC A117.1 ACCESSIBLE AND USABLE BUILDINGS AND FA


- 9) 2014 NATIONAL ELECTRIC CODE (NFPA 70)
- 10) 2016 ANSI/ASHRAE/IESNA STANDARD 90.1 ENERGY STANDA BUILDINGS EXCEPT LOW-RISE RESIDENTIAL BUILDINGS
- 11) NFPA 54 NATIONAL FUEL GAS CODE
- 12) GENERAL STATUES OF CONNECTICUT WITH SUPPLEMENTS

	PIPING SYMB	BOLS LIST	
	⊽	AUTOMATIC VENT	
	¥⊢	RELIEF VALVE	
	[BUTTERFLY VALVE	
	×	GATE VALVE	
		GLOBE VALVE	
R TO EVALUATE THE RIGGING PATH AND PROVIDE QUIRED		PLUG VALVE	
TATE, BUILDING MANAGER AND ENGINEER		BALL VALVE	
OOM IN THE LOWER LEVEL GARAGE AREA.	S	SOLENOID VALVE	
	K	PRESSURE REDUCING VALVE	
ULATION, VALVES, FITTINGS,	Ŕ	TWO-WAY CONTROL VALVE	
LS RAME HEAT EXCHANGER. NEW VALVE SHALL BE	š	THREE-WAY CONTROL VALVE	
	M	ELECTRIC ACTUATOR	
	Ŷ	PNEUMATIC ACTUATOR	
LOW FOR THE INSTALLATION OF A NEW SNOW I TAKE CARE TO REVIEW DRAWINGS AND	<u>N</u>	CHECK VALVE	
NOW MELT CIRCUITS FOR	K _{Ay} I	STRAINER WITH VALVE	
ND PRESSURE GAUGES FOR		BASKET STRAINER	
THE FEEDBACK FROM THE CONTRACTOR	\otimes	FLOOR DRAIN	
IPERATURES FOR THE		ORIFICE PLATE	
	D	REDUCER	
	— —	DIRECTION OF FLOW	
ALSO REFER TO SPECIFICATIONS FOR		UNION	
	· <u>+++++++</u>	EQUIPMENT OR PIPING DEMOLI	TION
		BLIND FLANGE	
ACILITIES	T	STEAM TRAP	
DARD FOR		CONNECTION POINT	
		PRESSURE GAUGE	
8		THERMOMETER	
		FLEXIBLE CONNECTOR	
	Π	TEMPERATURE TRANSMITTER	
	PT	PRESSURE TRANSMITTER	
		DIFF. PRESSURE TRANSMITTER	
		FLOW METER	
		STATE OF CONNECTION	TT
	IONS & SYMBOLS	STATE OF CONNECTICU DEPARTMENT OF ADMINISTRATIVE SERVICES	1
	description	drawing prepared by EBD ENGINEERING	date 02/20/2020 scale
	HILL CORV S. 460. C.	31-33 NORTH MAIN STREET MARLBOROUGH, CT 06447 project	N/A drawn by
	S + PR 0020370 CENSED	PARKING LOT RECONFIGURATION/ EXPANSION PROJECT 505 HUDSON STREET	GSH approved by GSH drawing no.


project no. BI-2B-386


HARTFORD, CT


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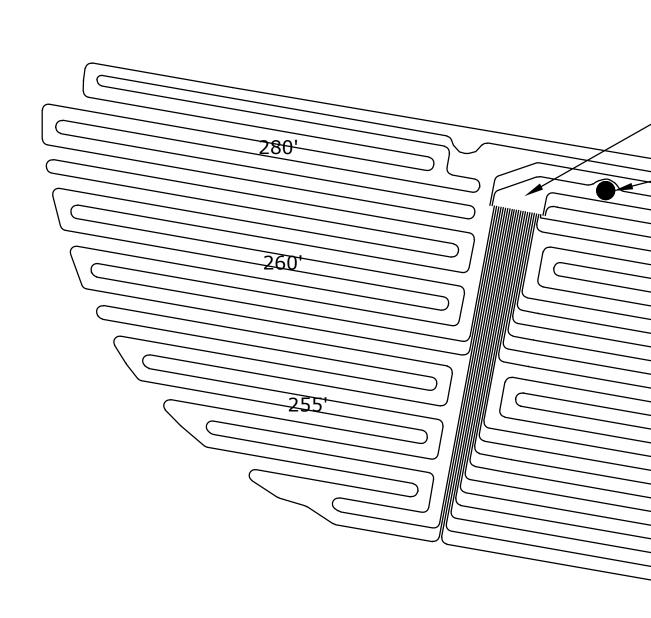
SCALE: 1/8" =1'-0"

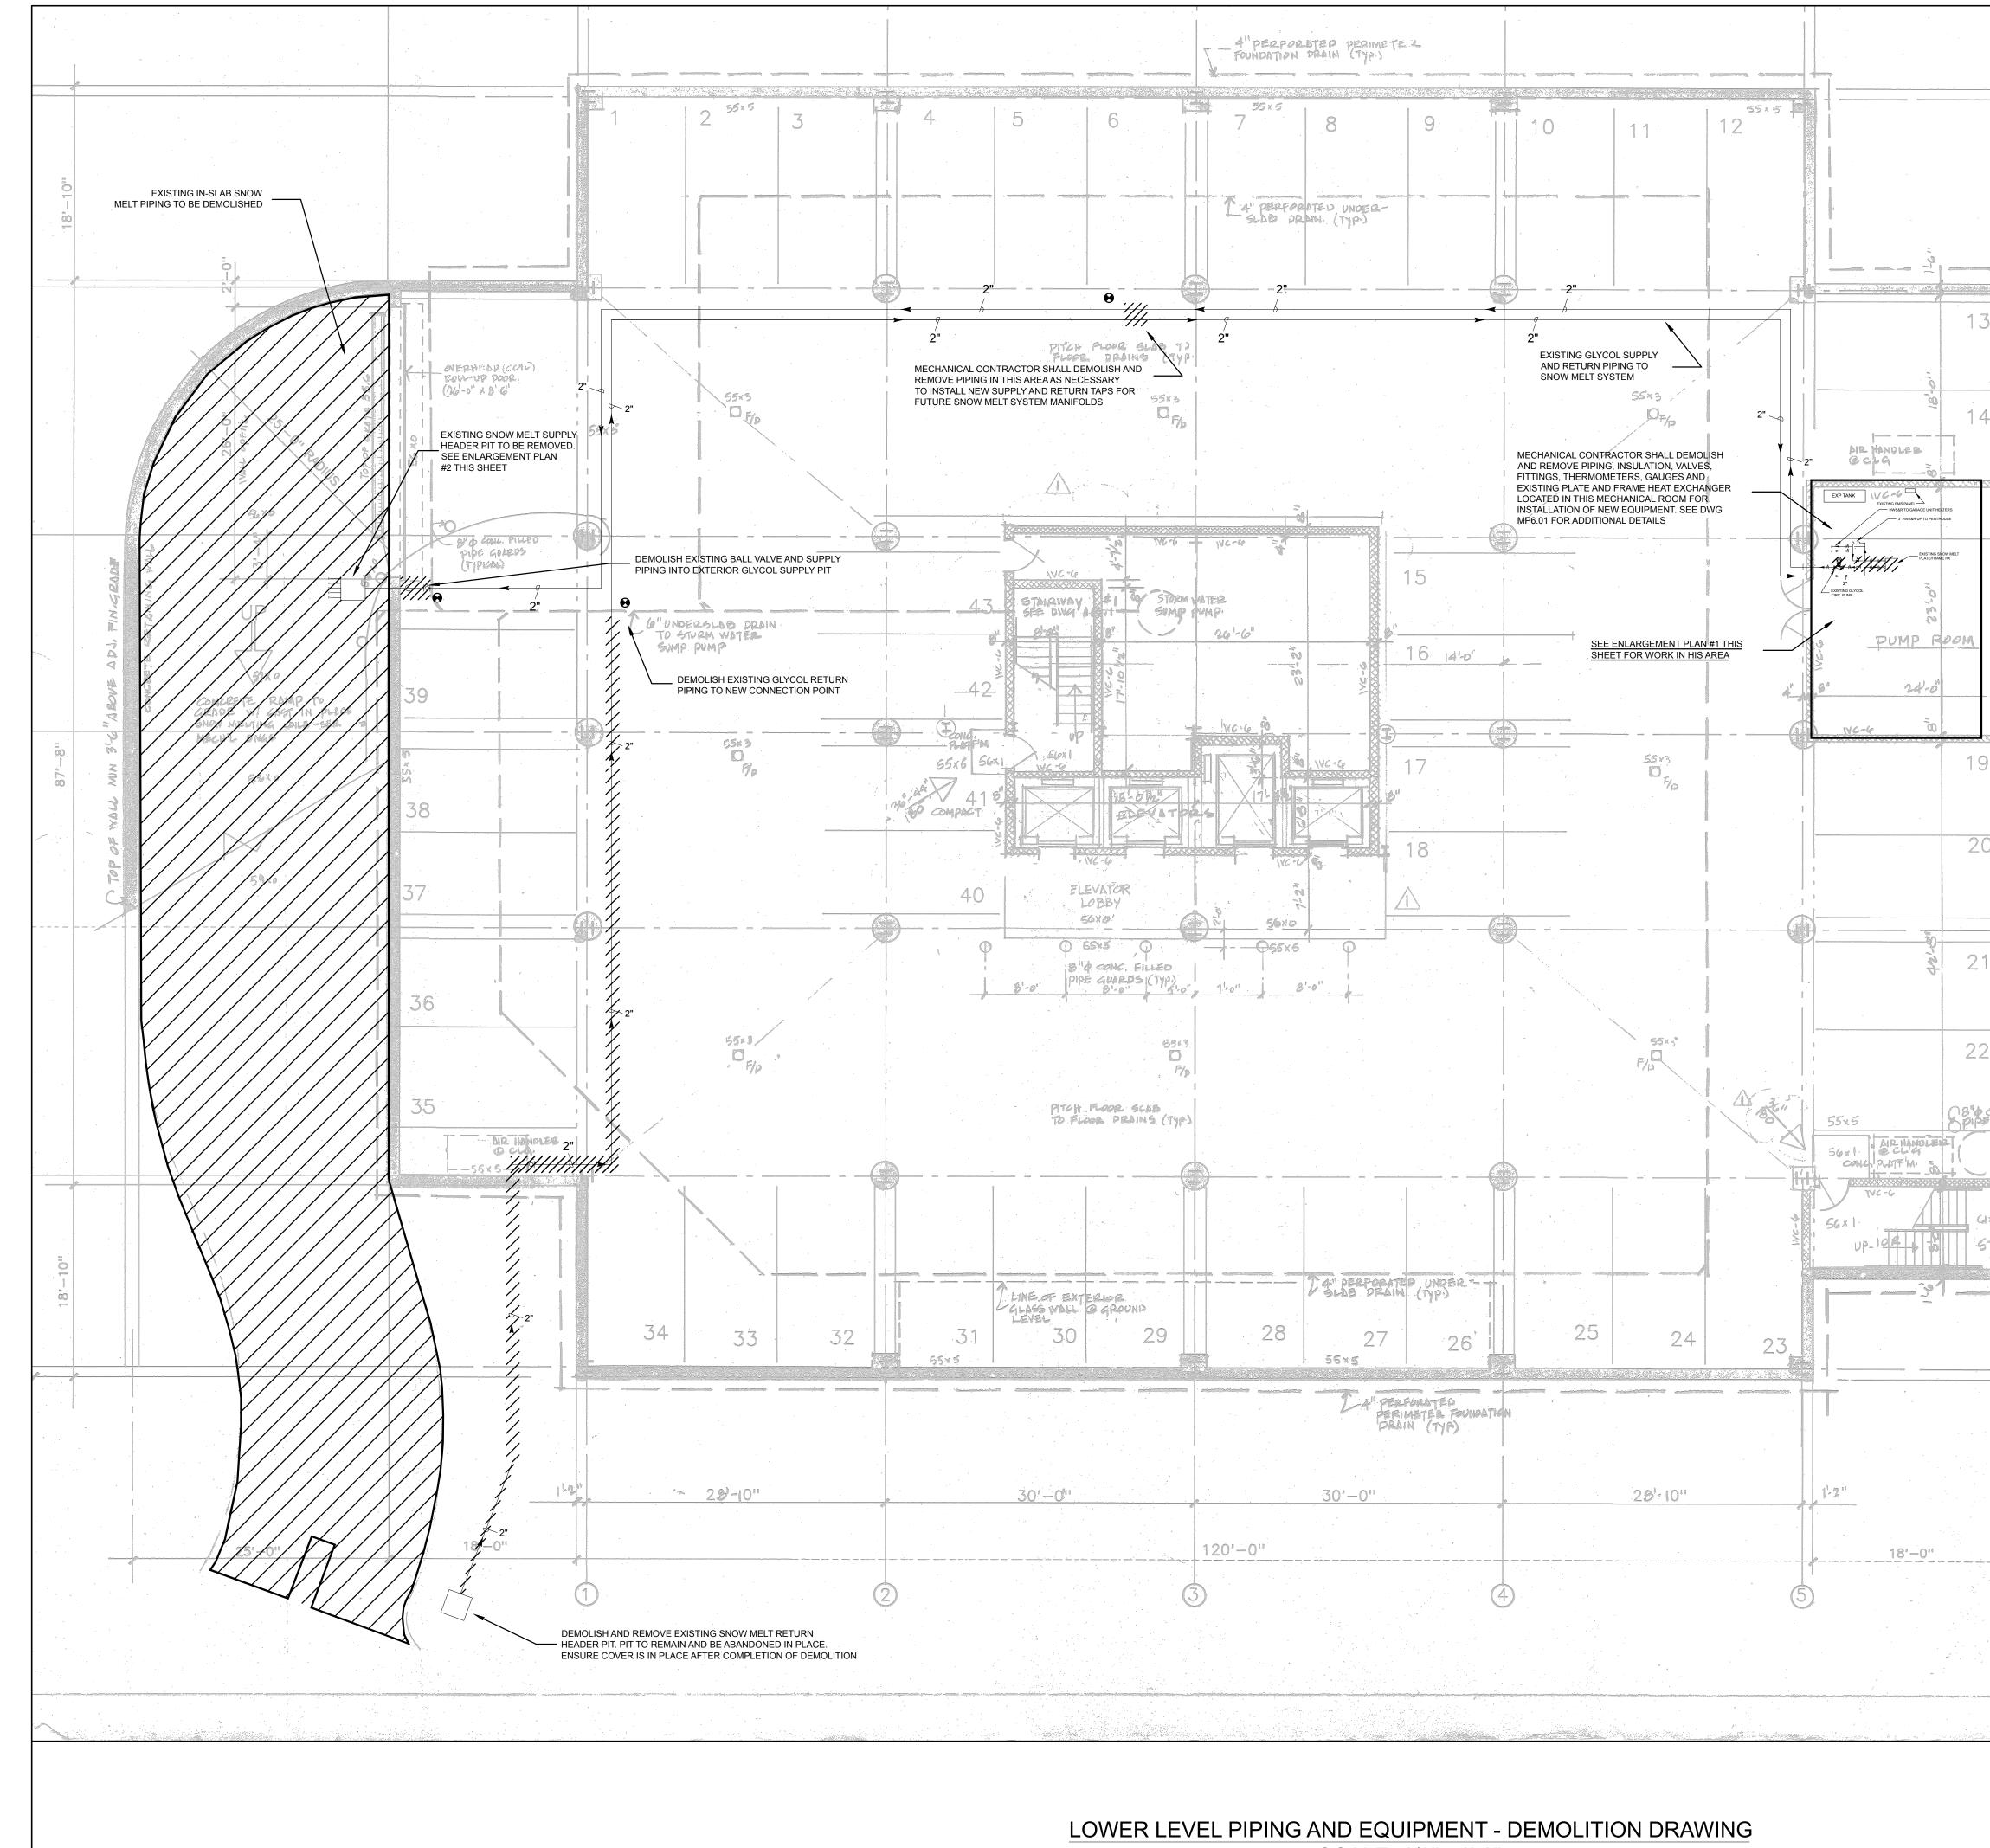




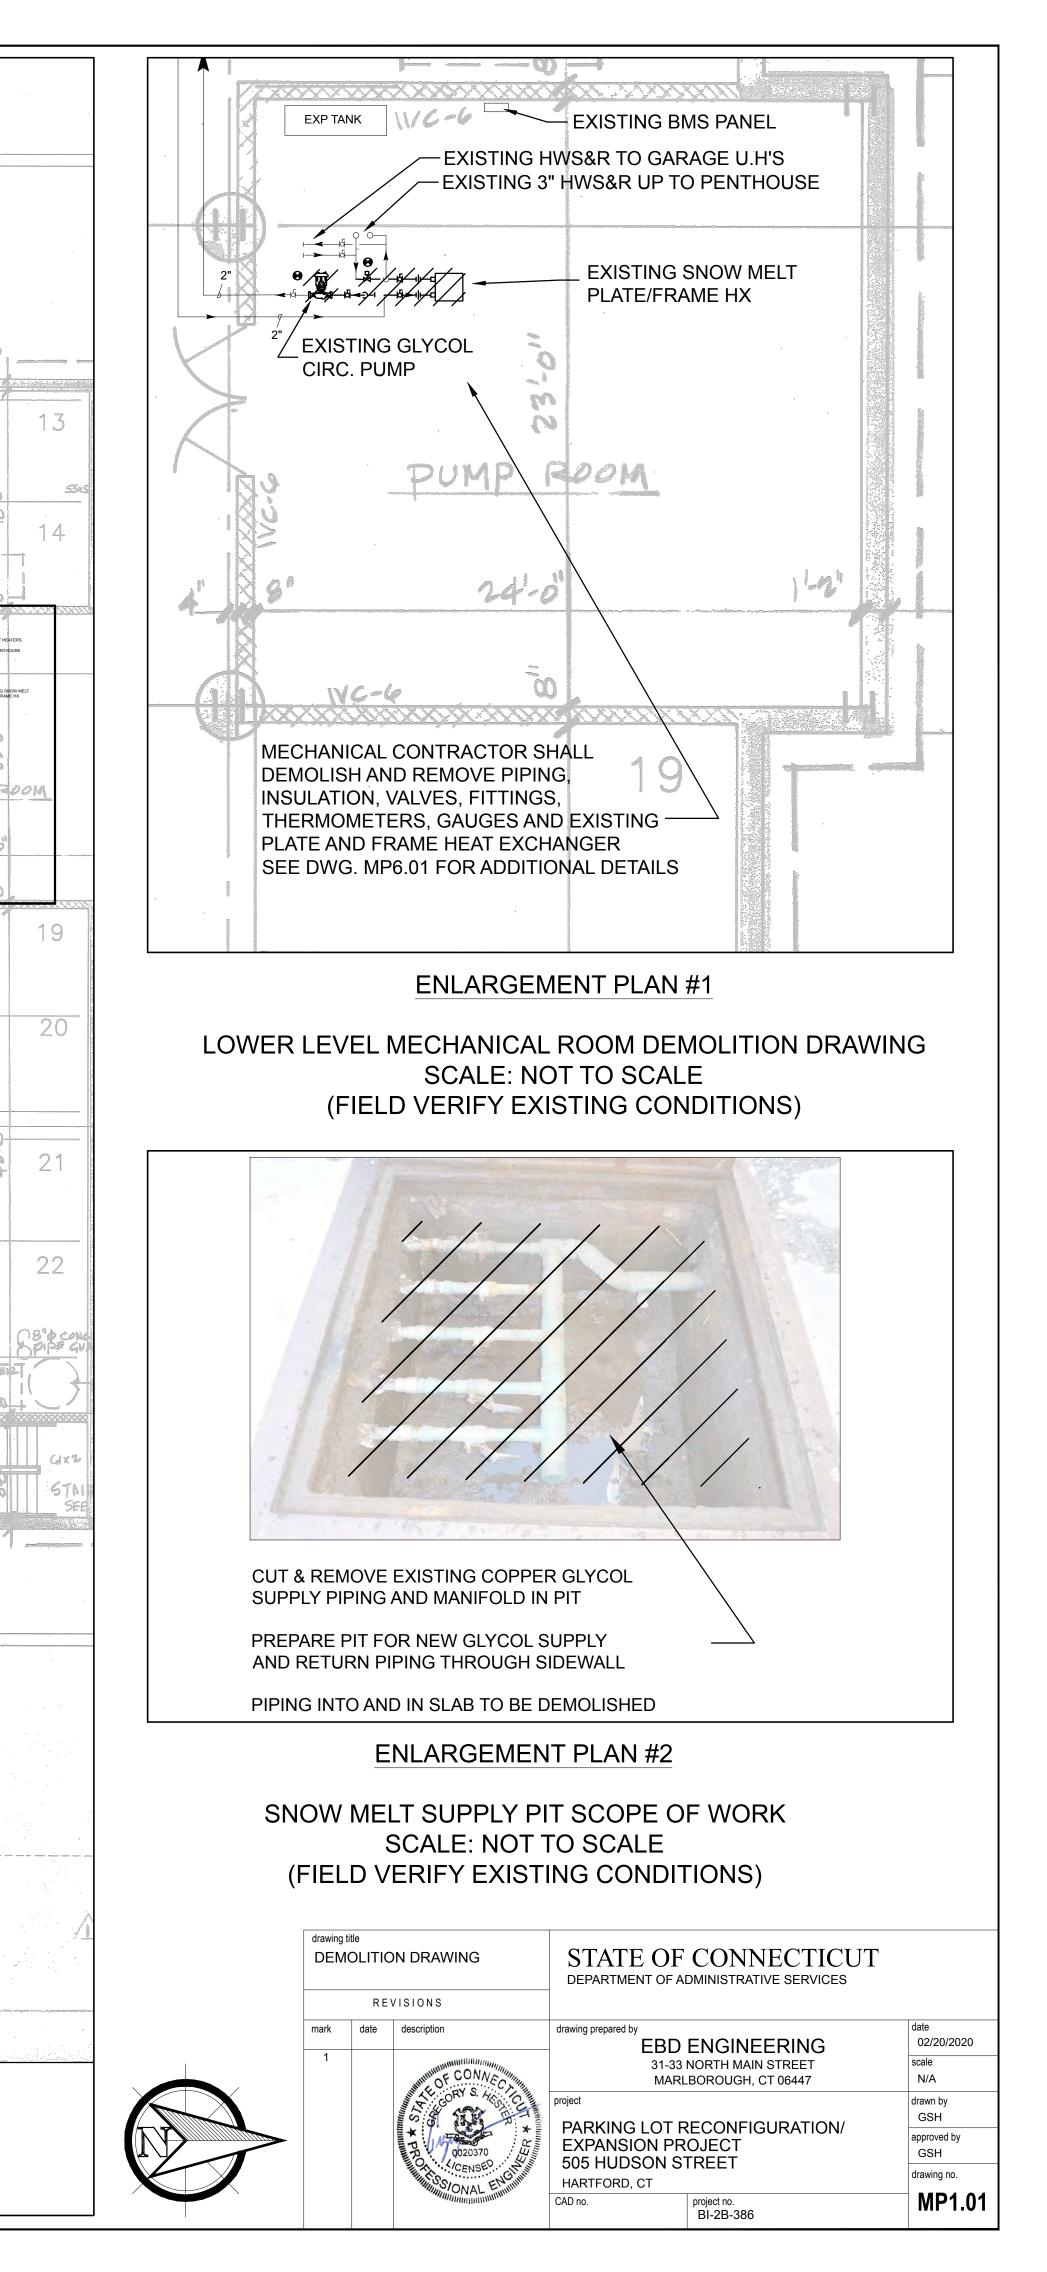

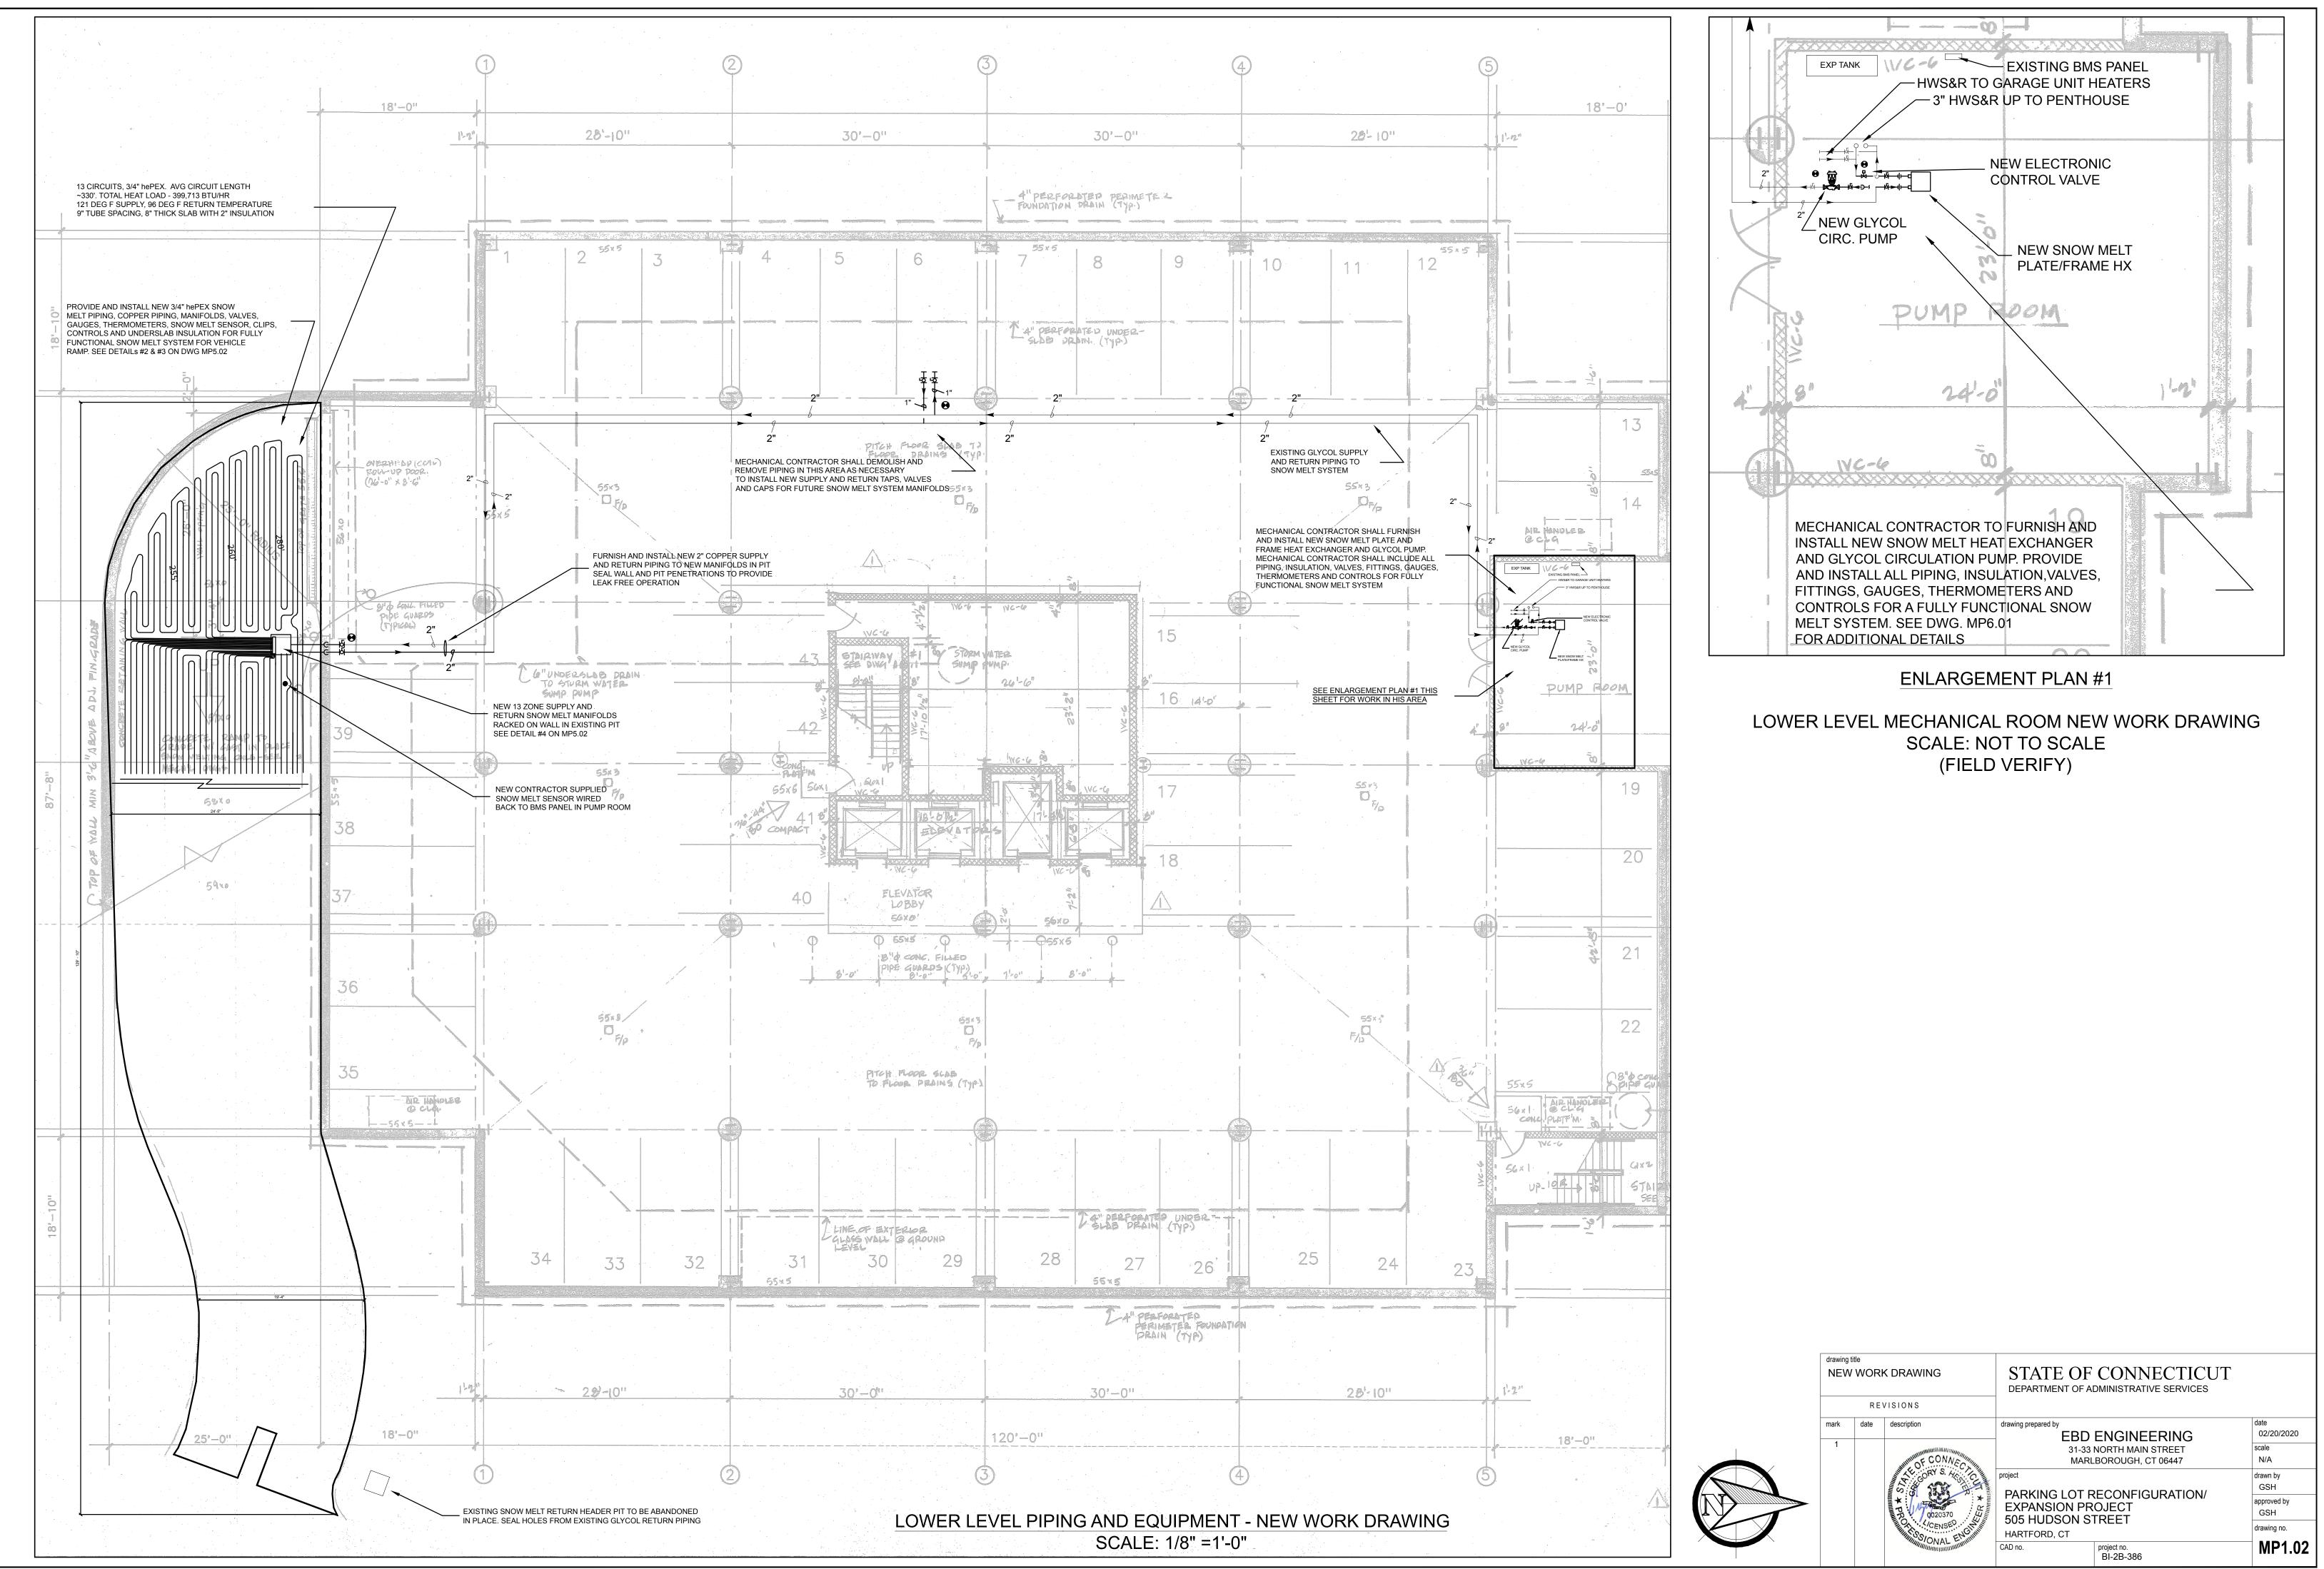
MP5.01 project no. BI-2B-386 CAD no

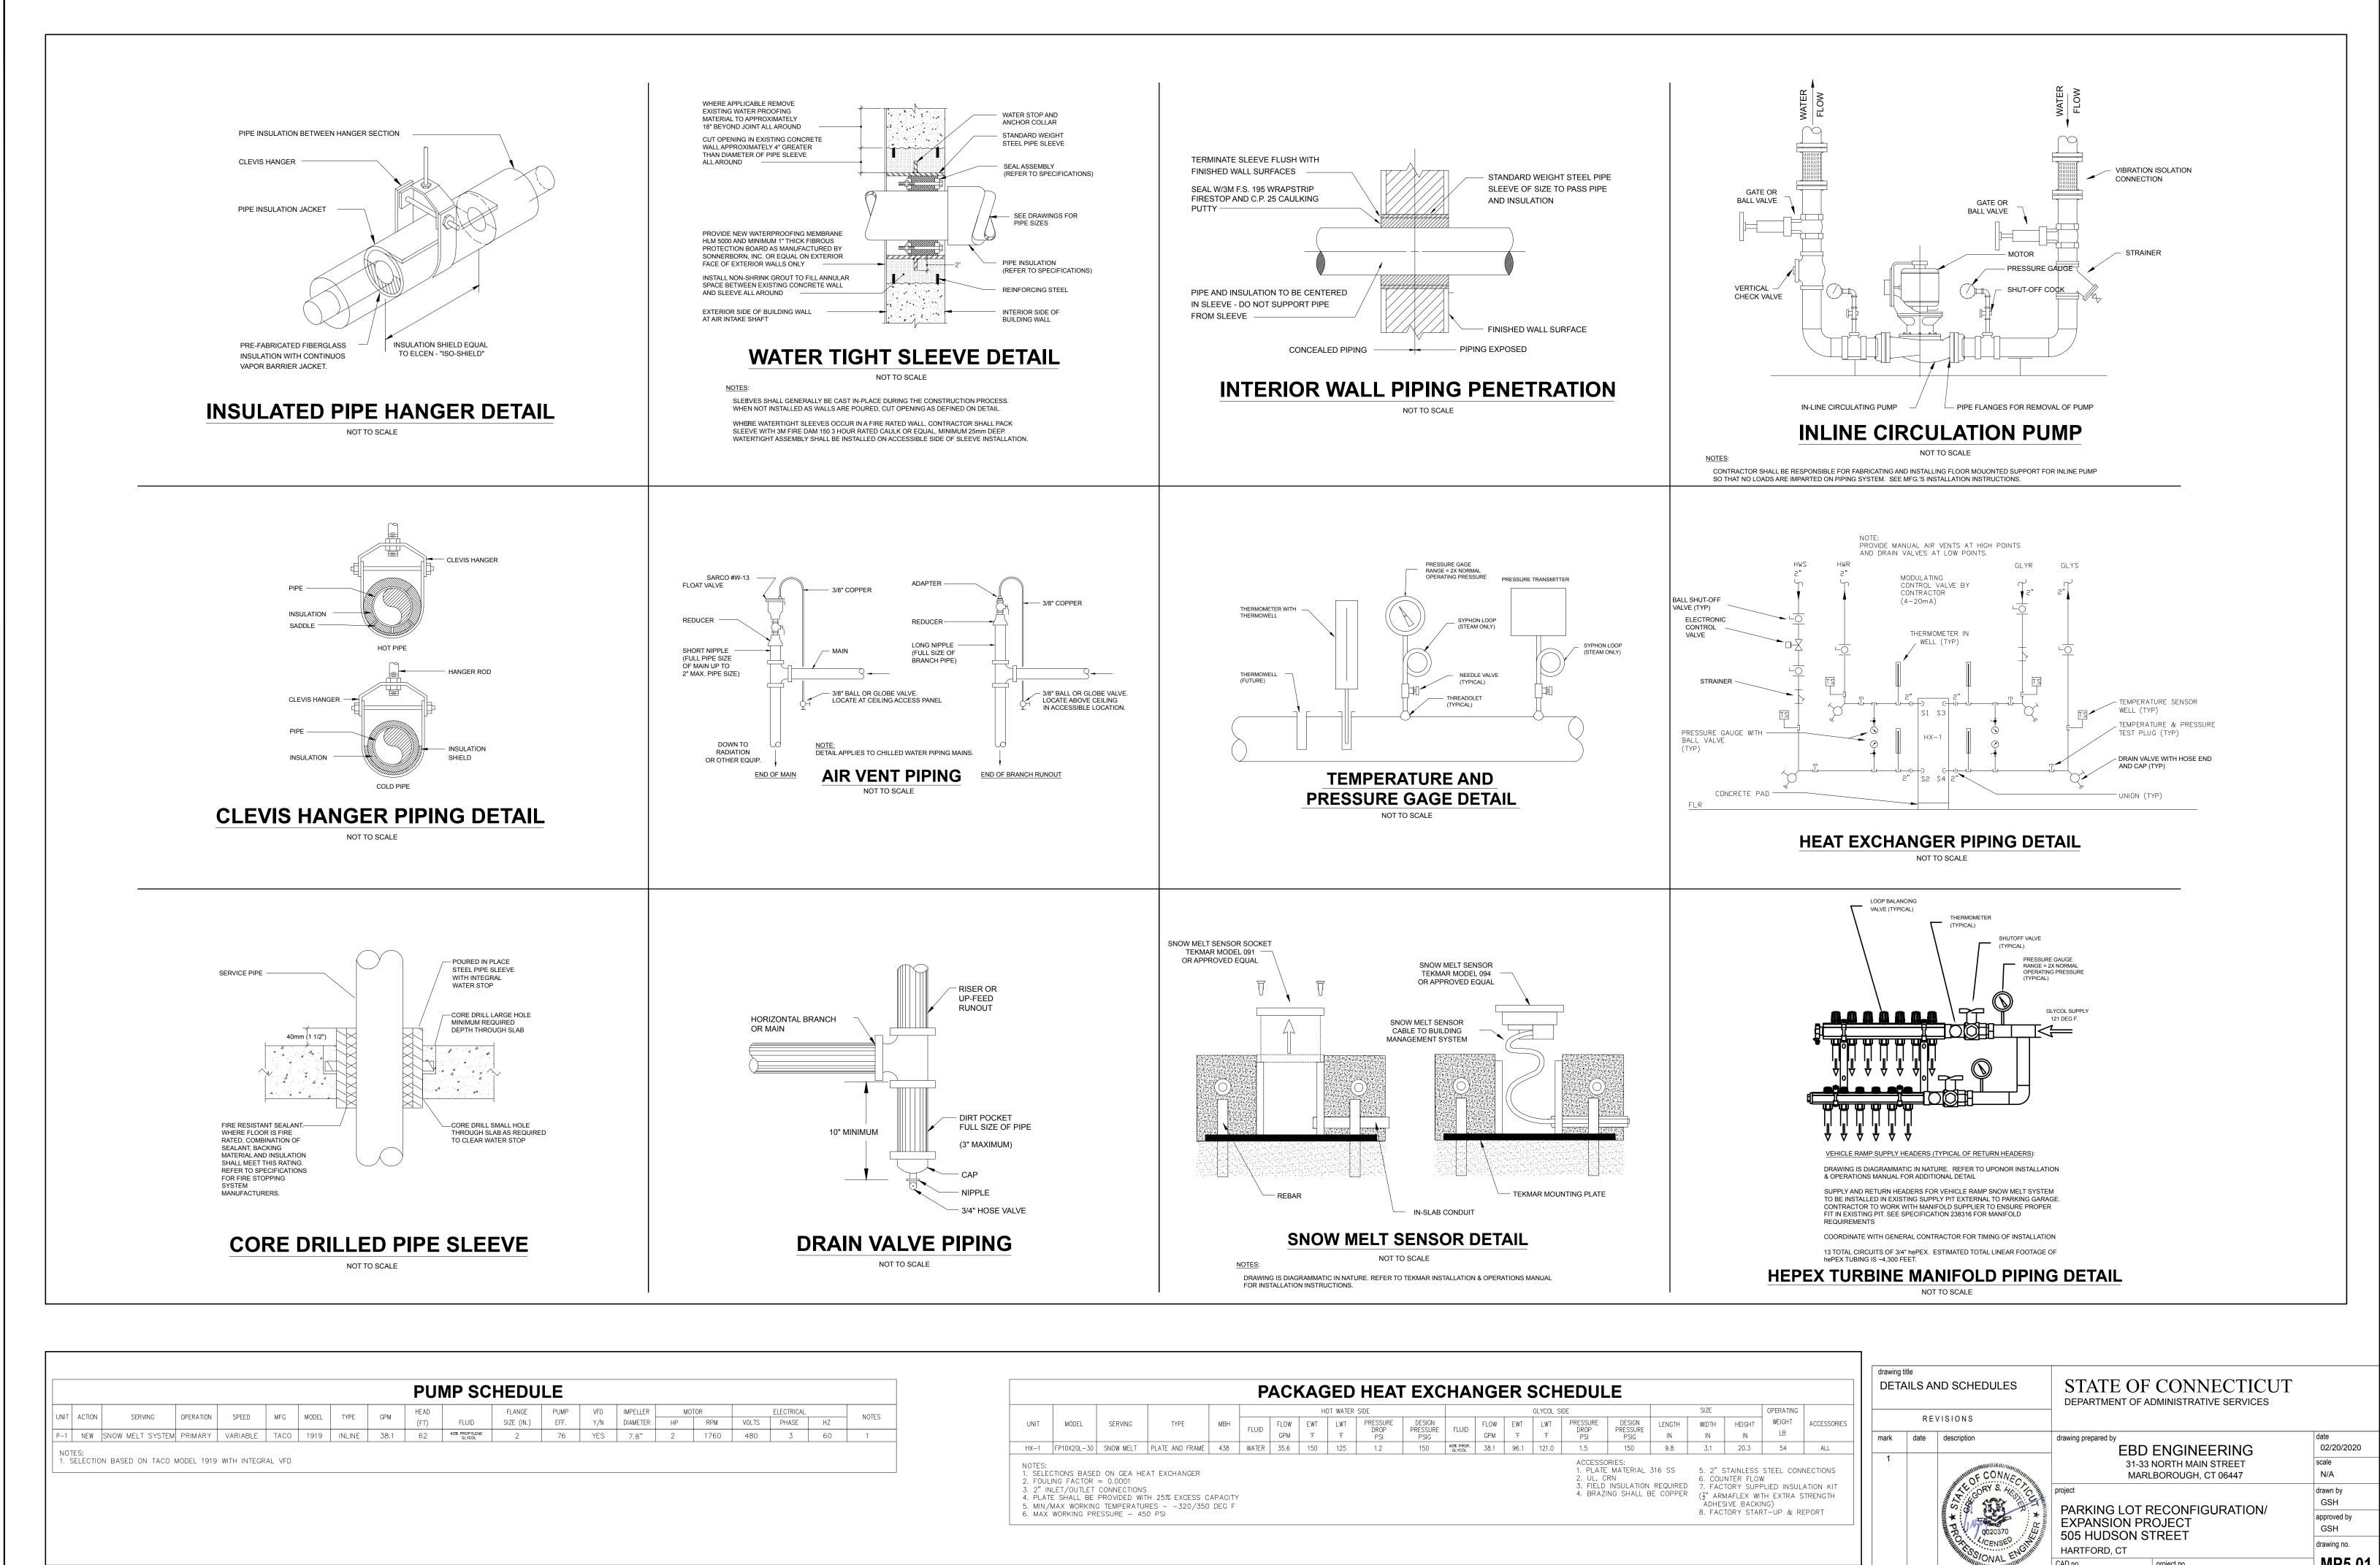

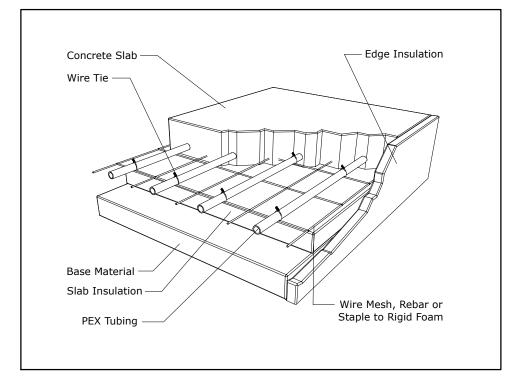

PEX INSTALLATION 2 DETAIL IN CONCRETE MP5.02 NOT TO SCALE


NOTE: PEX INSTALLATION MUST MEET THE CORRECT ASTM STANDARDS FOR PEX PIPING AND FITTINGS THAT ARE USED FOR SNOW MELT SYSTEMS AS NOTED IN THE 2003 PLUMBING CODE, SECTION 605 - "MATERIALS, JOINTS AND CONNECTIONS".

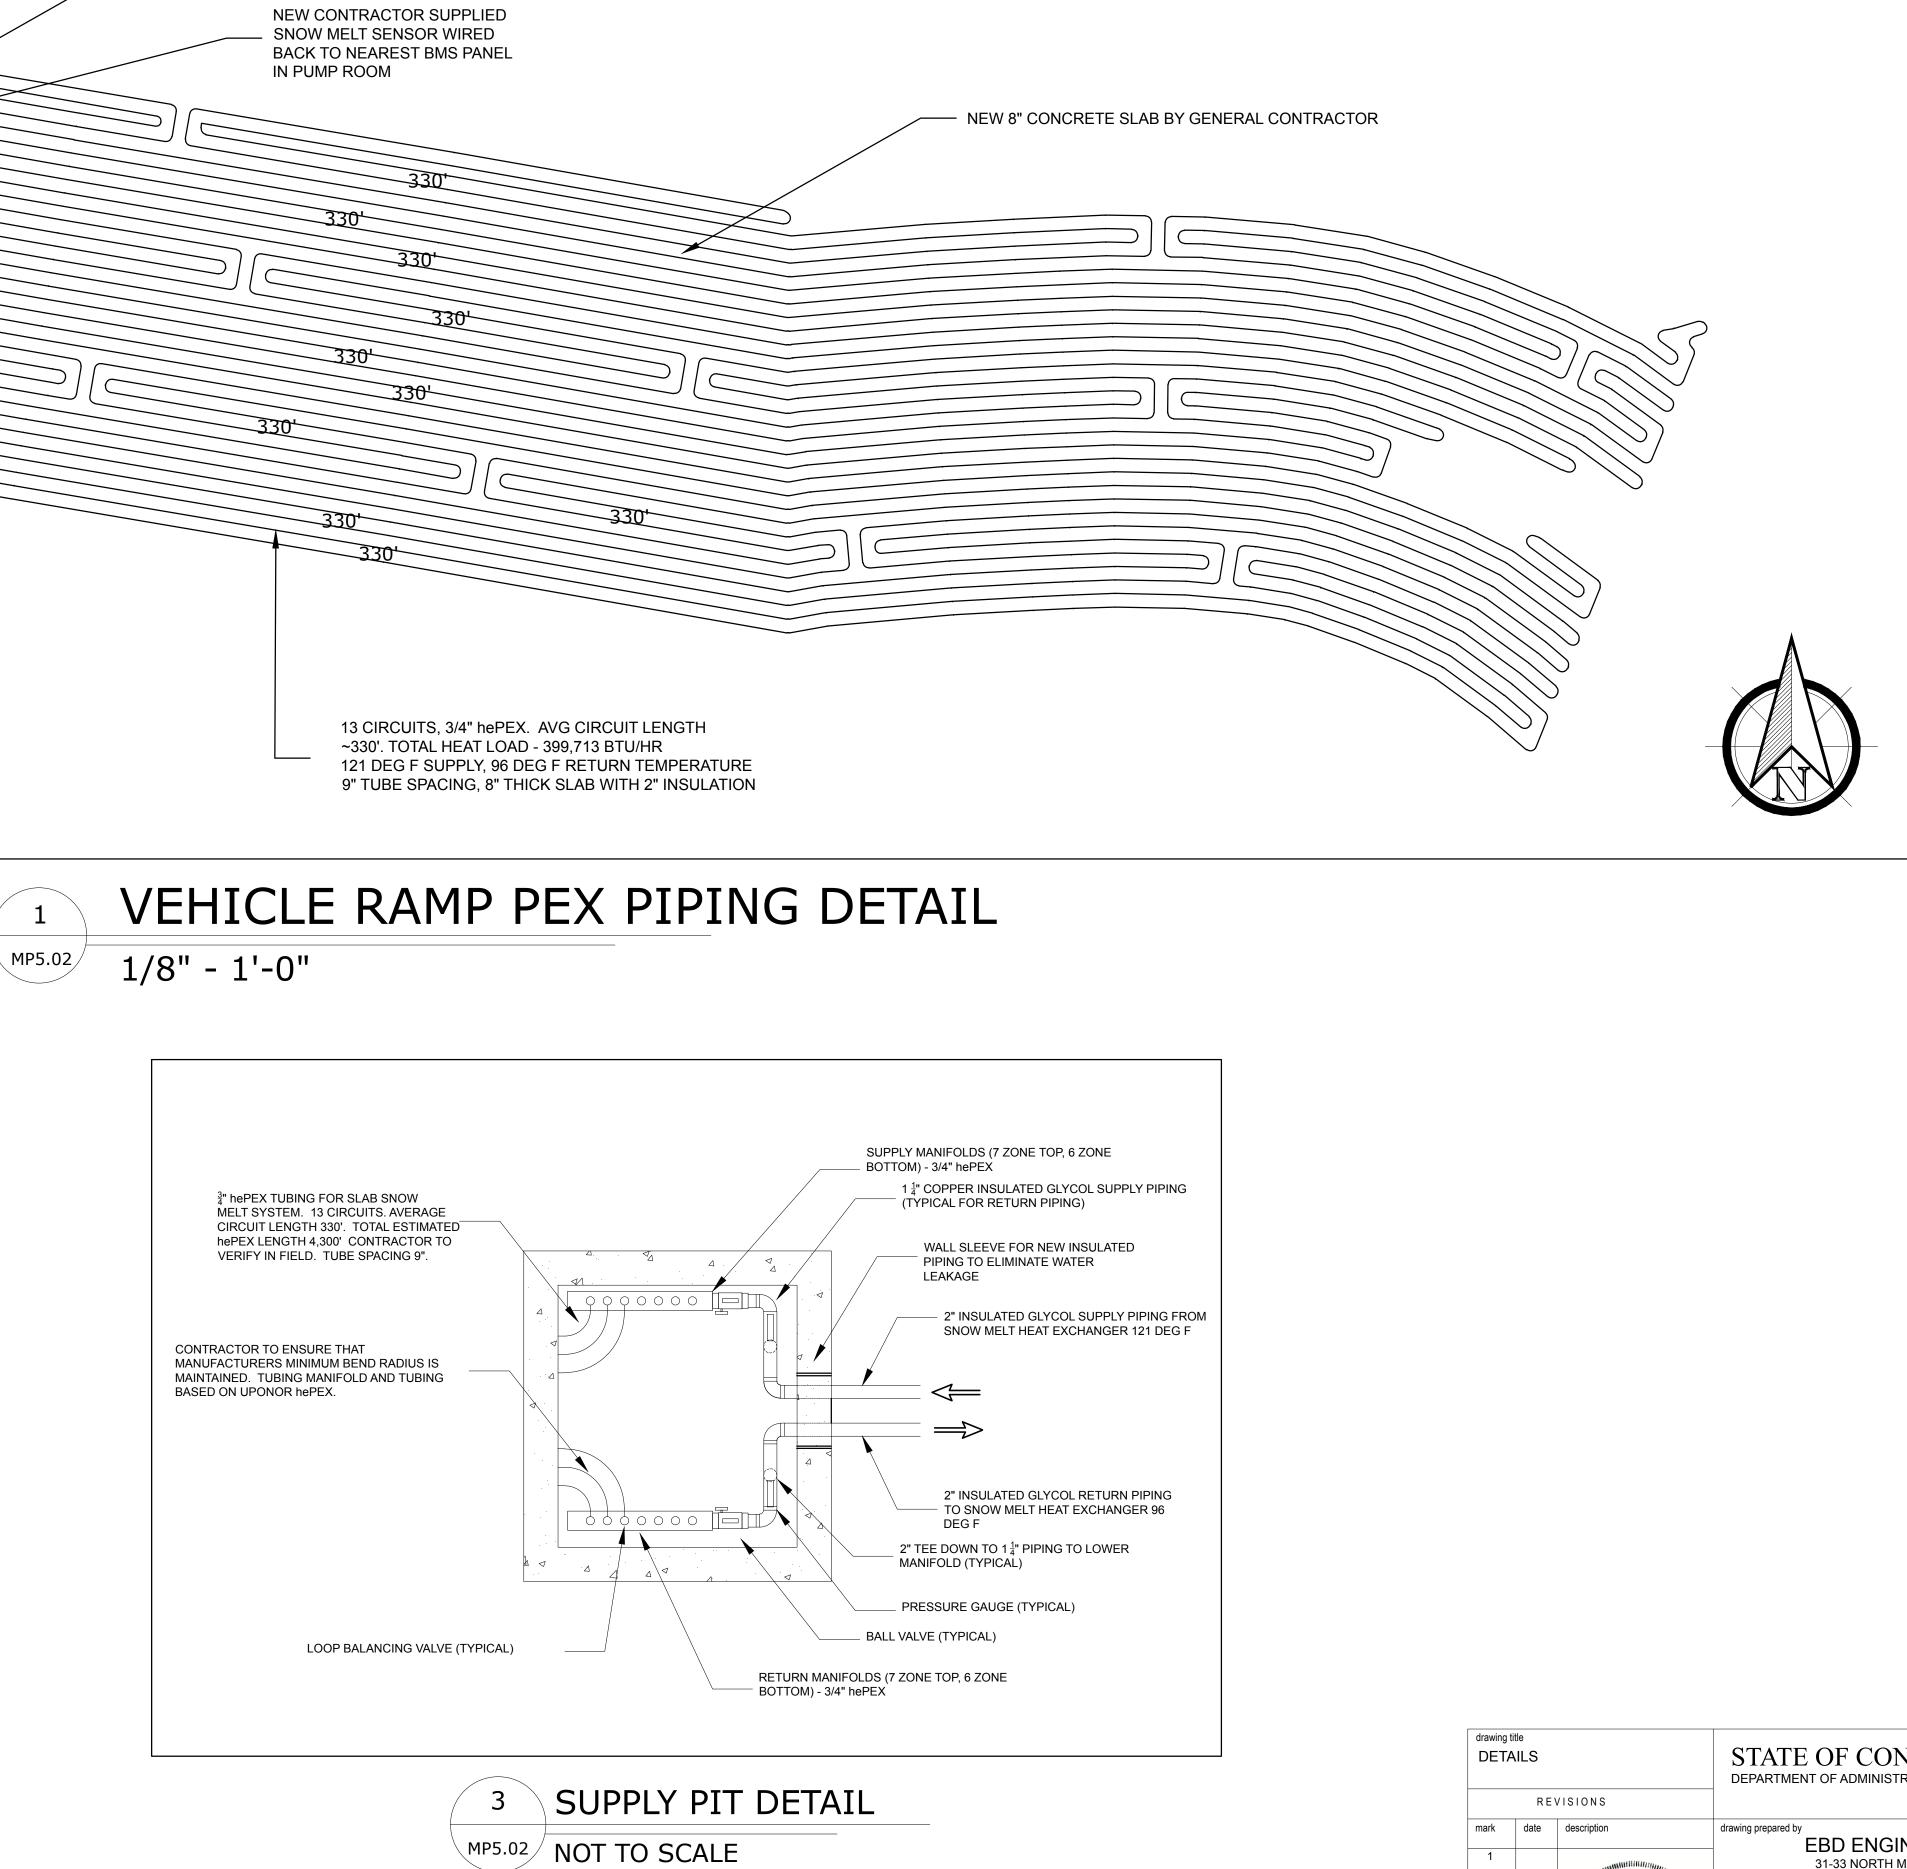


NOTE: PLEASE SEE DRAWING C1.02 FOR DETAIL

SUPPLY & RETURN MANIFOLD LOCATION IN EXISTING PIT

drawing title DETAILS			STATE OF CONNECTICUT DEPARTMENT OF ADMINISTRATIVE SERVICES		1
	RE	VISIONS			
mark	date	description	drawing prepared by	ENGINEERING	date 02/20/202
1		MUMMUM OF CONNEC	31-33	NORTH MAIN STREET LBOROUGH, CT 06447	scale N/A
		LE CORY S. HOLC		RECONFIGURATION/	drawn by GSH
		0020370 0020370	EXPANSION PR 505 HUDSON S	ROJECT	approved by GSH
		CENSED RUIN	HARTFORD, CT		drawing no.
		ONAL	CAD no.	project no. BI-2B-386	MP5.

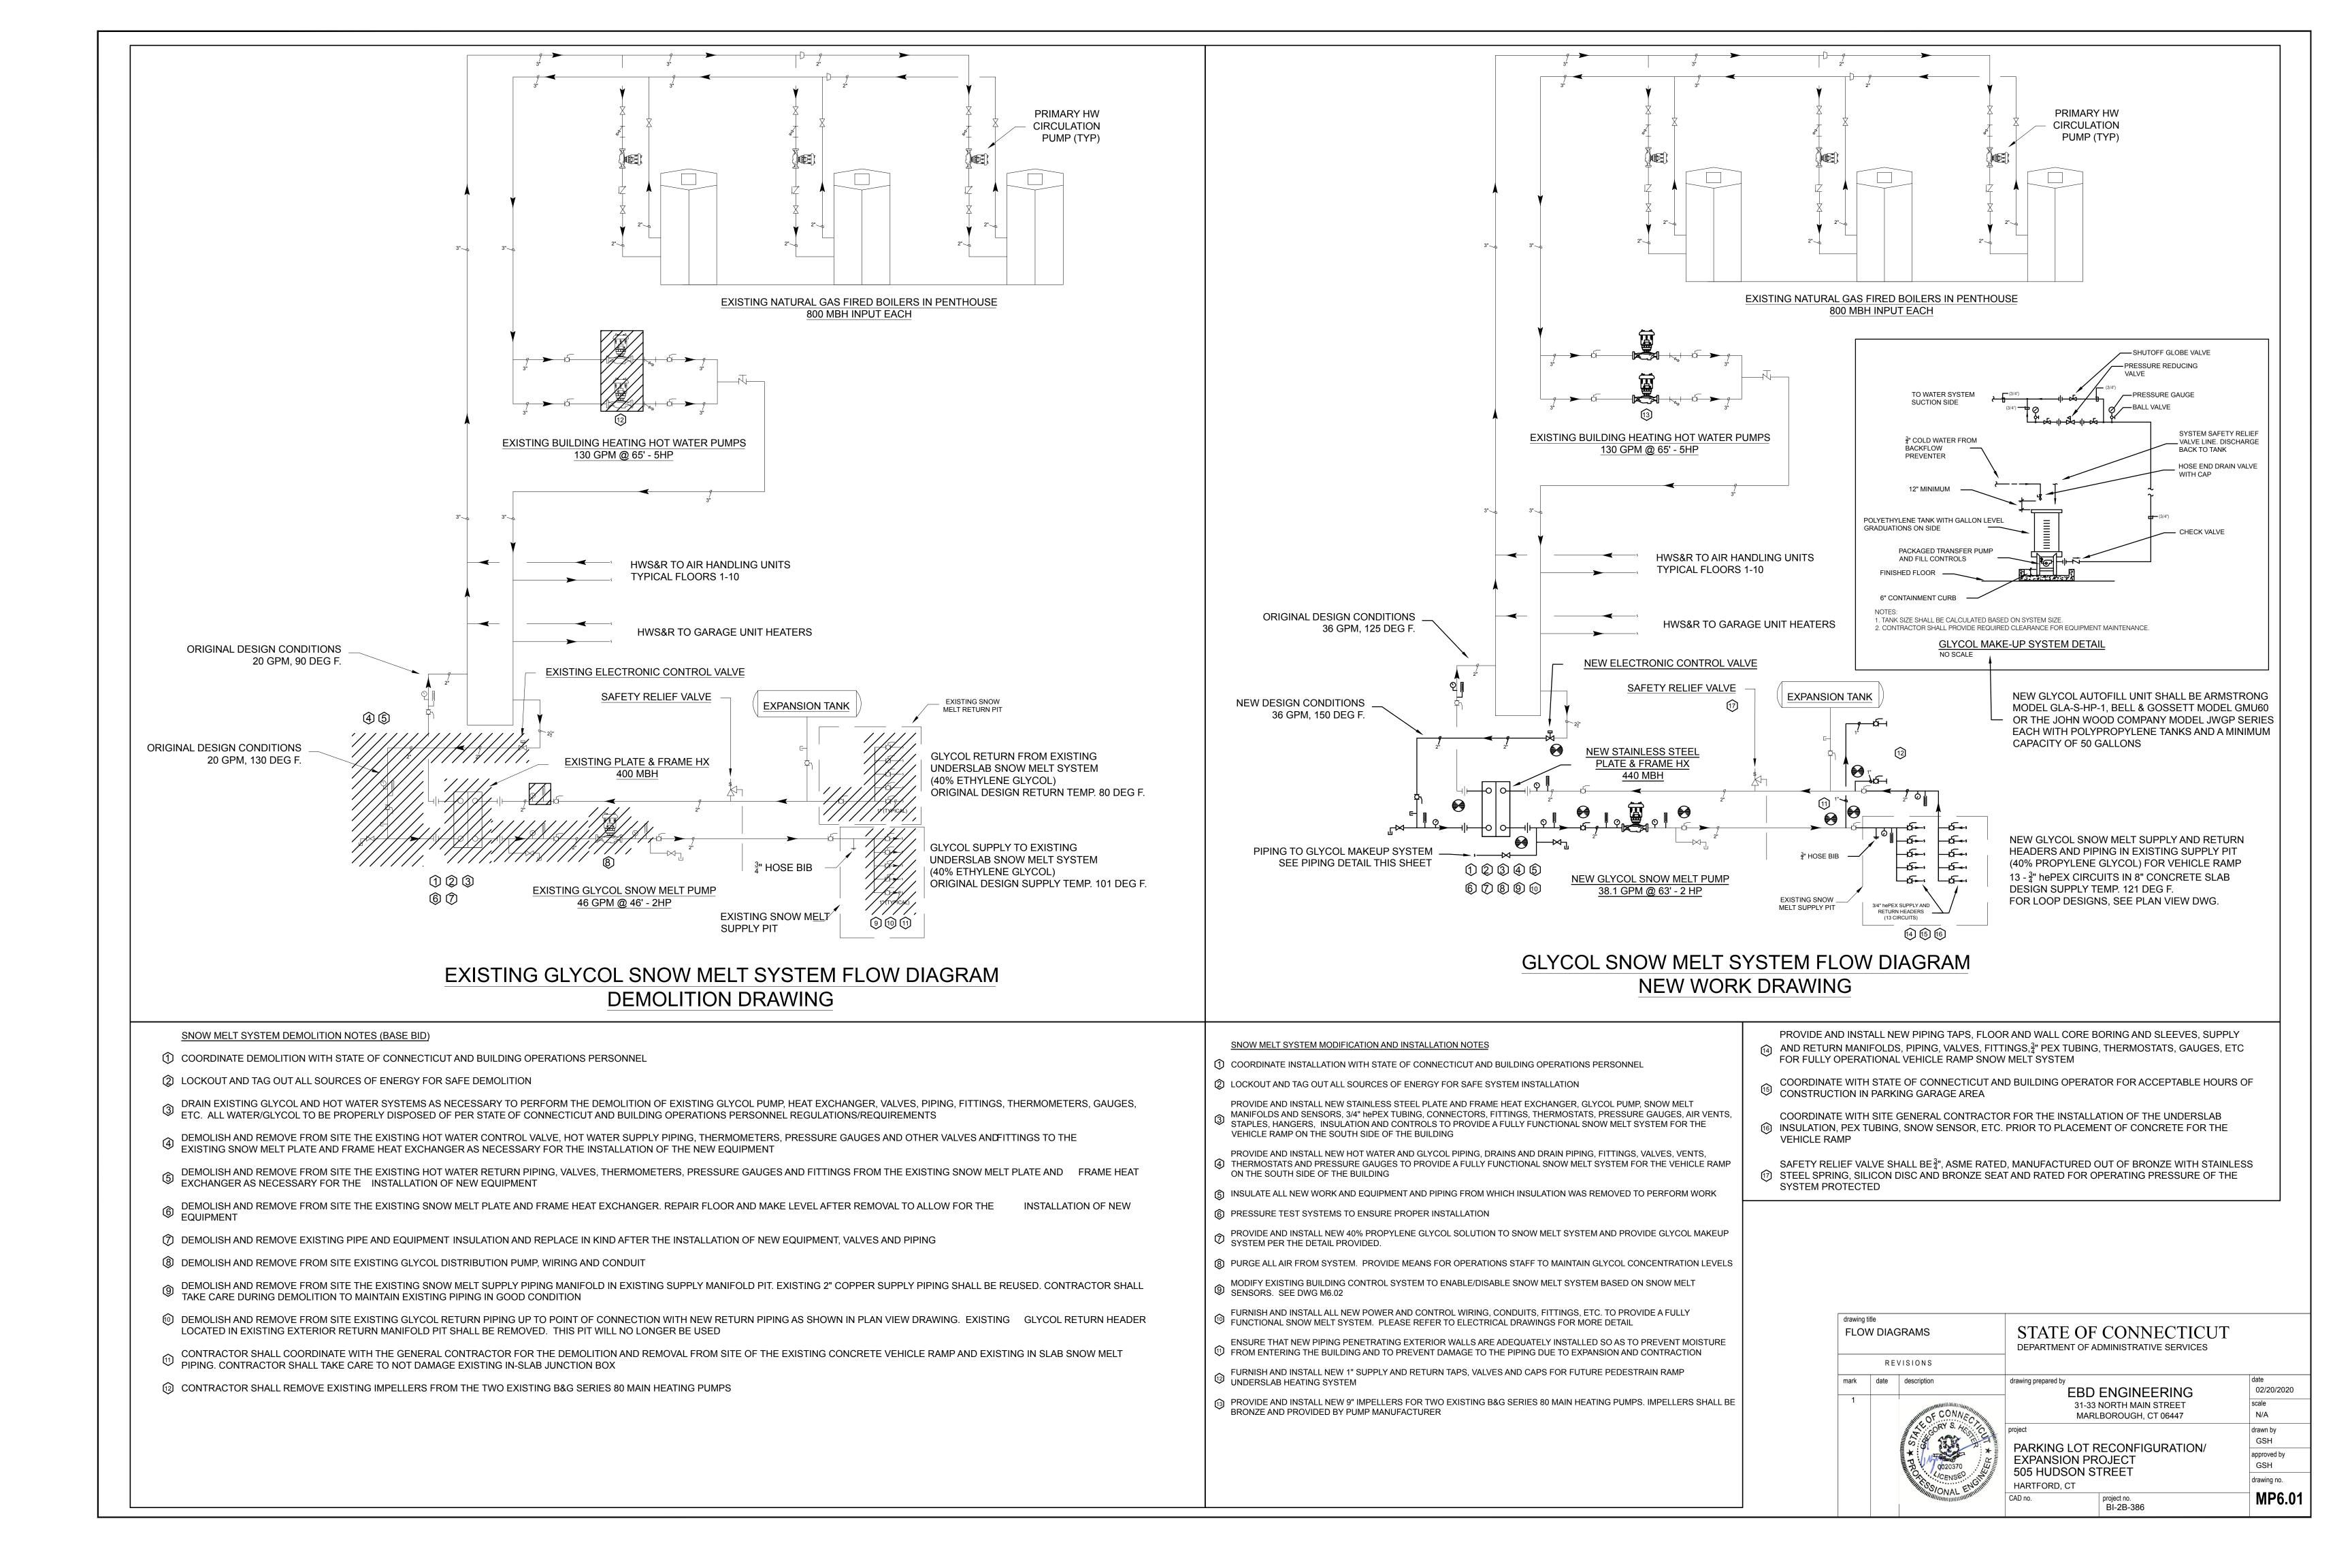

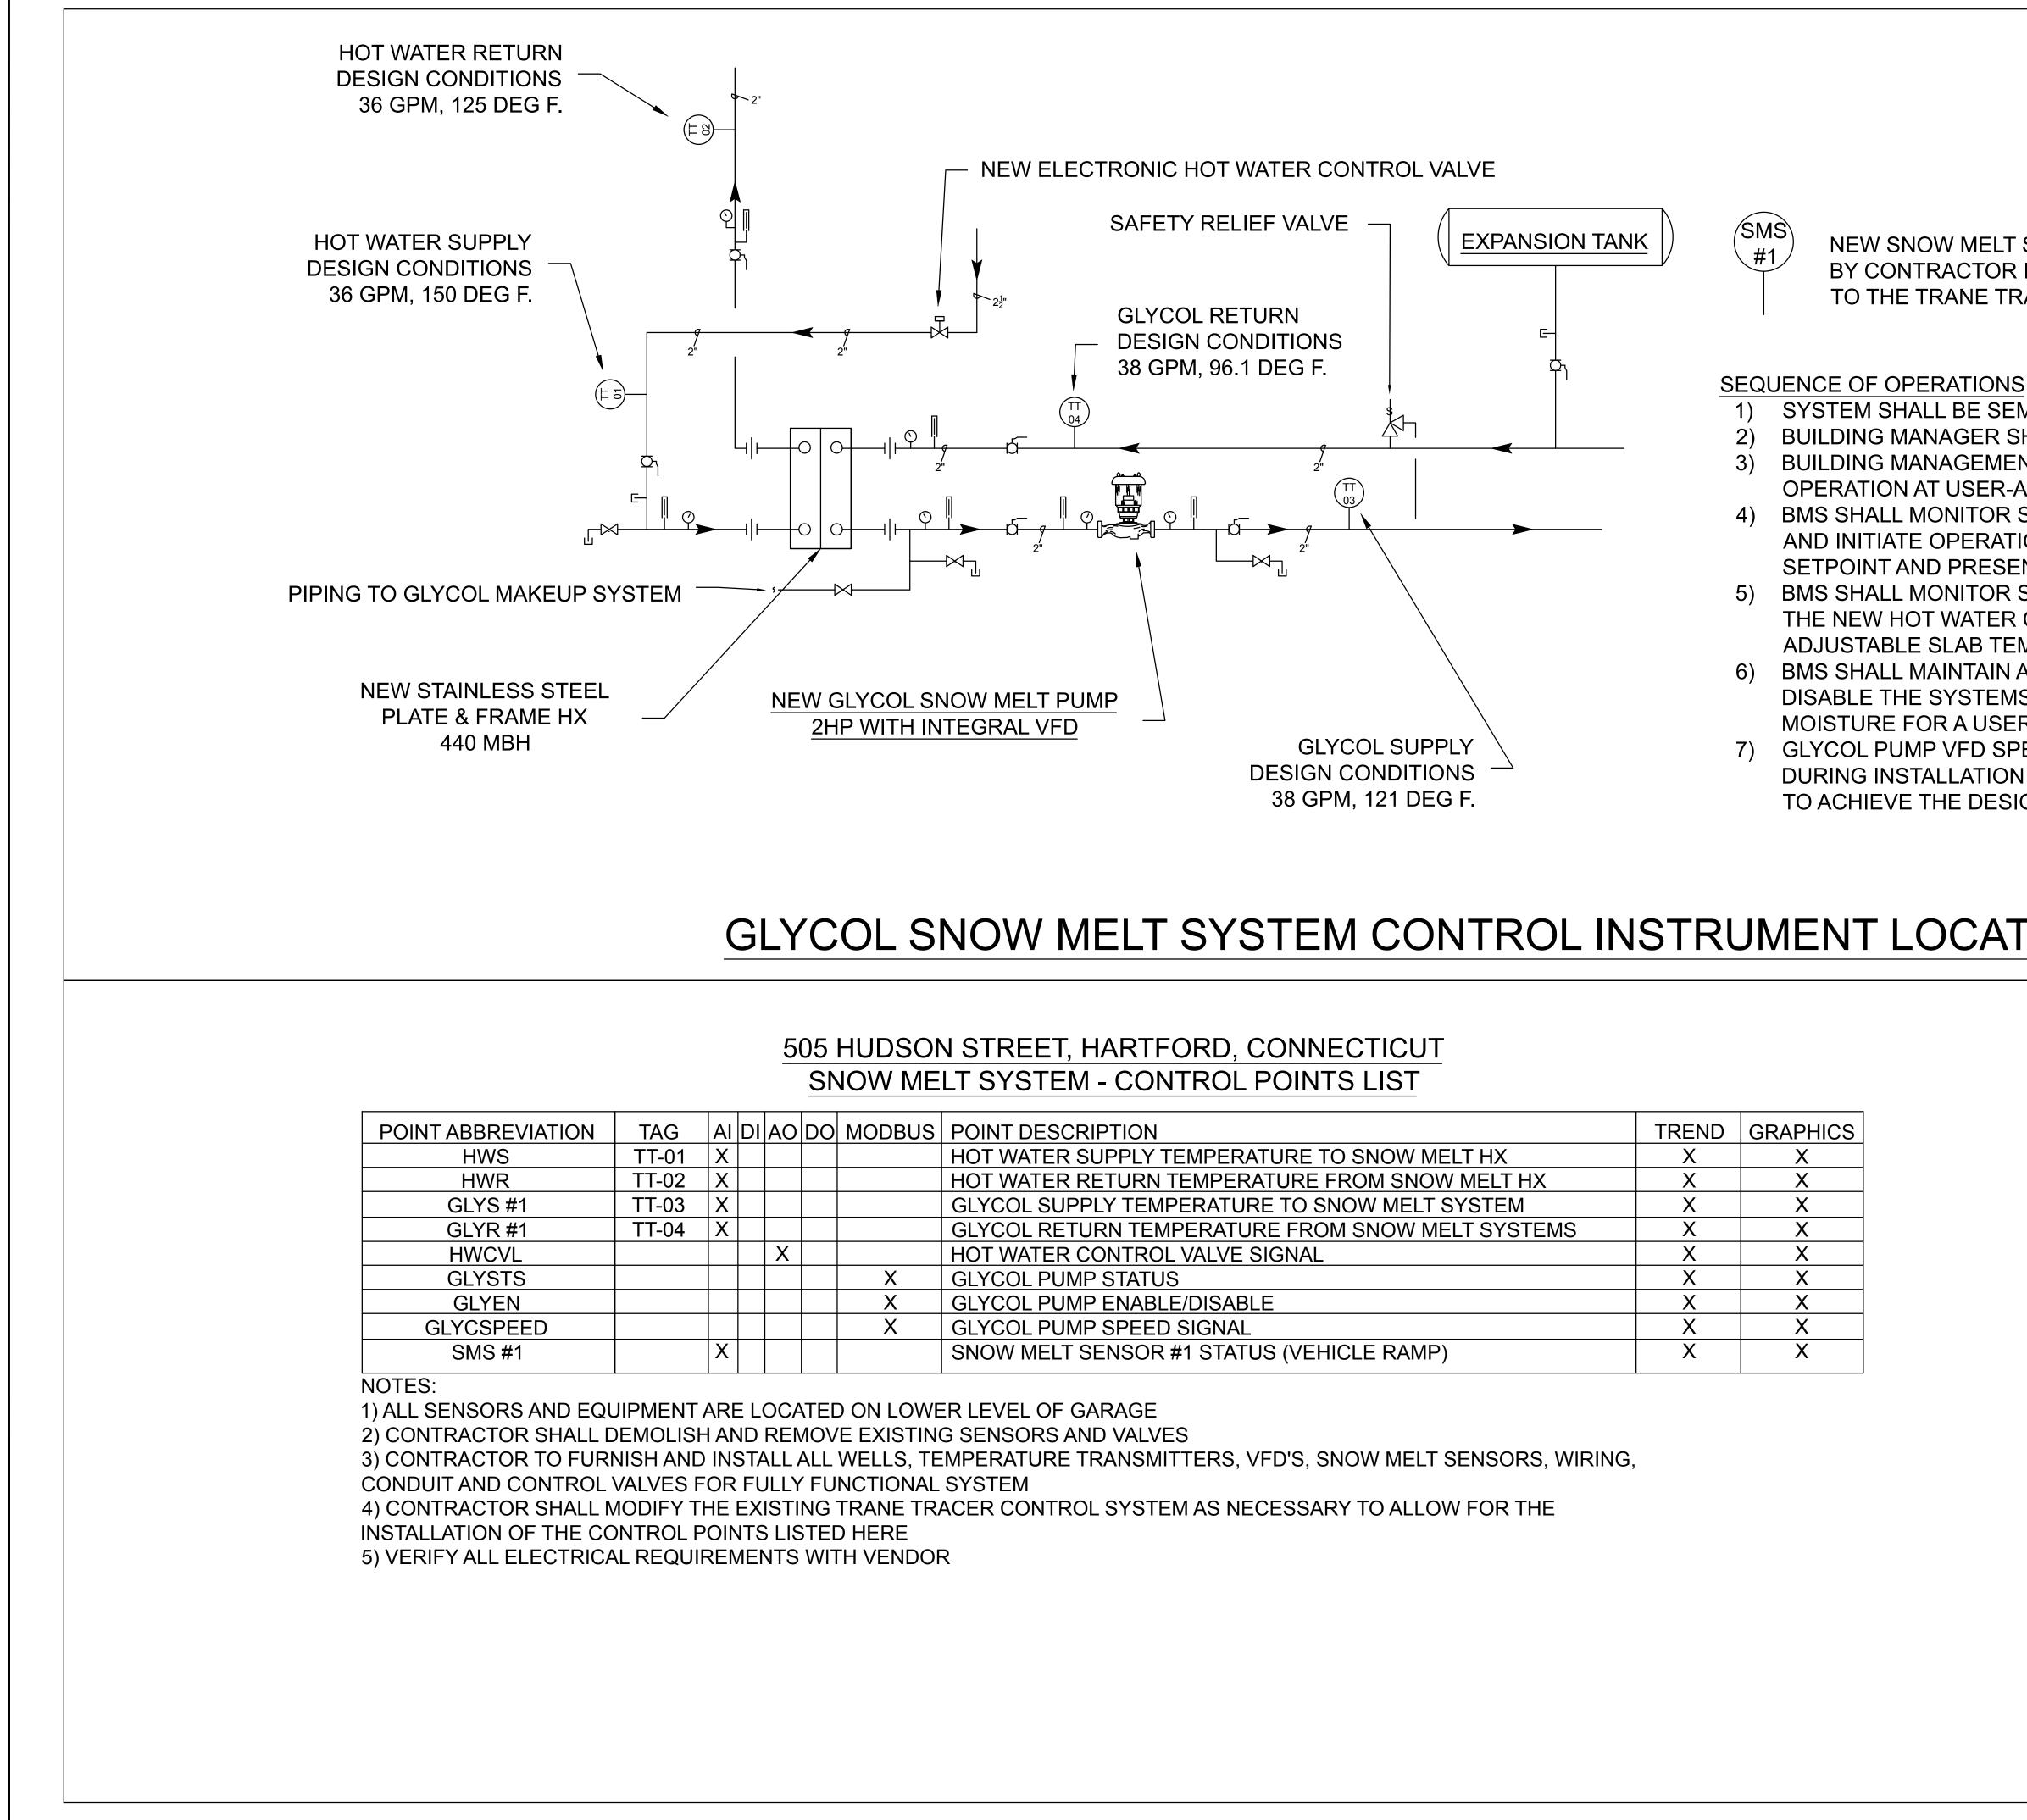

GLYCOL SNOW MELT SYSTEM CONTROL INSTRUMENT LOCATION DETAIL

BUS	POINT DESCRIPTION	TREND	GRAPHICS
	HOT WATER SUPPLY TEMPERATURE TO SNOW MELT HX	Х	Х
	HOT WATER RETURN TEMPERATURE FROM SNOW MELT HX	Х	Х
	GLYCOL SUPPLY TEMPERATURE TO SNOW MELT SYSTEM	Х	Х
	GLYCOL RETURN TEMPERATURE FROM SNOW MELT SYSTEMS	Х	Х
	HOT WATER CONTROL VALVE SIGNAL	Х	Х
<	GLYCOL PUMP STATUS	Х	Х
<	GLYCOL PUMP ENABLE/DISABLE	Х	Х
<	GLYCOL PUMP SPEED SIGNAL	Х	Х
	SNOW MELT SENSOR #1 STATUS (VEHICLE RAMP)	Х	Х

NEW SNOW MELT SENSOR TO BE FURNISHED AND INSTALLED BY CONTRACTOR IN NEW PEDESTRIAN RAMP AND WIRED BACK TO THE TRANE TRACER CONTROL PANEL IN THE PUMP ROOM

SYSTEM SHALL BE SEMI-AUTOMATIC BUILDING MANAGER SHALL INITIATE SYSTEM OPERATION BUILDING MANAGEMENT SYSTEM (BMS) SHALL ENABLE SYSTEM **OPERATION AT USER-ADJUSTABLE OUTDOOR AIR SETPOINT** BMS SHALL MONITOR SLAB TEMPERATURE AND MOISTURE SENSOR AND INITIATE OPERATION ON USER-ADJUSTABLE TEMPERATURE SETPOINT AND PRESENCE OF MOISTURE 5) BMS SHALL MONITOR SLAB TEMPERATURE AND SHALL MODULATE THE NEW HOT WATER CONTROL VALVE TO MAINTAIN THE USER-ADJUSTABLE SLAB TEMPERATURE 6) BMS SHALL MAINTAIN A USER-ADJUSTABLE TIMER THAT WILL DISABLE THE SYSTEMS OPERATION AFTER NO DETECTION OF MOISTURE FOR A USER-ADJUSTABLE PERIOD OF TIME 7) GLYCOL PUMP VFD SPEED SHALL BE SET BY THE BALANCER


DURING INSTALLATION AND COMMISSIONING TO A PRESET LEVEL TO ACHIEVE THE DESIGN FLOW WITH ALL CIRCUITS IN OPERATION

drawing CON	title ITROLS	6	STATE OF CONNECTICUT DEPARTMENT OF ADMINISTRATIVE SERVICES	
	RE	VISIONS	-	
mark 1	date		drawing prepared by EBD ENGINEERING 31-33 NORTH MAIN STREET MARLBOROUGH, CT 06447	date 02/20/2020 scale N/A
		PROPOSITIONAL ENVIRONMENT	PRKING LOT RECONFIGURATION	drawn by GSH approved by
		B 0020370	EXPANSION PROJECT 505 HUDSON STREET HARTFORD, CT	GSH drawing no.
		ONAL MINIM	CAD no. project no. BI-2B-386	MP6.02

ABBREVIATIONS				
ABBV.	DESCRIPTION	ABBV.	DESCRIPTION	
TYP.	TYPICAL	WP	WATER PROOF	
E.C.	ELECTRICAL CONTRACTOR	TP	TAMPER PROOF	
F.A.	FIRE ALARM	GFI	GROUND FAULT INTERRUPTER	
J.O.N.	UNLESS OTHERWISE NOTED	AFG	ABOVE FINISHED GRADE	
CLG.	CEILING	RM	REMOVE	
REQD.	REQUIRED	N	NEW	
MTD.	MOUNTED	EX	EXISTING	
MIN.	MINIMUM	RL	EXISTING TO BE RELOCATED	
C/B	CIRCUIT BREAKER	NL	NEW LOCATION	
AFF	ABOVE FINISHED FLOOR	EM	CONNECTION TO EMERGENCY POWER	
WG	WIRE GUARD			

GENERAL DRAWING NOTES :

- A. THE PARKING GARAGE IS A WET LOCATION. ALL WIRING METHODS, JUNCTION BOXES AND WIRE USED WITHIN THE GARAGE ARE TO BE WET LOCATION RATED.
- B. ALL CONDUIT IN THE GARAGE IS TO BE RIGID GALVANIZED STEEL.

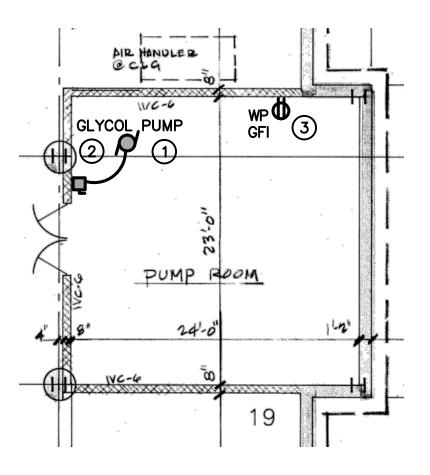

LOWER LEVEL PART PLAN 1/8"=1'-0"

LI	LINE REPRESENTATION		
	NEW BURIED WIRING		
	NEW WIRING/EQUIPMENT		
	EXISTING WIRING/EQUIPMENT		
	DEMOLISH WIRING/EQUIPMENT		

I INF DEDDECENTATION

DRAWING KEY NOTES :

- ① DISCONNECT EXISTING INLINE CIRCULATOR PUMP AND REMOVE EXISTING FEEDER AND ACROSS THE LINE STARTER. FEEDER AND DISCONNECT TO REMAIN.
- (2) FEEDER TO NEW GLYCOL CIRCULATOR PUMP. FEED VFD MOUNTED ON PUMP FROM EXISTING DISCONNECT SWITCH WITH 3#12 & 1#12 GND IN 3/4"C.
- 3 PROVIDE ONE (1) GROUND FAULT RECEPTACLE ADJACENT TO GLYCOL FEEDER AT 42" AFF. CONNECT RECEPTACLE TO NEAREST NEAREST GENERAL PURPOSE OUTLET BRANCH CIRCUIT.

GENERAL PROJECT NOTES:

- 1. EXISTING CONDITIONS NOT GENERALLY SHOWN. CONTRACTOR SHALL VERIFY ALL CONDITIONS IN FIELD PRIOR TO SUBMISSION OF BID.
- 2. COORDINATE SCOPE OF DEMOLITION WORK WITH DRAWINGS OF OTHER TRADES.
- 3. DRAWINGS ARE DIAGRAMMATIC AND INDICATE THE GENERAL ARRANGEMENT OF SYSTEMS AND WORK. CONTRACTOR SHALL:
 - A. FOLLOW DRAWINGS IN LAYING OUT WORK AND CHECK DRAWINGS AND OTHER TRADES RELATING TO WORK TO VERIFY SPACE IN WHICH WORK WILL BE INSTALLED. MAINTAIN HEADROOM AND MINIMUM CODE REQUIRED WORKING CLEARANCES AT ALL TIMES.
 - B. FURNISH AND INSTALL ALL NECESSARY OUTLETS, SUPPORTS, PULLBOXES, CONDUITS, FITTINGS AND ACCESSORIES TO FULFILL APPLICABLE CODES, REGULATIONS, BUILDING STANDARDS AND THE BEST PRACTICES OF THE TRADE FOR INSTALLATION OF WORK.
- 4. DRAWINGS INDICATE SIZE AND GENERAL LOCATION OF WORK. SCALED DIMENSIONS SHALL NOT BE USED.
- 5. CONTRACTOR SHALL BE RESPONSIBLE FOR FIELD MEASUREMENTS AND VERIFICATION OF FIELD CONDITIONS PRIOR TO INSTALLATION OF WORK. ANY CHANGES IN WORK NECESSITATED BY FAILURE OF THE CONTRACTOR TO COMPLY WITH THIS PROVISION SHALL BE UNDERTAKEN BY THE CONTRACTOR AT HIS OWN EXPENSE.
- 6. ALL NECESSARY CUTTING AND PATCHING FOR WORK OF THIS CONTRACT SHALL BE BY THE CONTRACTOR. PRIOR TO PERFORMING ANY CHASING, CHOPPING OR CORE DRILLING, THE CONTRACTOR SHALL FIELD INVESTIGATE CONDITIONS AND COORDINATE WITH ALL APPROPRIATE TRADES TO ENSURE THAT WORK WILL BE IN HARMONY WITH OTHER WORK AND NOT AFFECT ANY EXISTING SYSTEMS. WORK ON EXISTING SYSTEMS MUST BE APPROVED BY THE OWNER PRIOR TO PROCEEDING.
- 7. CONTRACTOR SHALL COORDINATE WORK WITH OTHER TRADES FOR EXACT LOCATIONS OF ALL EQUIPMENT AND CONTROL DEVICES. LOCATIONS AS SHOWN ON ELECTRICAL DRAWINGS ARE APPROXIMATE.
- 8. OPENINGS AROUND ELECTRICAL PENETRATIONS THROUGH FIRE RESISTANCE RATED WALLS, PARTITIONS, FLOORS OR CEILINGS SHALL BE FIRE STOPPED USING APPROVED METHODS. SEALANT SHALL BE RATED FOR THREE (3) HOURS.
- 9. ALL EQUIPMENT, DEVICE BOXES, JUNCTION BOXES, PULLBOXES AND OUTLET BOXES SHALL BE INSTALLED SO AS TO ALLOW ACCESS TO THE COVER. IF NECESSARY AND APPROVED BY ENGINEER, PROVIDE ACCESS DOORS OR COVER PLATES IN AREAS WHERE UNOBSTRUCTED ACCESS IS NOT POSSIBLE.

ELECTRICAL SYMBOL LIST					
þ	MOTOR OR MOTORIZED EQUIPMENT				
ď	HEAVY DUTY FUSED DISCONNECT SWITCH, NEMA TYPE 3R FOR WET LOCATION. PROVIDE FUSES AS REQUIRED.				
PP-1 20A-1P	HOMERUN, TOP NUMBER INDICATES PANEL, BOTTOM NUMBER INDICATES BREAKER SIZE. WIRE IS $2\#12 \& 1\#12$ GND IN $3/4$ °C UNLESS NOTED OTHERWISE.				
	JUNCTION BOX SIZED AS REQUIRED BY NEC				
S	LIGHT SWITCH, HUBBELL HBL1221, SUBLETTER "3" INDICATES 3-WAY, SUBLETTER "PL" INDICATES PILOT LIGHT. SUBLETTER "M" INDICATES MOTION SENSOR, SUBLETTER "EPO" INDICATES EMERGENCY POWER OFF, SUBLETTER "PB" INDICATES PUSHBUTTON, SUBLETTER "TM" INDICATES TIMER SWITCH (WATTSTOPPER # TS-200), MOUNT SWITCHES AT 48" AFF UNLESS NOTED OTHERWISE				
	120/208V PANELBOARD				
	drawing title ELECTRICAL LOW/ED LEVEL DLAN				

LC	 EVEL PLAN	DEPARTMENT	DEPARTMENT OF ADMINISTRATIVE SERVICES	
mark	 description	drawing prepared by	PROGRESSIV ENGINEERING, INC 290 BURNSIDE AVENUE, EAST HARTFORD, CT TEL: 860.895.8385 FAX: 860.895.8	
		Project LOWER GAF RAMP REST 505 HUDSON ST HARTFORD, CT	ORATION REET	drawn by BBO approved by BBO drawing no.
		CAD no. 16016 E-2.dwg	project no. BI-2B-438	E1.01