STATE OF CONNECTICIJ


GOVERNOR NED LAMONT

DEPARTMENT OF ADMINISTRATIVE SERVICES JOSH GEBALLE COMMISSIONER



CONSULTING ARCHITECT/ STRUCTURAL ENGINEER LEAVITT ASSOCIATES INC. **1514 BEACON STREET** BROOKLINE, MA 02446 617-823-3926




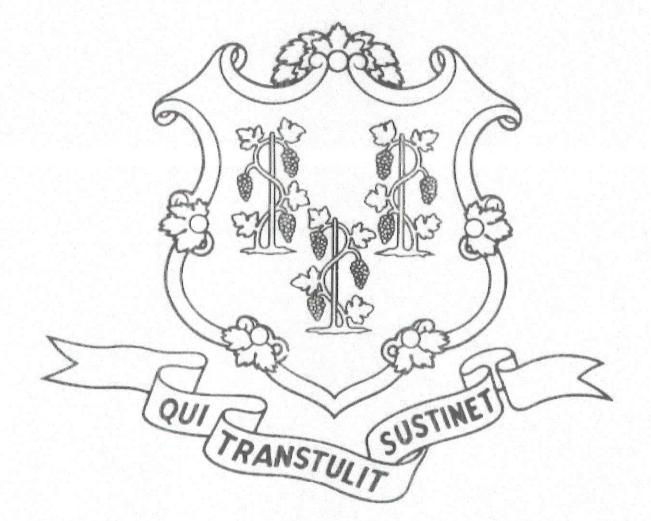


SOUTHERN CONNECTICUT STATE UNIVERSITY JOE BERTOLINO PRESIDENT

SCSU RESIDENCE HALL SHELF ANGLE REPAIRS SCSU, NEW HAVEN PROJECT NO.: CF-RS-358

ARCHITECT CHRISTOPHER WILLIAMS ARCHITECTS LLC 85 WILLOW STREET, BUILDING 54 **NEW HAVEN, CT, 06511** 203-776-0184

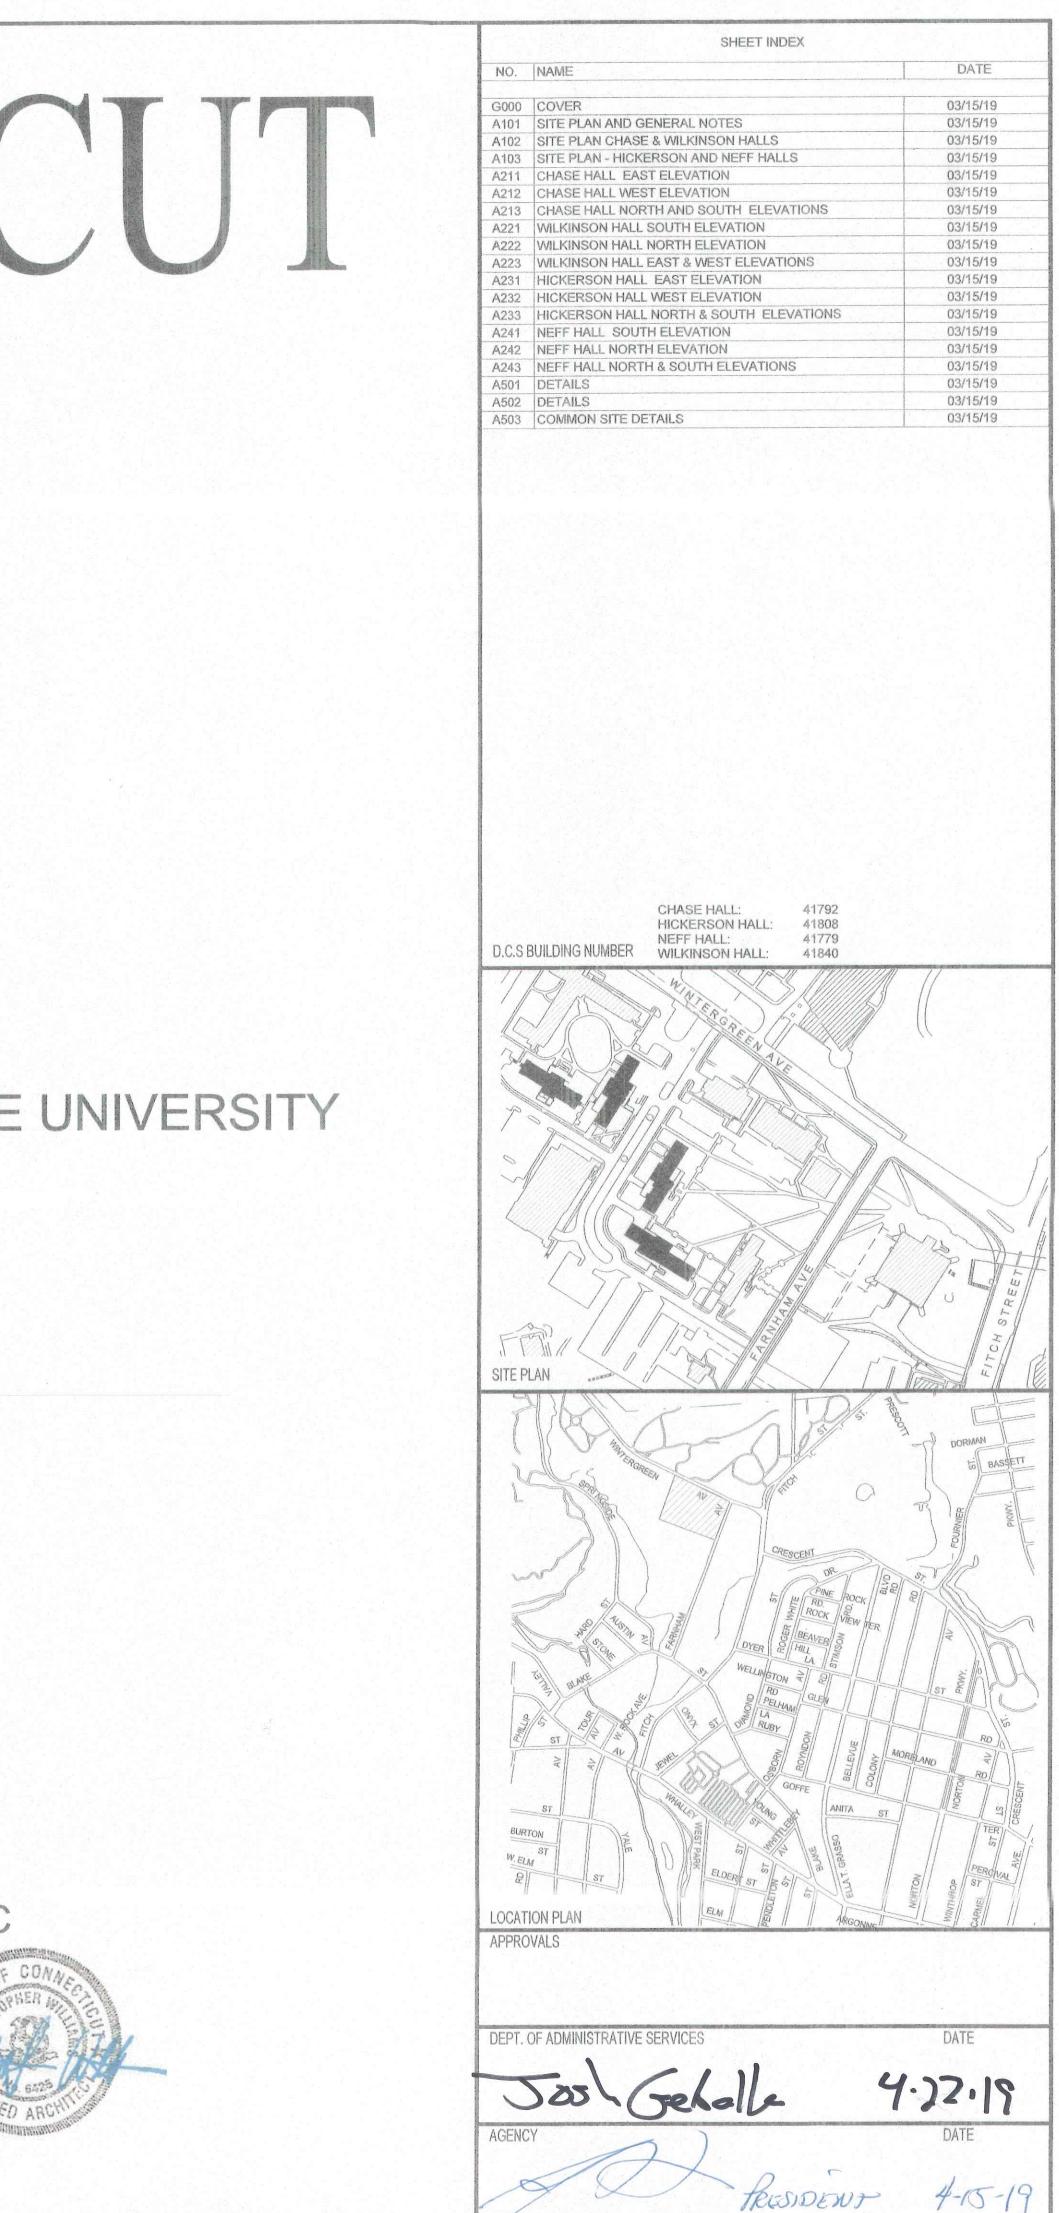

4/11/2019 9:39:08 AM

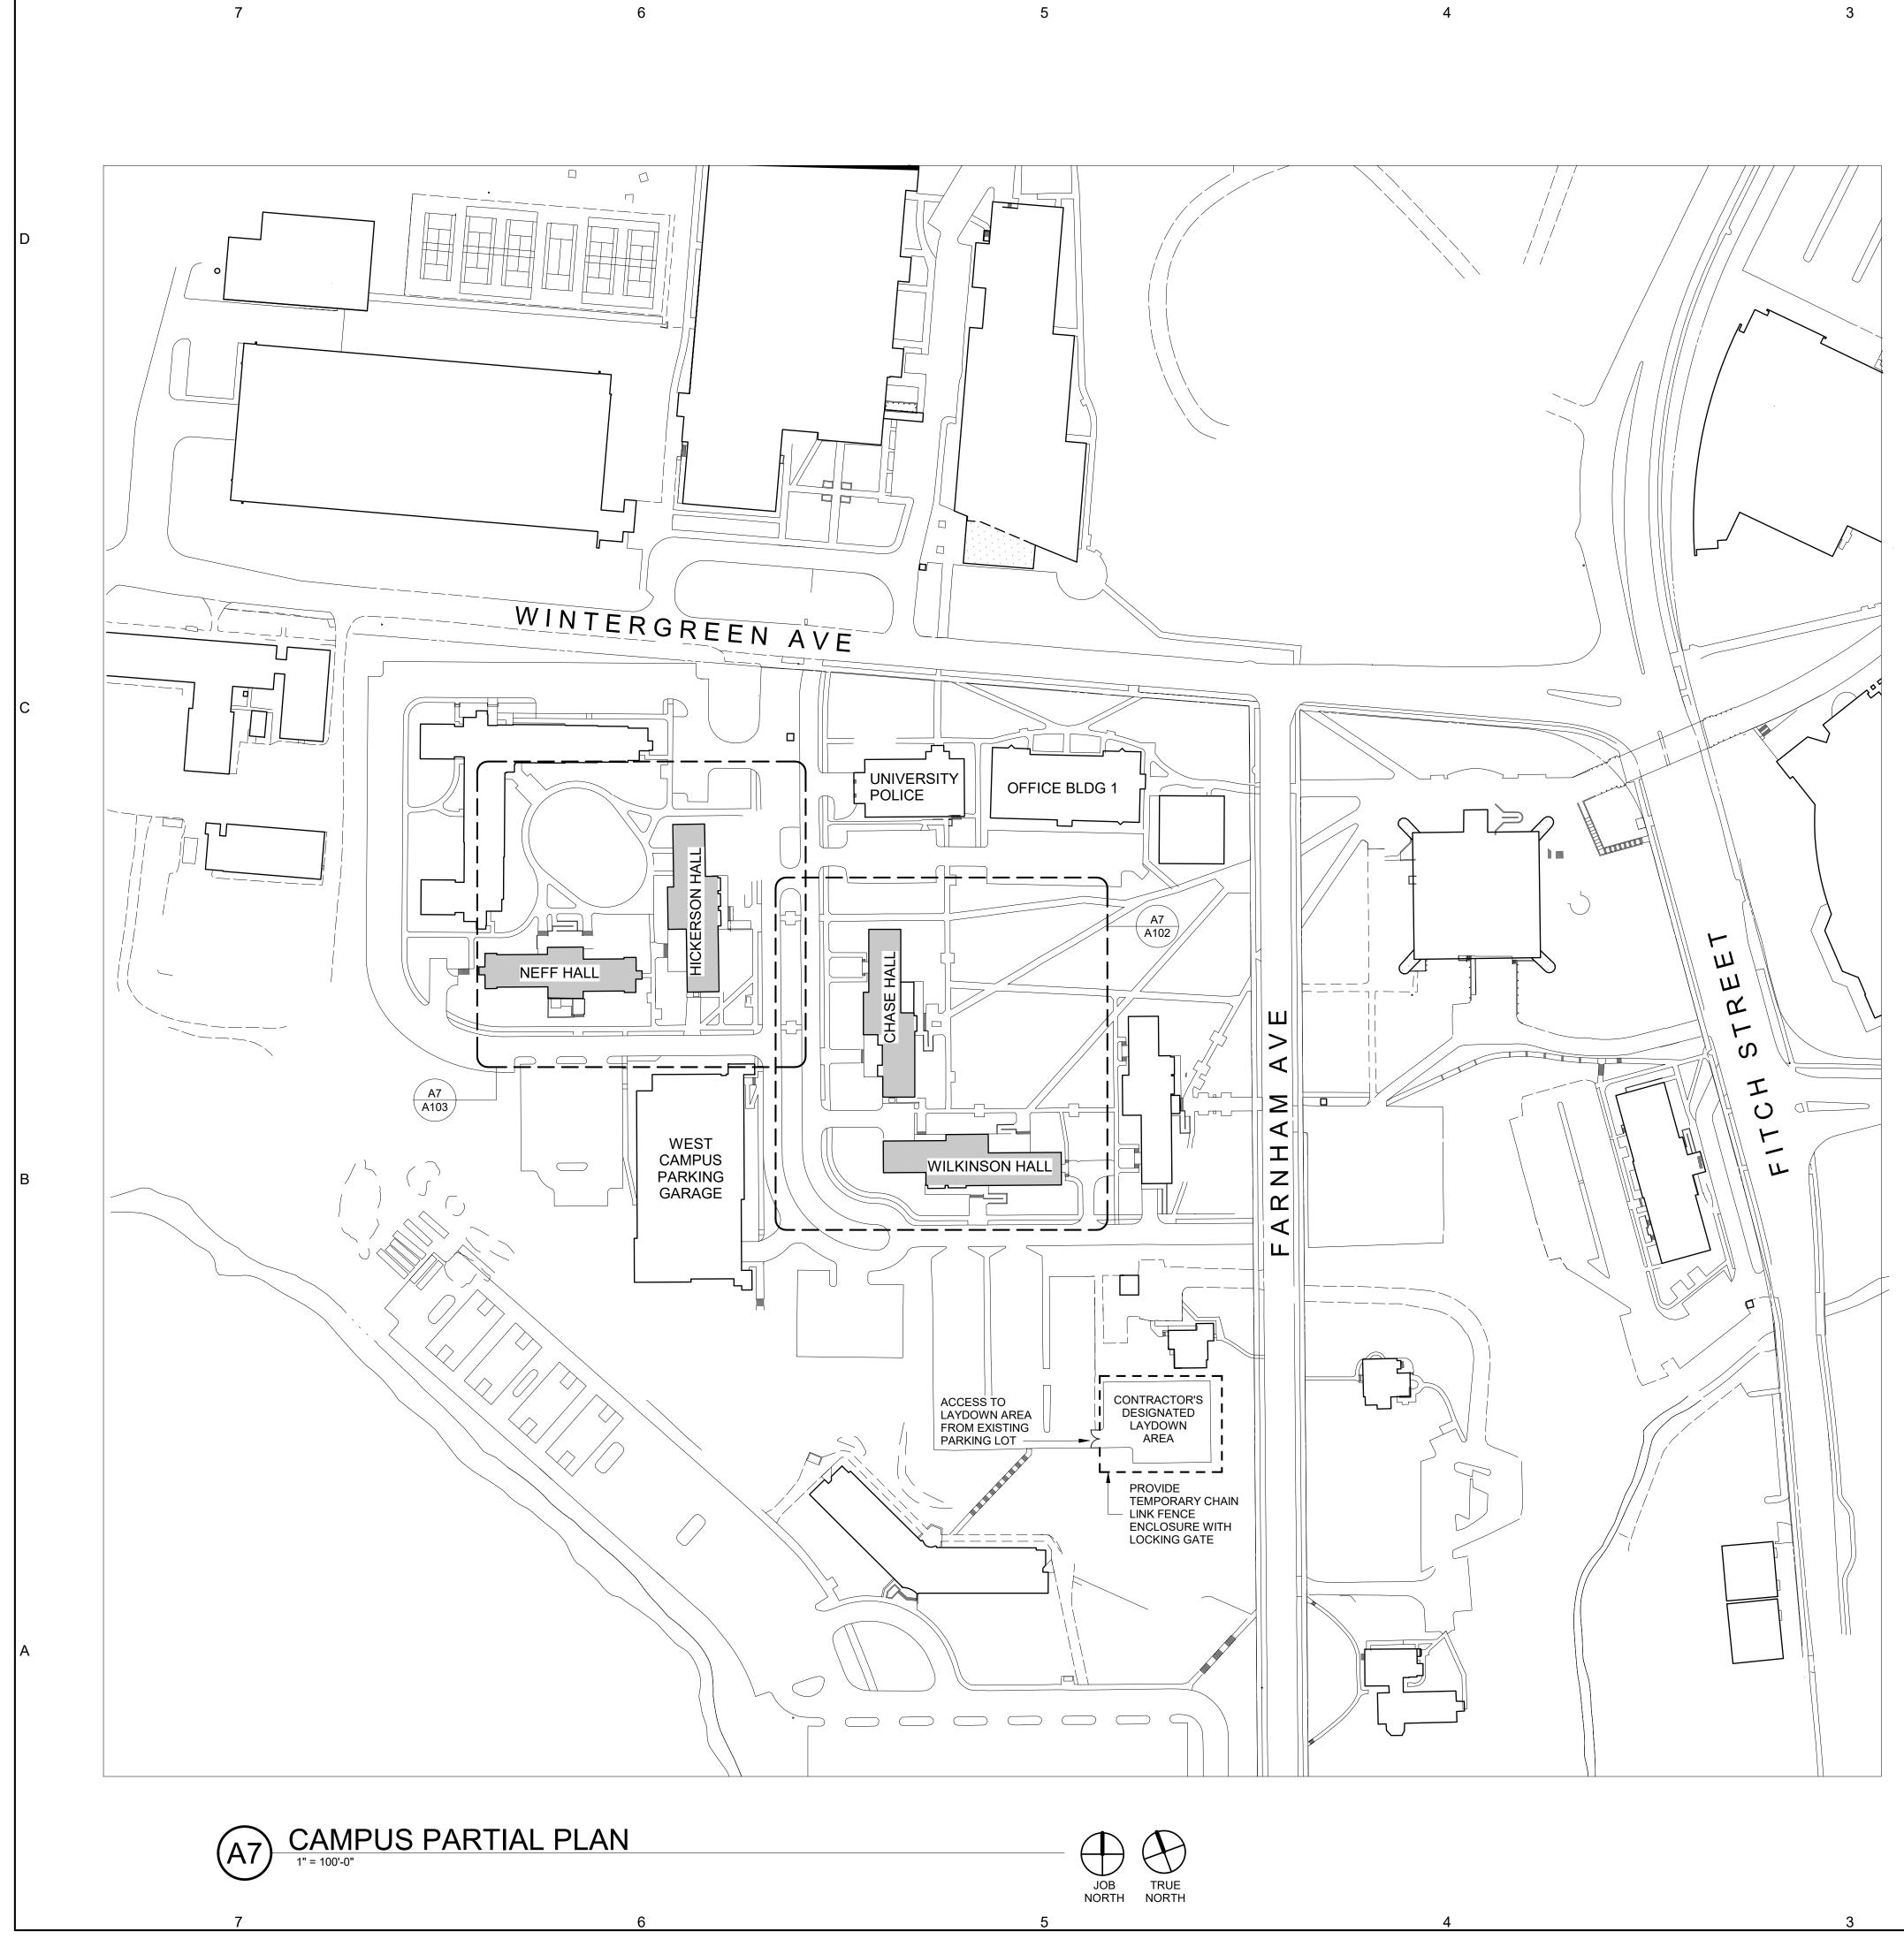

PROJECT DESCRIPTION


2

1

| 1. | REPLACEMENT OF SHELF ANGLES SUPPORTING BRICK VENEER AT 4 DORMITORIES AT SOUTHERN CONNECTICUT STATE UNIVERSITY THE WORK ALSO INCLUDES ADDING SOLAR FILM TO THE INSIDE FACES OF WINDOWS AT EACH BUILDING |
|----------------|---|
| 2. | THE WORK WILL BE EXECUTED IN 2 PHASES EACH INVOLVING 2 BUILDINGS |
| | PHASE 1: CHASE AND WILKINSON HALLS PHASE 2: HICKERSON AND NEFF HALLS |
| 3. GE 1. | THE BUILDINGS WILL BE OCCUPIED DURING THE ENTIRE DURATION OF CONSTRUCTION, PROVISION SHALL BE MADE TO PROVIDE ACCESS AND MAINTAIN ALL EXITS WHILE THE BUILDINGS ARE OCCUPIED. PRIVACY FILM SHALL BE INSTALLED ON ALL WINDOWS EXCEPT FOR THOSE SPECIFICALLY NOTED IN THE SPECIFICATIONS. THE CONTRACTOR SHALL FIELD VERIFT ALL DIMENSIONS AND CONDITIONS OF THE SITE AND OR BUILDING AND INFORM THE ARCHITECT IMMEDIATELY OF ANY DISCREPANCIES. DIMENSIONS SHOWN ON THE DRAWINGS ARE TO ESTABLISH RELATIVE RELATIONSHIPS. THEY ARE BASED ON AVAILABLE INFORMATION PROVIDED BY SCSU AND OBSERVATIONS BY THE ARCHITECT AND MUST BE VERIFIED BEFORE ORDERING MATERIALS OR DOING ANY WORK. DO NOT SCALE DRAWINGS. |
| 2. | THE CONTRACTOR SHALL PERFORM ALL WORK IN CONFORMANCE WITH ALL APPLICABLE REQUIREMENTS OF THE STATE OF CONNECTICUT BUILDING CODE AND FIRE SAFETY CODE, AS WELL AS ALL APPLICABLE FEDERAL AND STATE REGULATIONS AND REQUIREMENTS |
| 3. | BUILDINGS AND GROUNDS WILL BE OCCUPIED BY THE OWNER DURING THE WORK. SAFEGUARD PERSONNEL AND BUILDING OCCUPANTS |
| 4. | MAINTAIN ACCESS TO ALL ENTRANCES OF ALL BUILDINGS AND MAINTAIN ALL ACCESSIBLE ROUTES EXCEPT WHERE GIVEN EXPLICIT PERMISSION TO DO OTHERWISE BY THE OWNER. |
| 5. | THE CONTRACTOR'S OPERATIONS SHALL BE CONFINED TO WITHIN WORK ZONES AND LAYDOWN SPACES. WITHIN THE WORK ZONES, KEEP WORK AND STOCKPILE AREAS CLEAN. |
| 6. | MAINTAIN TRAFFIC AND PEDESTRIAN WAYS CLEAR OF CONSTRUCTION AT ALL TIMES. COORDINATE WORK AREAS AND BARRIERS WITH OWNER. |
| 7. | WITHIN THE LIMITS OF THE SITE THERE ARE EXISTING UTILITIES BELOW GROUND. THE CONTRACTOR SHALL COORDINATE WITH "CALL BEFORE YOU DIG" AND MAKE HIS OWN SURVEY TO VERIFY THE LOCATIONS OF ALL UTILITIES POTENTIALLY EFFECTED BY THE WORK PRIOR TO BREAKING GROUND. ALL UTILITIES ARE TO BE MAINTAINED AND PROTECTED DURING THE EXECUTION OF THE WORK. |
| 8. | THE BUILDINGS SHALL BE KEPT WATERTIGHT DURING THE EXECUTION OF THE WORK. |
| 9. | THE CONTRACTOR SHALL ADEQUATELY BRACE AND PROTECT ALL WORK DURING CONSTRUCTION TO PREVENT DAMAGE, COLLAPSE OR DISTORTION OF EXISTING AND NEW WORK. |
| 10. | LANDSCAPING, SITE FURNISHINGS, FIXTURES, PAVINGS, SITE STAIRS ETC. DESIGNATED TO REMAIN SHALL BE PROTECTED DURING THE EXECUTION OF THE WORK. |
| 11. | ALL BUILDING MOUNTED EQUIPMENT, FIXTURES AND DEVICES SHALL BE PROTECTED DURING THE EXECUTION OF THE WORK. |
| 12. | THE CONTRACTOR SHALL PROVIDE NOISE, FUME. ODOR AND DUST CONTROL DURING THE EXECUTION OF THE WORK. THE CONTRACTOR SHALL PROVIDE TEMPORARY BARRIERS TO CONTAIN ALL DUST, DIRT AND DEBRIS WITHIN THE CONTRACT AREA AND OUT OF OTHER OCCUPIED AND UNOCCUPIED AREAS |
| 13. | DEBRIS AND REFUSE SHALL BE REMOVED FROM THE SITE AT THE END OF EACH WORK DAY. |
| CONN | A MENDMENTS TO THE 2015 INTERNATIONAL EVERTAL CODE A MENDMENTS TO THE 2015 INTERNATIONAL BUILDING CODE B. AMENDMENTS TO THE 2015 INTERNATIONAL BUILDING CODE B. AMENDMENTS TO THE 2015 INTERNATIONAL EXISTING BUILDING CODE C. AMENDMENTS TO THE 2015 INTERNATIONAL EXISTING BUILDING CODE C. AMENDMENTS TO THE 2015 INTERNATIONAL PLUMBING CODE E. AMENDMENTS TO THE 2015 INTERNATIONAL PLUMBING CODE E. AMENDMENTS TO THE 2015 INTERNATIONAL PLUMBING CODE E. AMENDMENTS TO THE 2015 INTERNATIONAL RECHANICAL CODE F. AMENDMENTS TO THE 2015 INTERNATIONAL ENERGY CONSERVATION CODE G. AMENDMENTS TO THE 2017 NFPA 70, NATIONAL ENERGY CONSERVATION CODE H. AMENDMENTS TO THE 2017 NFPA 70, NATIONAL ENERGY CONSERVATION CODE H. AMENDMENTS TO THE INTERNATIONAL ESIDENTIAL CODE INTERNATIONAL BUILDING CODE - 2015 INTERNATIONAL EXISTING BUILDING CODE - 2015 INTERNATIONAL PLUMBING CODE - 2015 INTERNATIONAL PLUMBING CODE - 2015 INTERNATIONAL PLUMBING CODE - 2015 INTERNATIONAL PLUMBING CODE - 2015 |
| | NATIONAL ELECTRIC CODE (NFPA 70) - 2017 ICC/ANSI A117.1-ACCESSIBLE AND USABLE BUILDINGS AND FACILITIES 2009. |
| | NECTICUT FIRE SAFETY CODE - 2018 CT AMENDMENTS - 2018 INTERNATIONAL FIRE SAFETY CODE - 2015 NFPA 101 - 2015 |
| | NECTICUT FIRE PREVENTION CODE - 2018 CT AMENDMENTS - 2018 NFPA 1 2015 |
| οςςι | JPATIONAL SAFETY AND HEALTH ADMINISTRATION (OSHA) OSHA 29 CFR PART 1910 OCCUPATIONAL SAFETY AND HEALTH REGULATIONS OSHA 29 CFR PART 1926 OCCUPATIONAL SAFETY AND HEALTH REGULATIONS FOR CONSTRUCTION- |
| | OF CONNECTION |
| | OF CONACCE |
| | drawing title SITE PLAN AND GENERAL NOTES REVISIONS |
| | SITE PLAN AND GENERAL NOTES STATE OF CONNECTICUT DEPARTMENT OF ADMINISTRATIVE SERVICES |

| | | ew Haven, CT 06511 | 1" = 100'-0" |
|--|-------------------------|--------------------------|-------------------|
| | project SCSU RESIDEN | CE HALL SHELF ANGLE | drawn by DL |
| | REPAIRS SCSU, NEW HA | VEN. CT | approved by CW |
| | | · | drawing no. |
| | CAD no. Checker | project no. CF-RS-358 | A101 |
| | | | |

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| SITE LOGISTICS/TEMPORARY |
|--------------------------|
| FACILITIES GENERAL NOTES |

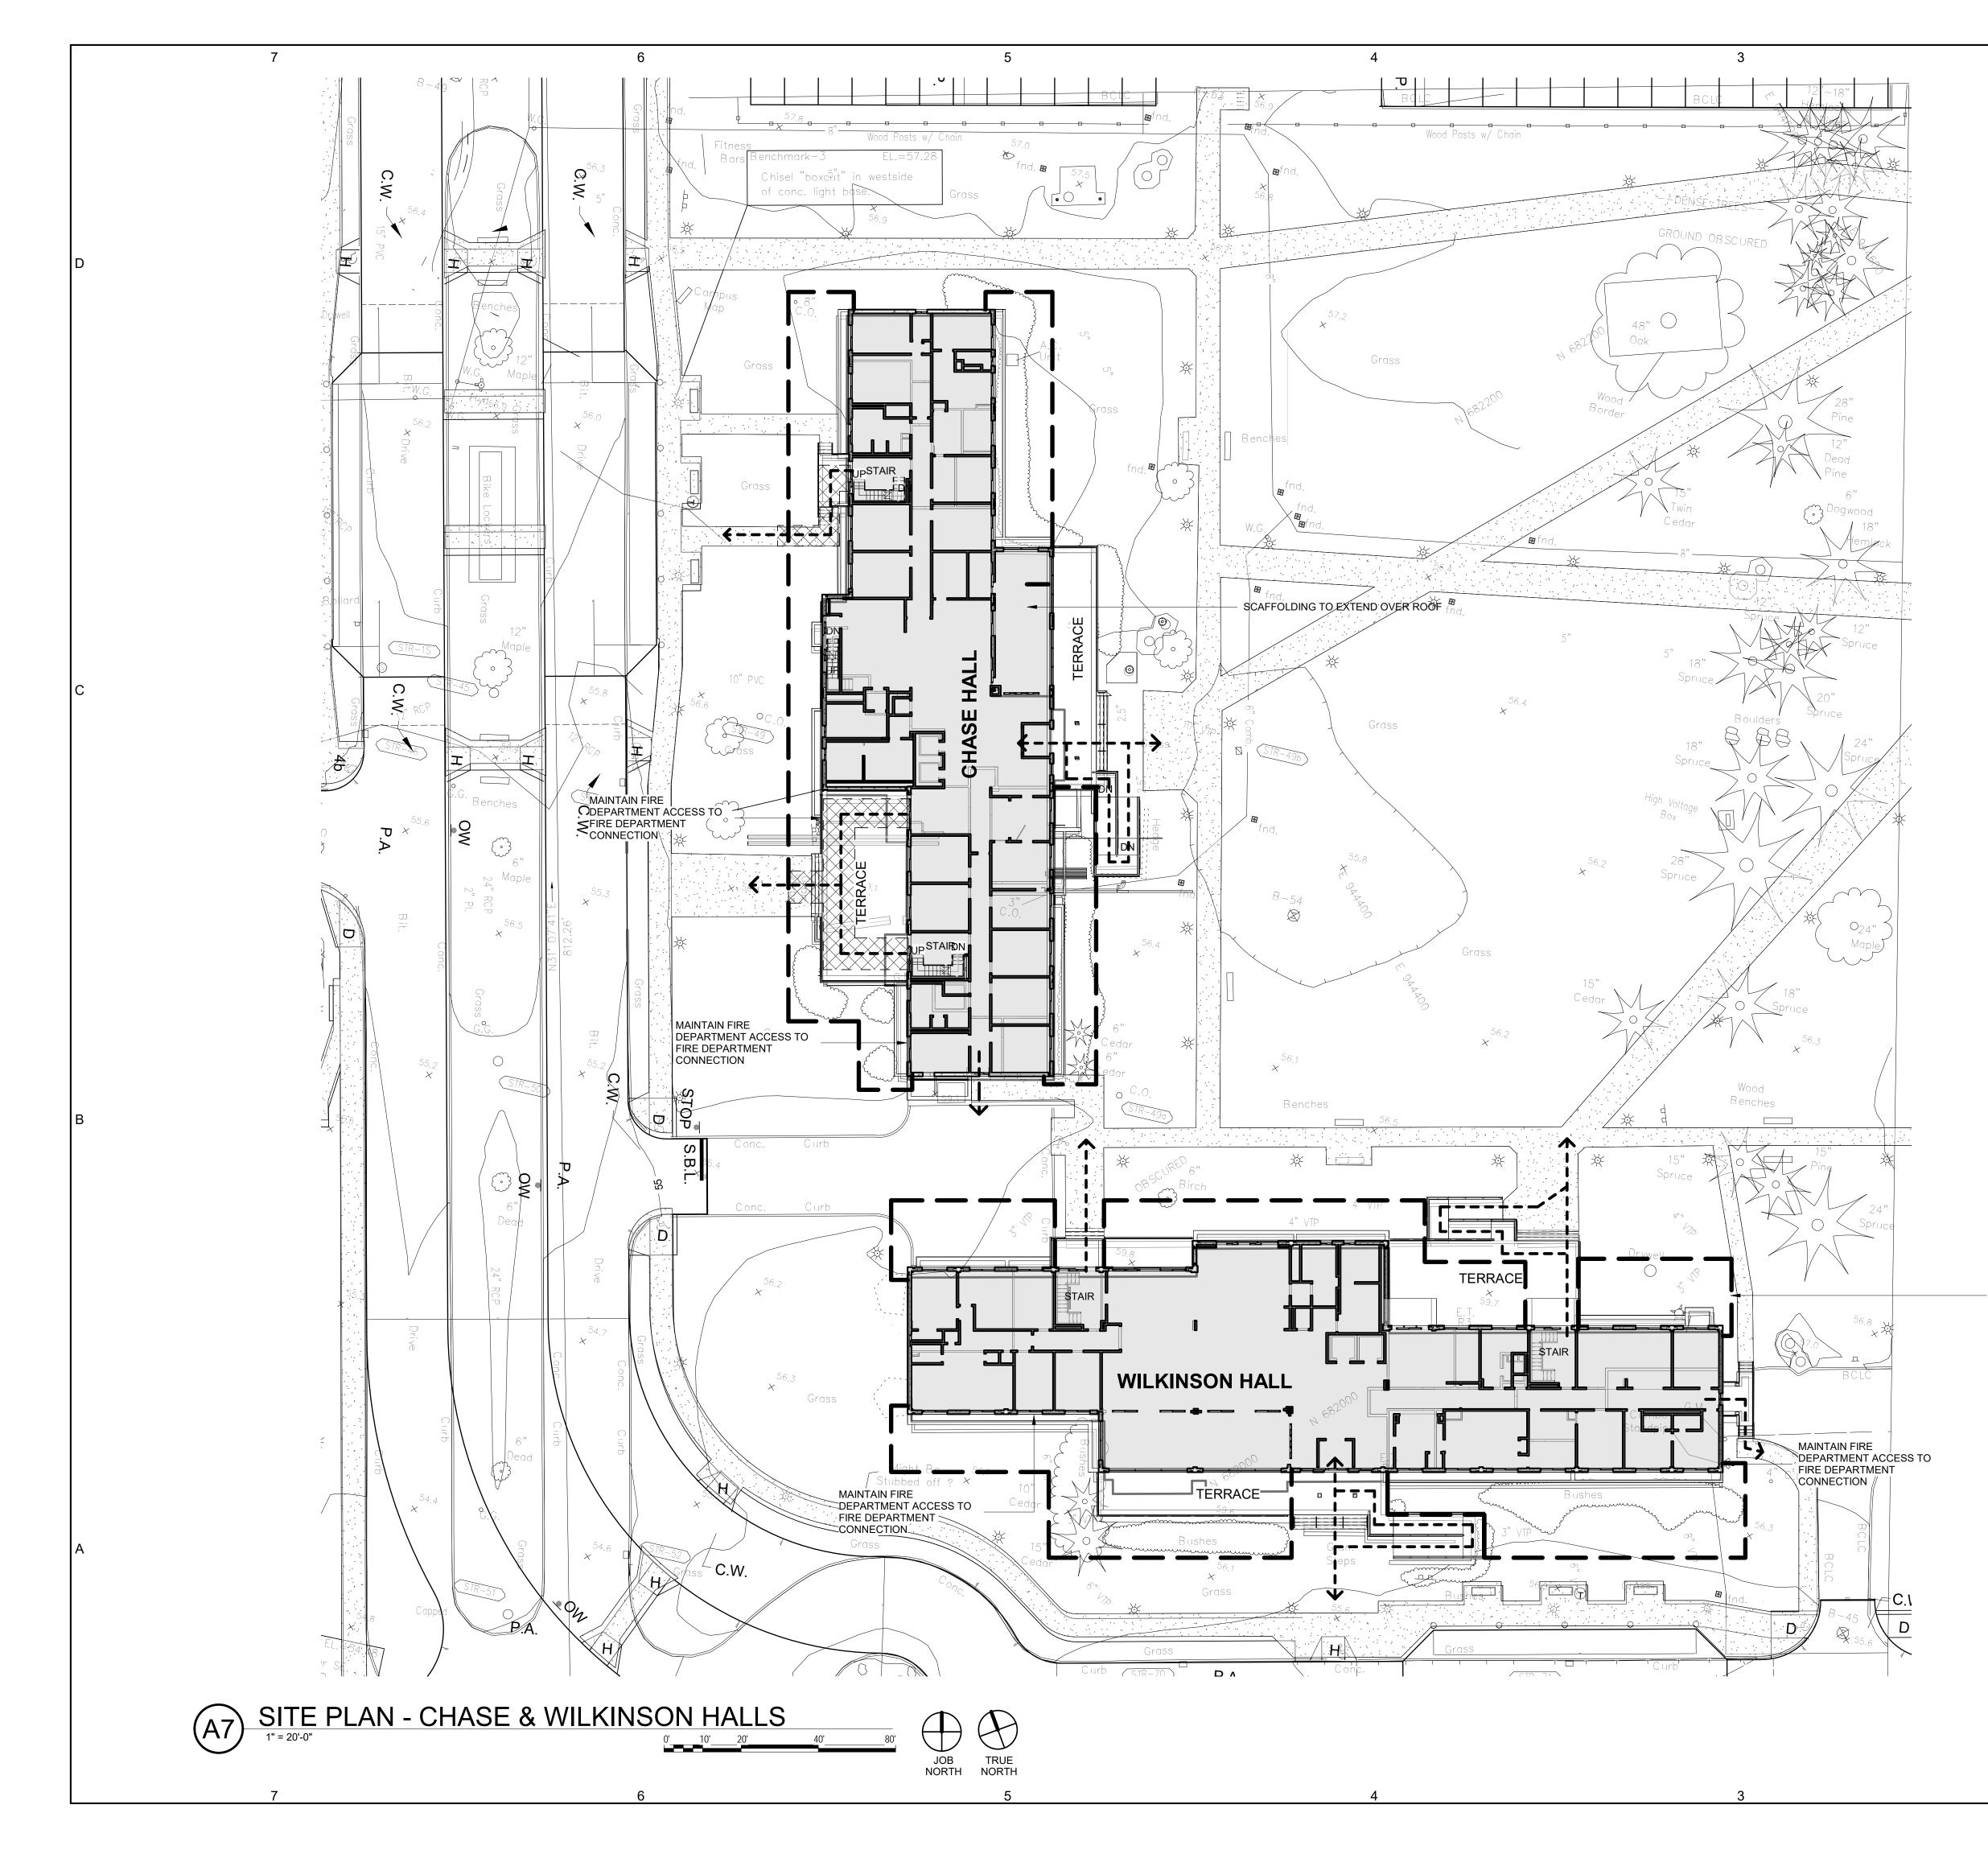- THE CONTRACTOR WILL SUBMIT A LOGISTICS 1. PLAN TO THE UNIVERSITY FOR APPROVAL BEFORE COMMENCING WORK. THE PLAN SHALL SHOW PROPOSED:
 - A. LOCATIONS OF CONSTRUCTION FENCE AND GATE LOCATIONS
 - B. SCAFFOLDING LOCATIONS
 - ROUTES AND PROTECTION OF BUILDING C. ENTRANCES
 - D. TREE AND PLANT PROTECTION
 - EROSION AND SEDIMENT CONTROLS LOCATIONS OF DUMPSTER, PORTABLE TOILETS, DEDICATED CONSTRUCTION PARKING ETC.

THE LOGISTIC PLAN SHALL CLEARLY SHOW PROPOSED LAYOUT CHANGES FOR EACH PHASE OF THE PROJECT

- PROVIDE TEMPORARY 6-FT HIGH 2. CONSTRUCTION FENCE. THE CONSTRUCTION FENCE SHALL HAVE LOCKING GATES TO KEEP CONSTRUCTION AREAS SECURE AT ALL TIMES. LOCATE GATES TO SUIT CONTRACTOR, AS SHOWN ON CONTRACTOR'S SUBMITTED LOGISTICS PLAN AND APPROVED BY OWNER.
- MAINTAIN ACCESS TO FIRE DEPARTMENT 3. CONNECTIONS AT BUILDING BY PROVIDING TEMPORARY KNOX BOXES CONTAINING KEYS TO GATES AT ALL APPLICABLE GATES.
- 4. ALL SCAFFOLD ACCESS TO BE ENCLOSED WITH PLYWOOD ON ALL SIDES AND SECURED WITH LOCKED GATES AT ALL TIMES WHEN NOT IN USE.
- MAINTAIN MINIMUM 6-FT WIDE ACCESS/EGRESS 5. TO MAIN ENTRIES AND 5-FT WIDE ACCESS/EGRESS TO ALL OTHER DORMITORY DOORS WHEN BUILDINGS ARE OCCUPIED. PROVIDE OVERHEAD AND SIDE PROTECTION WHERE ENTRY/EGRESS PATHS PASS UNDER SCAFFOLDING.

CONSTRUCTION FENCE TO ENCLOSE SCAFFOLDING

-----EXIT/EGRESS PATH

PROTECTED EGRESS PATH FROM BUILDING EXIT THROUGH AREA ENCLOSED BY CONSTRUCTION FENCE. MINIMUM WIDTH 6-FT AT MAIN ENTRANCES, 5-FT AT OTHER EGRESS PATHS

GENERAL SHEET NOTES

- SURVEY INFO IS BASED ON VARIOUS MAPS 1. PROVIDED BY SCSU AND VISUAL SITE INSPECTIONS. ACTUAL SITE CONDITIONS WERE OBSERVED TO VARY FROM THE MAPS, INCLUDING, BUT ARE NOT LIMITED TO, ADDITIONAL PLANTINGS, SITE IMPROVEMENTS (BIKE RACKS, RECYCLING BINS, ETC.), WALKWAYS. EVERY EFFORT HAS BEEN MADE TO INCLUDE THESE VARIATIONS IN THESE DRAWINGS, HOWEVER FIELD VERIFICATION DURING CONSTRUCTION IS NECESSARY.
- 2. ALL UTILITY DEPTHS AND LOCATIONS MUST BE FIELD VERIFIED.


PROVIDE LOCKED/SECURED GATES THROUGH CONSTRUCTION FENCE WHERE REQUIRED BY CONTRACTOR AND APPROVED BY OWNER (TYPICAL)

2



| drawing title SITE PLAN CHASE & WILKINSON HALLS | | | STATE OF CONNECTICUT DEPARTMENT OF ADMINISTRATIVE SERVICES | | |
|---|------|-------------|---|--------------------------|----------------------------------|
| | F | REVISIONS | | | |
| mark | date | description | drawing prepared by CHRISTOPHEF | WILLIAMS ARCHITECTS | date 03/15/19 |
| | | | 85 Willow Street, Building 54 New Haven, CT 06511 | | ^{scale} As indicated |
| Project SCSU RESIDENCE HALL SH REPAIRS | | | drawn by DL | | |
| | | | SCSU RESIDEN REPAIRS | approved by CW | |
| | | | | | drawing no. |
| | | | CAD no. Checker | project no. CF-RS-358 | A102 |

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SITE LOGISTICS/TEMPORARY FACILITIES GENERAL NOTES

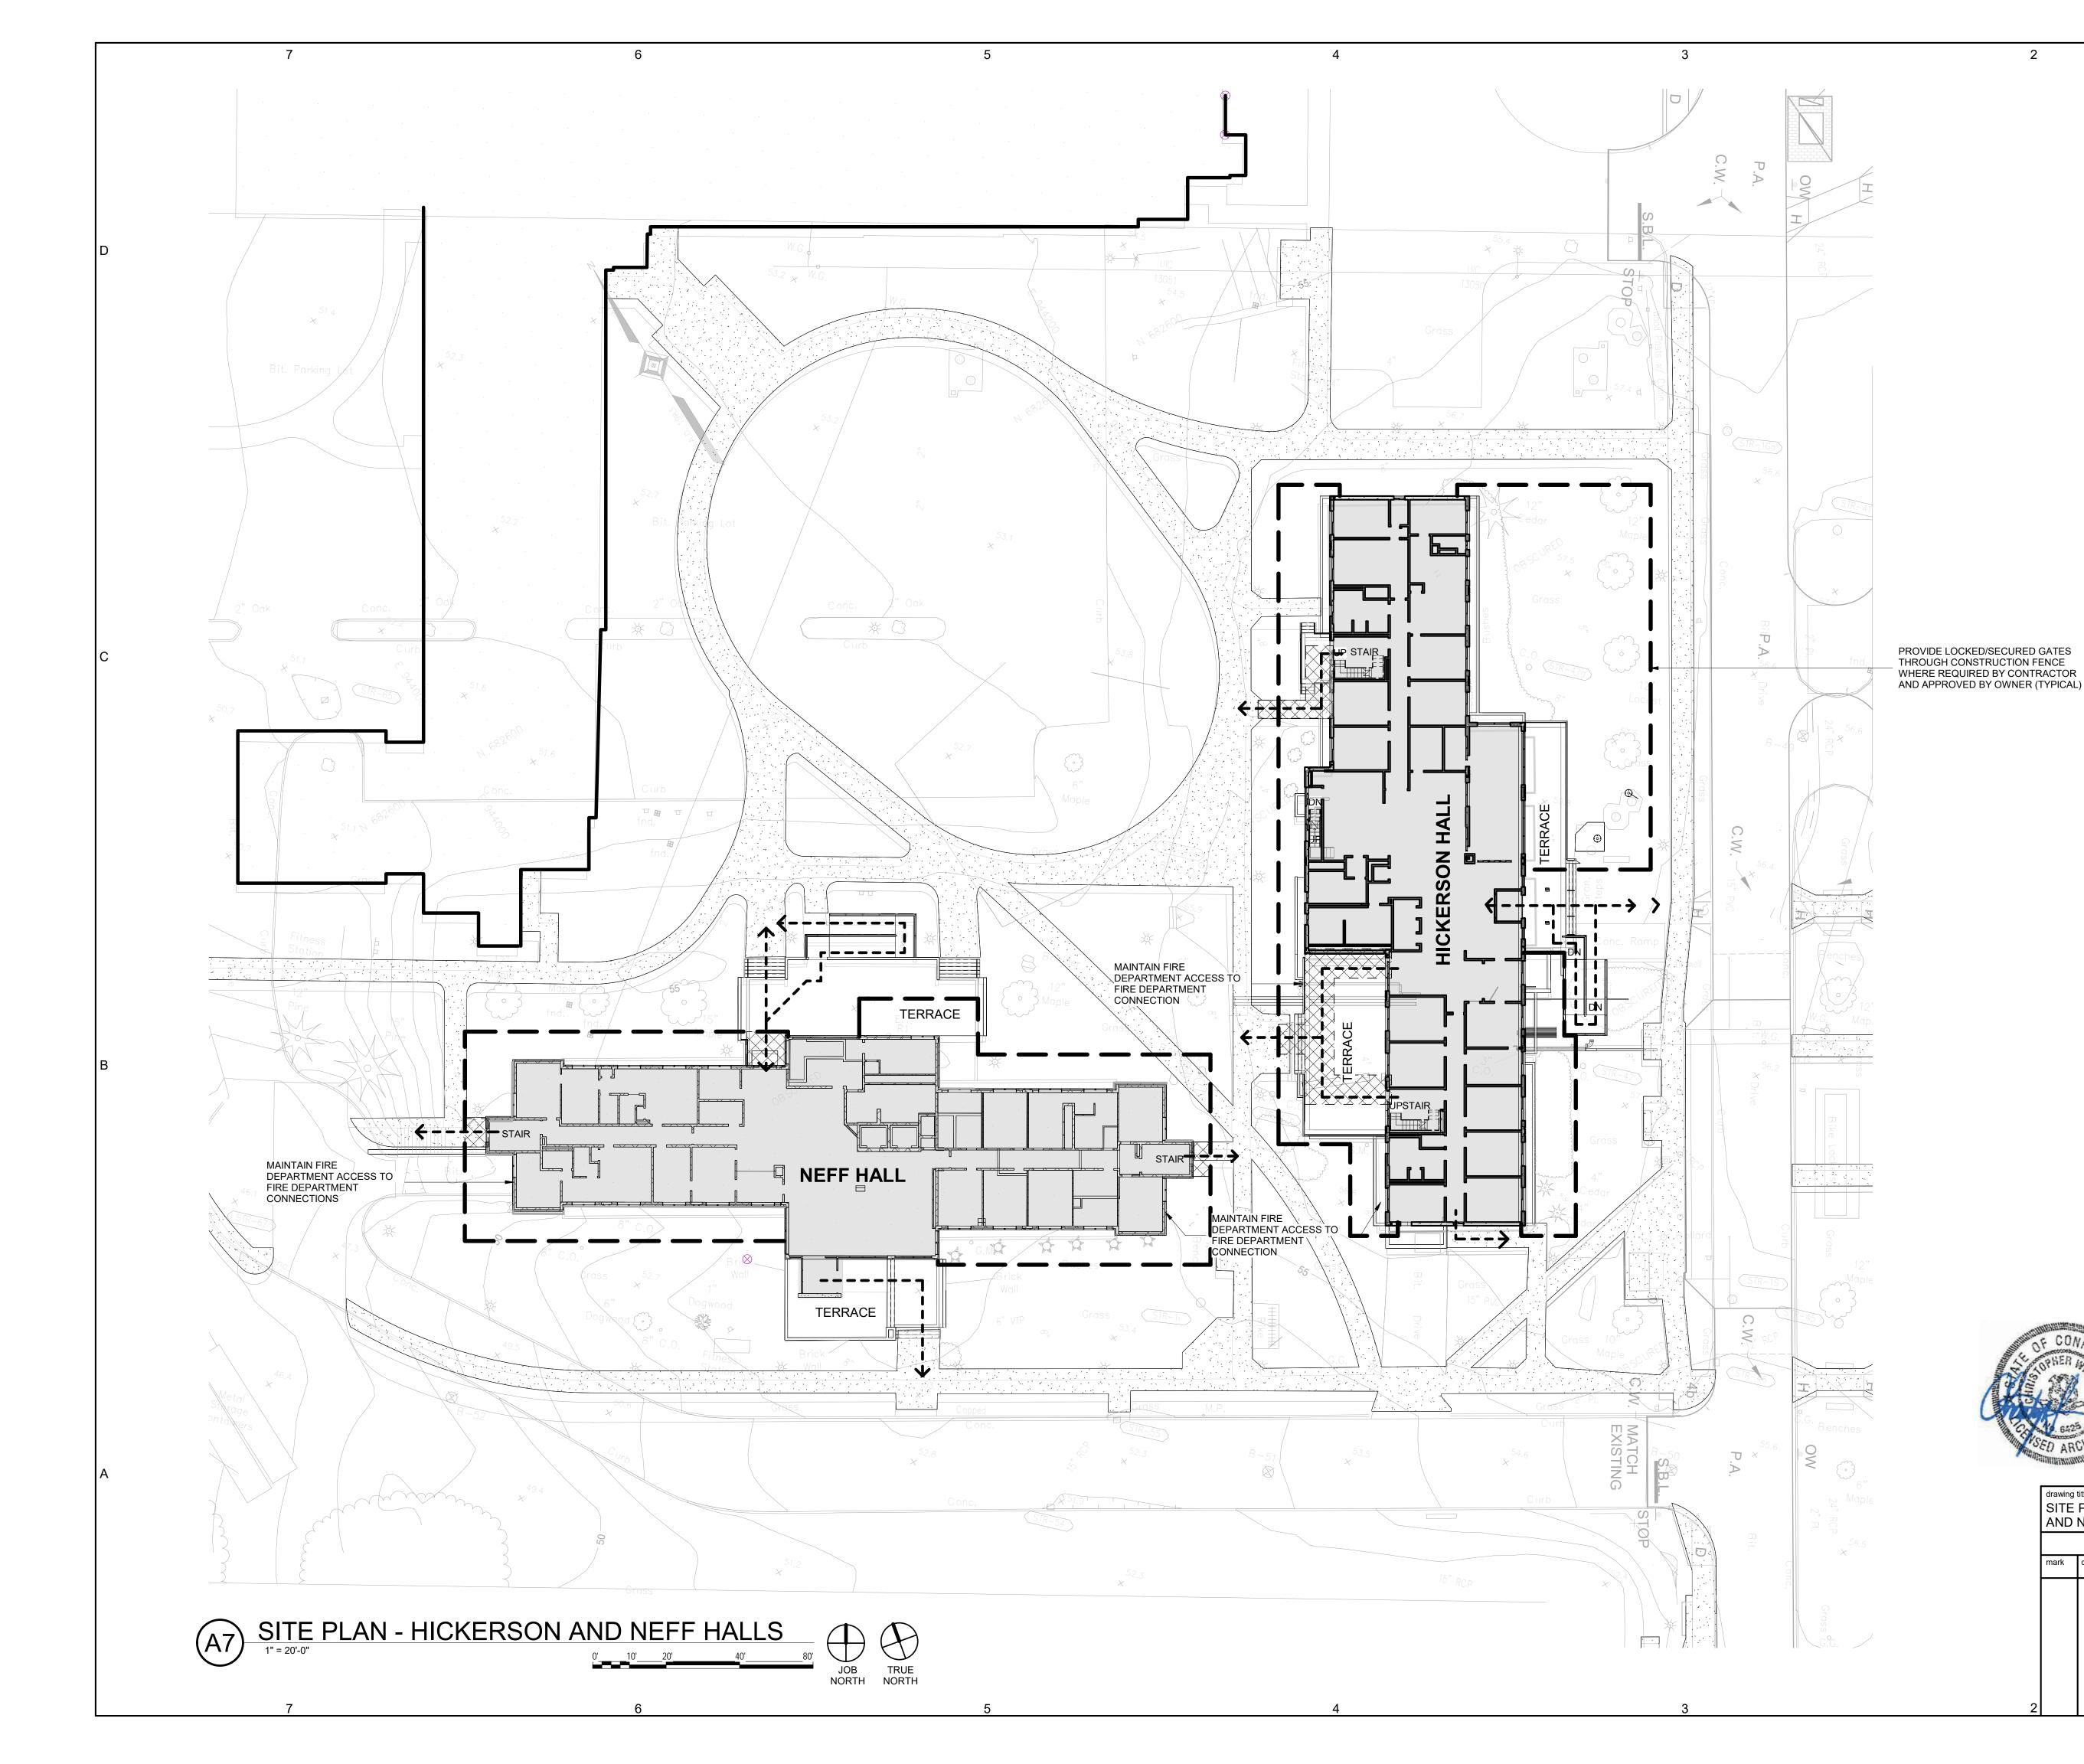- THE CONTRACTOR WILL SUBMIT A LOGISTICS PLAN TO THE UNIVERSITY FOR APPROVAL 1. BEFORE COMMENCING WORK. THE PLAN SHALL SHOW PROPOSED:
 - A. LOCATIONS OF CONSTRUCTION FENCE AND GATE LOCATIONS
 - SCAFFOLDING LOCATIONS Β.
 - ROUTES AND PROTECTION OF BUILDING C. ENTRANCES
 - D. TREE AND PLANT PROTECTION
 - EROSION AND SEDIMENT CONTROLS Ε.
 - LOCATIONS OF DUMPSTER, PORTABLE TOILETS, DEDICATED CONSTRUCTION PARKING ETC.

THE LOGISTIC PLAN SHALL CLEARLY SHOW PROPOSED LAYOUT CHANGES FOR EACH PHASE OF THE PROJECT

- PROVIDE TEMPORARY 6-FT HIGH 2. CONSTRUCTION FENCE. THE CONSTRUCTION FENCE SHALL HAVE LOCKING GATES TO KEEP CONSTRUCTION AREAS SECURE AT ALL TIMES. LOCATE GATES TO SUIT CONTRACTOR, AS SHOWN ON CONTRACTOR'S SUBMITTED LOGISTICS PLAN AND APPROVED BY OWNER.
- MAINTAIN ACCESS TO FIRE DEPARTMENT 3 CONNECTIONS AT BUILDING BY PROVIDING TEMPORARY KNOX BOXES CONTAINING KEYS TO GATES AT ALL APPLICABLE GATES.
- 4. ALL SCAFFOLD ACCESS TO BE ENCLOSED WITH PLYWOOD ON ALL SIDES AND SECURED WITH LOCKED GATES AT ALL TIMES WHEN NOT IN USE.
- MAINTAIN MINIMUM 6-FT WIDE ACCESS/EGRESS 5. TO MAIN ENTRIES AND 5-FT WIDE ACCESS/EGRESS TO ALL OTHER DORMITORY DOORS WHEN BUILDINGS ARE OCCUPIED. PROVIDE OVERHEAD AND SIDE PROTECTION WHERE ENTRY/EGRESS PATHS PASS UNDER SCAFFOLDING.


CONSTRUCTION FENCE TO ENCLOSE SCAFFOLDING

EXIT/EGRESS PATH

PROTECTED EGRESS PATH FROM BUILDING EXIT THROUGH AREA ENCLOSED BY CONSTRUCTION FENCE. MINIMUM WIDTH 6-FT AT MAIN ENTRANCES, 5-FT AT OTHER EGRESS PATHS


GENERAL SHEET NOTES

- SURVEY INFO IS BASED ON VARIOUS MAPS PROVIDED BY SCSU AND VISUAL SITE INSPECTIONS. ACTUAL SITE CONDITIONS WERE OBSERVED TO VARY FROM THE MAPS, INCLUDING, BUT ARE NOT LIMITED TO, ADDITIONAL PLANTINGS, SITE IMPROVEMENTS (BIKE RACKS, RECYCLING BINS, ETC.), WALKWAYS. EVERY EFFORT HAS BEEN MADE TO INCLUDE THESE VARIATIONS IN THESE DRAWINGS, HOWEVER FIELD VERIFICATION DURING CONSTRUCTION IS NECESSARY.
- ALL UTILITY DEPTHS AND LOCATIONS MUST BE FIELD VERIFIED.

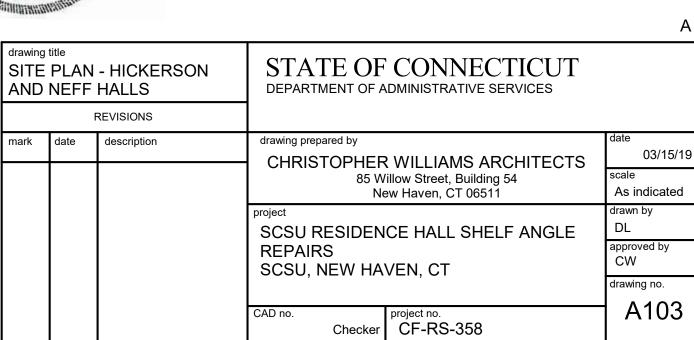


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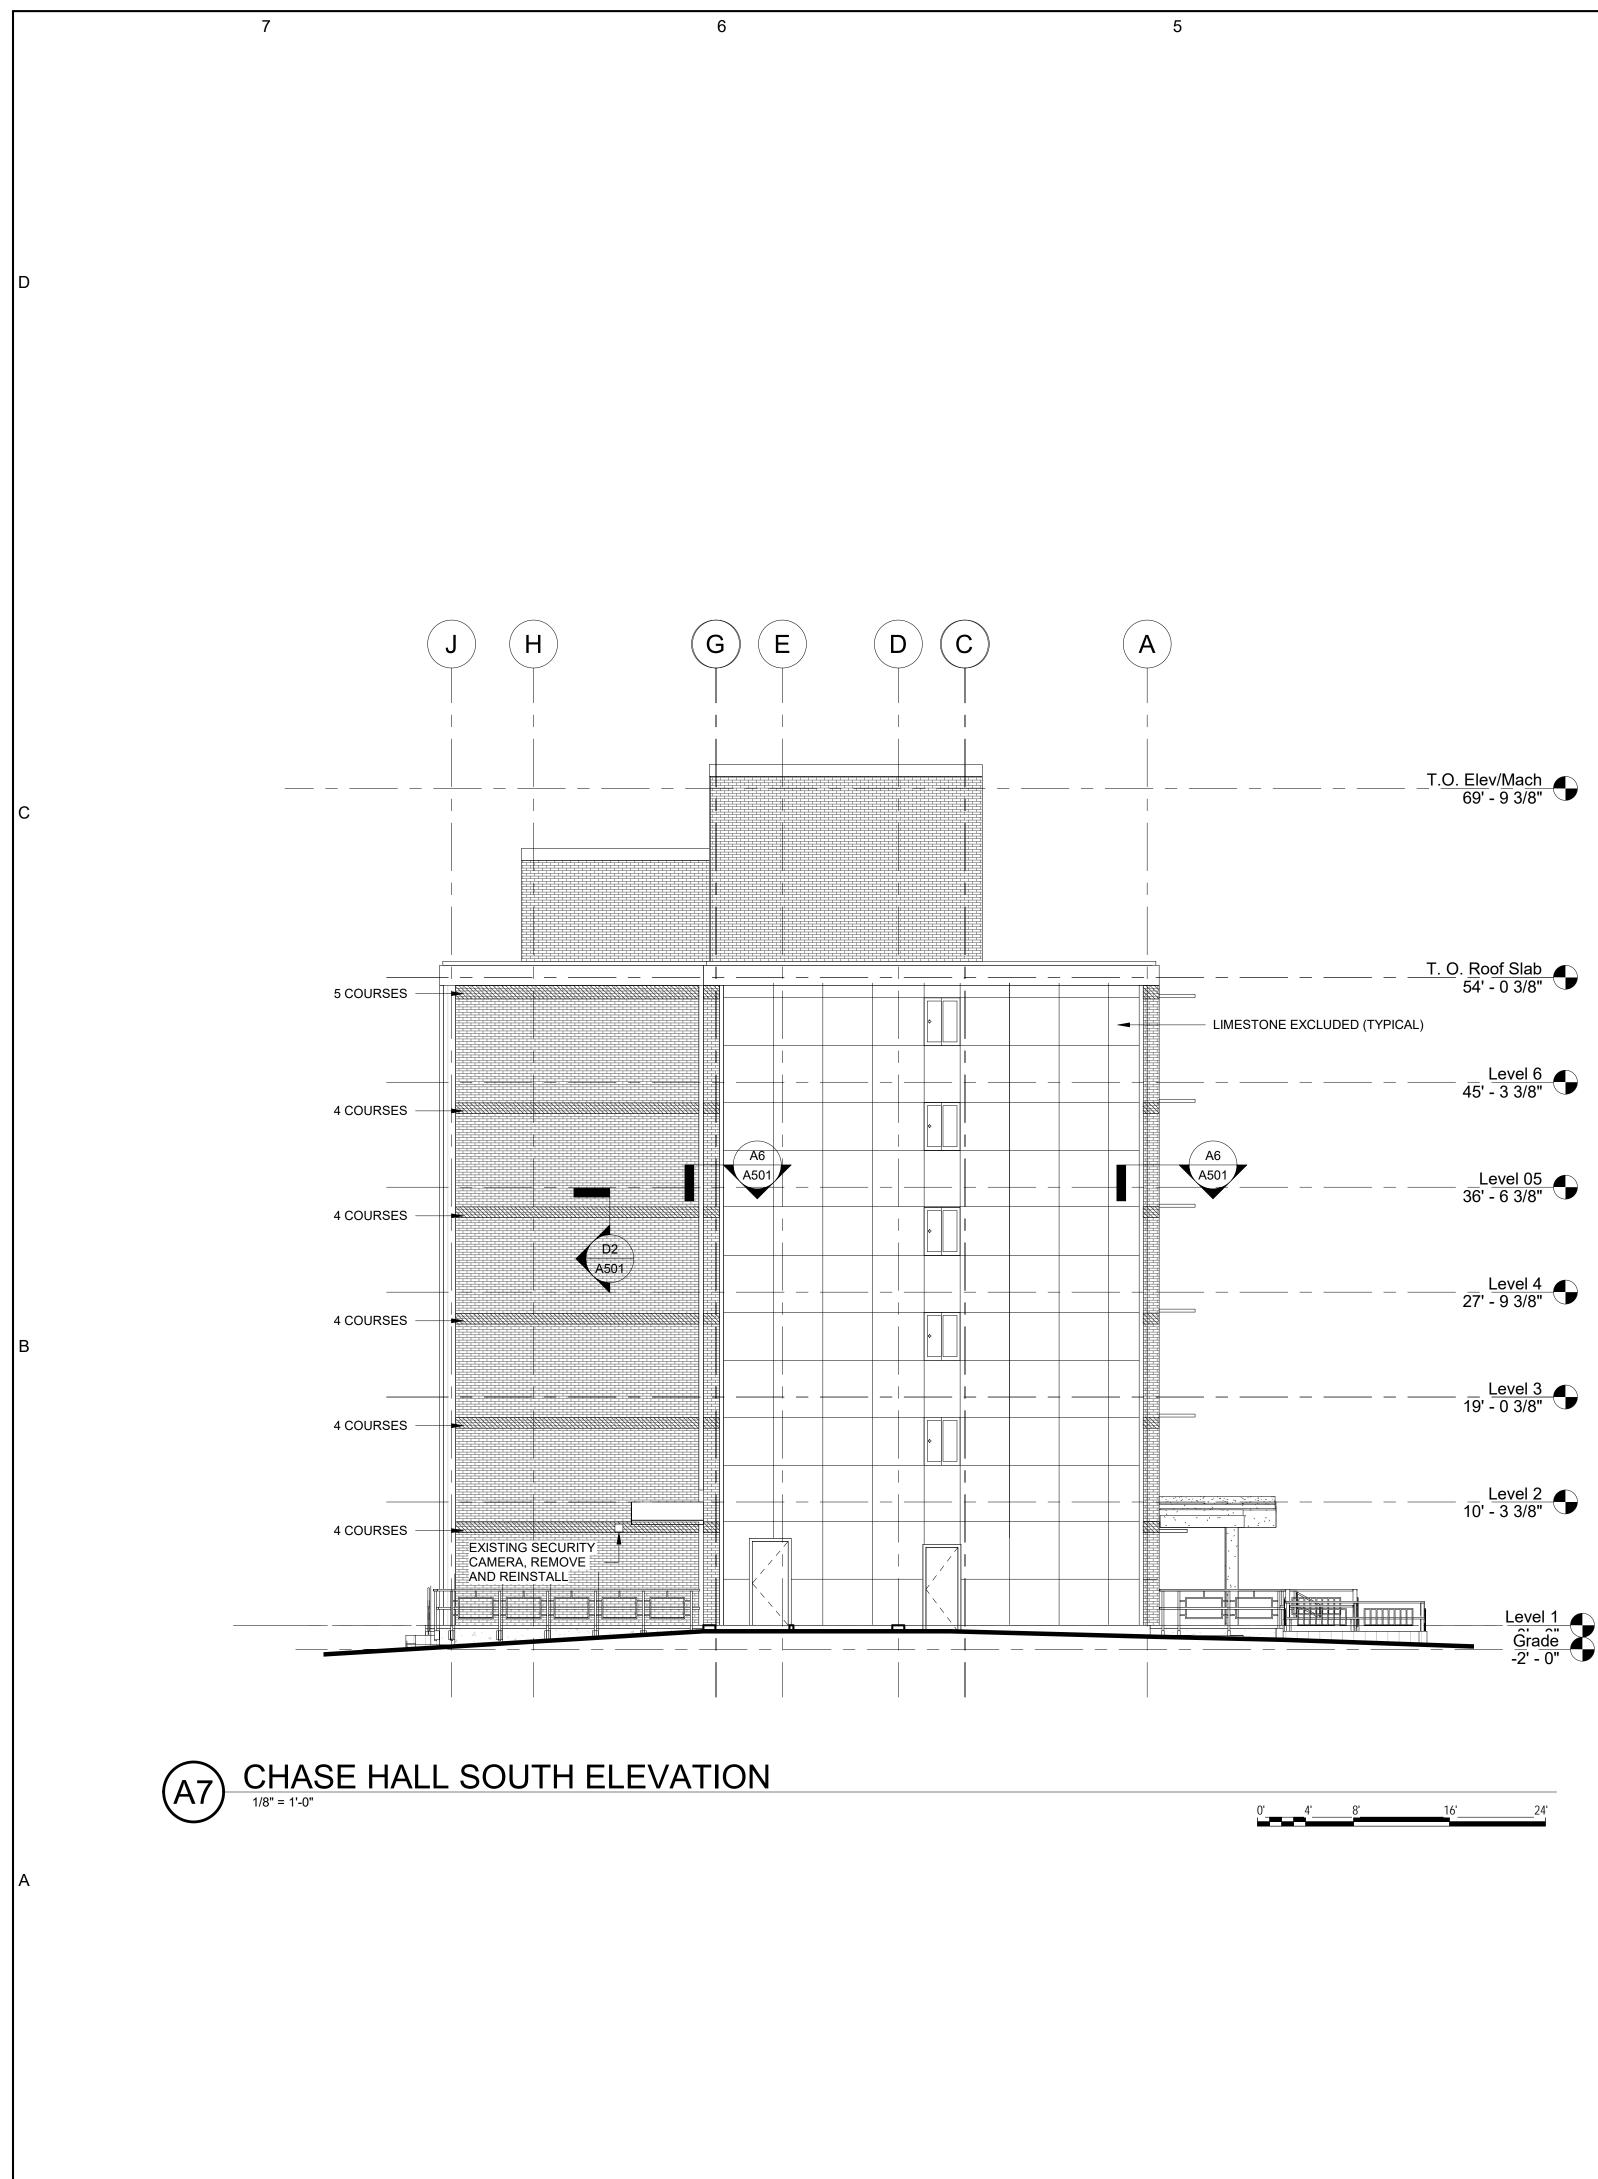


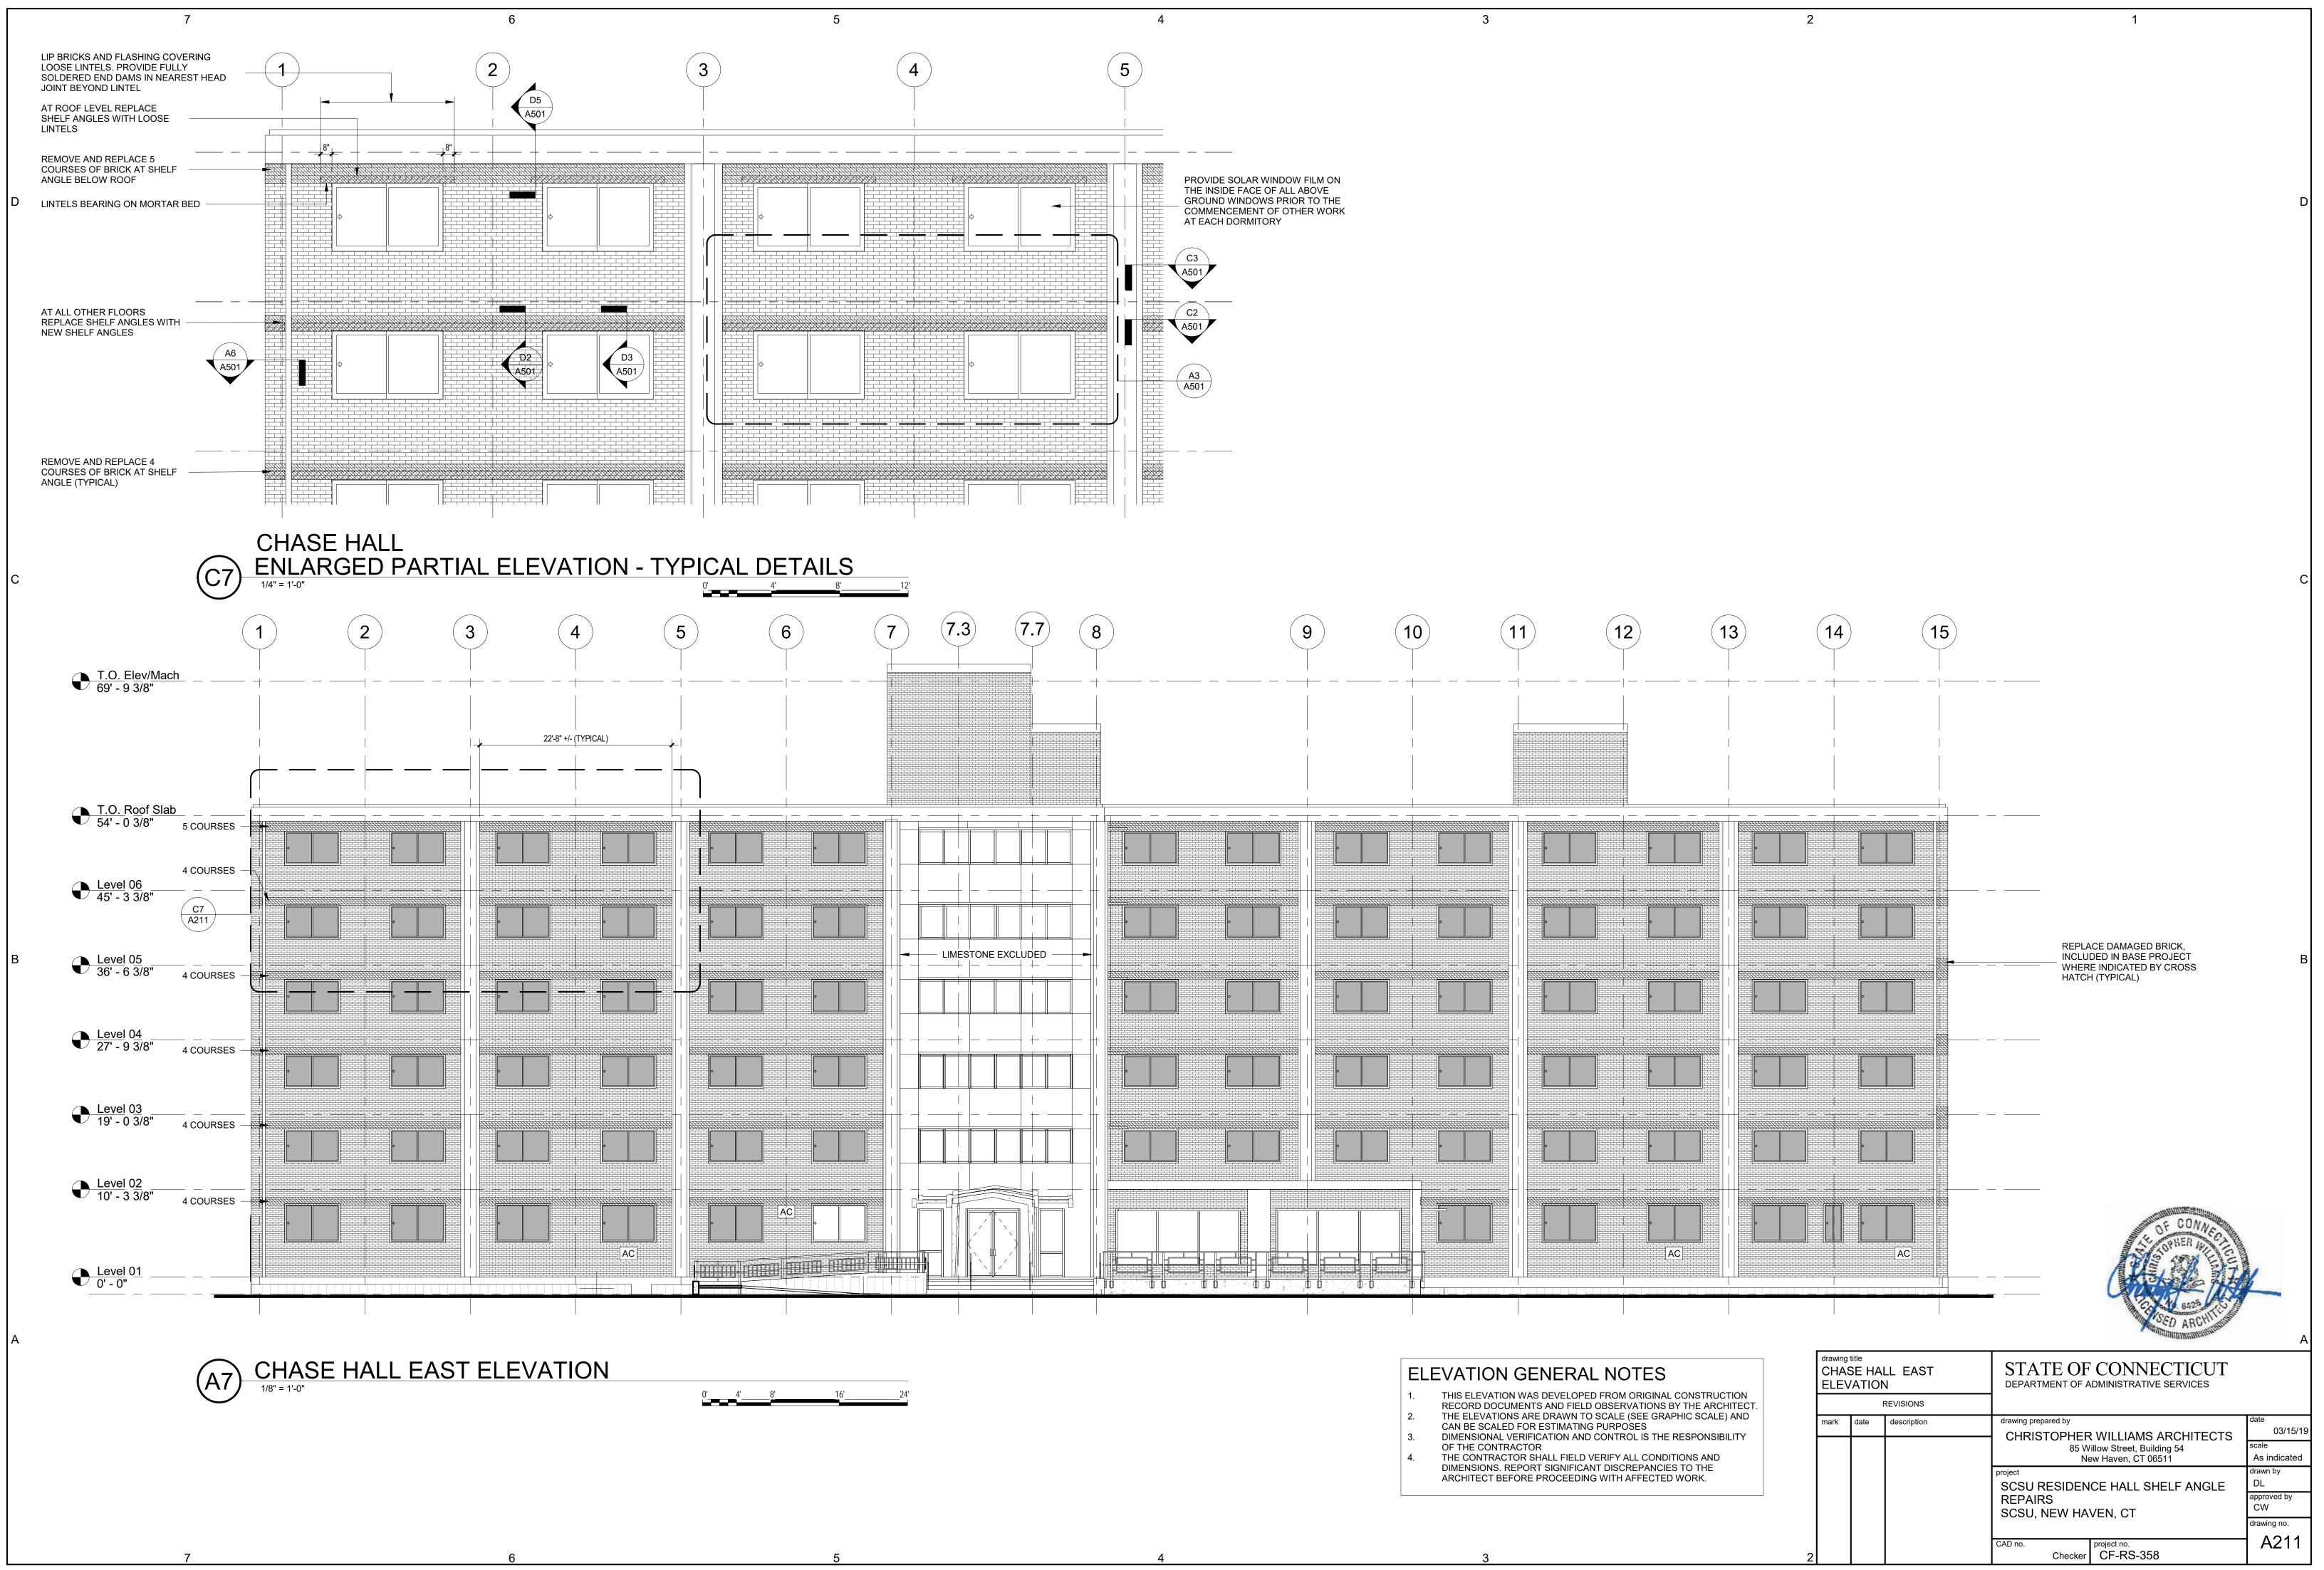


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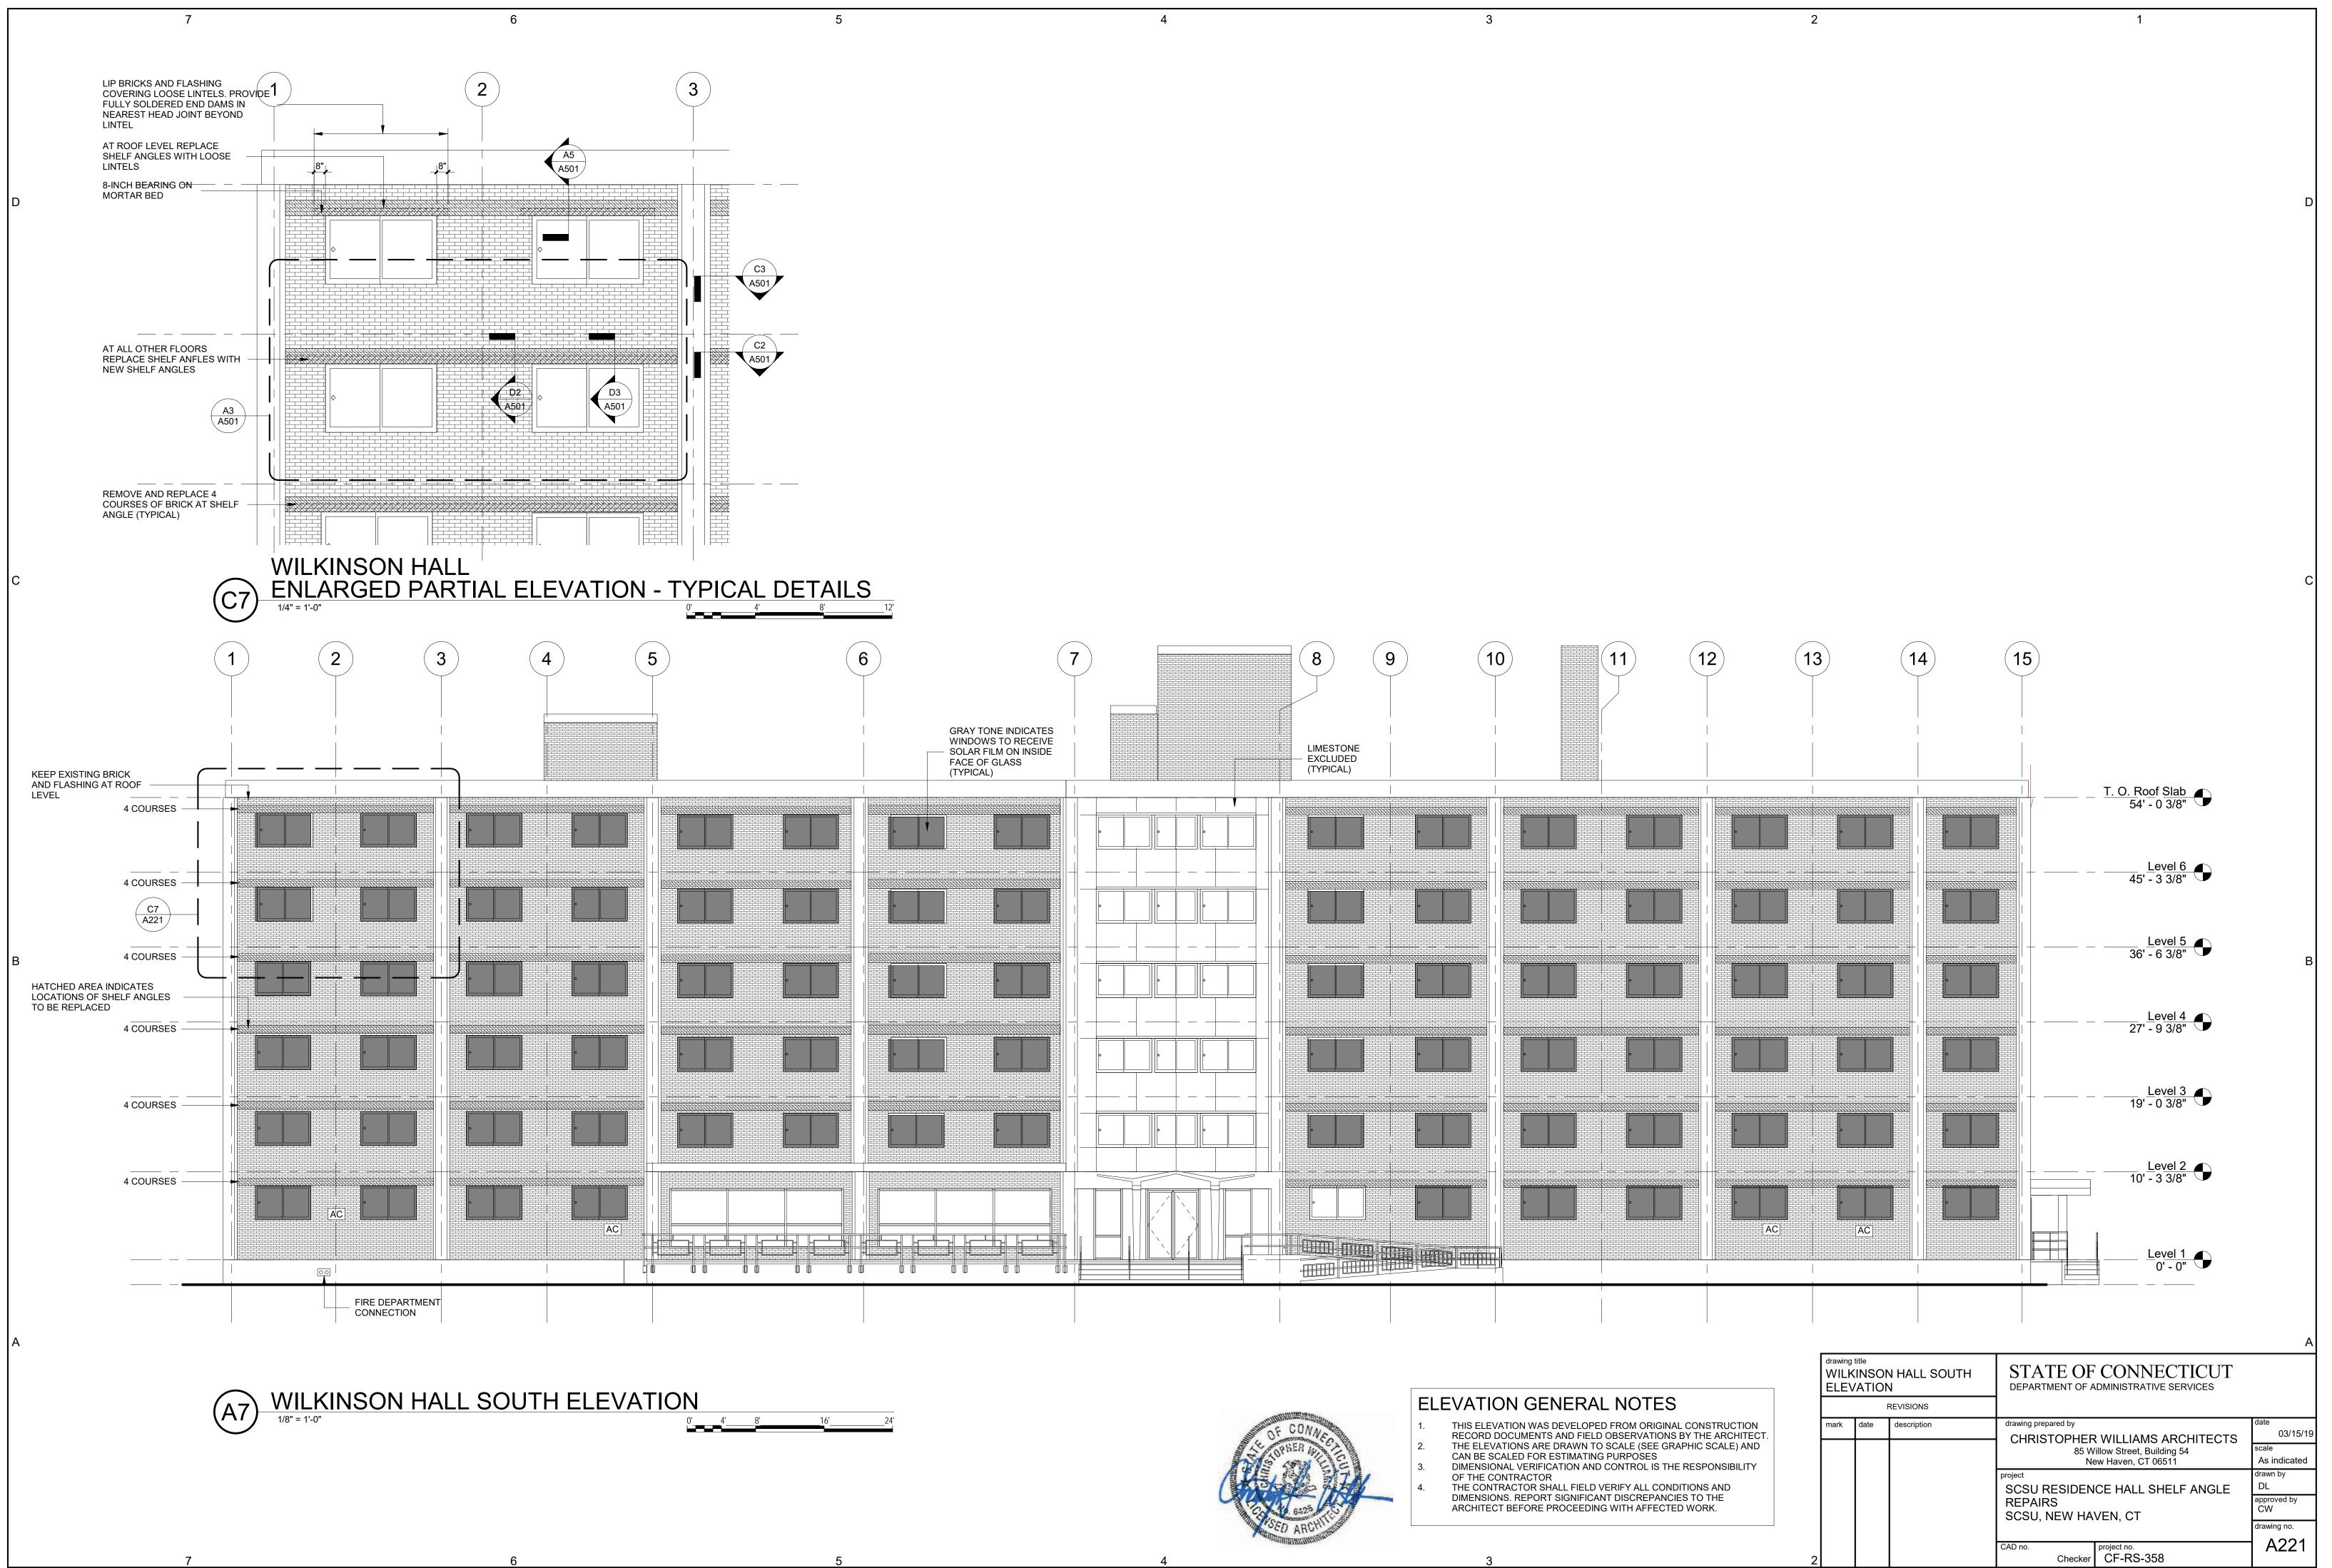


| <u>Level 01</u> 0' - 0" | | | | |
|----------------------------|-----------|------|---------|--|
| | HASE HALL | NORT | H ELEVA | |

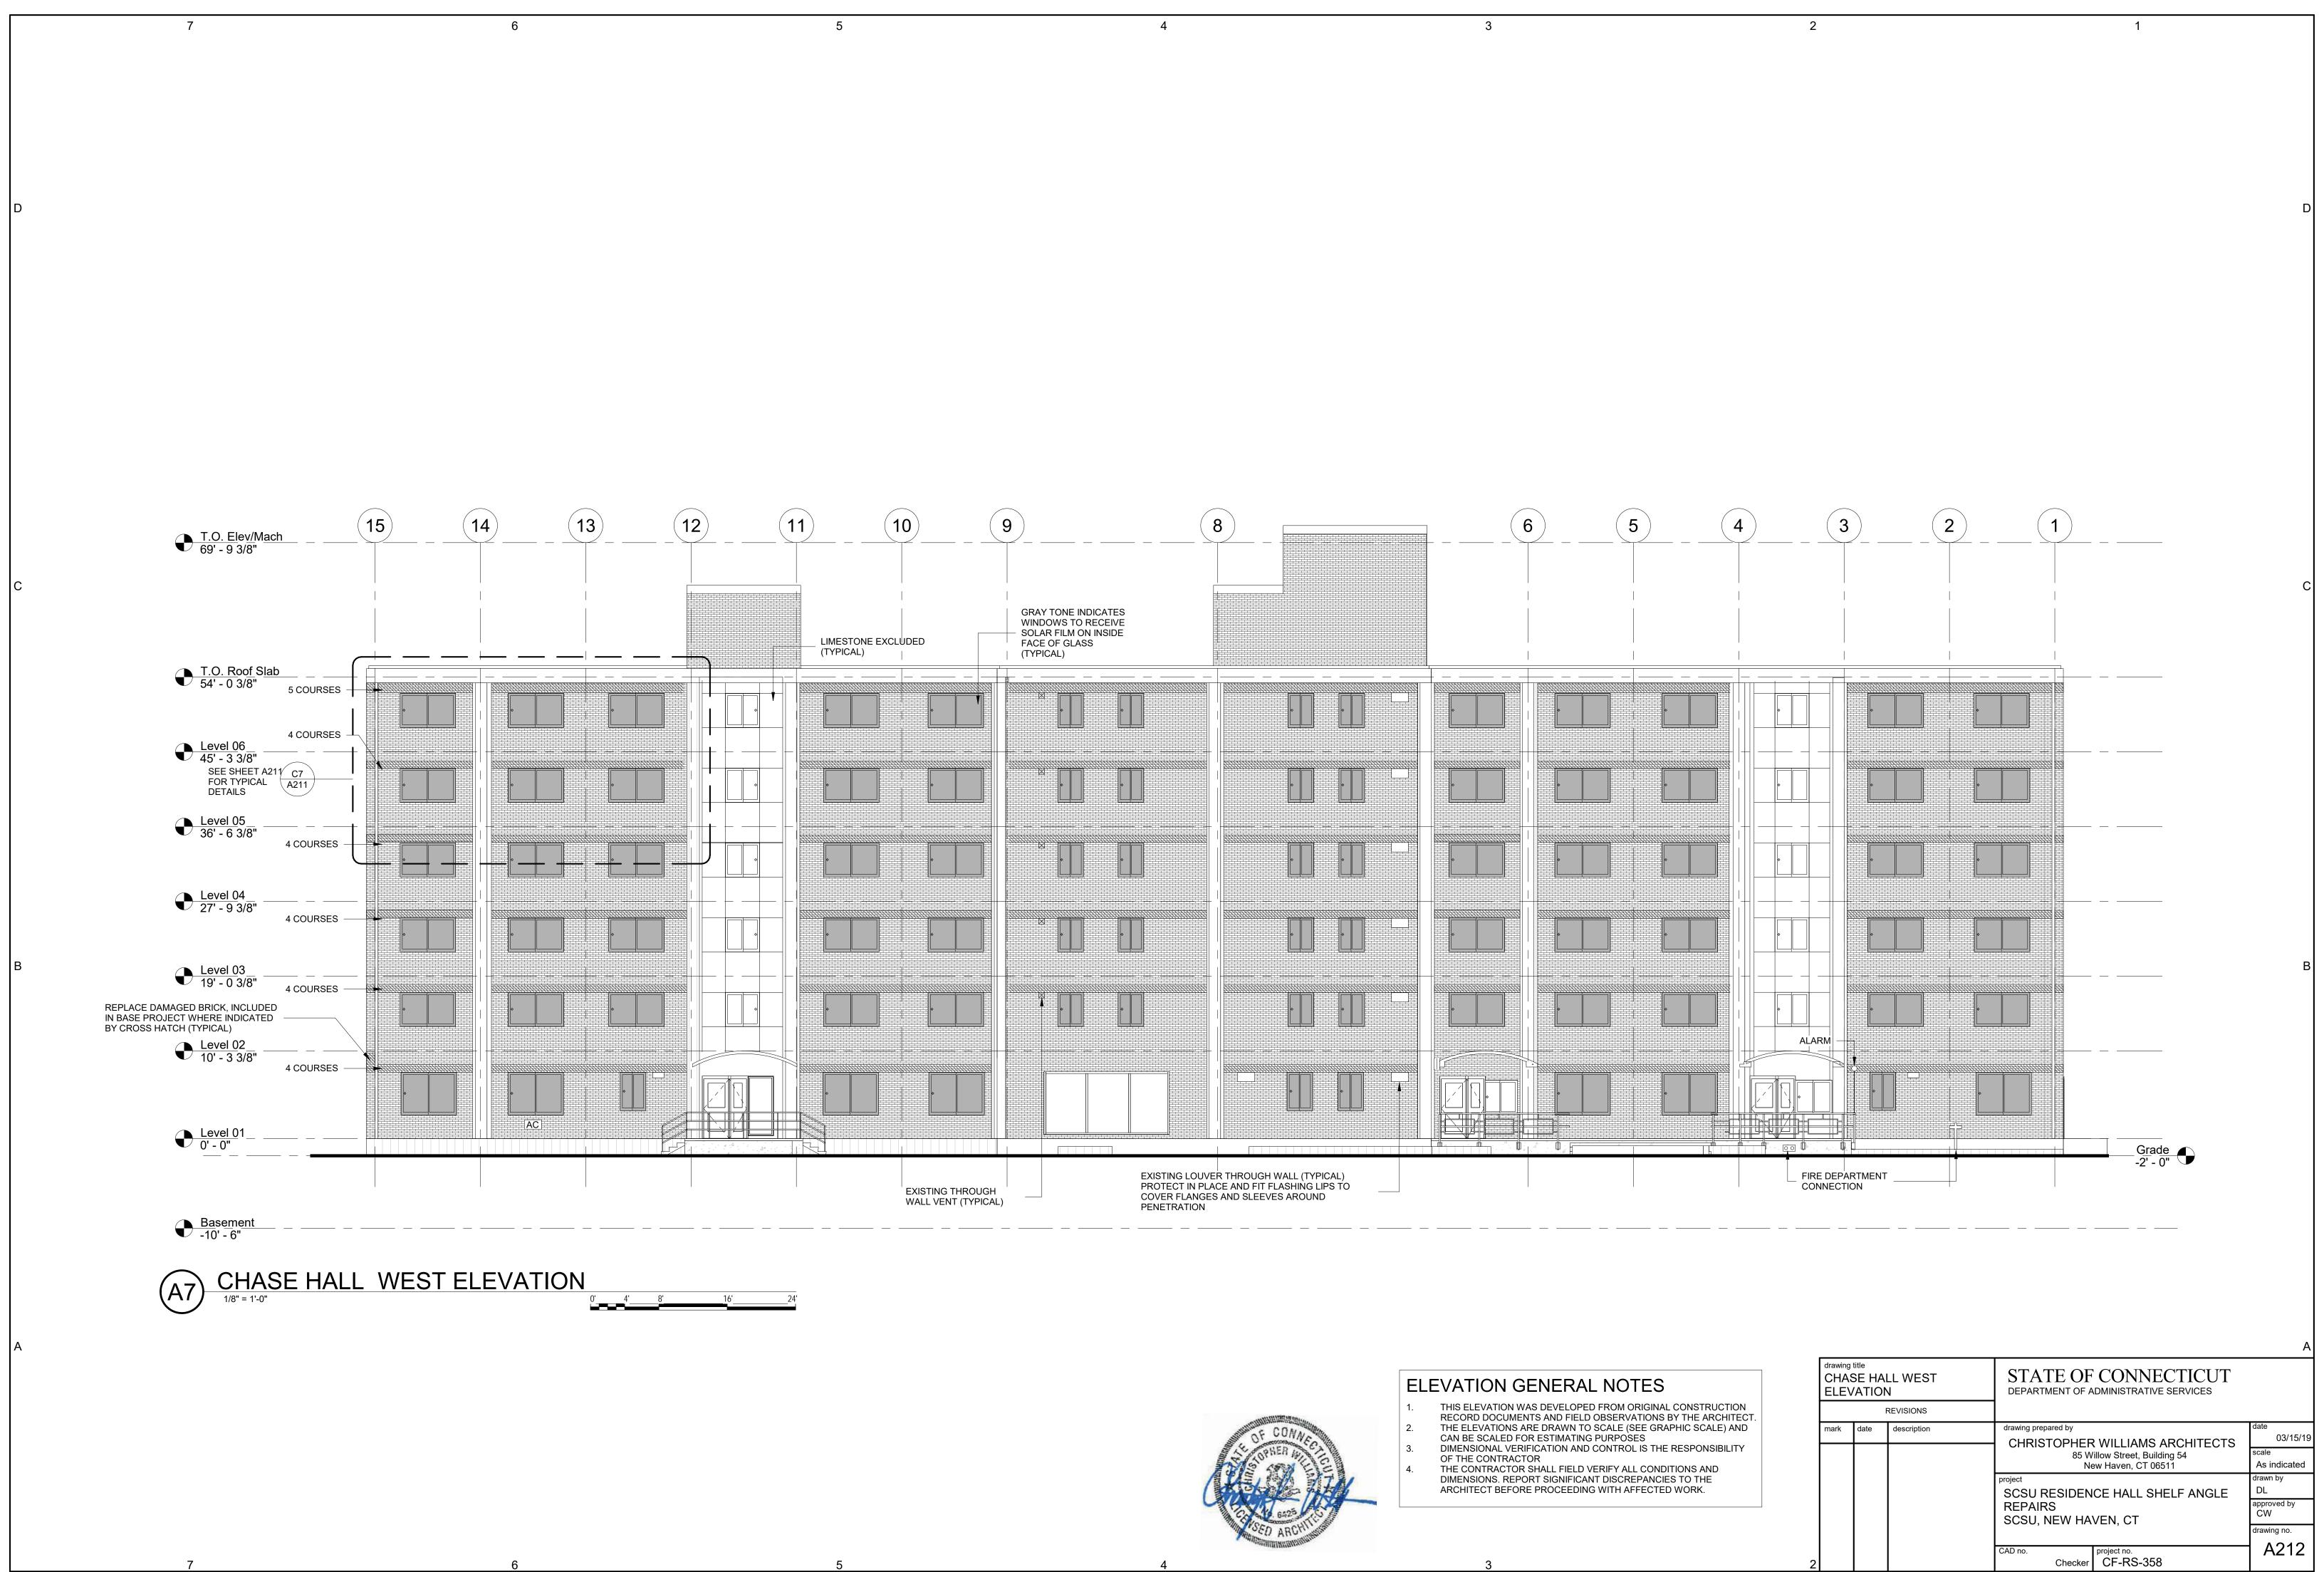


| A | | |
|---|------|---|
| | | T. <u>O. Ele</u> v/ <u>Mach</u> 69' - 9 3/8" |


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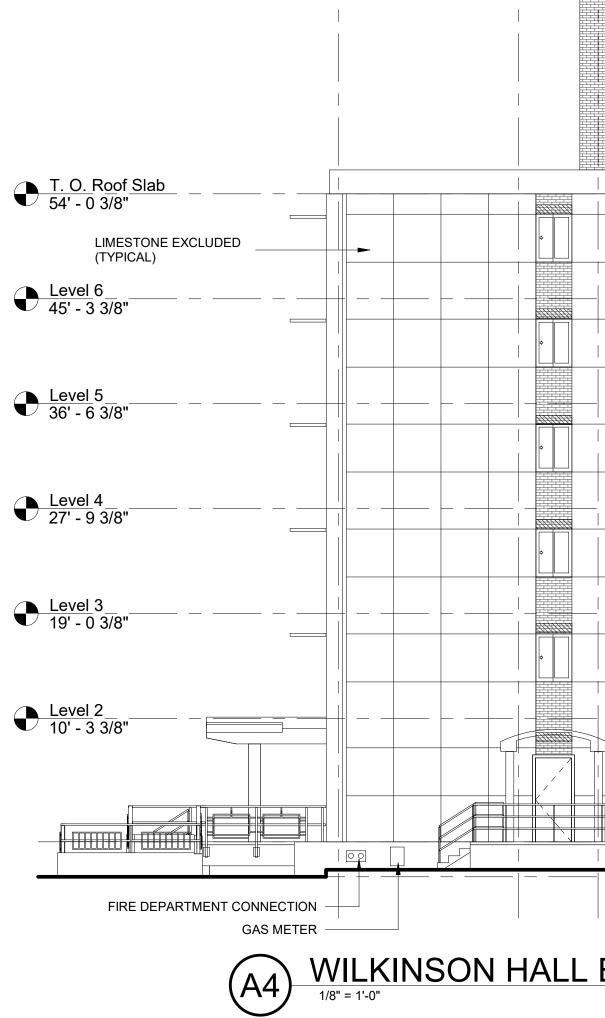

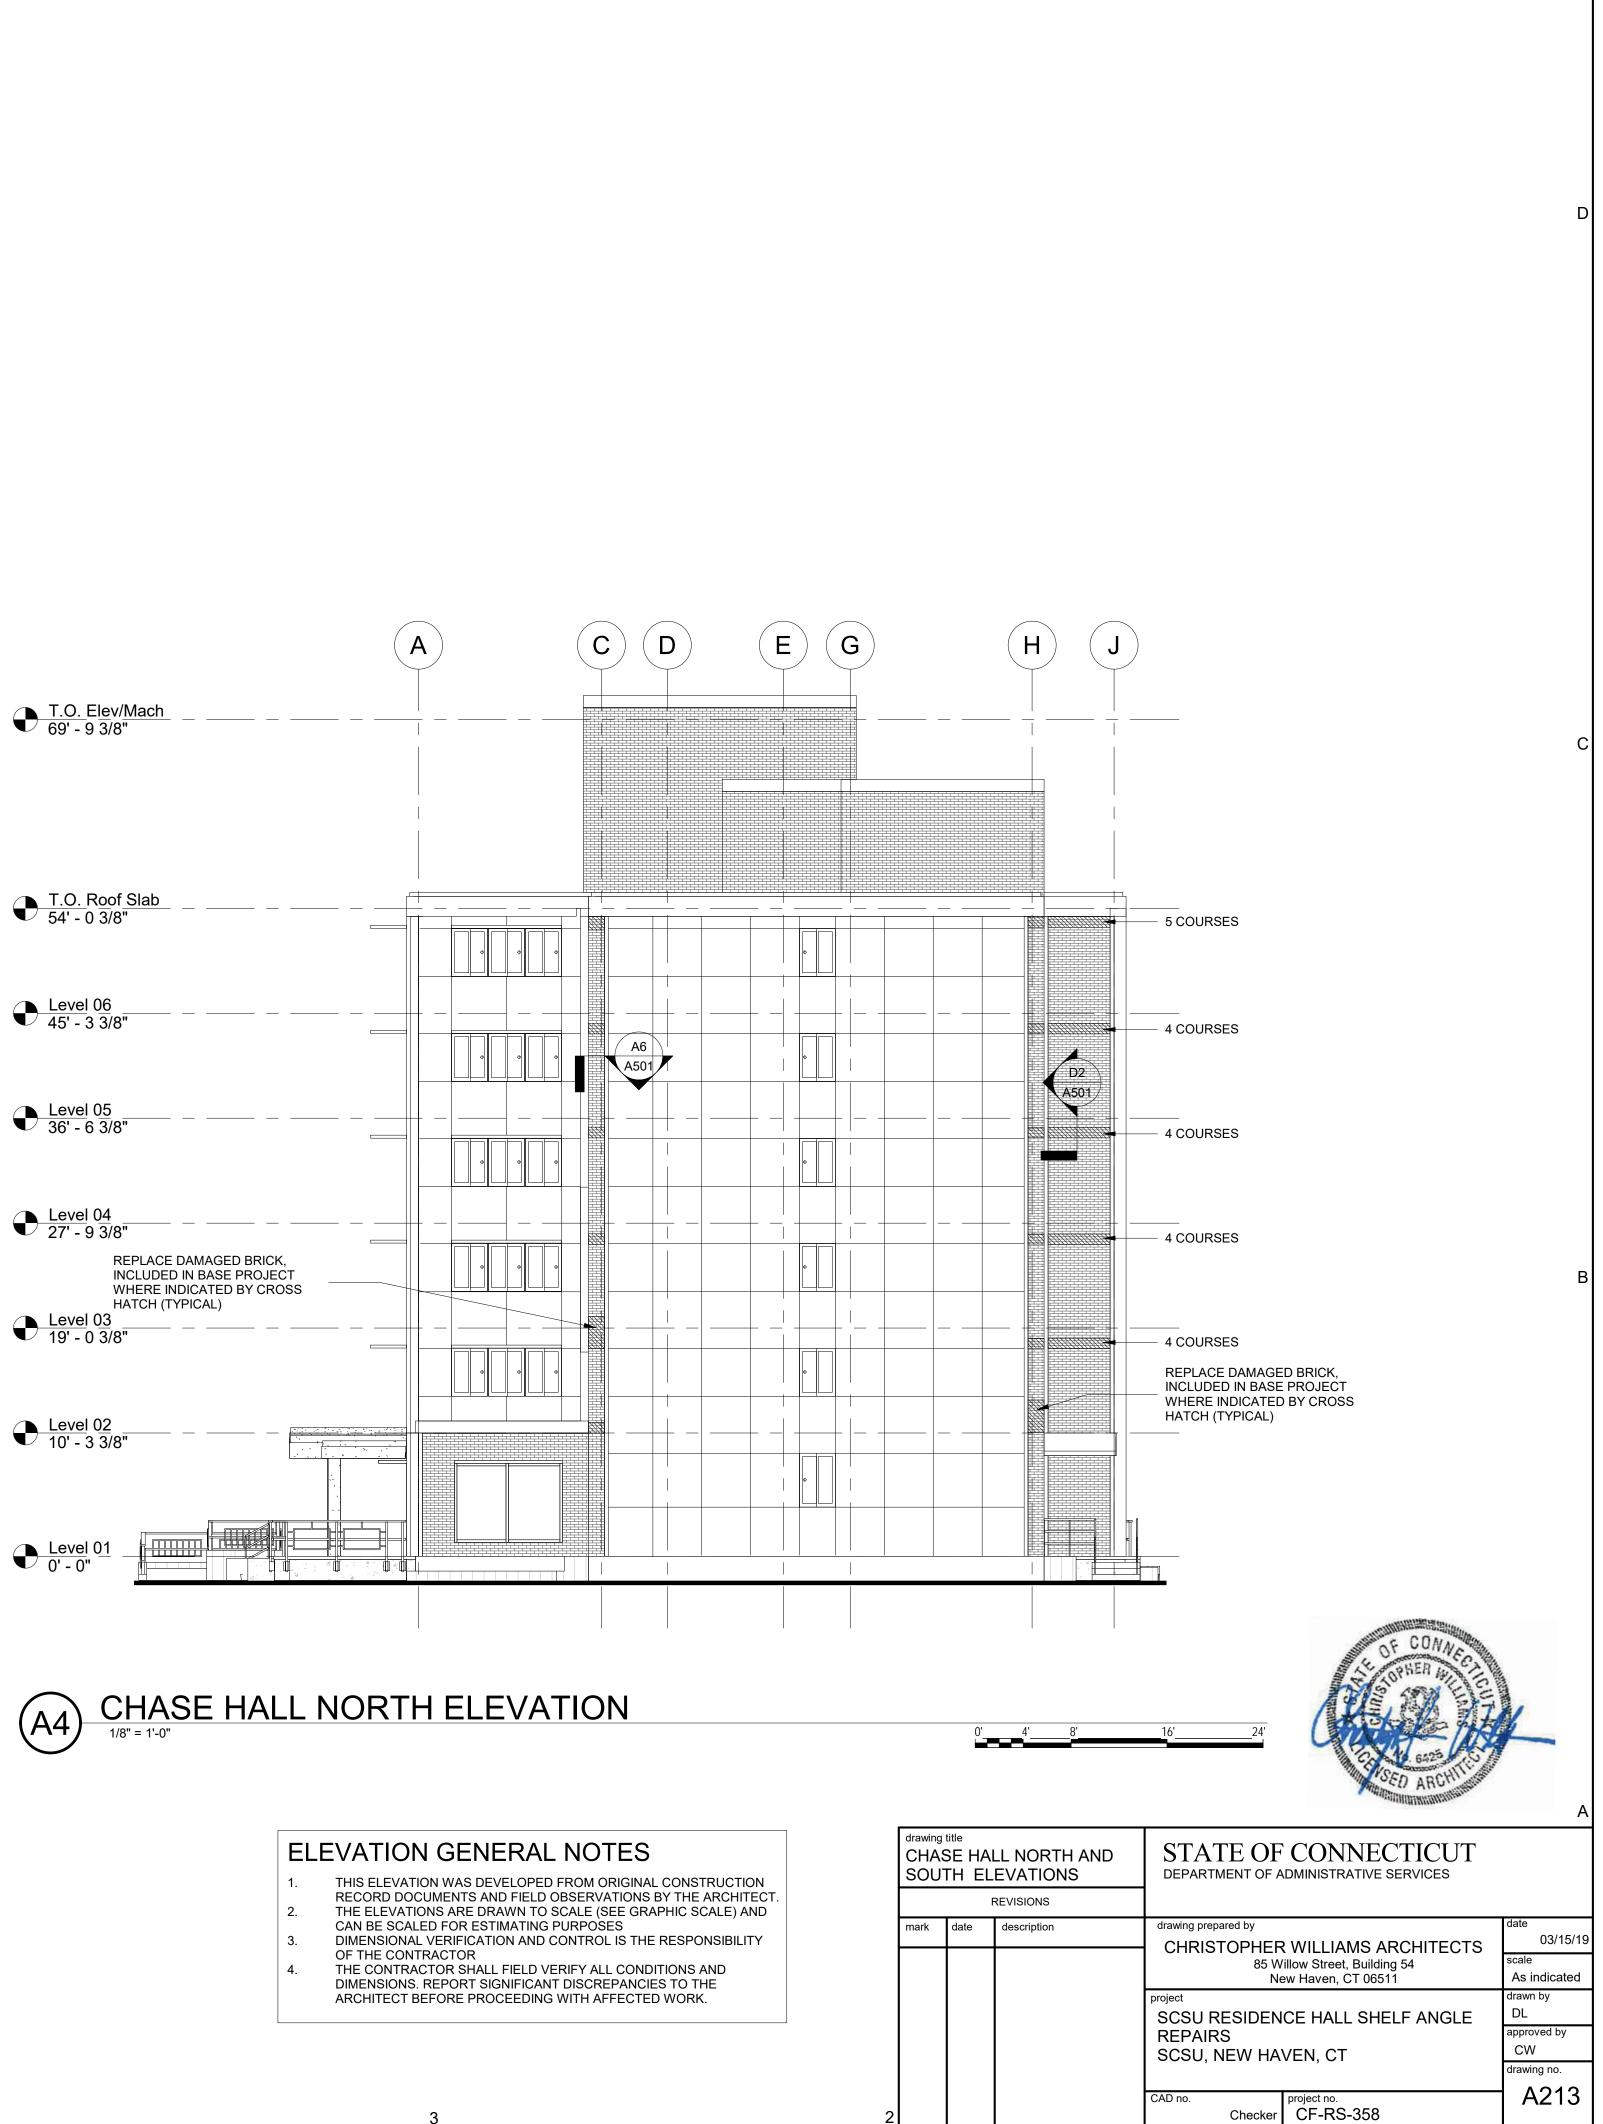
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| ELE | EVATION GENER |
|-----|--|
| 1. | THIS ELEVATION WAS DEVELO |
| 2. | RECORD DOCUMENTS AND FIN THE ELEVATIONS ARE DRAWN |
| | CAN BE SCALED FOR ESTIMAT |

- CAN BE SCALED FOR ESTIMATI DIMENSIONAL VERIFICATION AN OF THE CONTRACTOR THE CONTRACTOR SHALL FIELD DIMENSIONS. REPORT SIGNIFIC ARCHITECT BEFORE PROCEED 3 4.

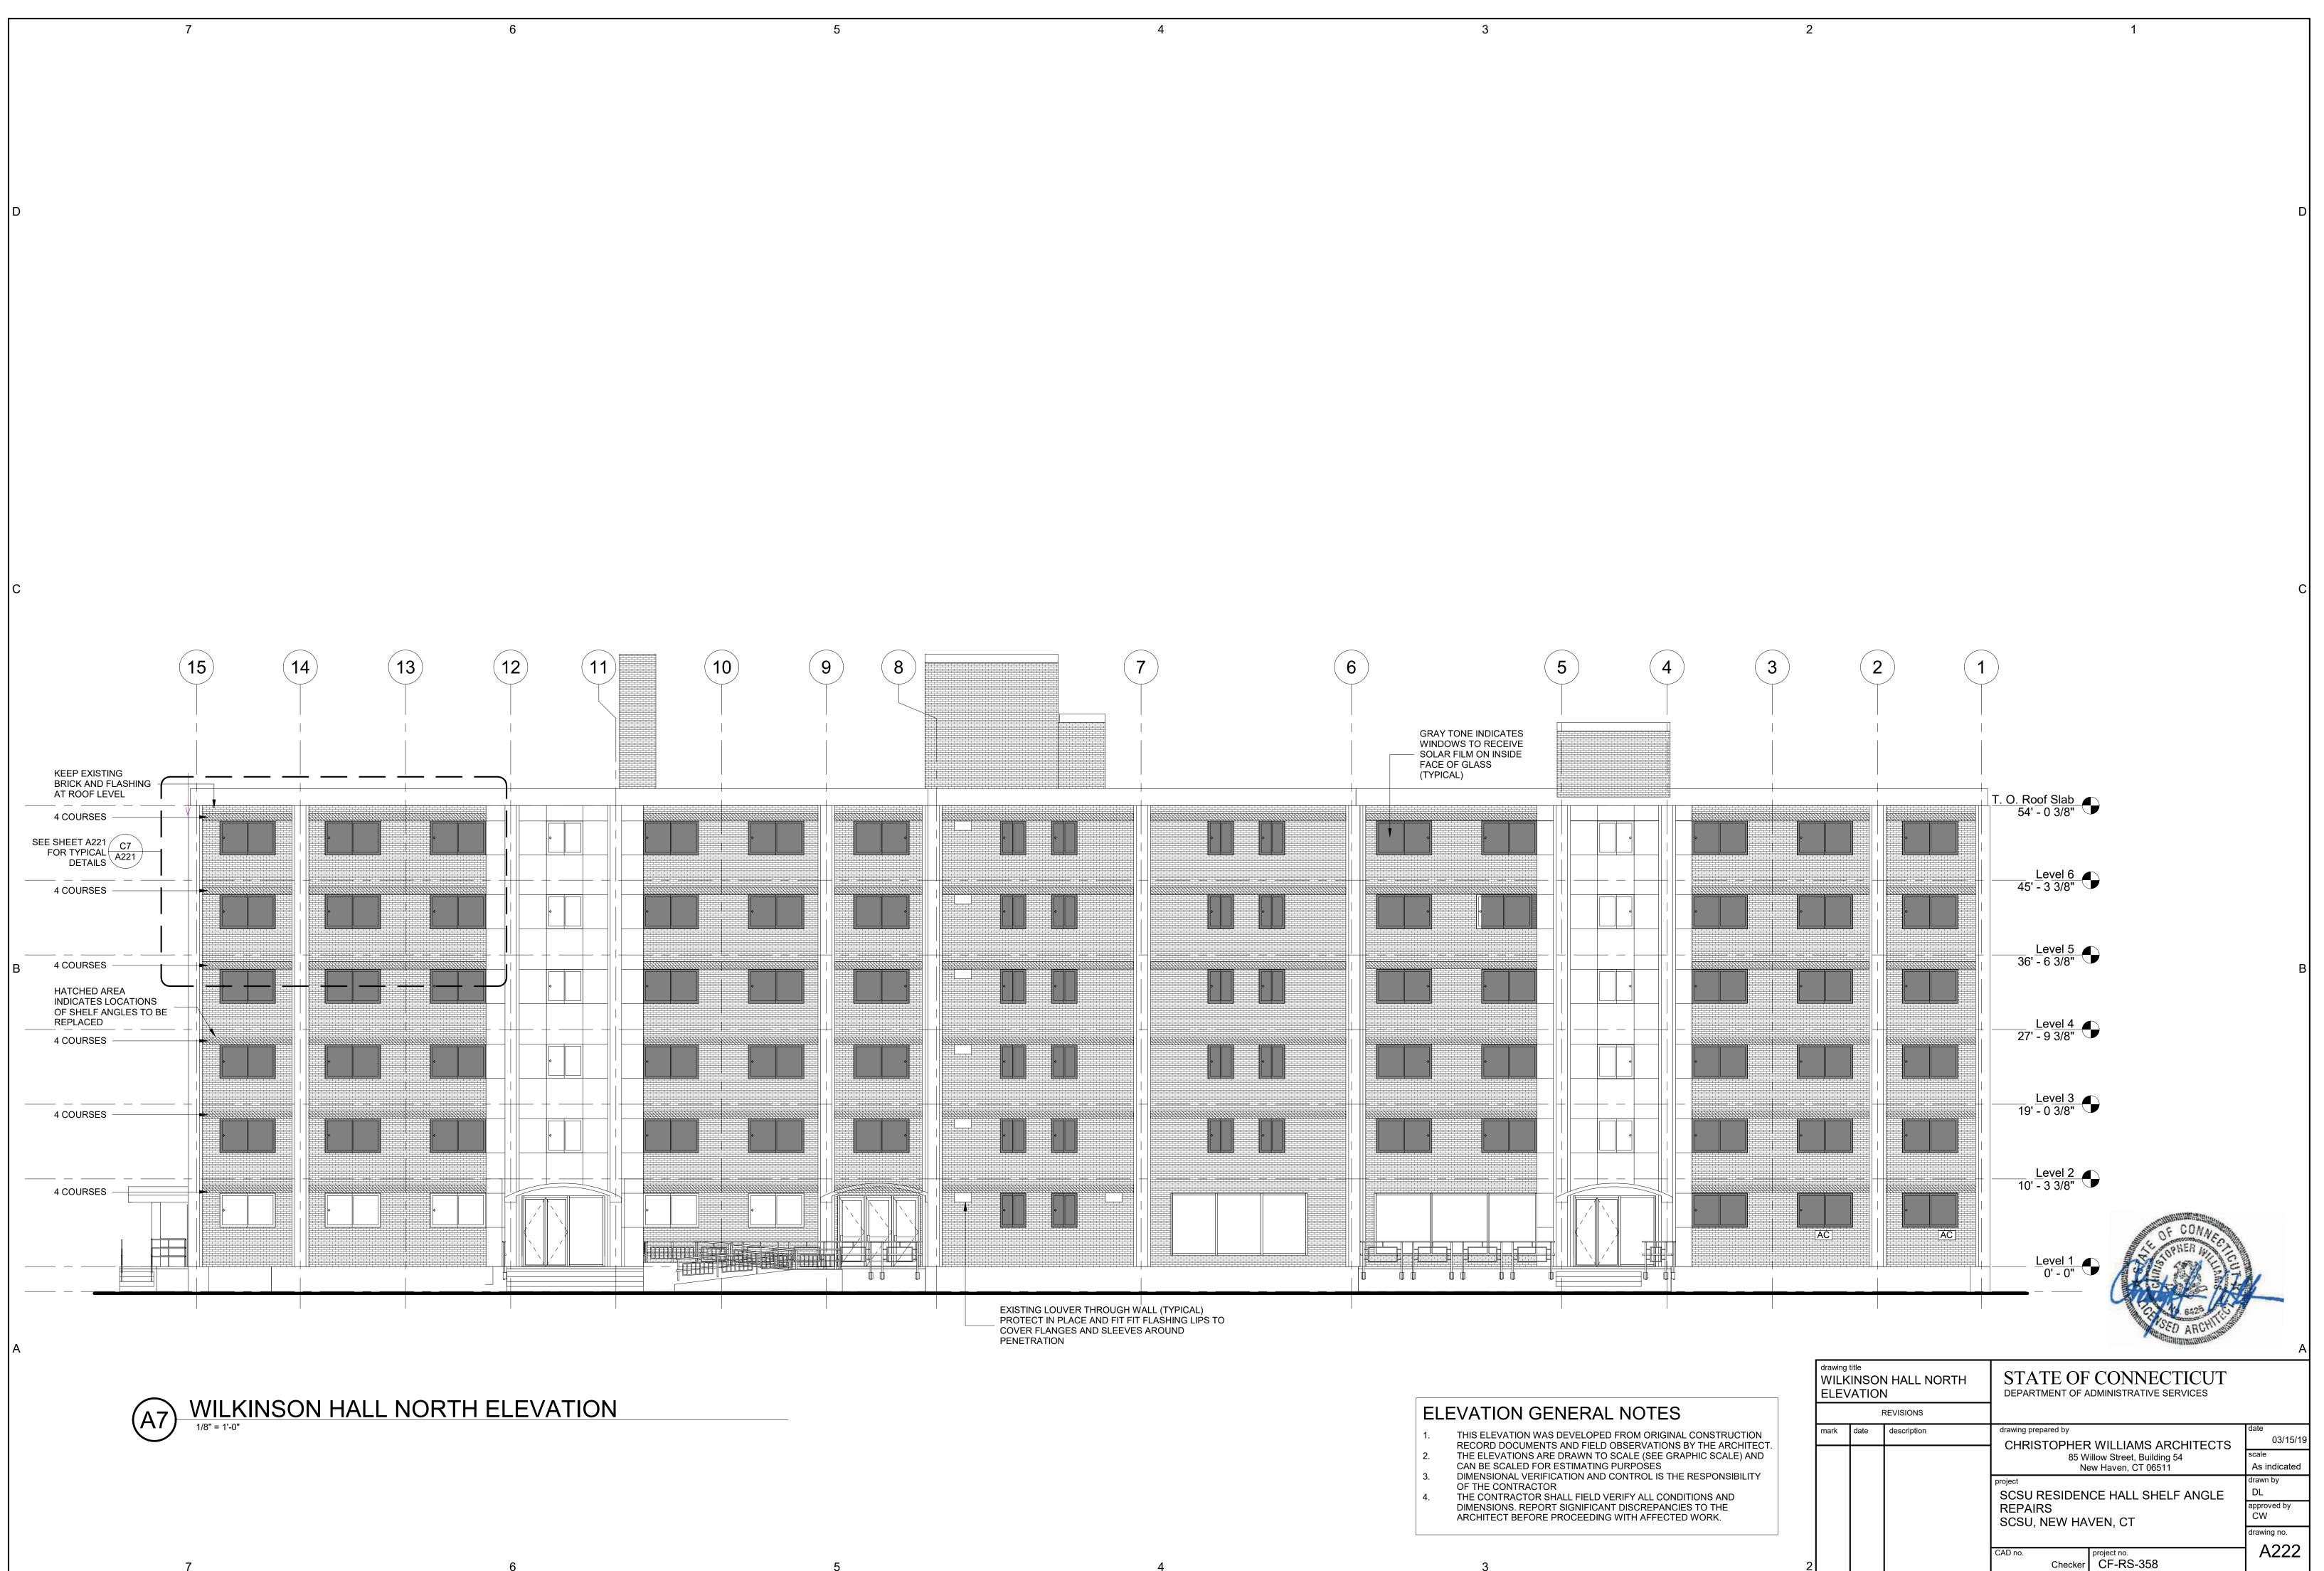


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(B)

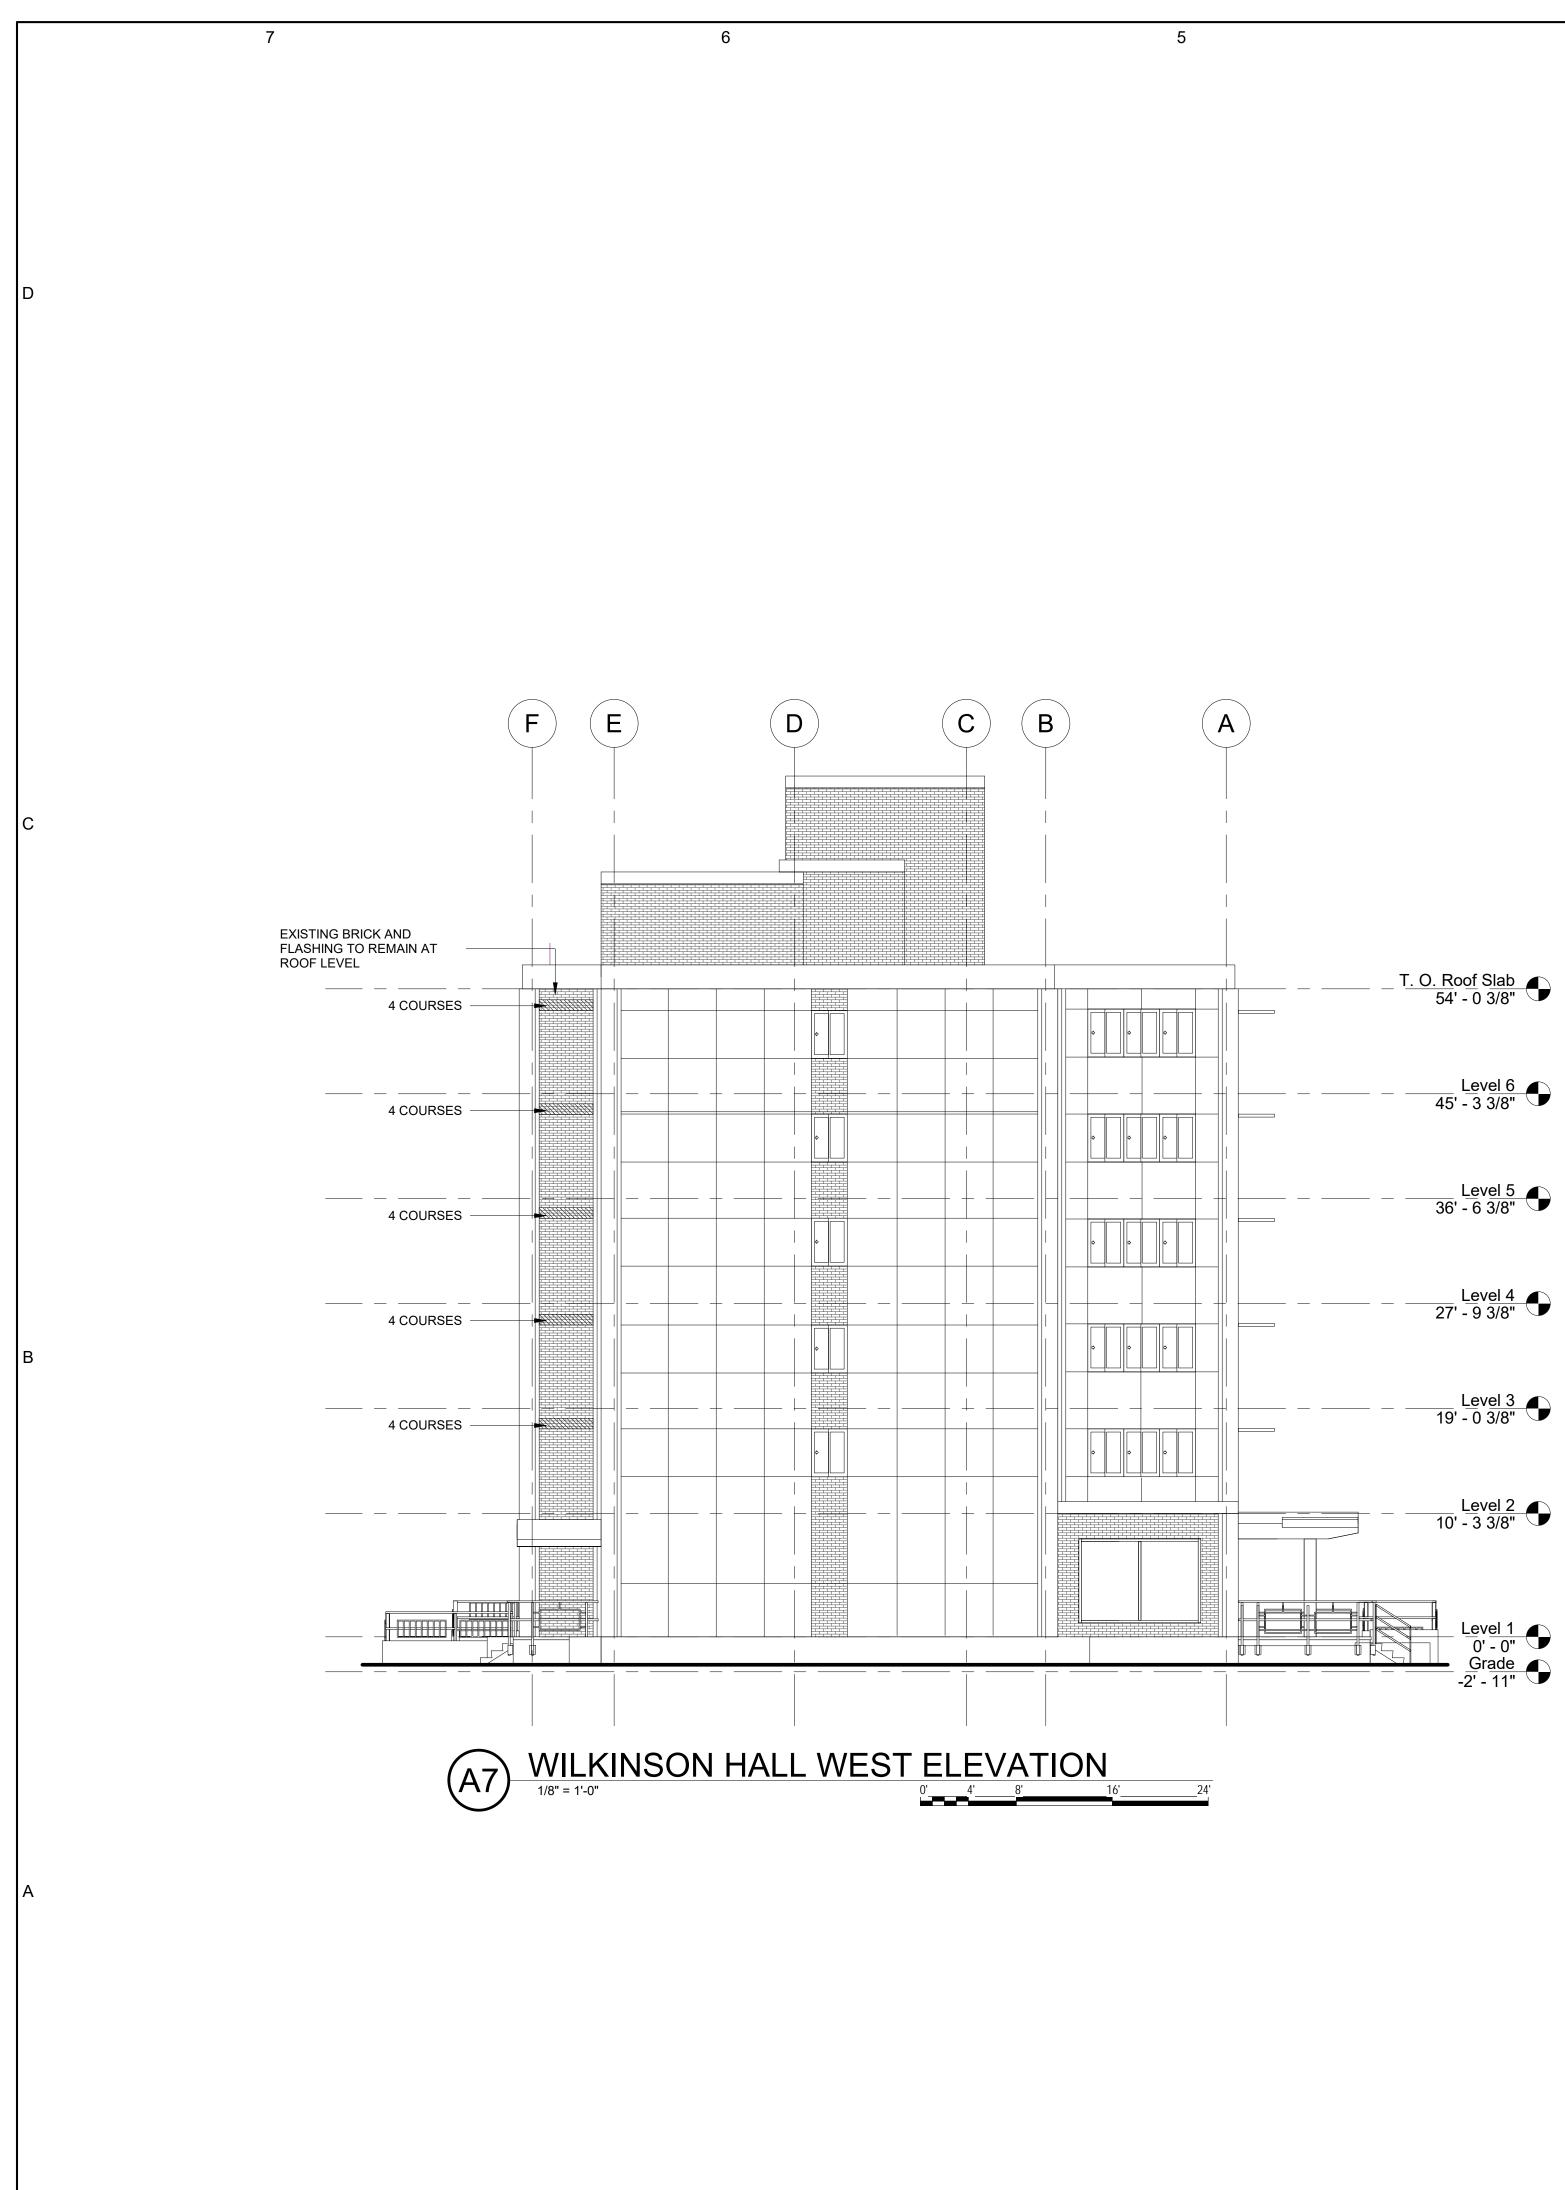
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| C | D | E F | | | (|
|---|--|---|---|---|--|
| | | | EXISTING BRICK AND FLASHING REMAIN AT RC LEVEL 4 COURSES | 0OF | |
| | | | 4 COURSES | | |
| | | | 4 COURSES HATCHED AREA INDICATI LOCATIONS OF SHELF AN TO BE REPLACED 4 COURSES | | |
| | | | 4 COURSES | | I |
| | | | + 4 COURSES - REMOVE AND REINSTALL | SECURITY CAMERA | |
| EAST EL | EVATION | 24' | | OF CONNEC | |
| RAL NOTES | | drawing title WILKINSON HAI WEST ELEVATIO | ONS DEPARTM | TE OF CONNECTICUT | |
| OPED FROM ORIGINAL FIELD OBSERVATIONS E N TO SCALE (SEE GRANTING PURPOSES AND CONTROL IS THE | BY THE ARCHITECT. PHIC SCALE) AND RESPONSIBILITY | mark date descri | ption drawing prepared | TOPHER WILLIAMS ARCHITECT 85 Willow Street, Building 54 New Haven, CT 06511 | scale As indicated drawn by |
| ELD VERIFY ALL CONDI FICANT DISCREPANCIE EDING WITH AFFECTED | S TO THE | 2 | REPAIR | ESIDENCE HALL SHELF ANGLE S NEW HAVEN, CT Checker CF-RS-358 | approved by CW drawing no. A223 |



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EXISTING LOUVER THROUGH WALL (TYPICAL) PROTECT IN PLACE AND FIT FIT FLASHING LIPS TO COVER FLANGES AND SLEEVES AROUND PENETRATION

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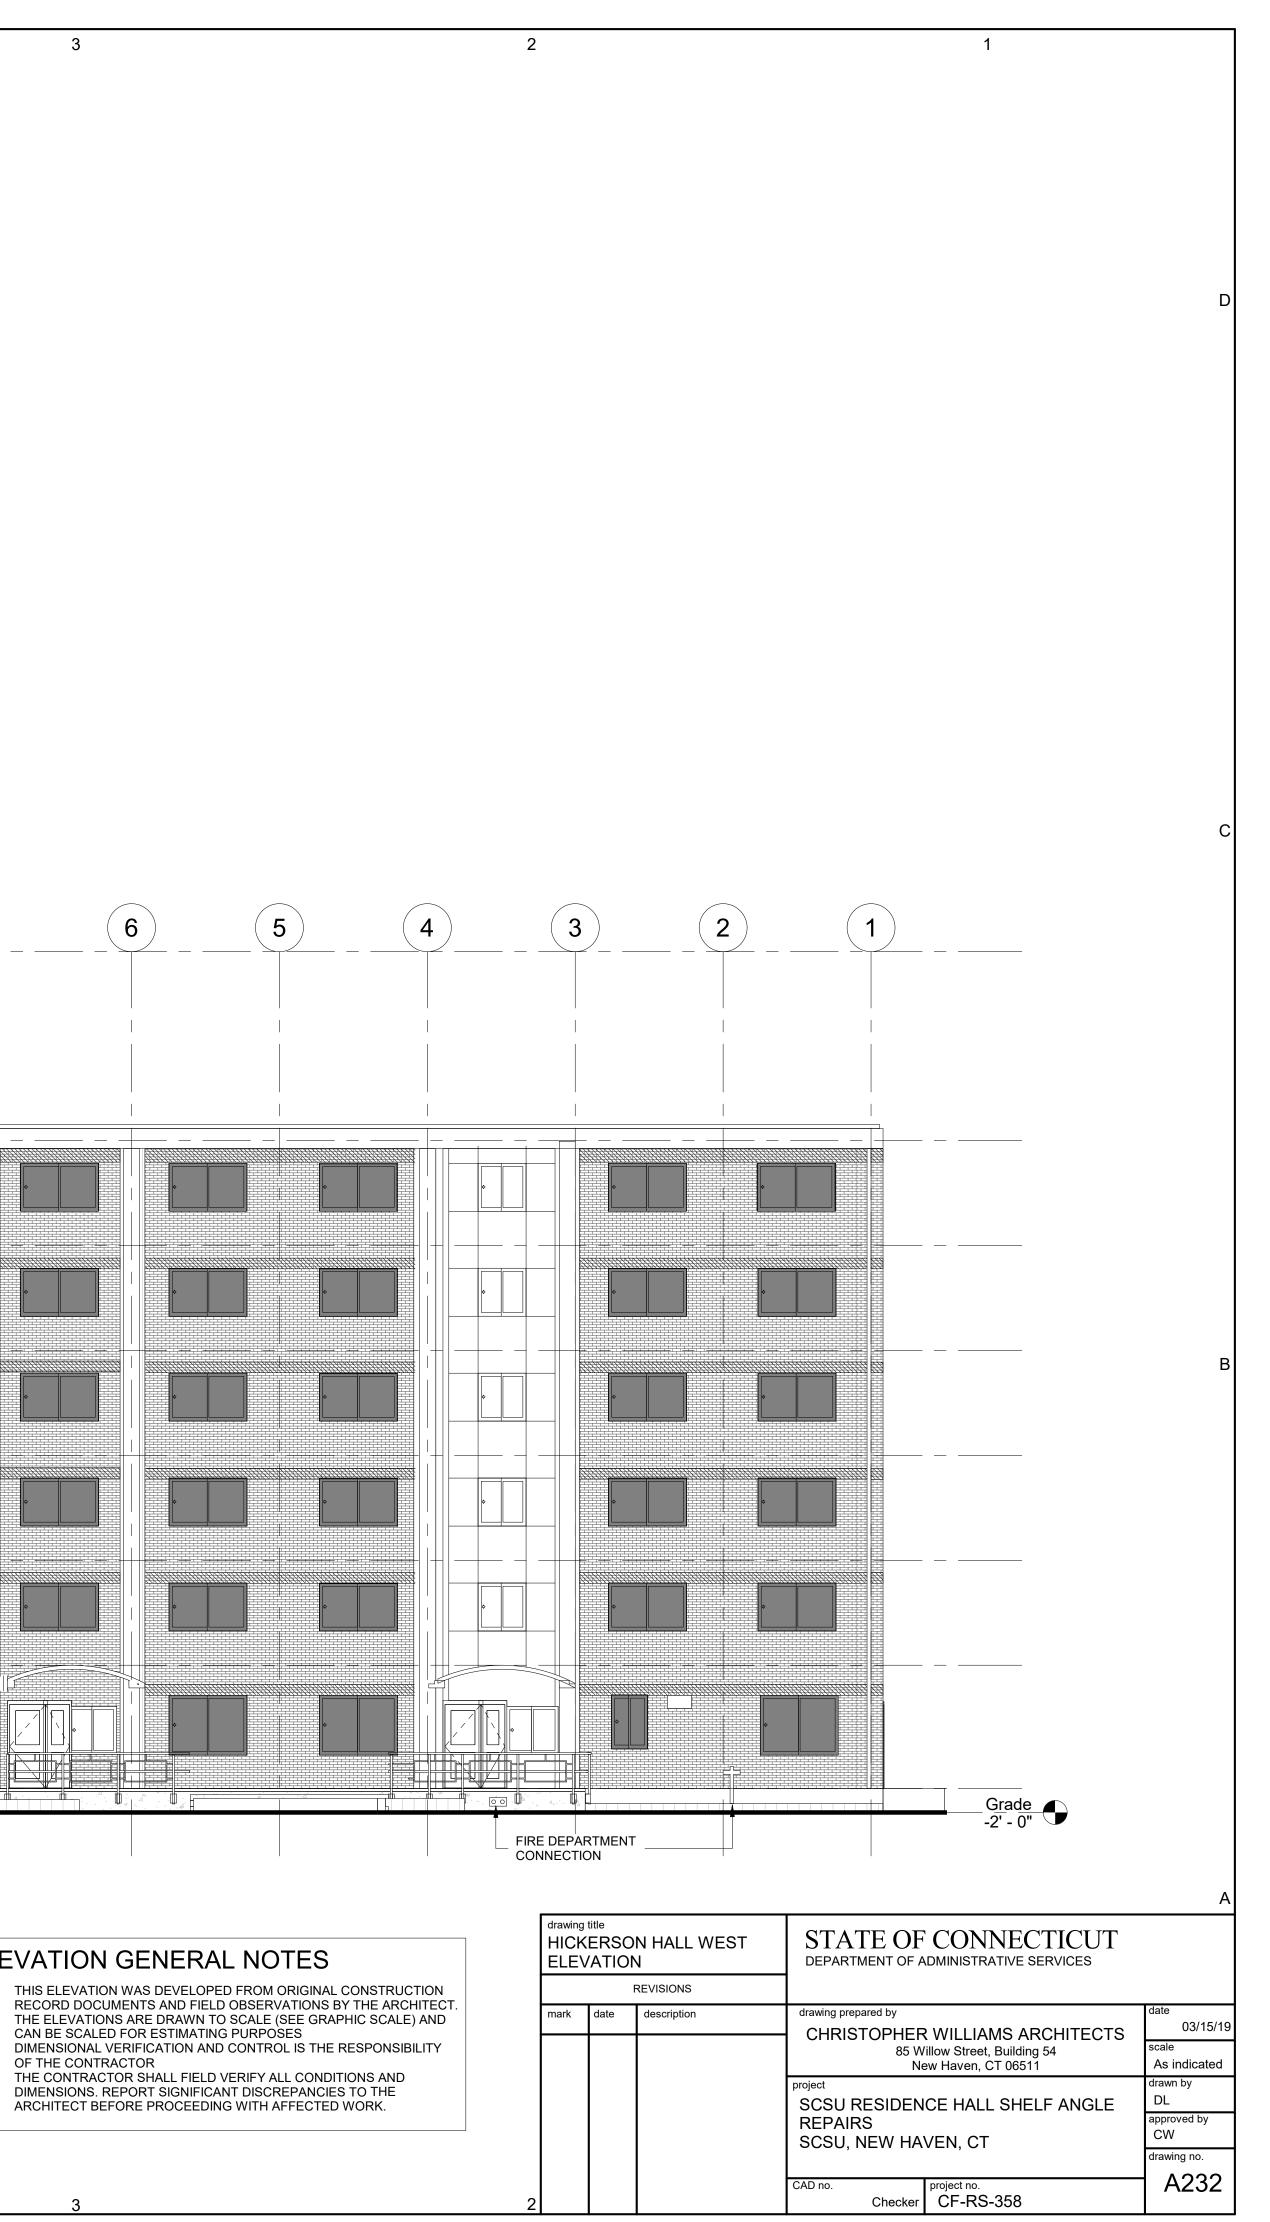
ELEVATION GENERAL NOTES

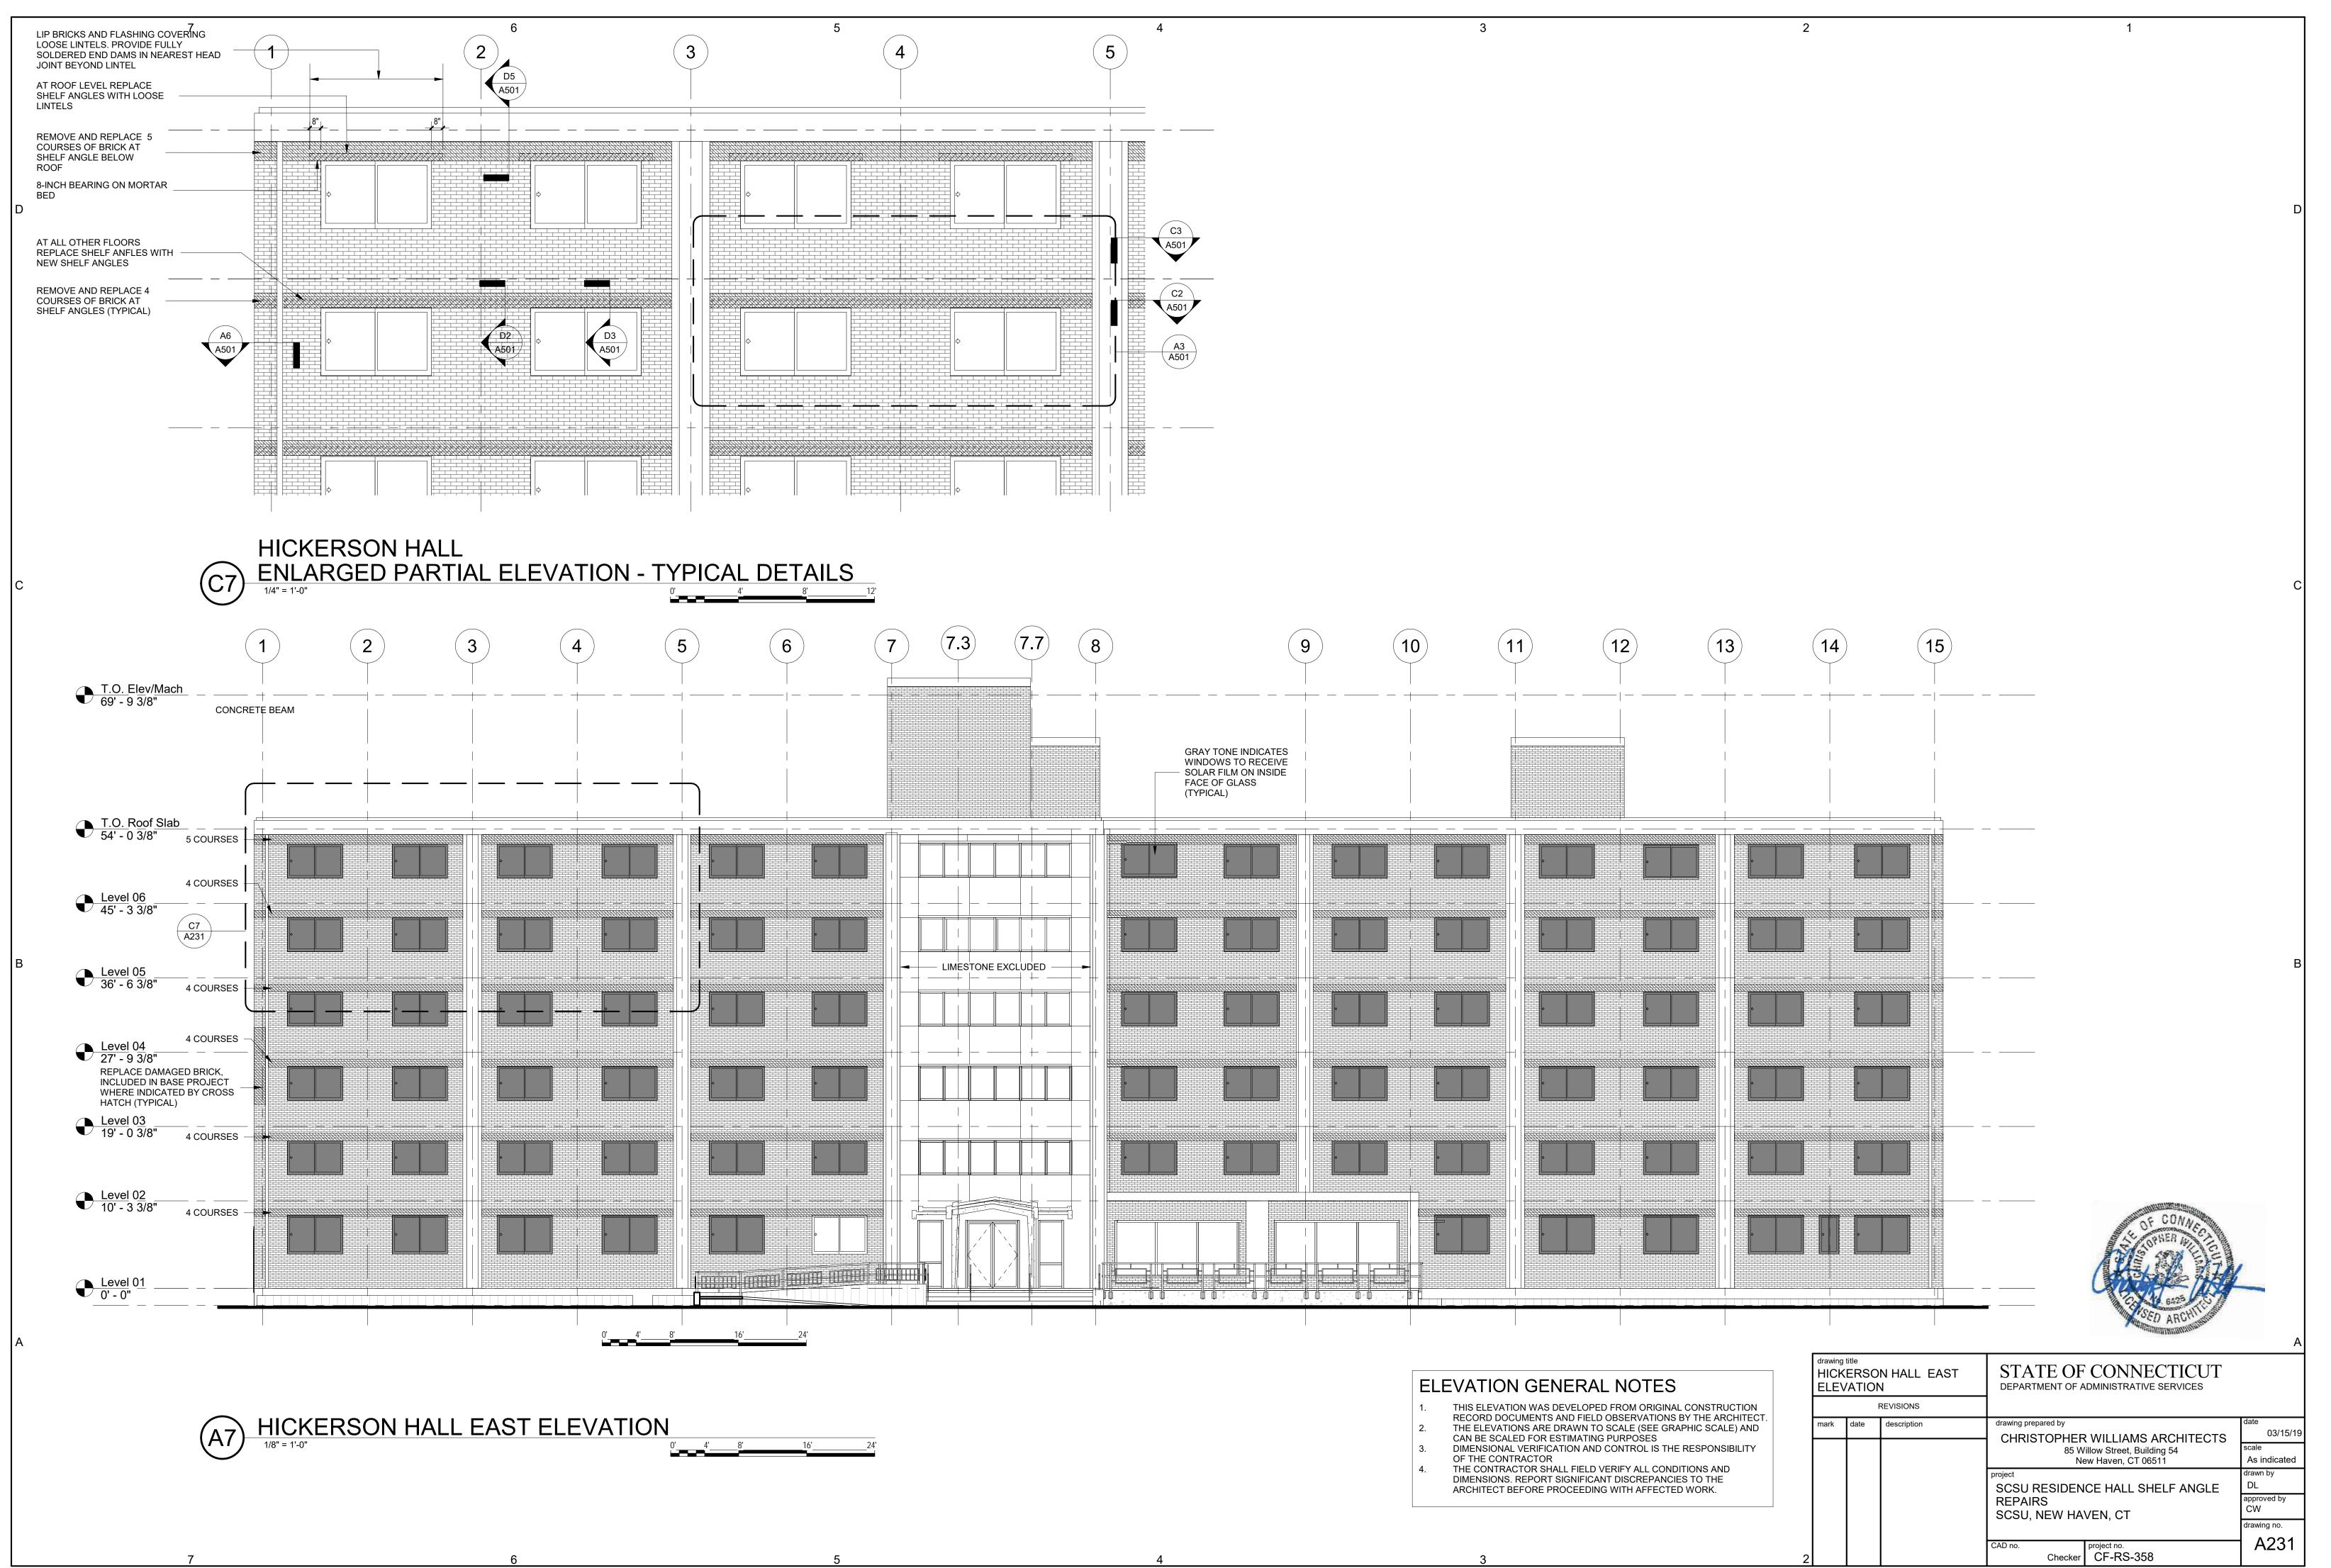_____ *4*

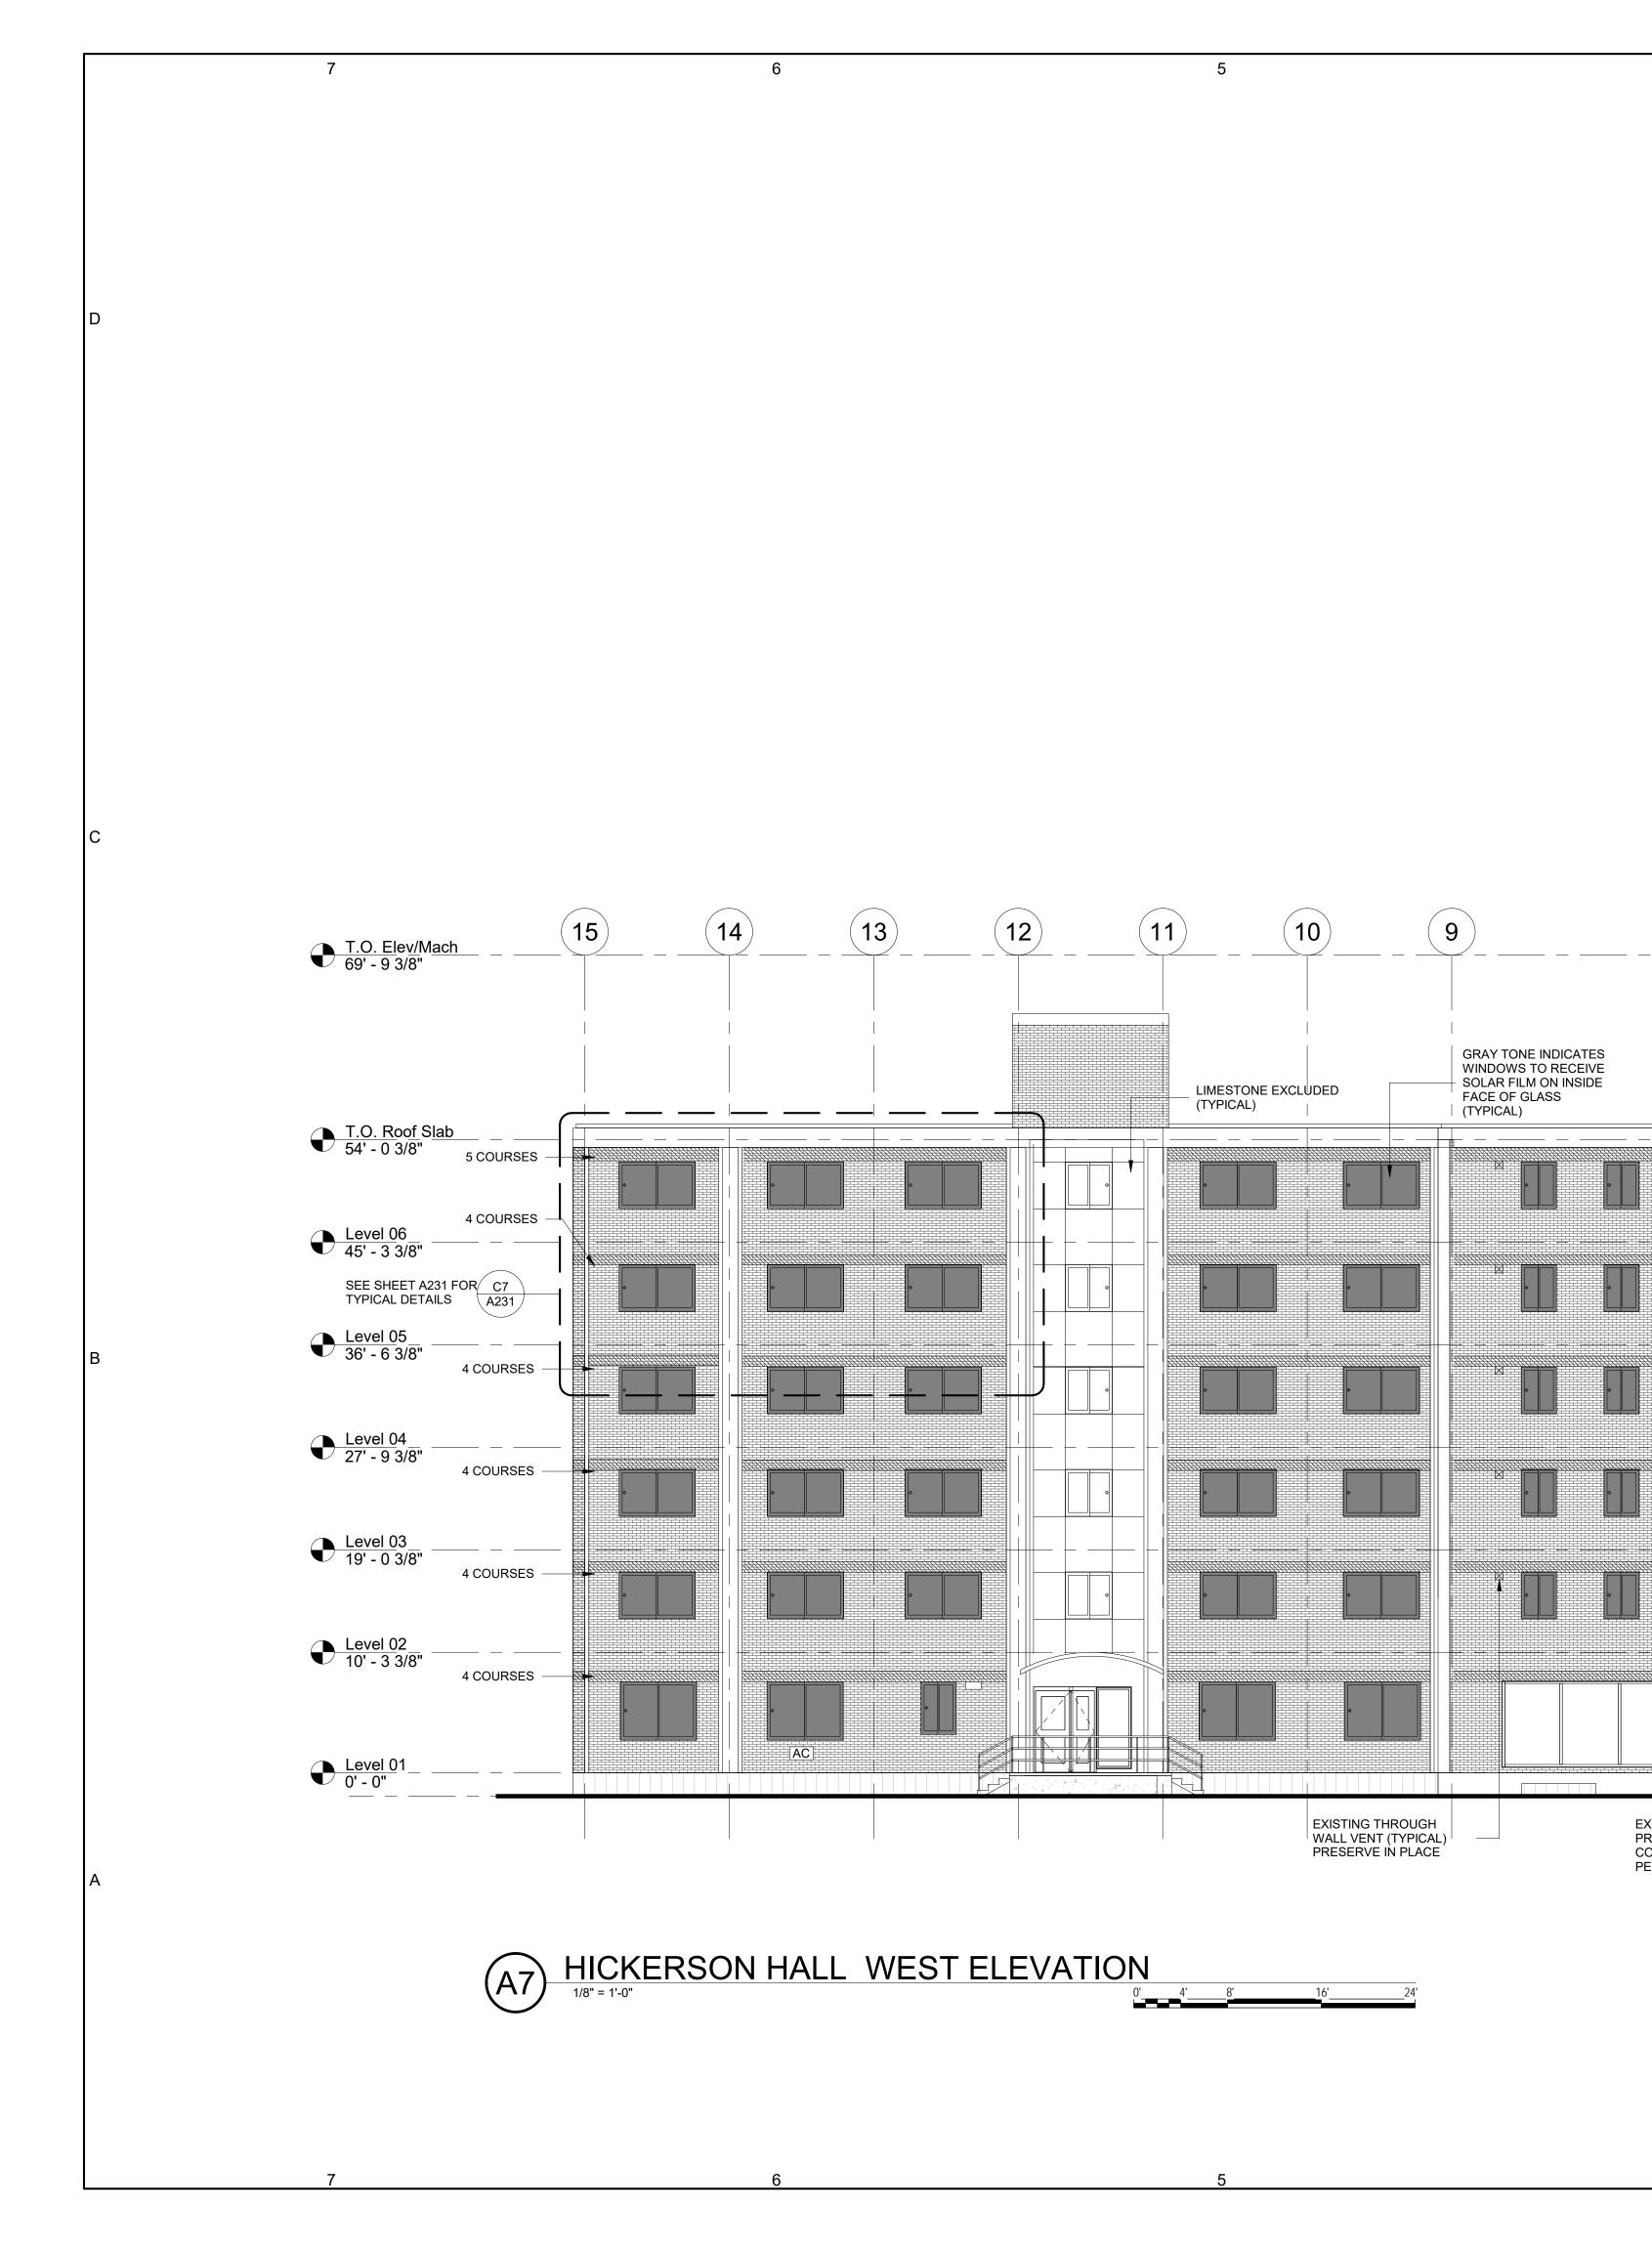
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OF THE CONTRACTOR

3



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 (\mathbf{A})

4
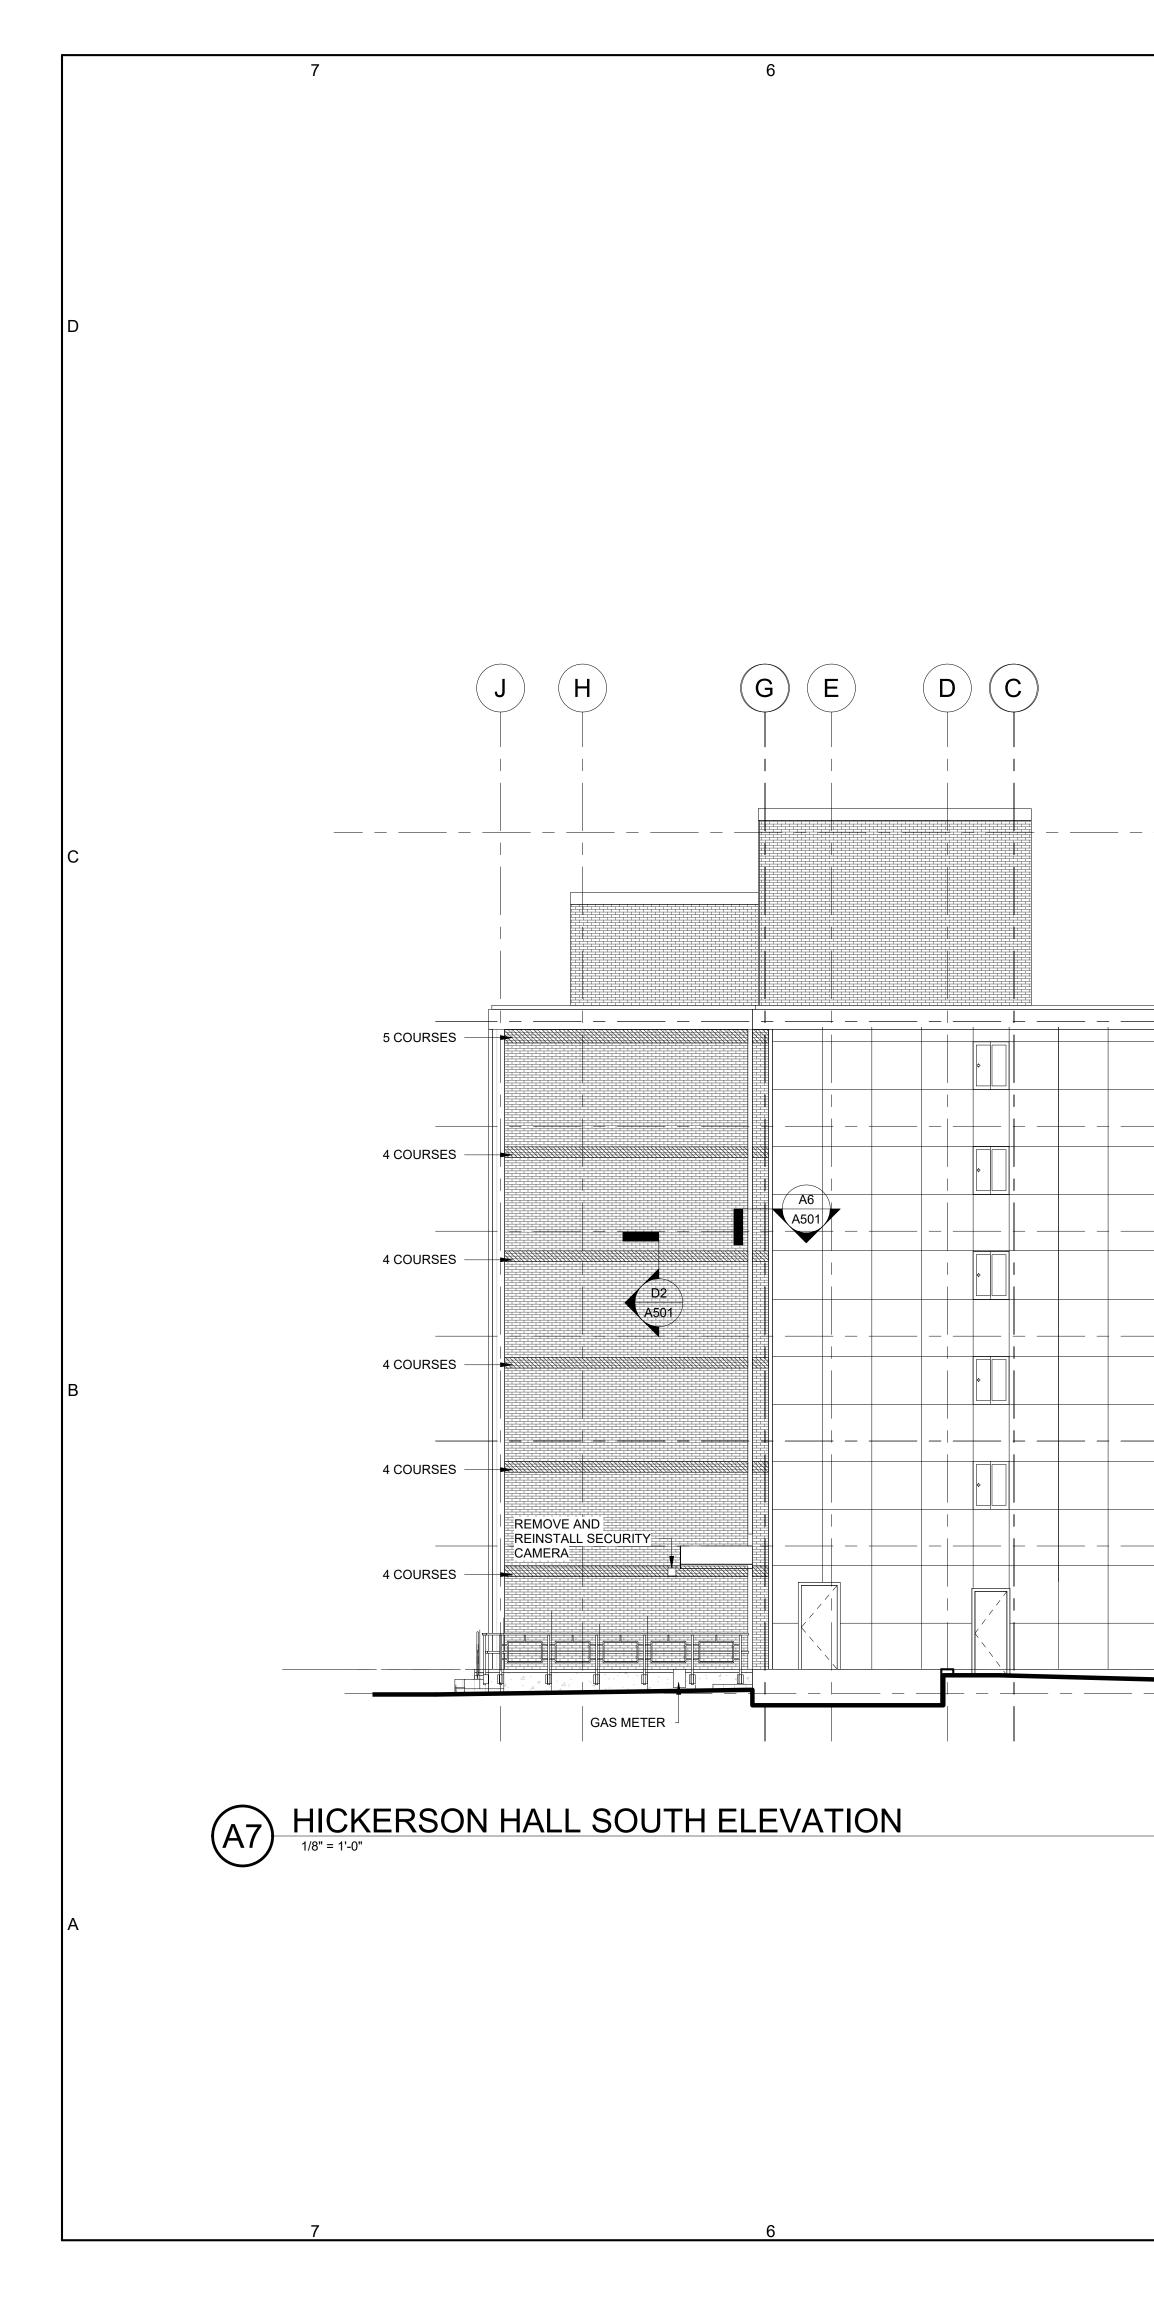
<u>T. O</u>. <u>Roof Slab</u> 54' - 0 3/8"

45' - 3 3/8"

Level 05 36' - 6 3/8"

27' - 9 3/8"

19' - 0 3/8"

10' - 3 3/8"

<u><u><u>G</u>rade</u> -2' - 0"</u>

LIMESTONE EXCLUDED (TYPICAL)

5 COURSES

A6

— 4 COURSES

— 4 COURSES

8' 16'

REPLACE DAMAGED BRICK,

INCLUDED IN BASE PROJECT WHERE INDICATED BY CROSS HATCH (TYPICAL)

A501

<u>T.O. Elev/Mach</u> 69' - 9 3/8"

T.O. Roof Slab 54' - 0 3/8"

Level 06 45' - 3 3/8"

Level 05 36' - 6 3/8"

Level 04 27' - 9 3/8"

Level 03 19' - 0 3/8"

Level 02 10' - 3 3/8"

<u>Level 01</u> 0' - 0"

| EL | EVATION GENERA |
|----|----------------------------|
| 1 | THIS ELEVATION WAS DEVELOP |


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(U.A.U.

CAN BE SCALED FOR ESTIMATING PURPOSES


OF THE CONTRACTOR



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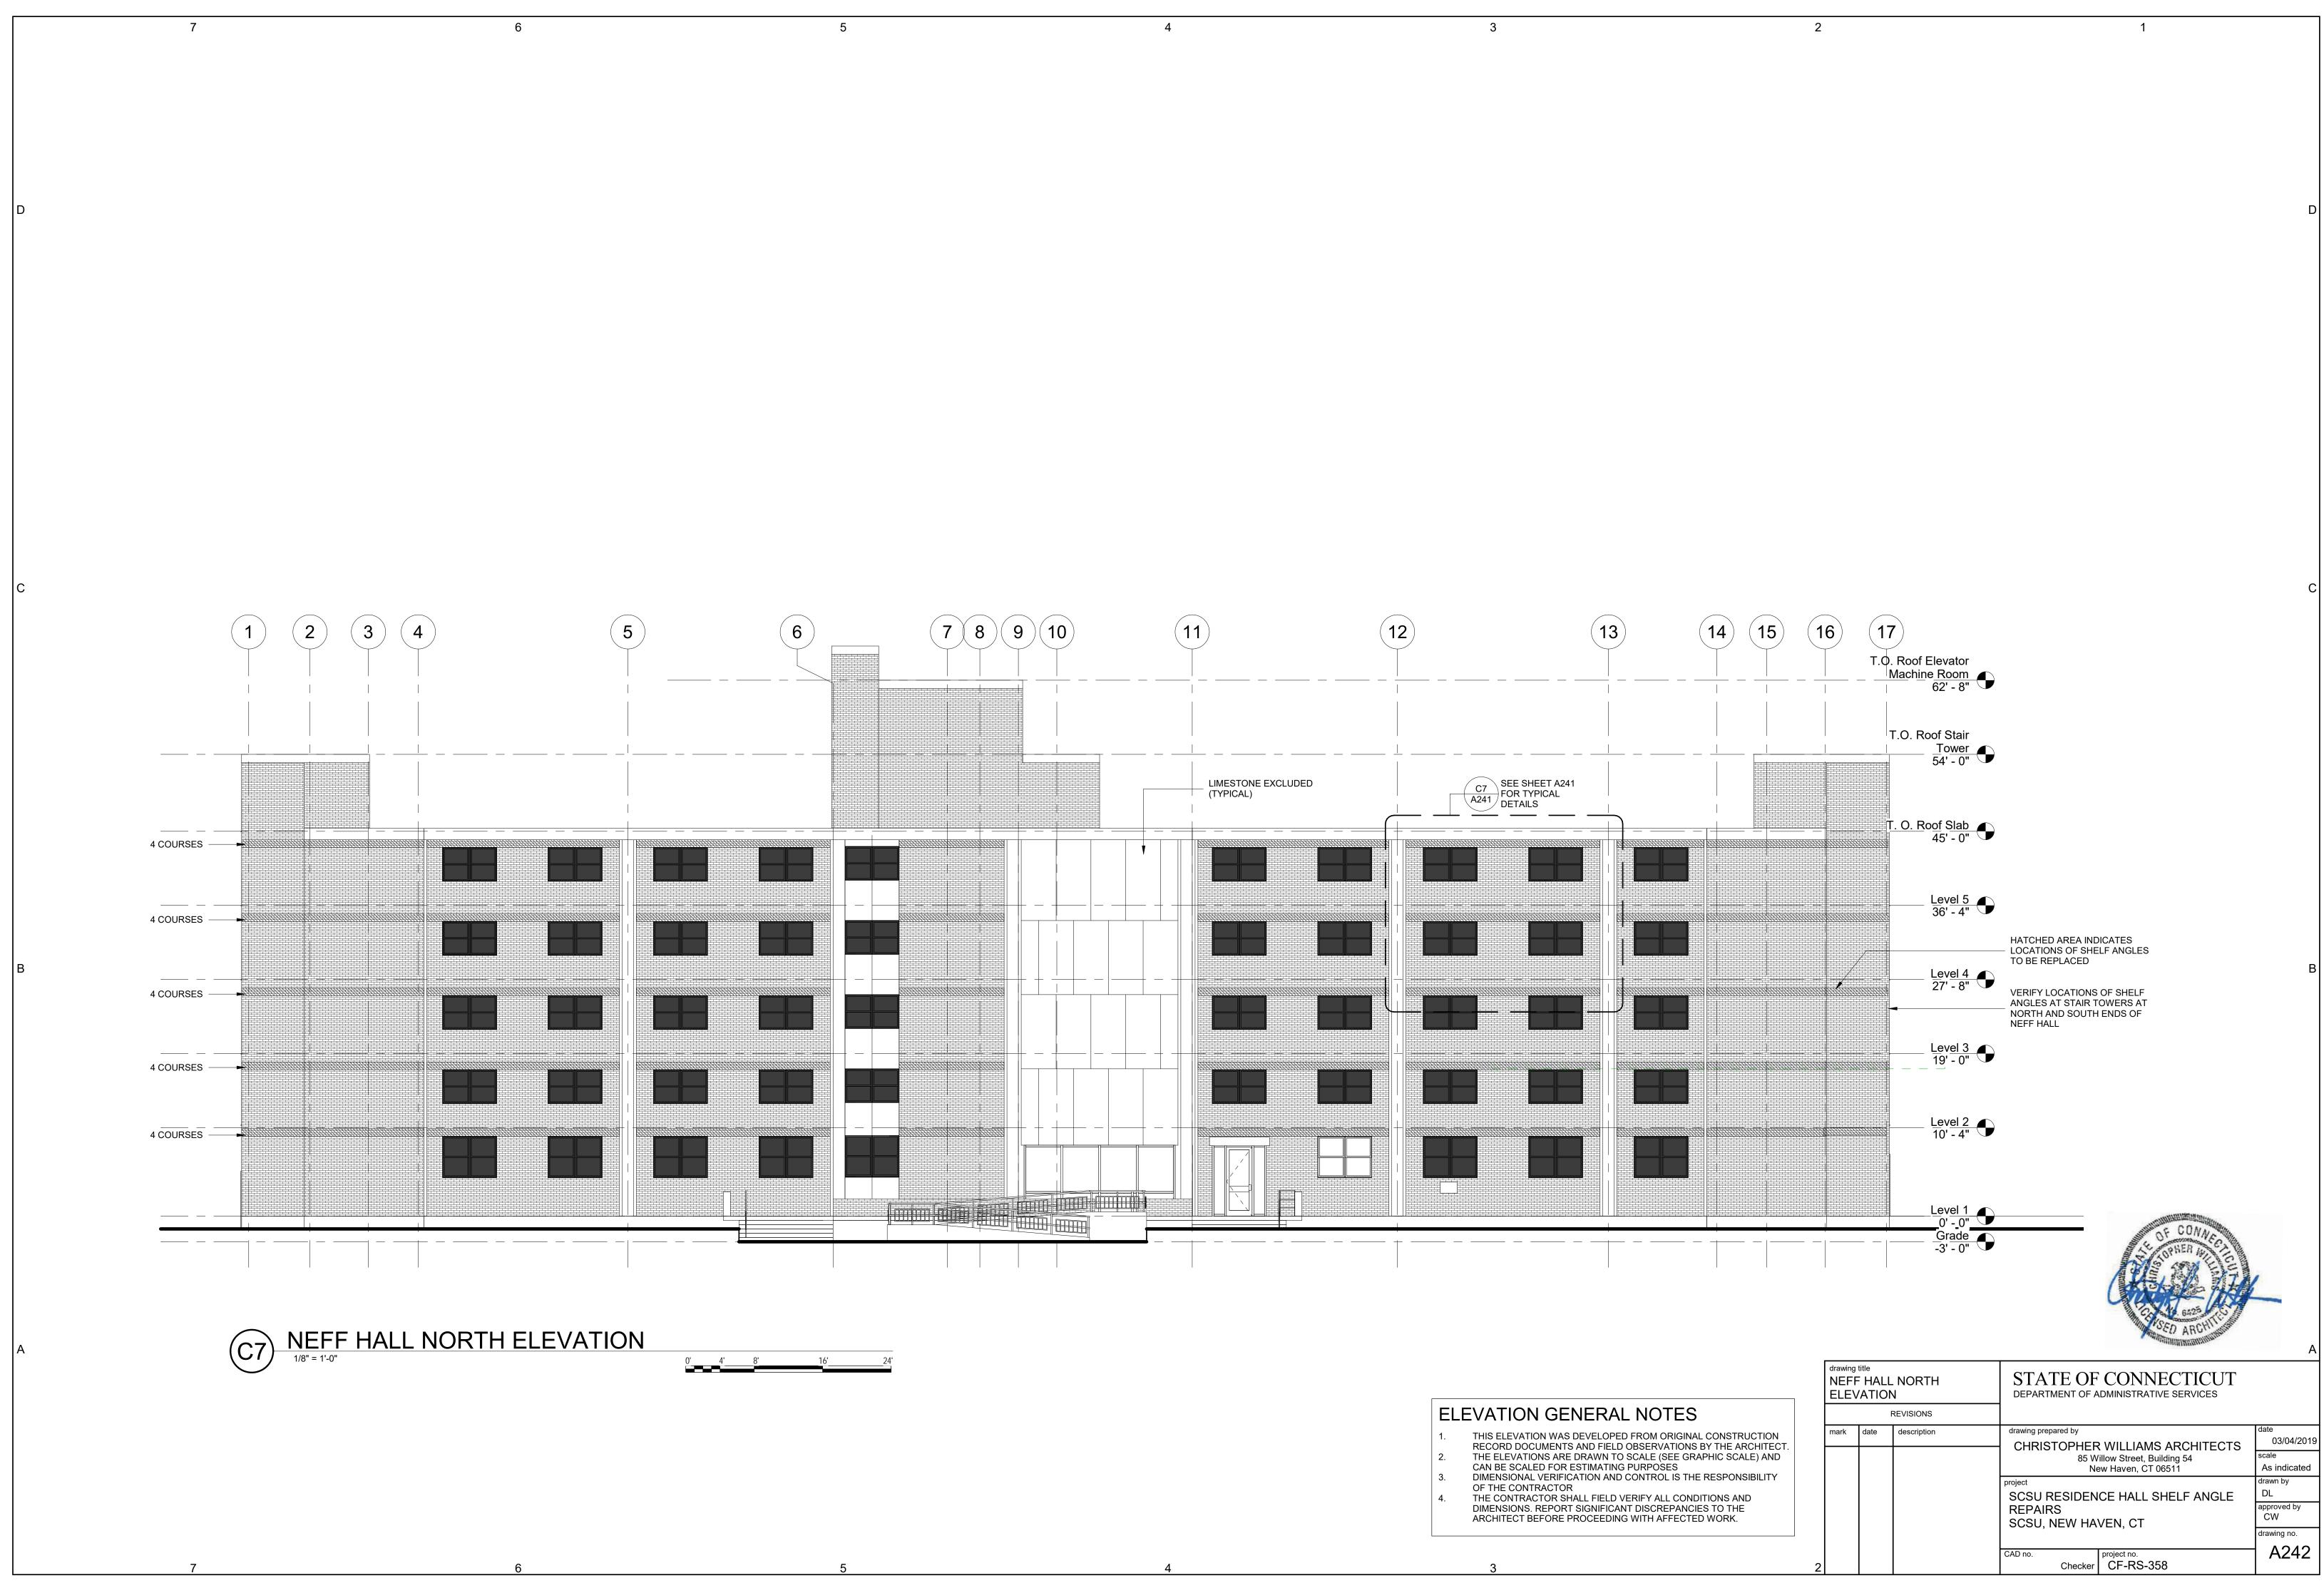

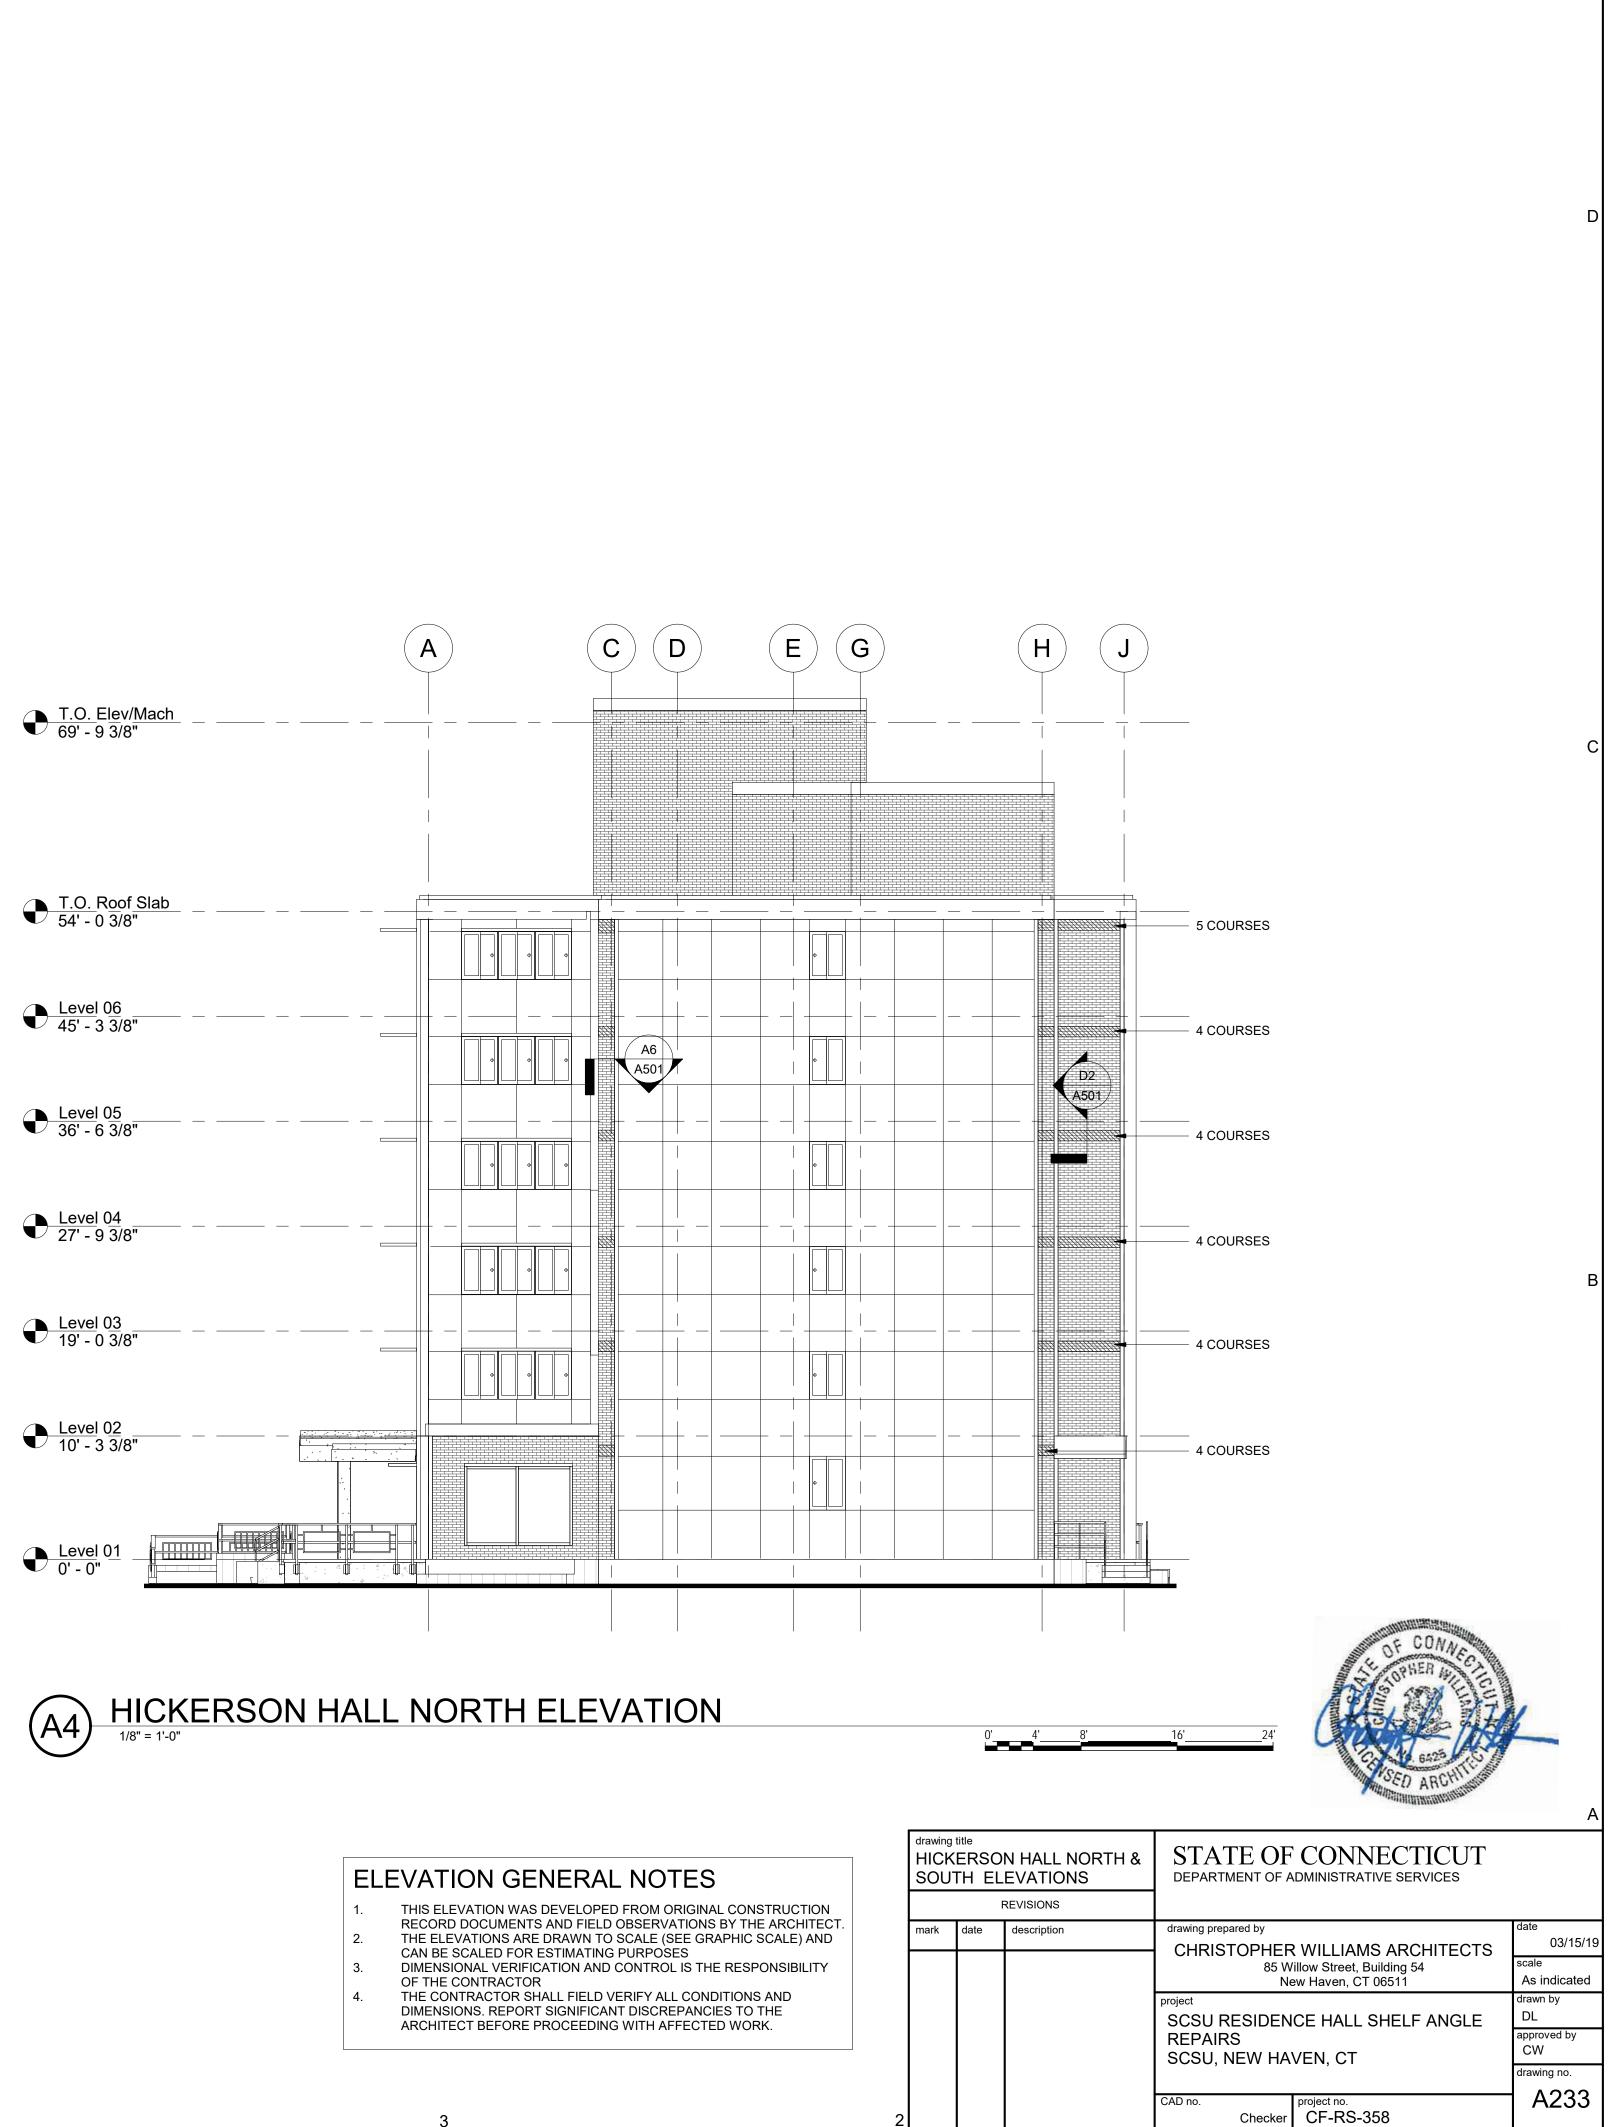
| 4 | 3 2 | 2 1 | |
|----------------|-----|----------------|--|
| | | | .O. Roof Stair <u>Tower</u> 54' - 0" |
| -/+0-, -/- | | T 1 | . O. Roof Slab 45' - 0" REPLACE EXISTING |
| | | | SHELF ANGLE WITH NEW PER D2/A501 Level 5 36' - 4" |
| | | | Level 4 27' - 8" |
| | | | <u>Level 3</u> 19' - 0" |
| | | | Lev <u>el 2</u> 10' - 4" |
| | | | Level 1 0' - 0" Grade -3' - 0" |

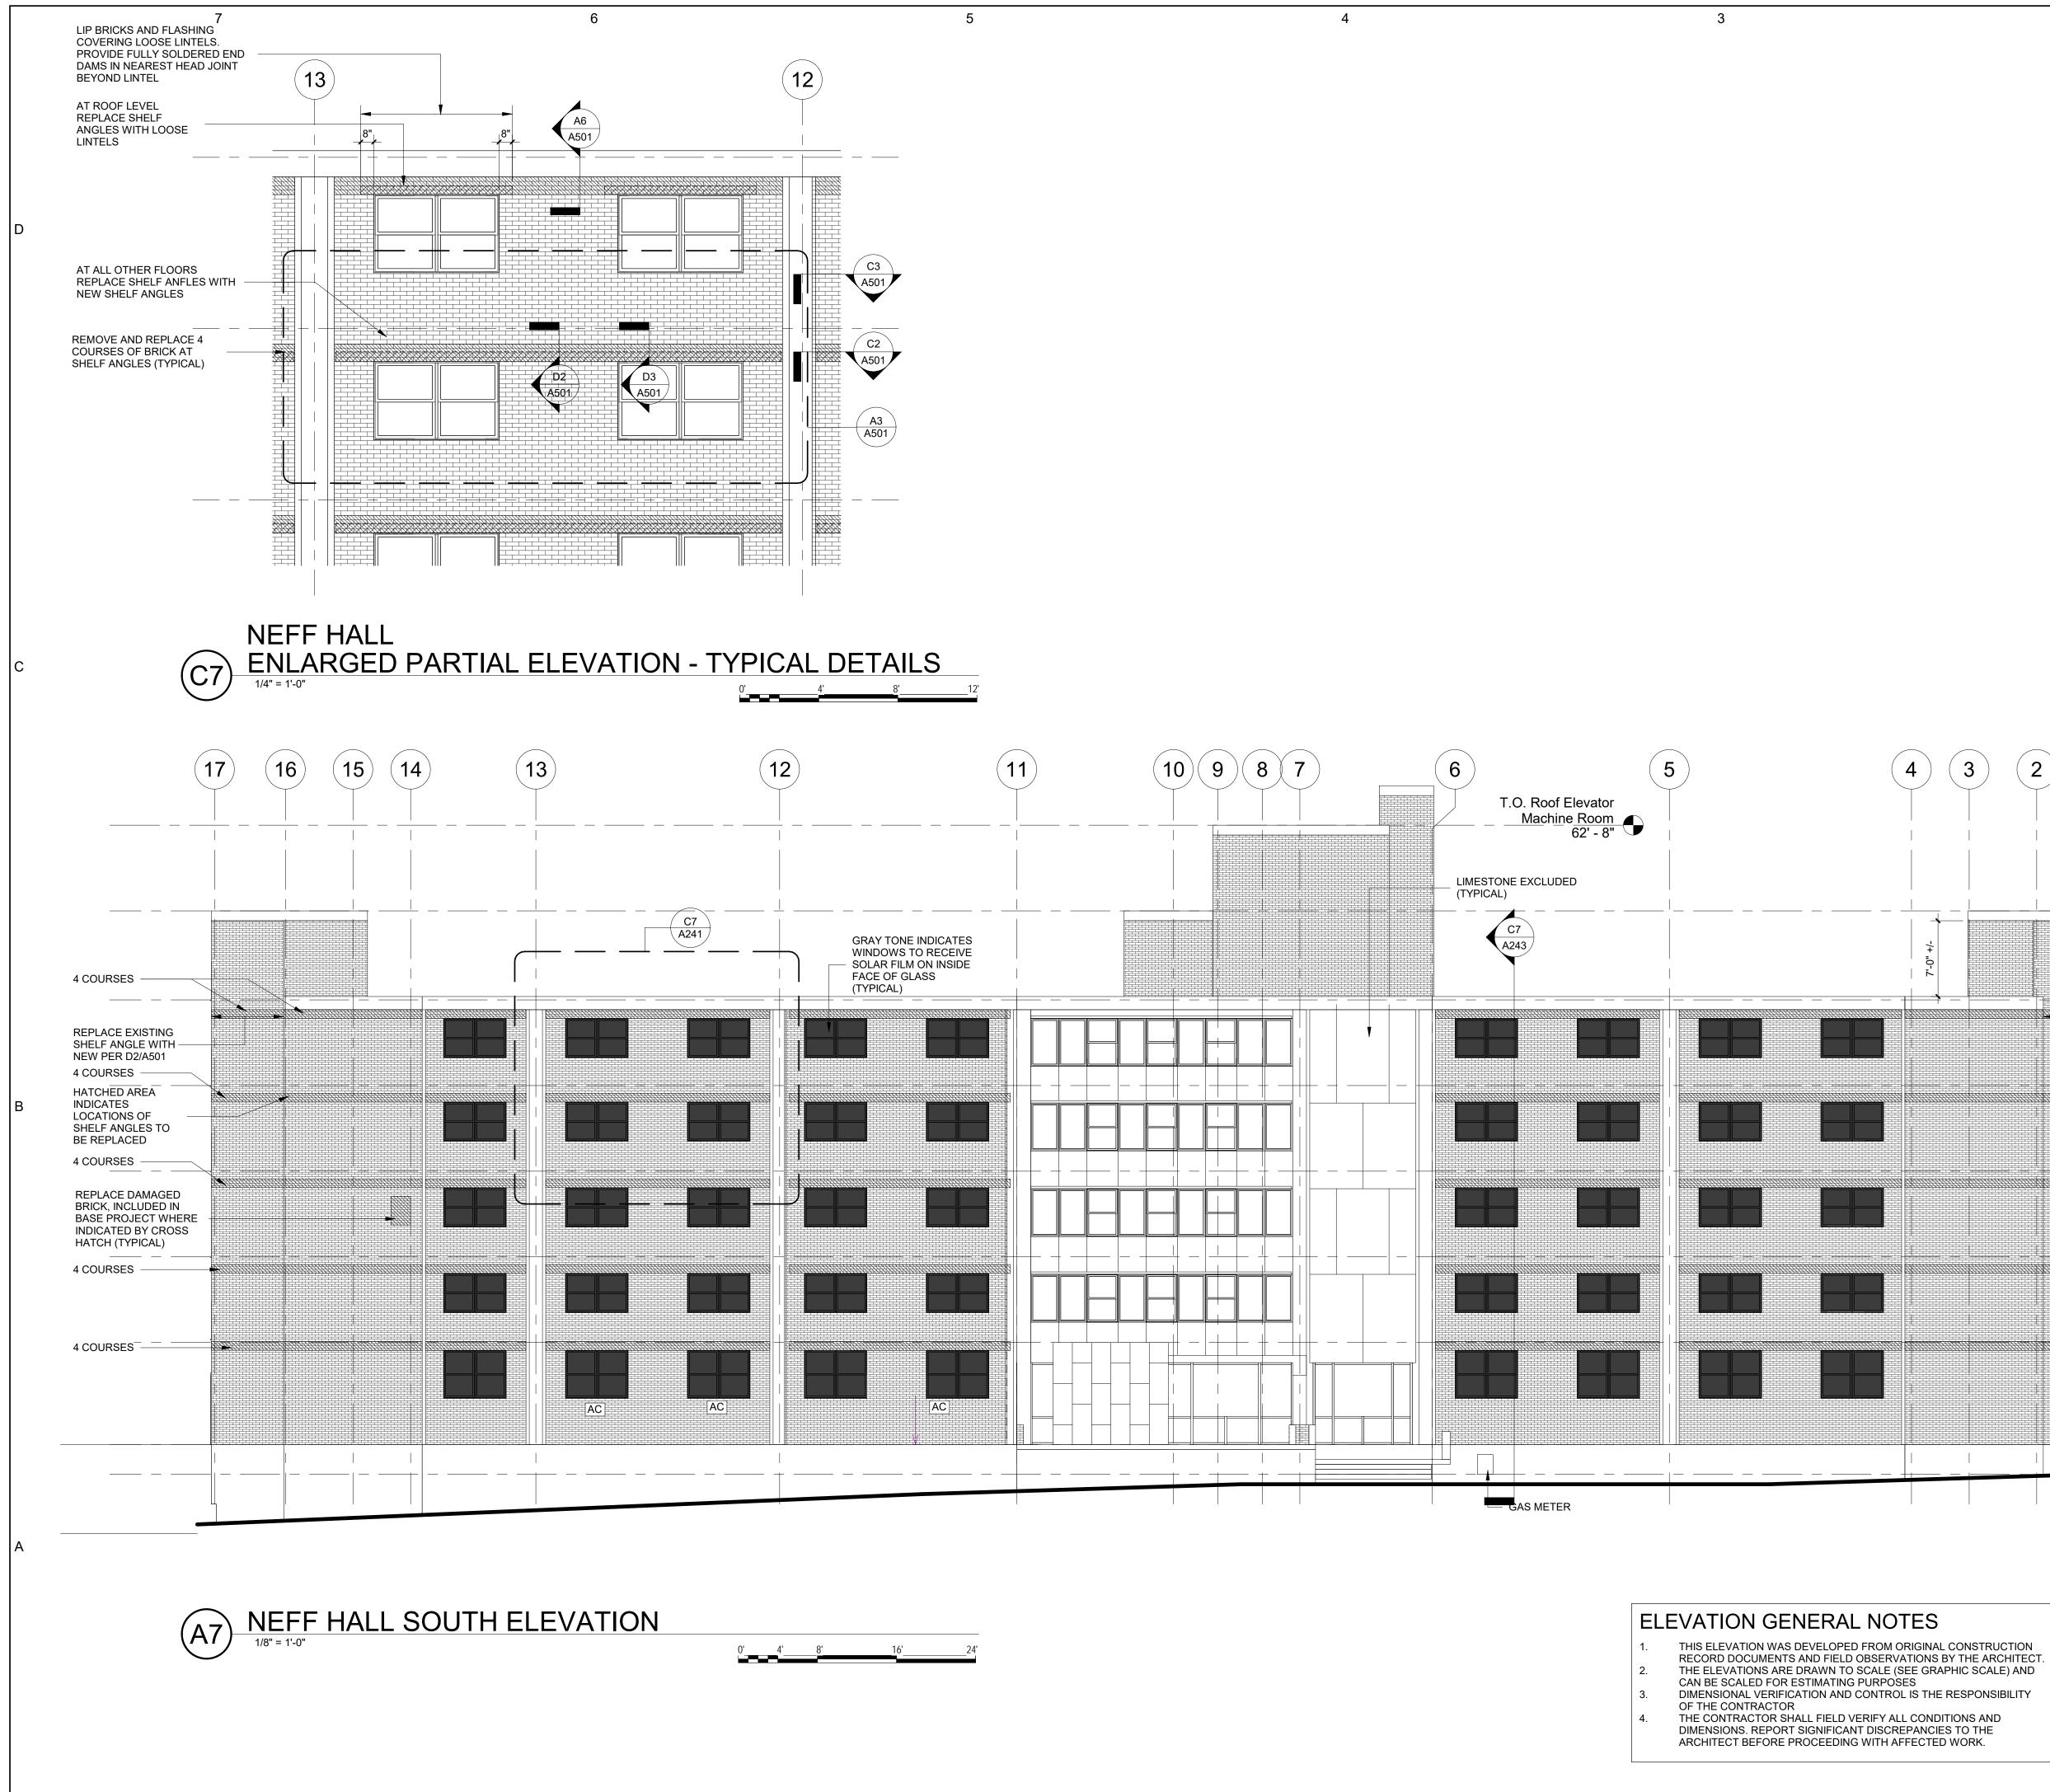


| | | | | ~ |
|---|----------------|--|---|--|
| drawing title NEFF HALL SOUTH ELEVATION | | STATE OF CONNECTICUT DEPARTMENT OF ADMINISTRATIVE SERVICES | | |
| | REVISIONS | | | |
| mark dat | te description | 85 W | R WILLIAMS ARCHITECTS Villow Street, Building 54 ew Haven, CT 06511 | date 03/04/2019 scale As indicated |
| | | project SCSU RESIDENCE HALL SHELF ANGLE REPAIRS SCSU, NEW HAVEN, CT | | drawn by DL approved by CW drawing no. A241 |
| | | CAD no. Checker | project no. CF-RS-358 | |

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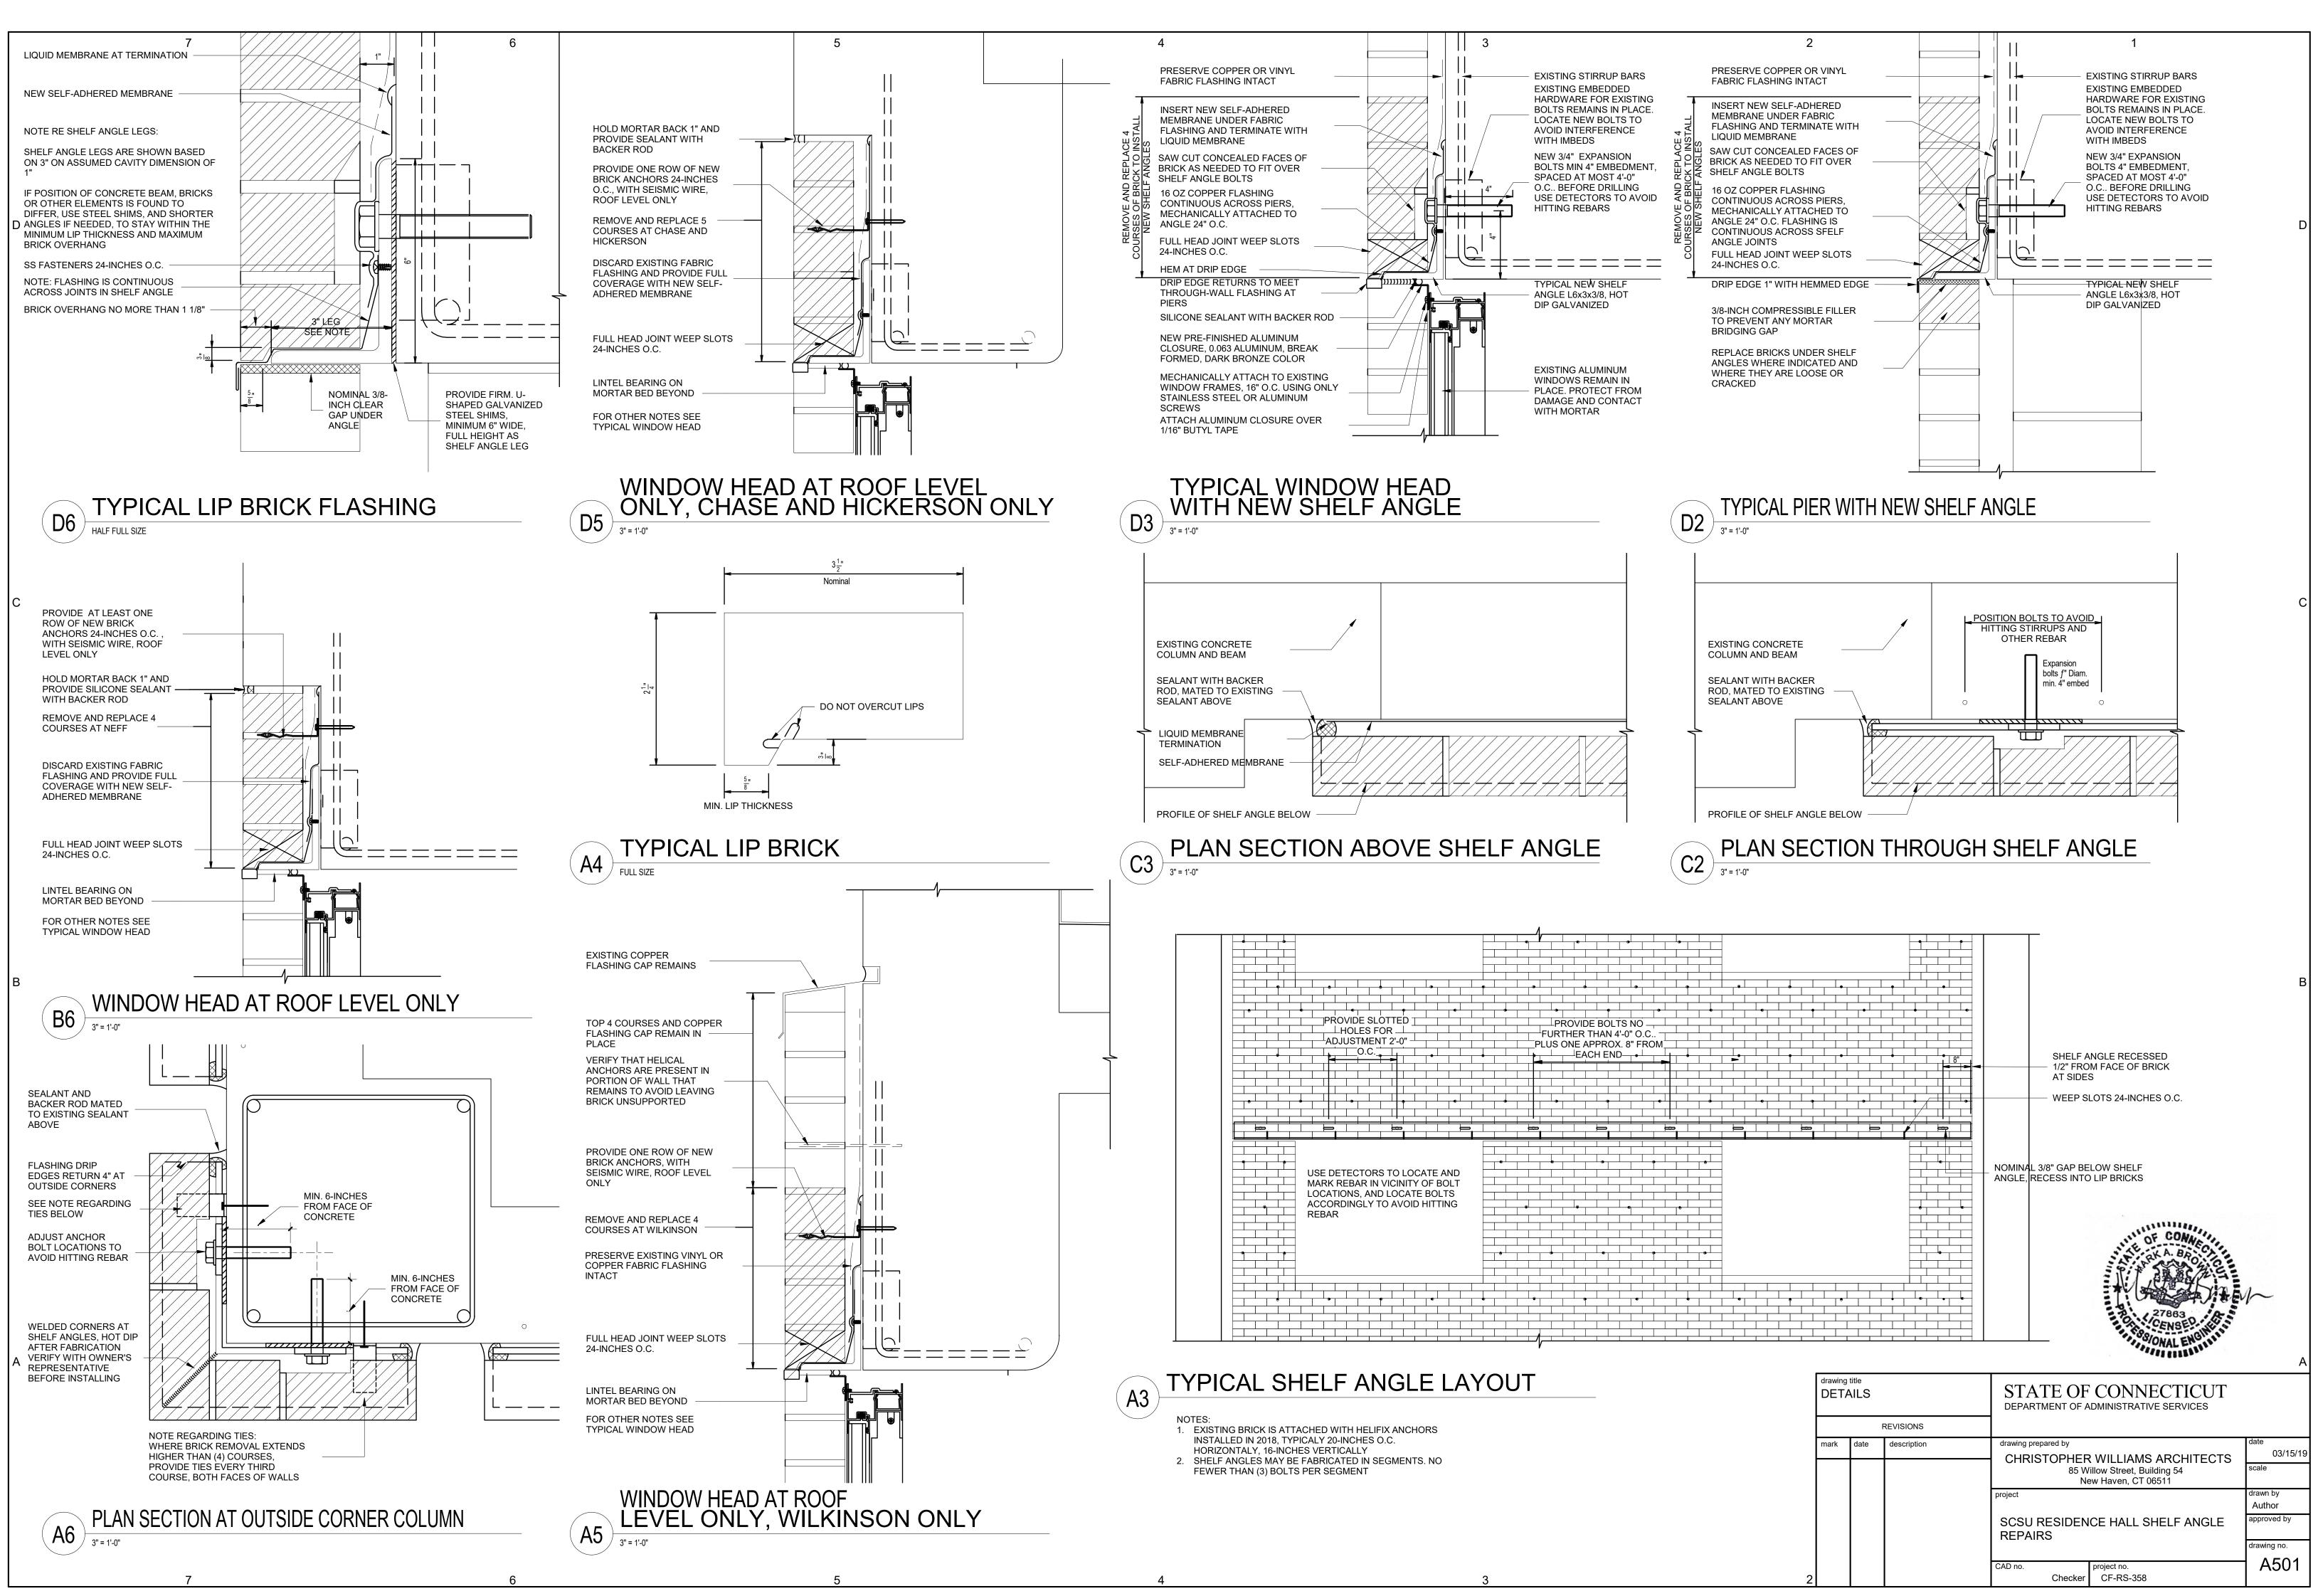
| ELEVATION | | N | DEPARTMENT OF ADMINISTRATIVE SERVICES | | |
|-----------|------|-------------|--|--------------------------|--|
| | | REVISIONS | | | |
| mark | date | description | drawing prepared by CHRISTOPHER WILLIAMS ARCHITECTS 85 Willow Street, Building 54 New Haven, CT 06511 | | date 03/04/2019 scale As indicated |
| | | | project SCSU RESIDENCE HALL SHELF ANGLE REPAIRS SCSU, NEW HAVEN, CT | | drawn by DL approved by CW drawing no. |
| | | | CAD no. Checker | project no. CF-RS-358 | A242 |
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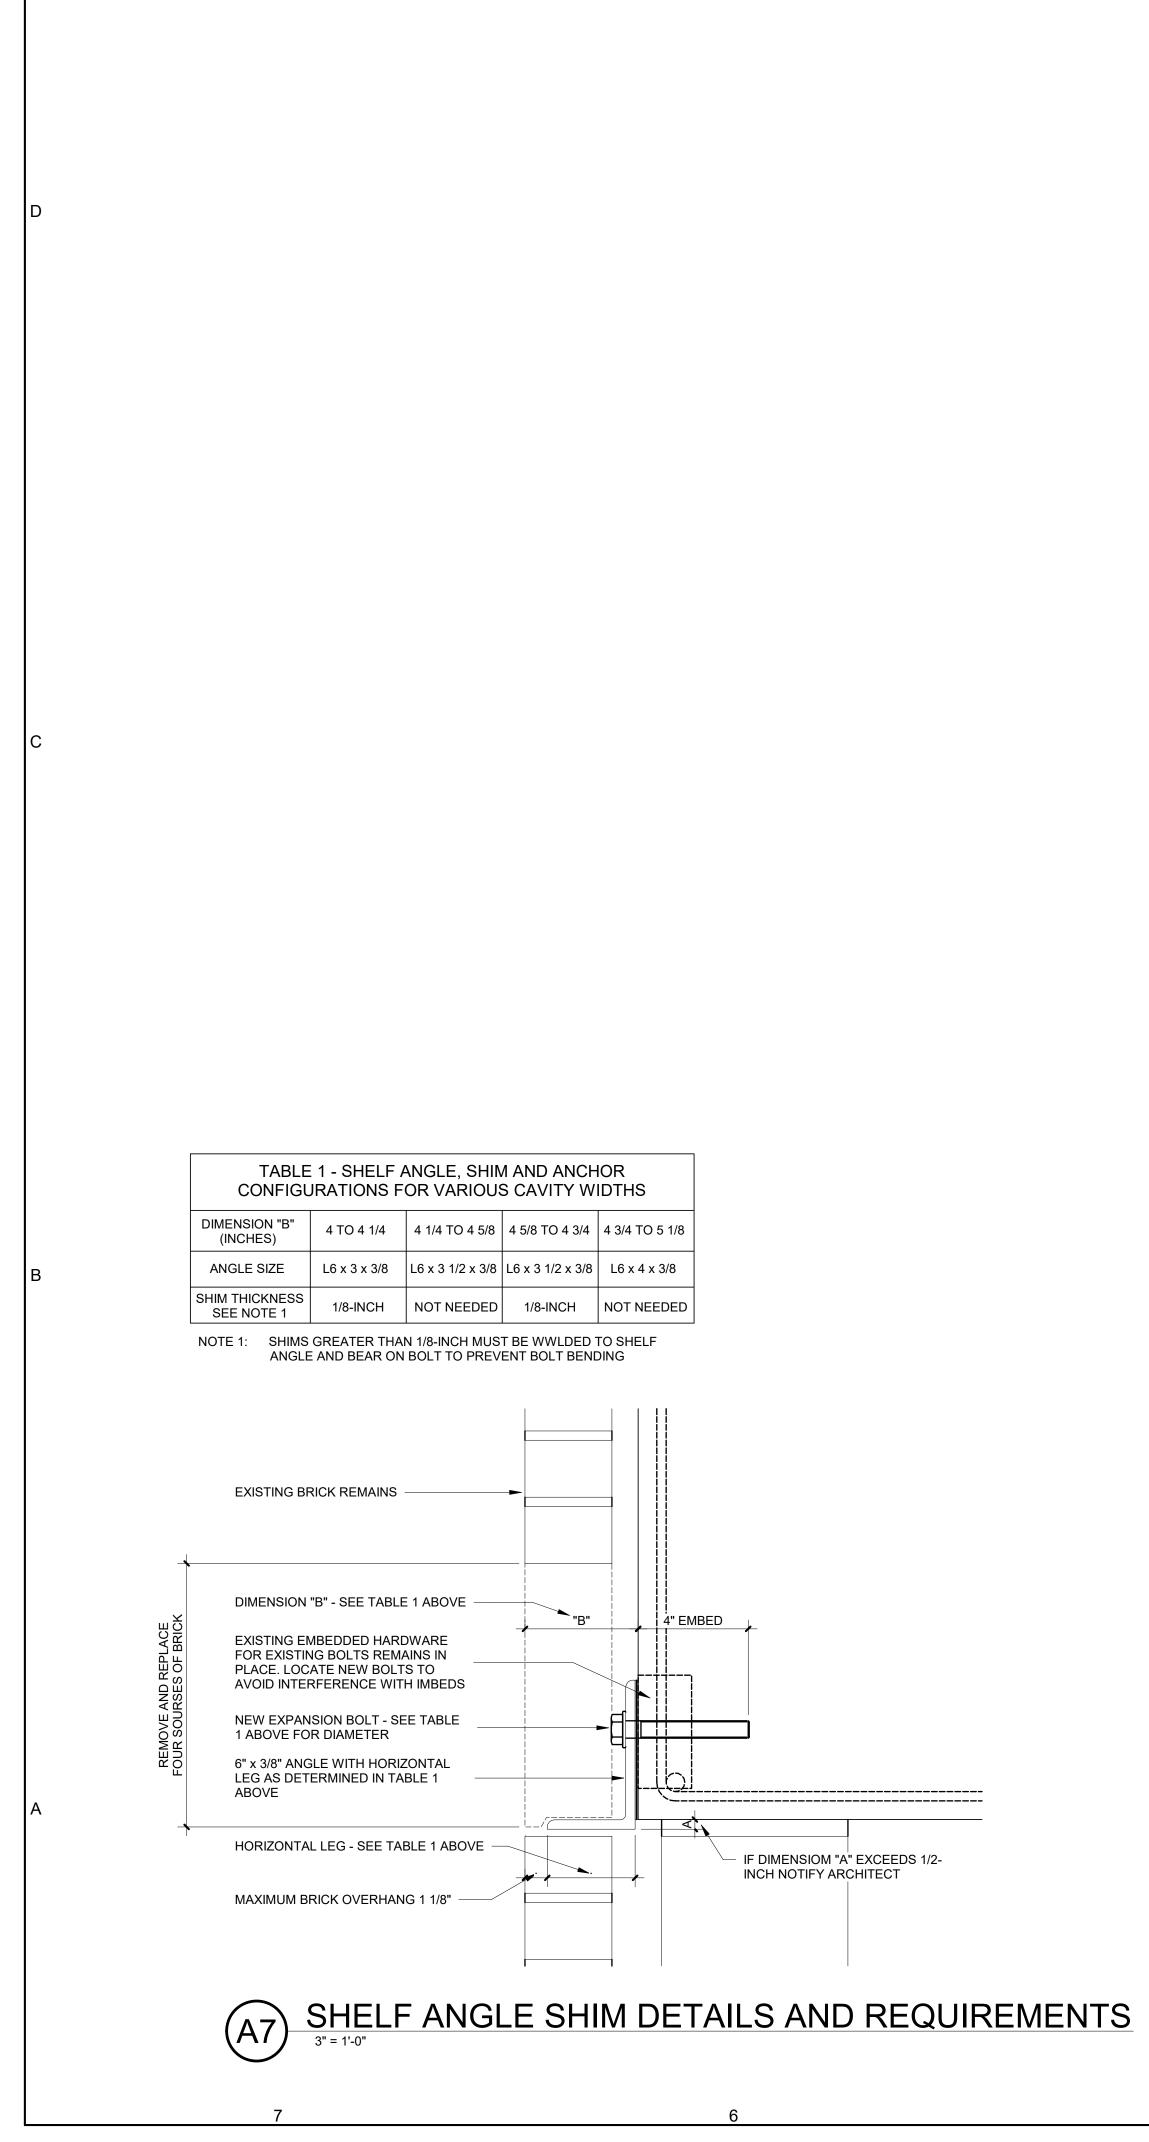


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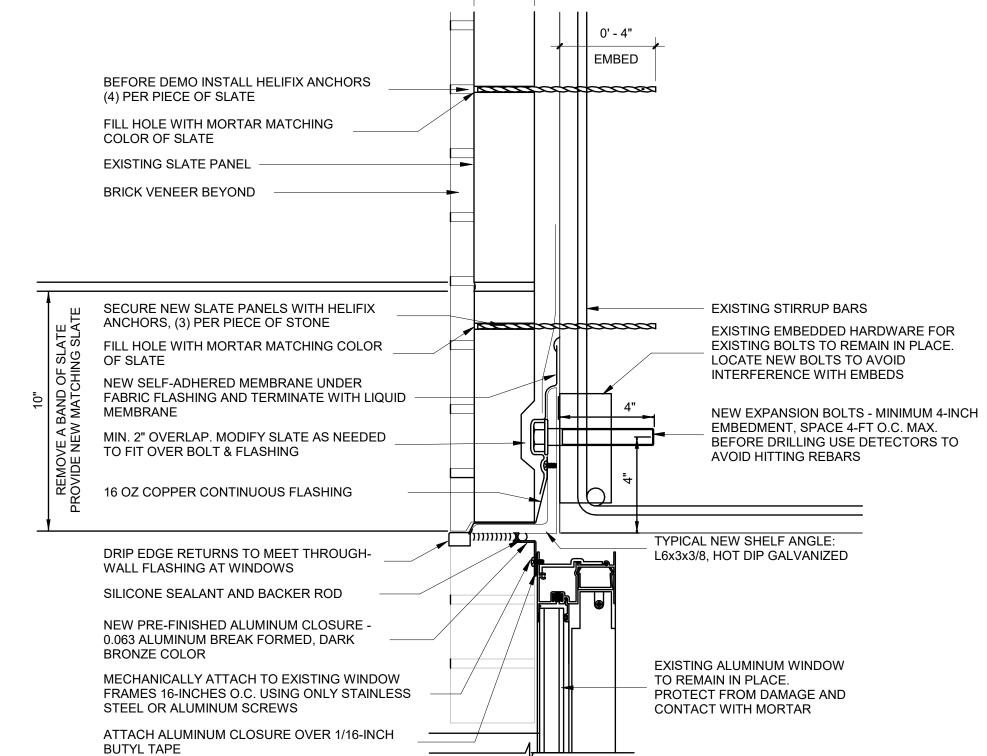


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7

A4 SLATE ANCHORING REPAIR DETAIL AT WINDOW HEAD

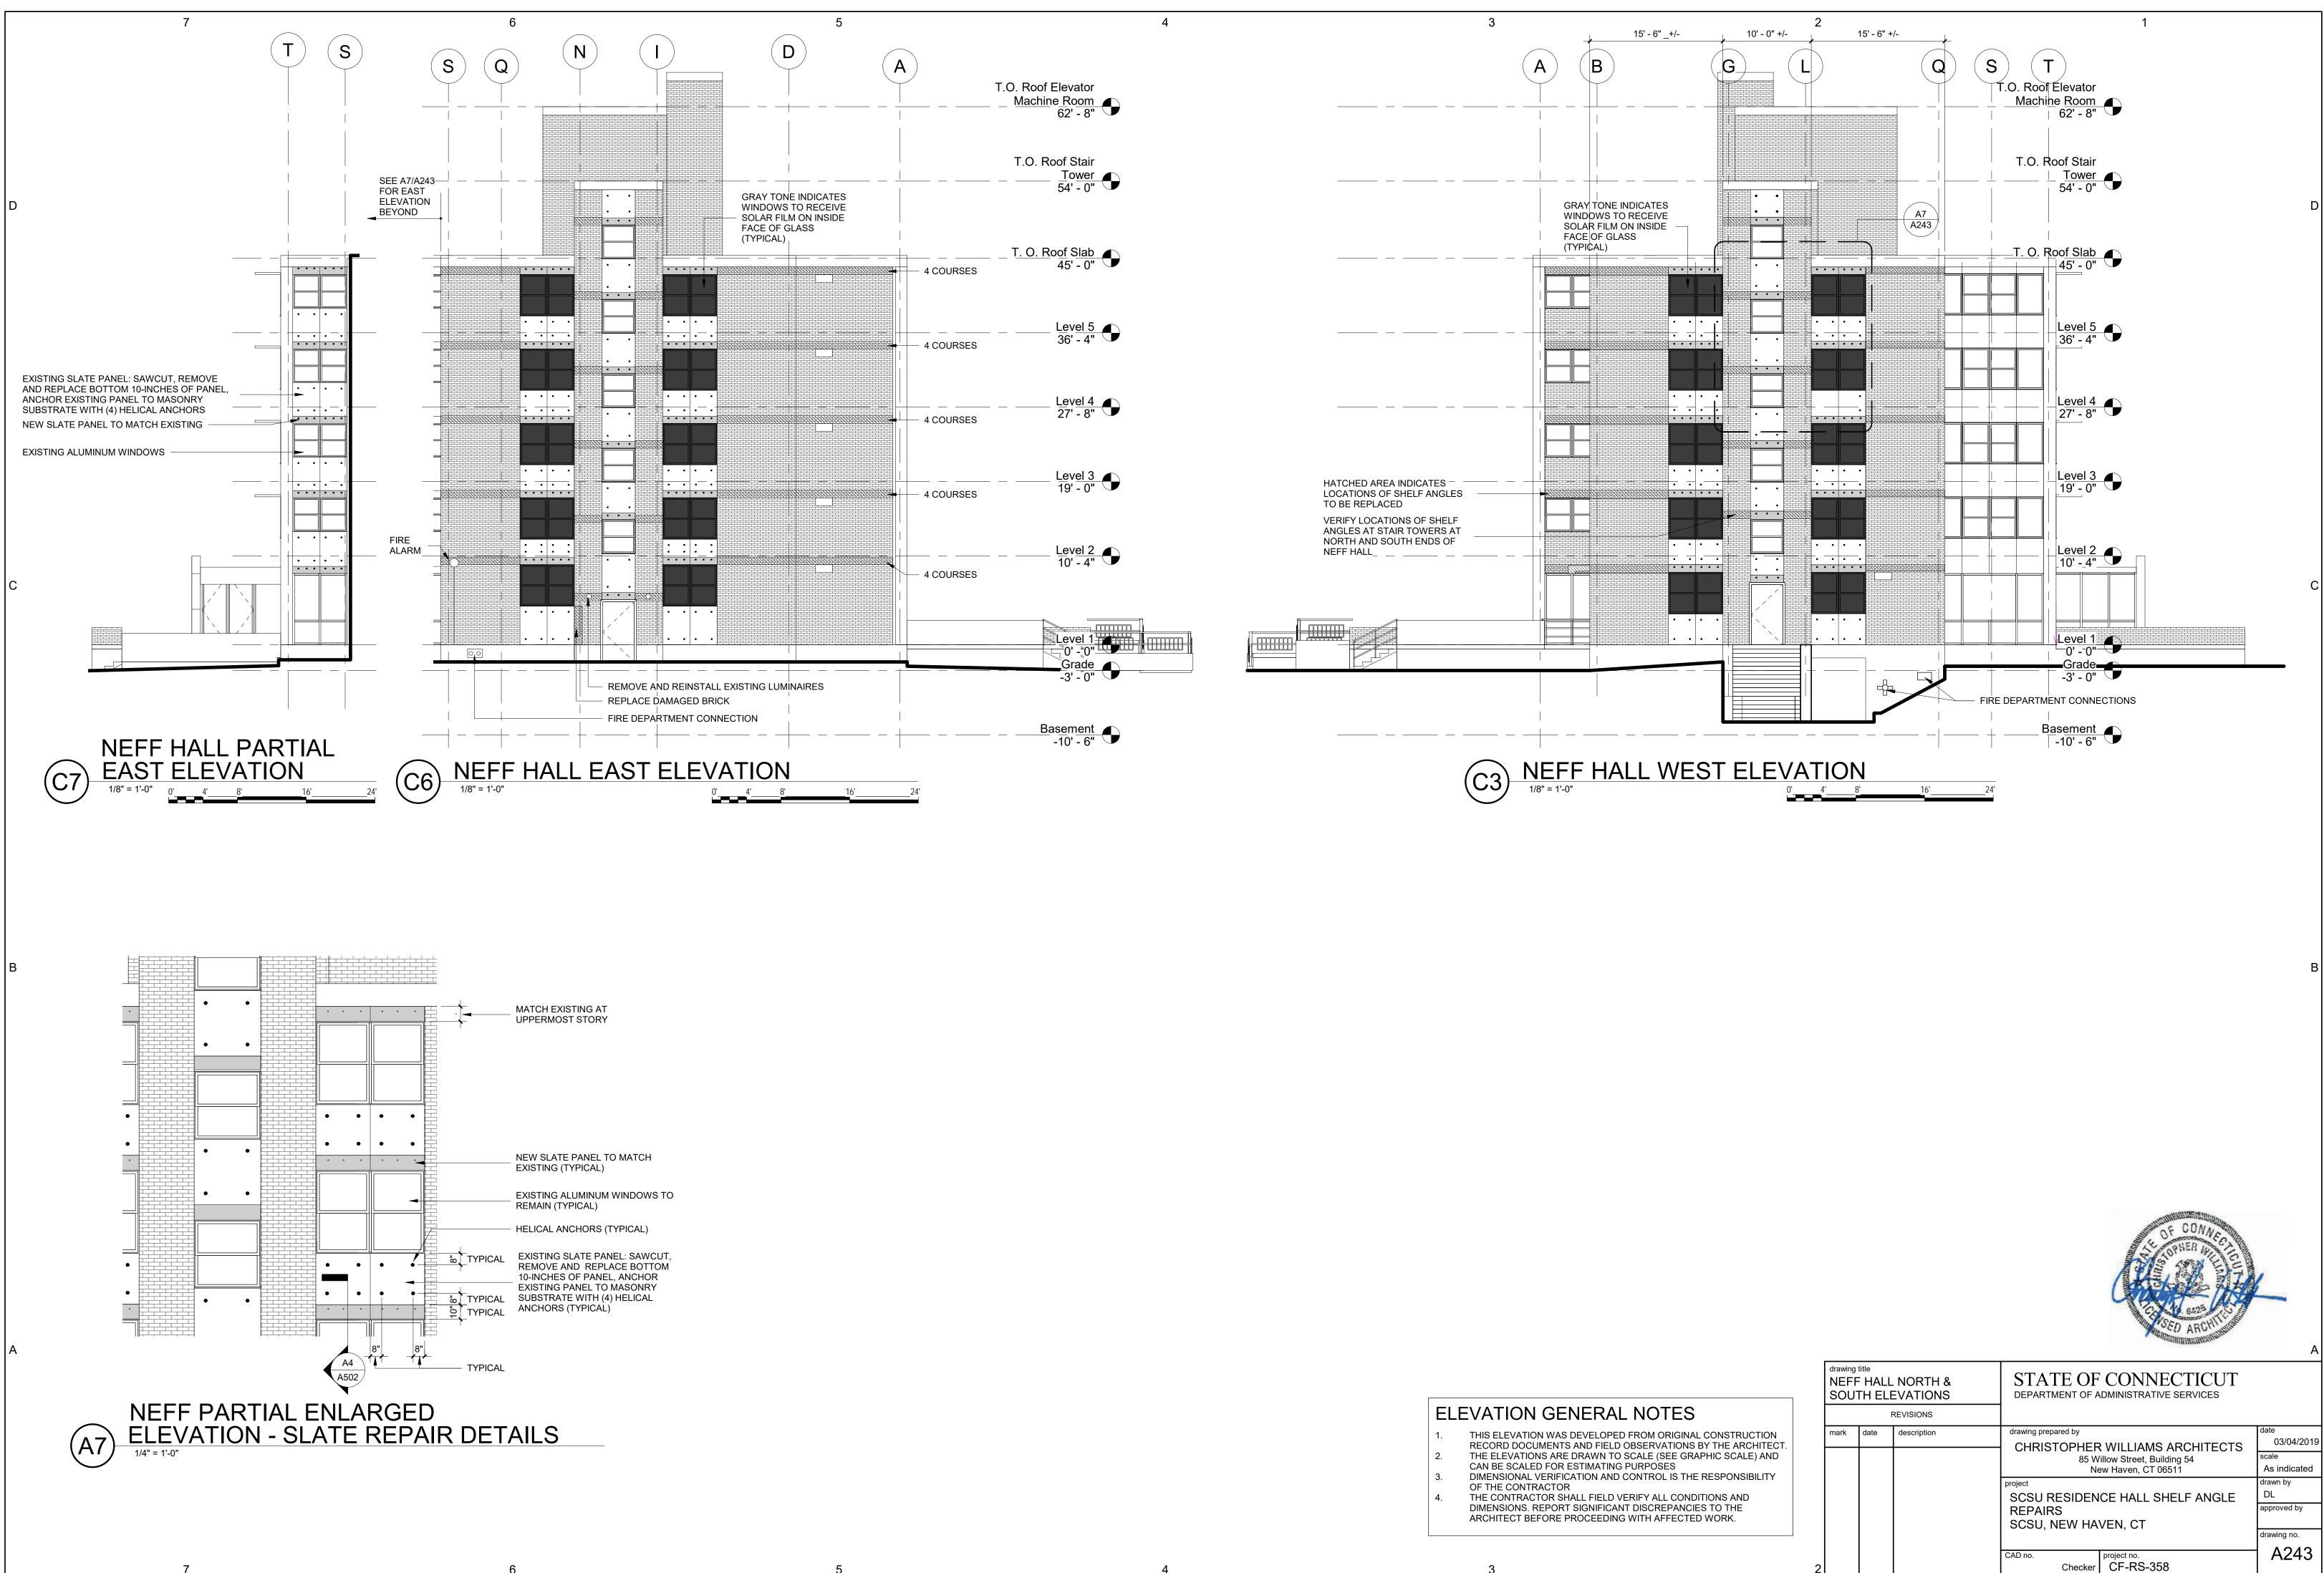

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|---|--|--------------|-----------------------|----------------------------|----------------------|
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|-------------------------|-------------|---|---------------------|
| rawing title DETAILS | | STATE OF CONNECTICUT DEPARTMENT OF ADMINISTRATIVE SERVICES | |
| | REVISIONS | | |
| nark date | description | drawing prepared by CHRISTOPHER WILLIAMS ARCHITECTS | date 03/15/19 |
| | | 85 Willow Street, Building 54 New Haven, CT 06511 | scale 3" = 1'-0" |
| | | project SCSU RESIDENCE HALL SHELF ANGLE | drawn by Author |
| | | REPAIRS SCSU, NEW HAVEN, CT | approved by |
| | | | drawing no. |
| | | CAD no. project no. Checker CF-RS-358 | A502 |

1111144,

THICKNESS OF NEW SLATE SAME AS EXISTING



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| MASONRY CLEANING WASTE AND DEBRIS SOIL EROSION AND SEDIMENT CONTROL PRACTICES MUST BE INSTALLED IN ACCORDANCE WITH THE LOCAL GOVERNING AUTHORITY AND THE CONNECTCUT GUIDELINES FOR SOIL EROSION AND SEDIMENT CONTROL. EROSION AND SEDIMENT CONTROL DEVICES MUST BE INSTALLED PRIOR TO START OF SITE PREPARATION AND DEMOLITION. ALL EARTH CHANCES SHALL BE DESIGNED, CONSTRUCTED, AND COMPLETED IN SUCH A MANNER SO THAT THE EXPOSED AREA OF ANY DISTURBED LAND SHALL BE LIMITED TO THE SHORTED FOSSIBLE PRIOD OF TIME. EROSION AND SEDIMENT CONTROL DEVICES MUST BE INSTALLED PRIOR TO START OF SITE PREPARATION AND DEMOLITION. ALL EARTH CHANCES SHALL BE DESIGNED, CONSTRUCTED, AND COMPLETED IN SUCH A MANNER SO THAT THE EXPOSED AREA OF ANY DISTURBED LAND SHALL BE LIMITED TO THE SHORTEST POSSIBLE PRIOD OF TIME. DISPOSAL OF COLLECTED SEDIMENT SHALL BE LEGALLY DISPOSED OF OF SITE. THE CONTRACTOR IS RESPONSIBLE FOR THE MANTENANCE OF ALL PAVED ROADWAYS, ON AND OFF-SITE, WHICH MUST BE KEPT FREE OF SITE GENERATED SEDIMENT AT ALL TIMES. DUST SHALL BE CONTROLLED BY SPRINKLING OR OTHER APPROVED METHOD. ALL STORM DRAINAGE OUTLETS MUST BE STABILIZED, BEFORE OF THE DISCHARGE POINTS BECOME OPERATIONAL SILT FENCES AND BARRIERS MUST BE CONTINUOUSLY MAINTAINED BY CLEANING & REFLACED TO REMOVE SILT ACCUMULATION ALL EROSION AND SEDIMENT CONTROL DEVICES MUST BE INSPECTED ON A DALY PASIS AND CLEANED IMMEDIATELY AFTER EACH STORY ONDITIONS OR FIELD OPERATIONS IMMEDIATELY AND IN ACCORDANCE WITH THE GUIDELINES FOR SOIL EROSION AND SEDIMENT CONTROL. SOIL EROSION AND SEDIMENT CONTROL SHULT DO TRICL. SOIL EROSION AND SEDIMENT CONTROL SHULT DO TRICL MUST BE INSPECTED BY THE ARCHITECT BEFORE WORK MAY COMMENCE. DESIGN CHITEMENT NO EQUIPMENT OR MATERIAL UNCLUDING WITHOUT LIMITATION, FILL, CONSTRUCTION MATERIALS OR DEBRIS, SHALL BE DEPOSITED, PLAC ON STORED NAME AND EROSION AND SEDIMENT CONTROL. | 0001 | E OF WORK |
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| SEDIMENT CONTROL PLANS a. CONNECTICUT DOT DRAINAGE MANUAL b. SCS GUIDELINE FOR SOIL EROSION AND SEDIMENT CONTROL OPERATION AND MAINTENANCE NO EQUIPMENT OR MATERIAL INCLUDING WITHOUT LIMITATION, FILL, CONSTRUCTION MATERIALS OR DEBRIS, SHALL BE DEPOSITED, PLACIOR STORED IN ANY WETLAND OR WATERCOURSE ON OR OFF SITE. I. IND EQUIPMENT OR MATERIAL INCLUDING WITHOUT LIMITATION, FILL, CONSTRUCTION MATERIALS OR DEBRIS, SHALL BE DEPOSITED, PLACIOR STORED IN ANY WETLAND OR WATERCOURSE ON OR OFF SITE. 2. TIMELY IMPLEMENTATION AND MAINTENANCE OF SEDIMENT AND EROSION CONTROL MEASURES ARE REQUIRED. ALL SEDIMENT AND EROSION CONTROL MEASURES MUST BE MAINTAINED UNTIL ALL DISTURBED AREAS ARE STABILIZED. 3. A PRE-CONSTRUCTION MEETING SHALL BE HELD PRIOR TO THE COMMENCEMENT OF ANY CONSTRUCTION ACTIVITIES ON THE SITE WITH T CONTRACTOR, AND CITY STAFF. 4. AS CONTAINED IN THE SEDIMENTATION AND EROSION CONTROL SPECIFICATIONS, OPERATIONS AND MAINTENANCE DURING CONSTRUCTION WILL CONSIST OF PERIODIC REPLACEMENT AND/OR CLEANING OF CLOGGED HAY BALES, SILT FENCE AND CONSTRUCTION ENTRANCE AT HE DEDITH OT THE SEDIMENT EXCEEDS 8". ALL DRAINAGE STRUCTURES SHALL BE INSPECTED ON A DAILY BASIS AND ANY NECESSARY CORRECTIVE ACTION TAKEN DESIGNATED ON-SITE AGENT THE PERSON RESPONSIBLE FOR OVERSEEING OF PROPER INSTALLATION AND MAINTENANCE OF ALL SOIL EROSION CONTROL MEASURES | DESIG | <u>IN CRITERIA</u> |
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| 1. THE PERSON RESPONSIBLE FOR OVERSEEING OF PROPER INSTALLATION AND MAINTENANCE OF ALL SOIL EROSION CONTROL MEASURES | 4. | AS CONTAINED IN THE SEDIMENTATION AND EROSION CONTROL SPECIFICATIONS, OPERATIONS AND MAINTENANCE DURING CONSTRUCTIO WILL CONSIST OF PERIODIC REPLACEMENT AND/OR CLEANING OF CLOGGED HAY BALES, SILT FENCE AND CONSTRUCTION ENTRANCE AT N ADDITIONAL COST TO THE OWNER. ANY TEMPORARY SEDIMENTATION BASINS WILL BE CLEANED OF ACCUMULATED SEDIMENT WHEN THE DEPTH OF THE SEDIMENT EXCEEDS 8". ALL DRAINAGE STRUCTURES SHALL BE INSPECTED ON A DAILY BASIS AND ANY NECESSARY |
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DRIP LINE -

(B3)

EXPANSION RESTRAINT -

2"x2"x3/4" RUBBER BLOCK -

ENCIRCLE LIMITS OF CRITICAL ROOT ZONE (MINIMUM 1-FT BEYOND DROP LINE) -OR-


RADIUS = 1-FT PER INCH OF TRUNK DIAMETER

1/4-INCH NYLON ROAP

(D3)

3

1-INCH REBAR FOR BAG REMOVAL FROM INLET

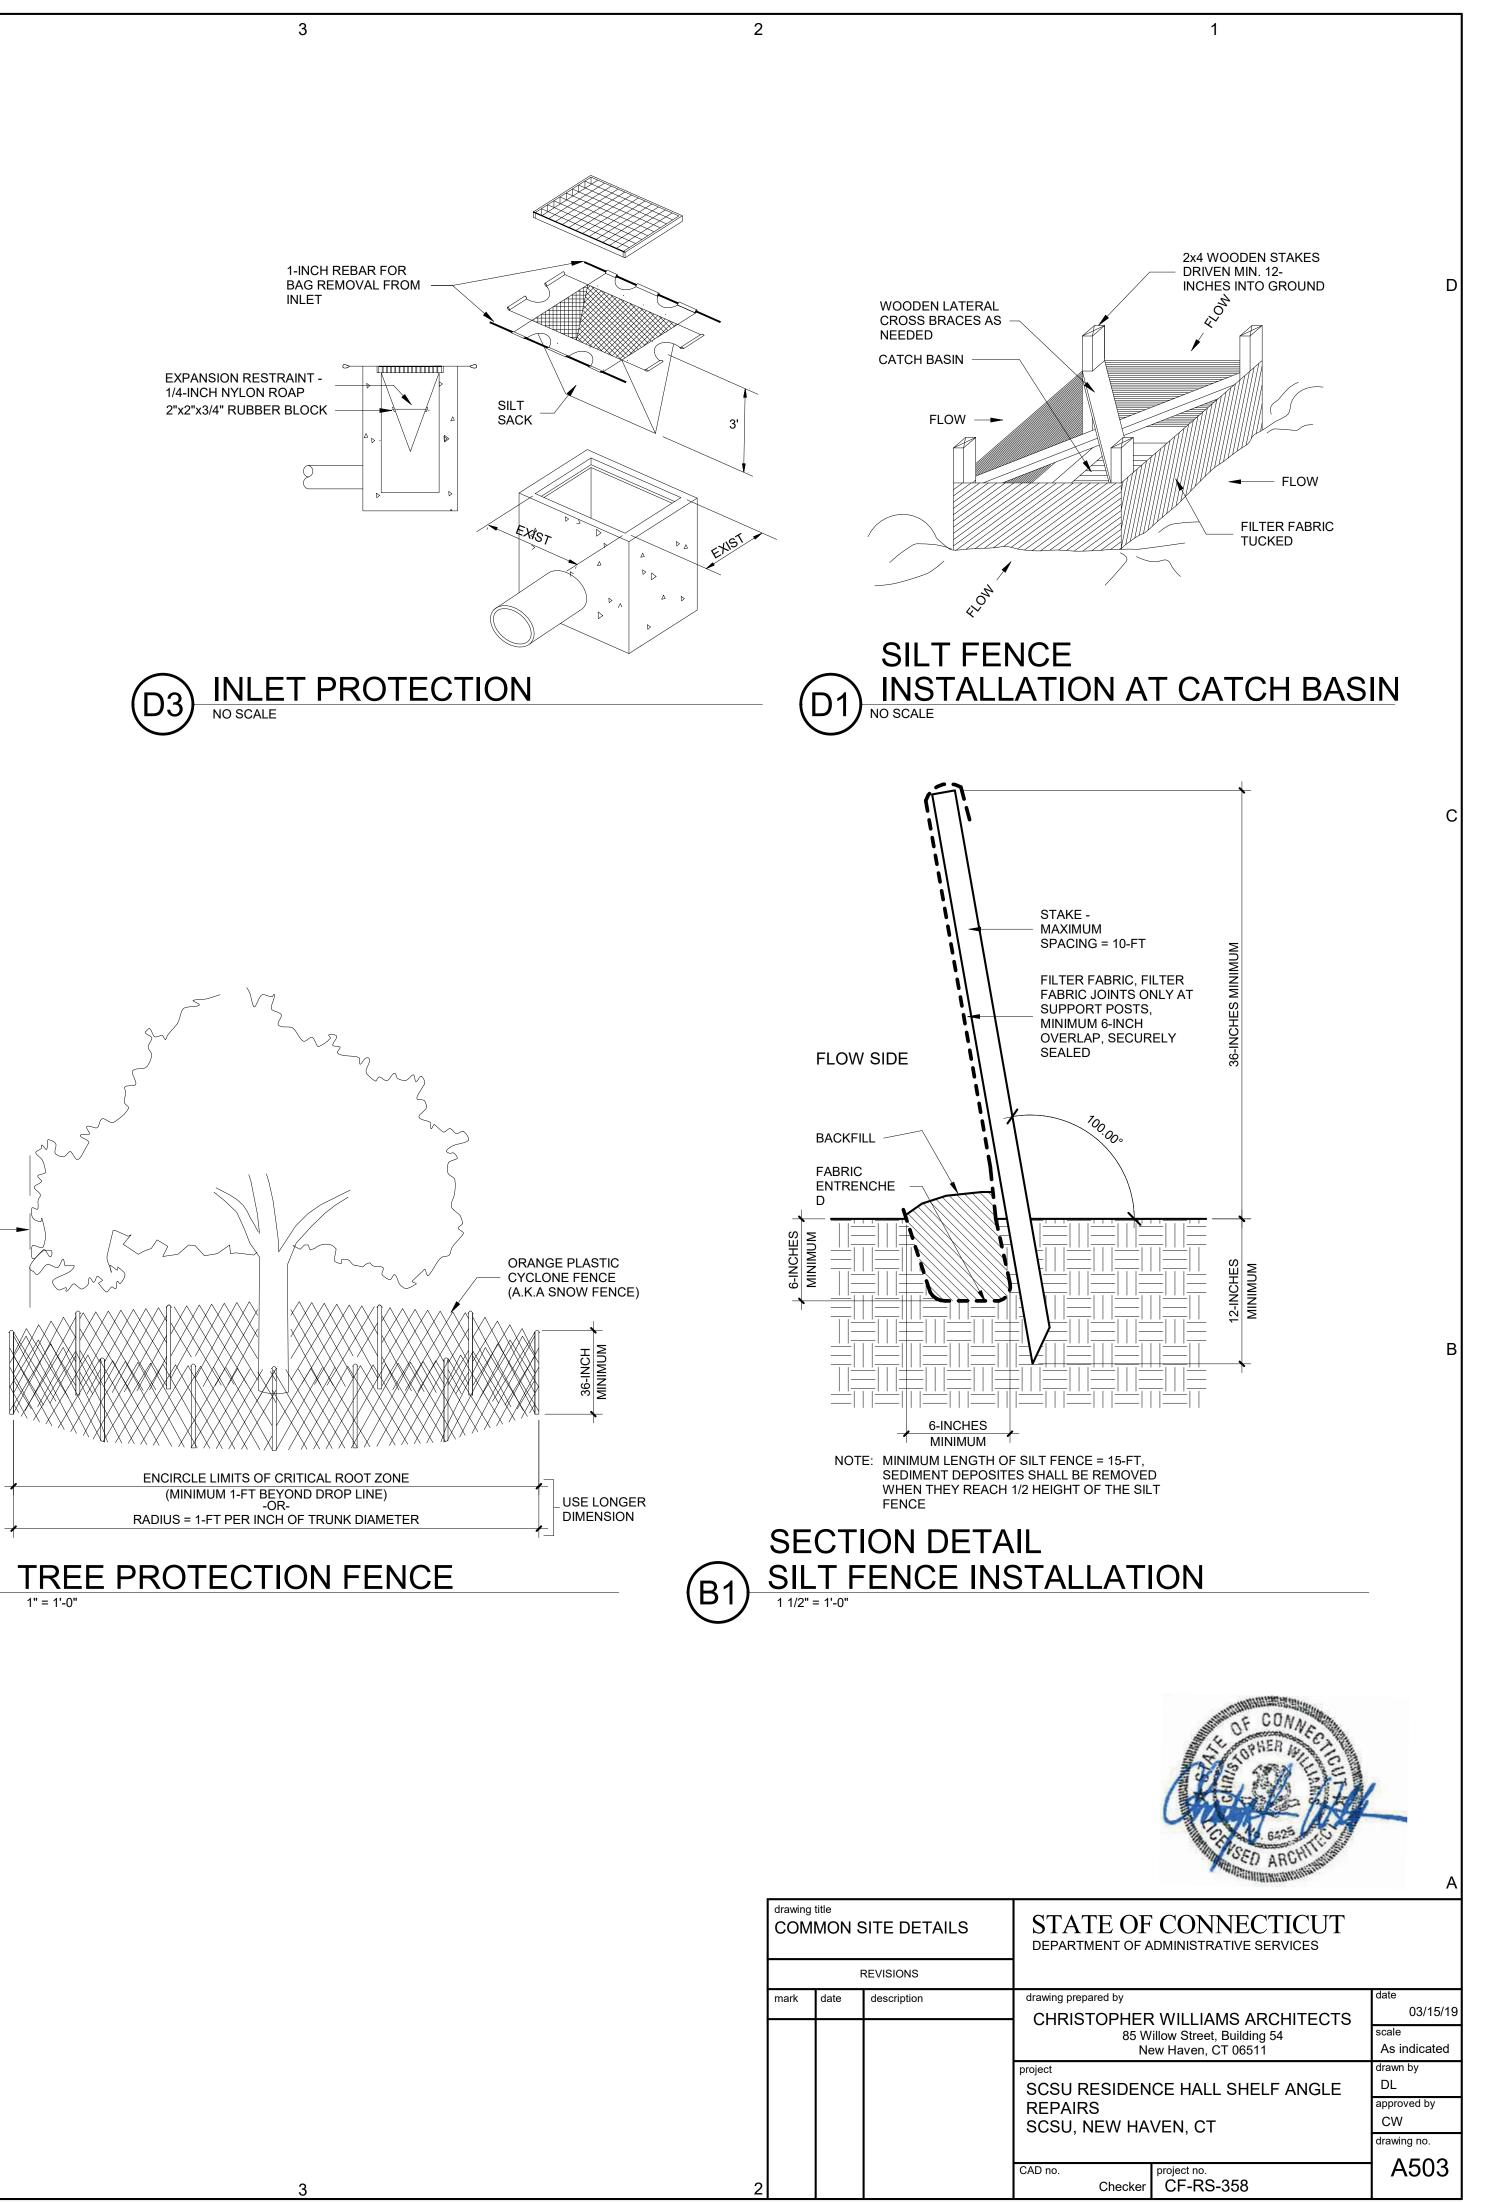

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