


STATE OF CONNECTICUT

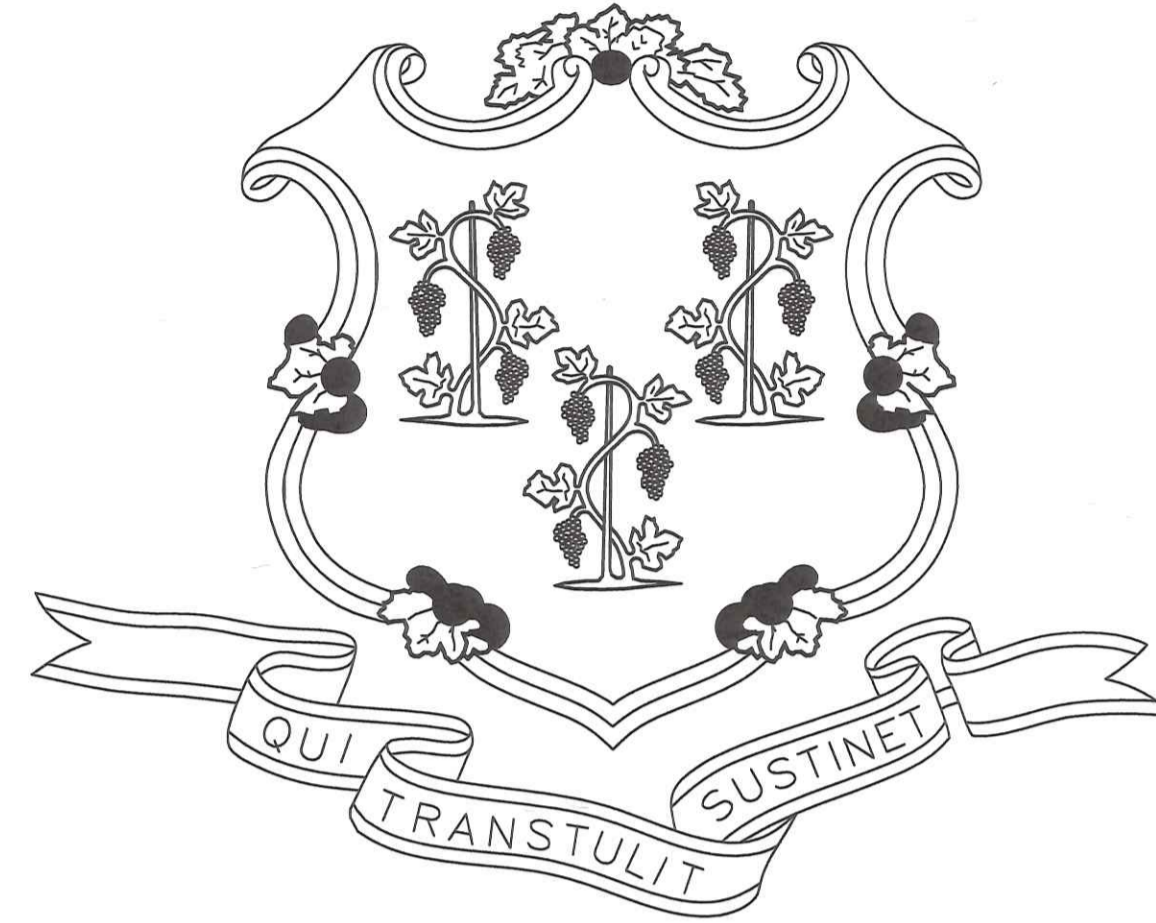

GOVERNOR NED LAMONT

DEPARTMENT OF ADMINISTRATIVE SERVICES
MELODY A. CURREY
COMMISSIONER

WESTERN CONNECTICUT STATE UNIVERSITY
DR. JOHN B. CLARK
PRESIDENT

WHITE HALL
2ND AND 3RD FLOOR RENOVATIONS
DANBURY, CONNECTICUT

PROJECT NO. BI-RD-299

AMES & WHITAKER ARCHITECTS
31 LIBERTY STREET, SUITE 208
SOUTHINGTON, CT, 06489
860-621-8944



CONSULTING ENGINEERING SERVICES, INC.
811 MIDDLE STREET
MIDDLETOWN, CT, 06457
860-632-1682



CONSTRUCTION DOCUMENTS
07/25/18
REV. 01/21/19

D.C.S BUILDING NUMBER 07405



SITE PLAN
APPROVALS

DEPT. OF ADMINISTRATIVE SERVICES


Melody A. Currey

DATE
1/30/19

AGENCY

John B. Clark

DATE
1/27/19


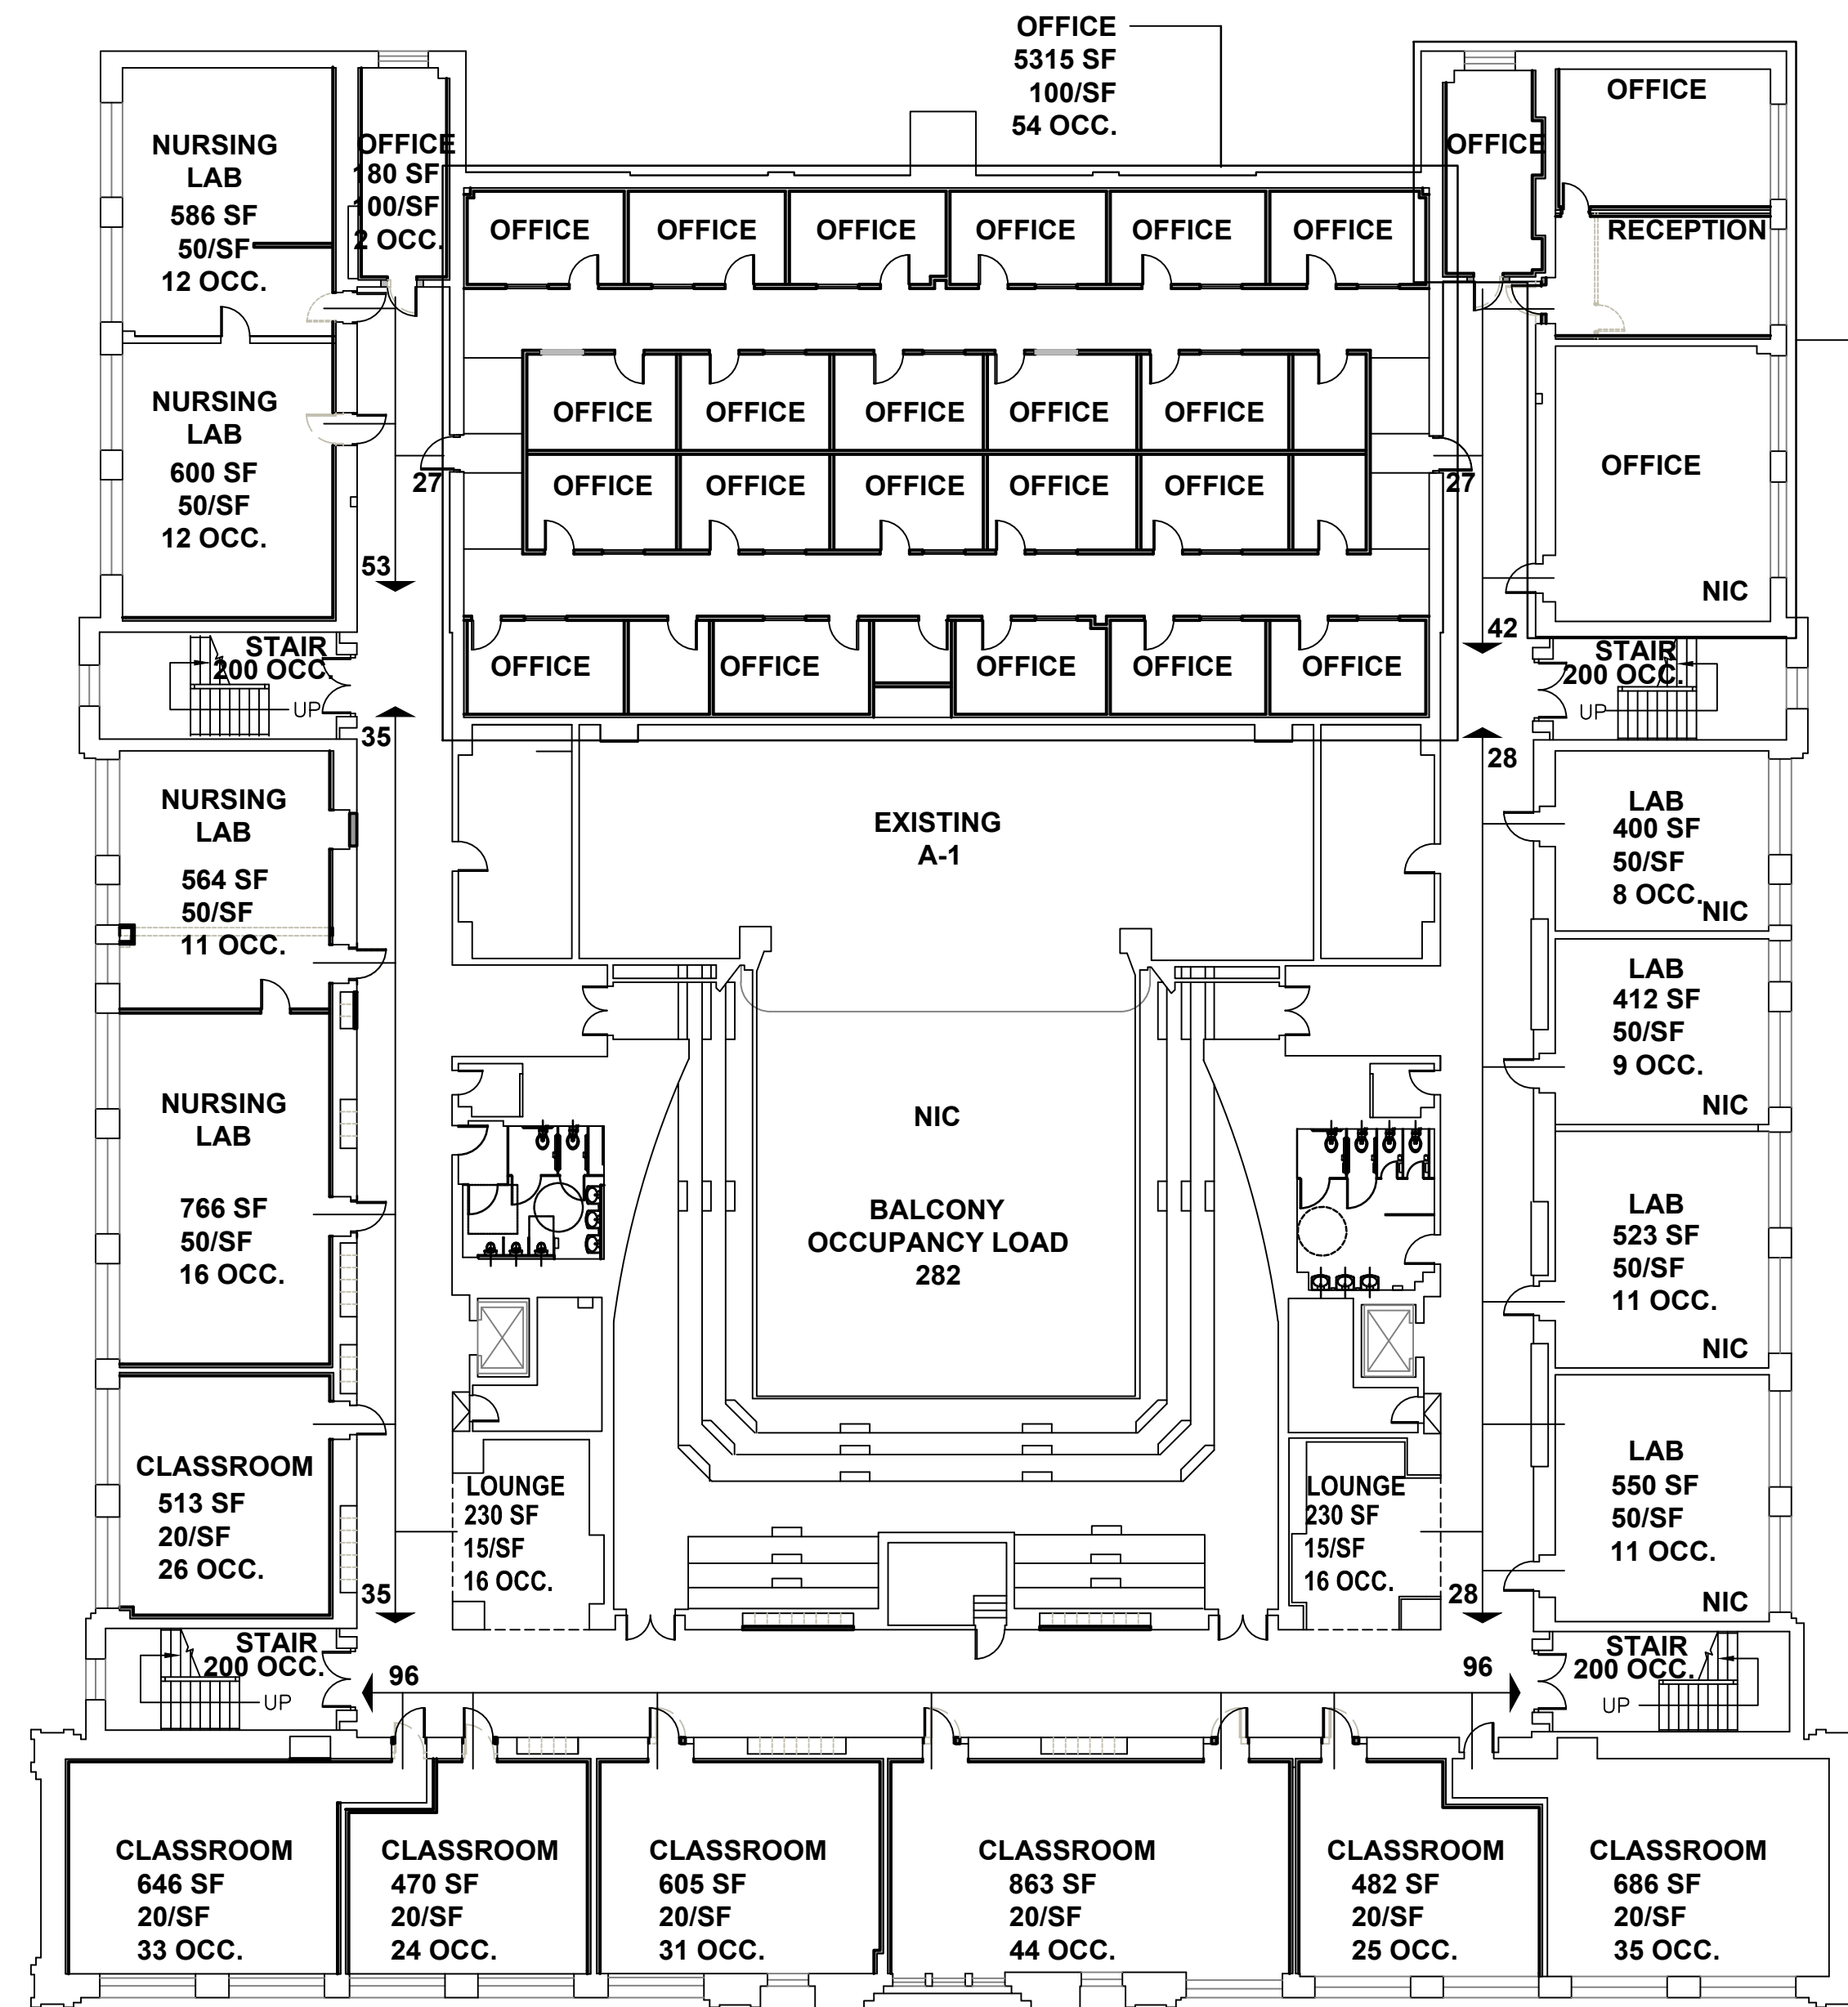


SECOND FLOOR - BUSINESS OCCUPANCY EGRESS

TOTAL 411 OCC B


NON-SIMULTANEOUS USE OF BUSINESS AND ASSEMBLY

EXIT STAIRS 4x200=800 (CONTROLS)
EXIT DOOR 4x340=1,360

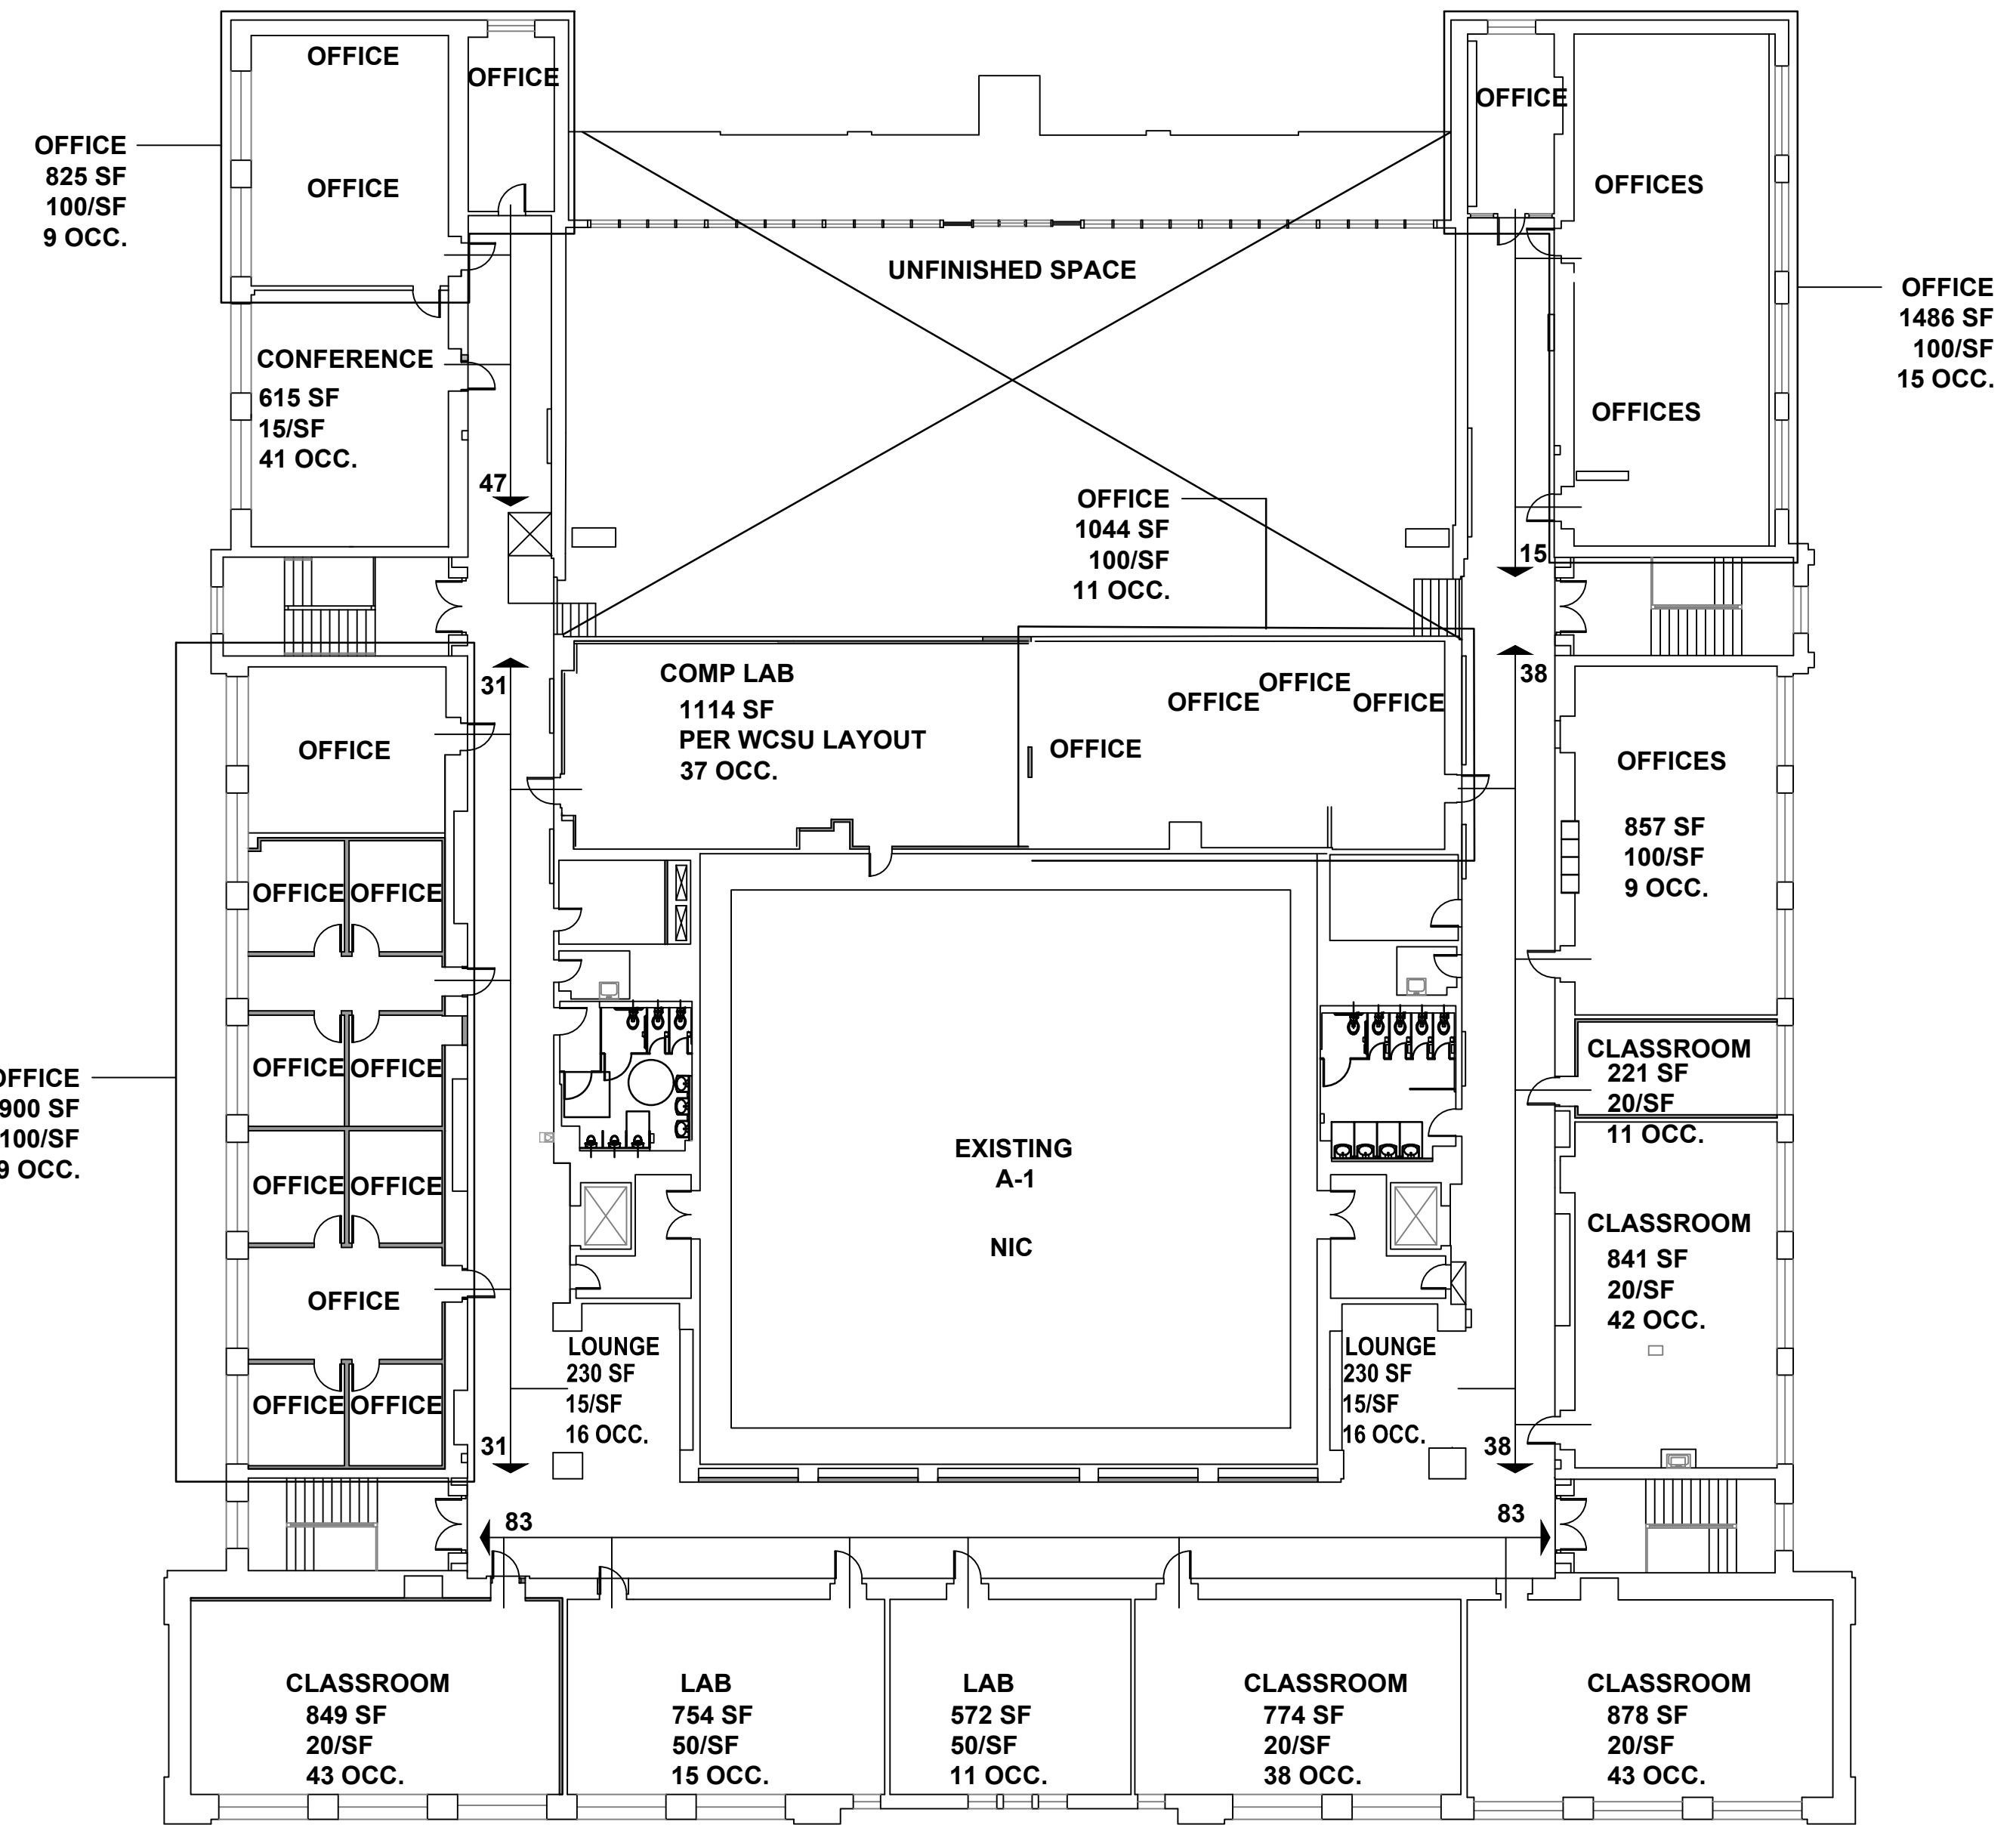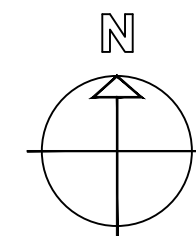


THIRD FLOOR - BUSINESS OCCUPANCY EGRESS

TOTAL 376 OCC B

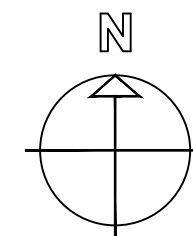

| drawing title | | | STATE OF CONNECTICUT | |
|------------------|---------|-------------------------------|--|--------------------------|
| CODE INFORMATION | | | DEPARTMENT OF ADMINISTRATIVE SERVICES | |
| REVISIONS | | | | |
| mark | date | description | drawing prepared by | date |
| | 8/4/17 | SCHEMATIC DESIGN SUBMISSION | AMES & WHITAKER ARCHITECTS 31 LIBERTY STREET SOUTHINGTON, CT | 07/25/18 |
| | 1/15/18 | DESIGN DEVELOPMENT SUBMISSION | | scale AS NOTED |
| | 4/16/18 | CONSTRUCTION DOCUMENTS | project | drawn by CA/SP |
| | 5/23/18 | | WESTERN CT STATE UNIVERSITY | approved by AL |
| | 7/25/18 | | WHITE HALL | drawing no. |
| | 1/21/19 | | 2ND AND 3RD FLOOR RENOVATIONS | |
| | | | DANBURY, CONNECTICUT | |
| | | | CAD no. | project no. BI-RD-299 |
| | | | | G1.01 |

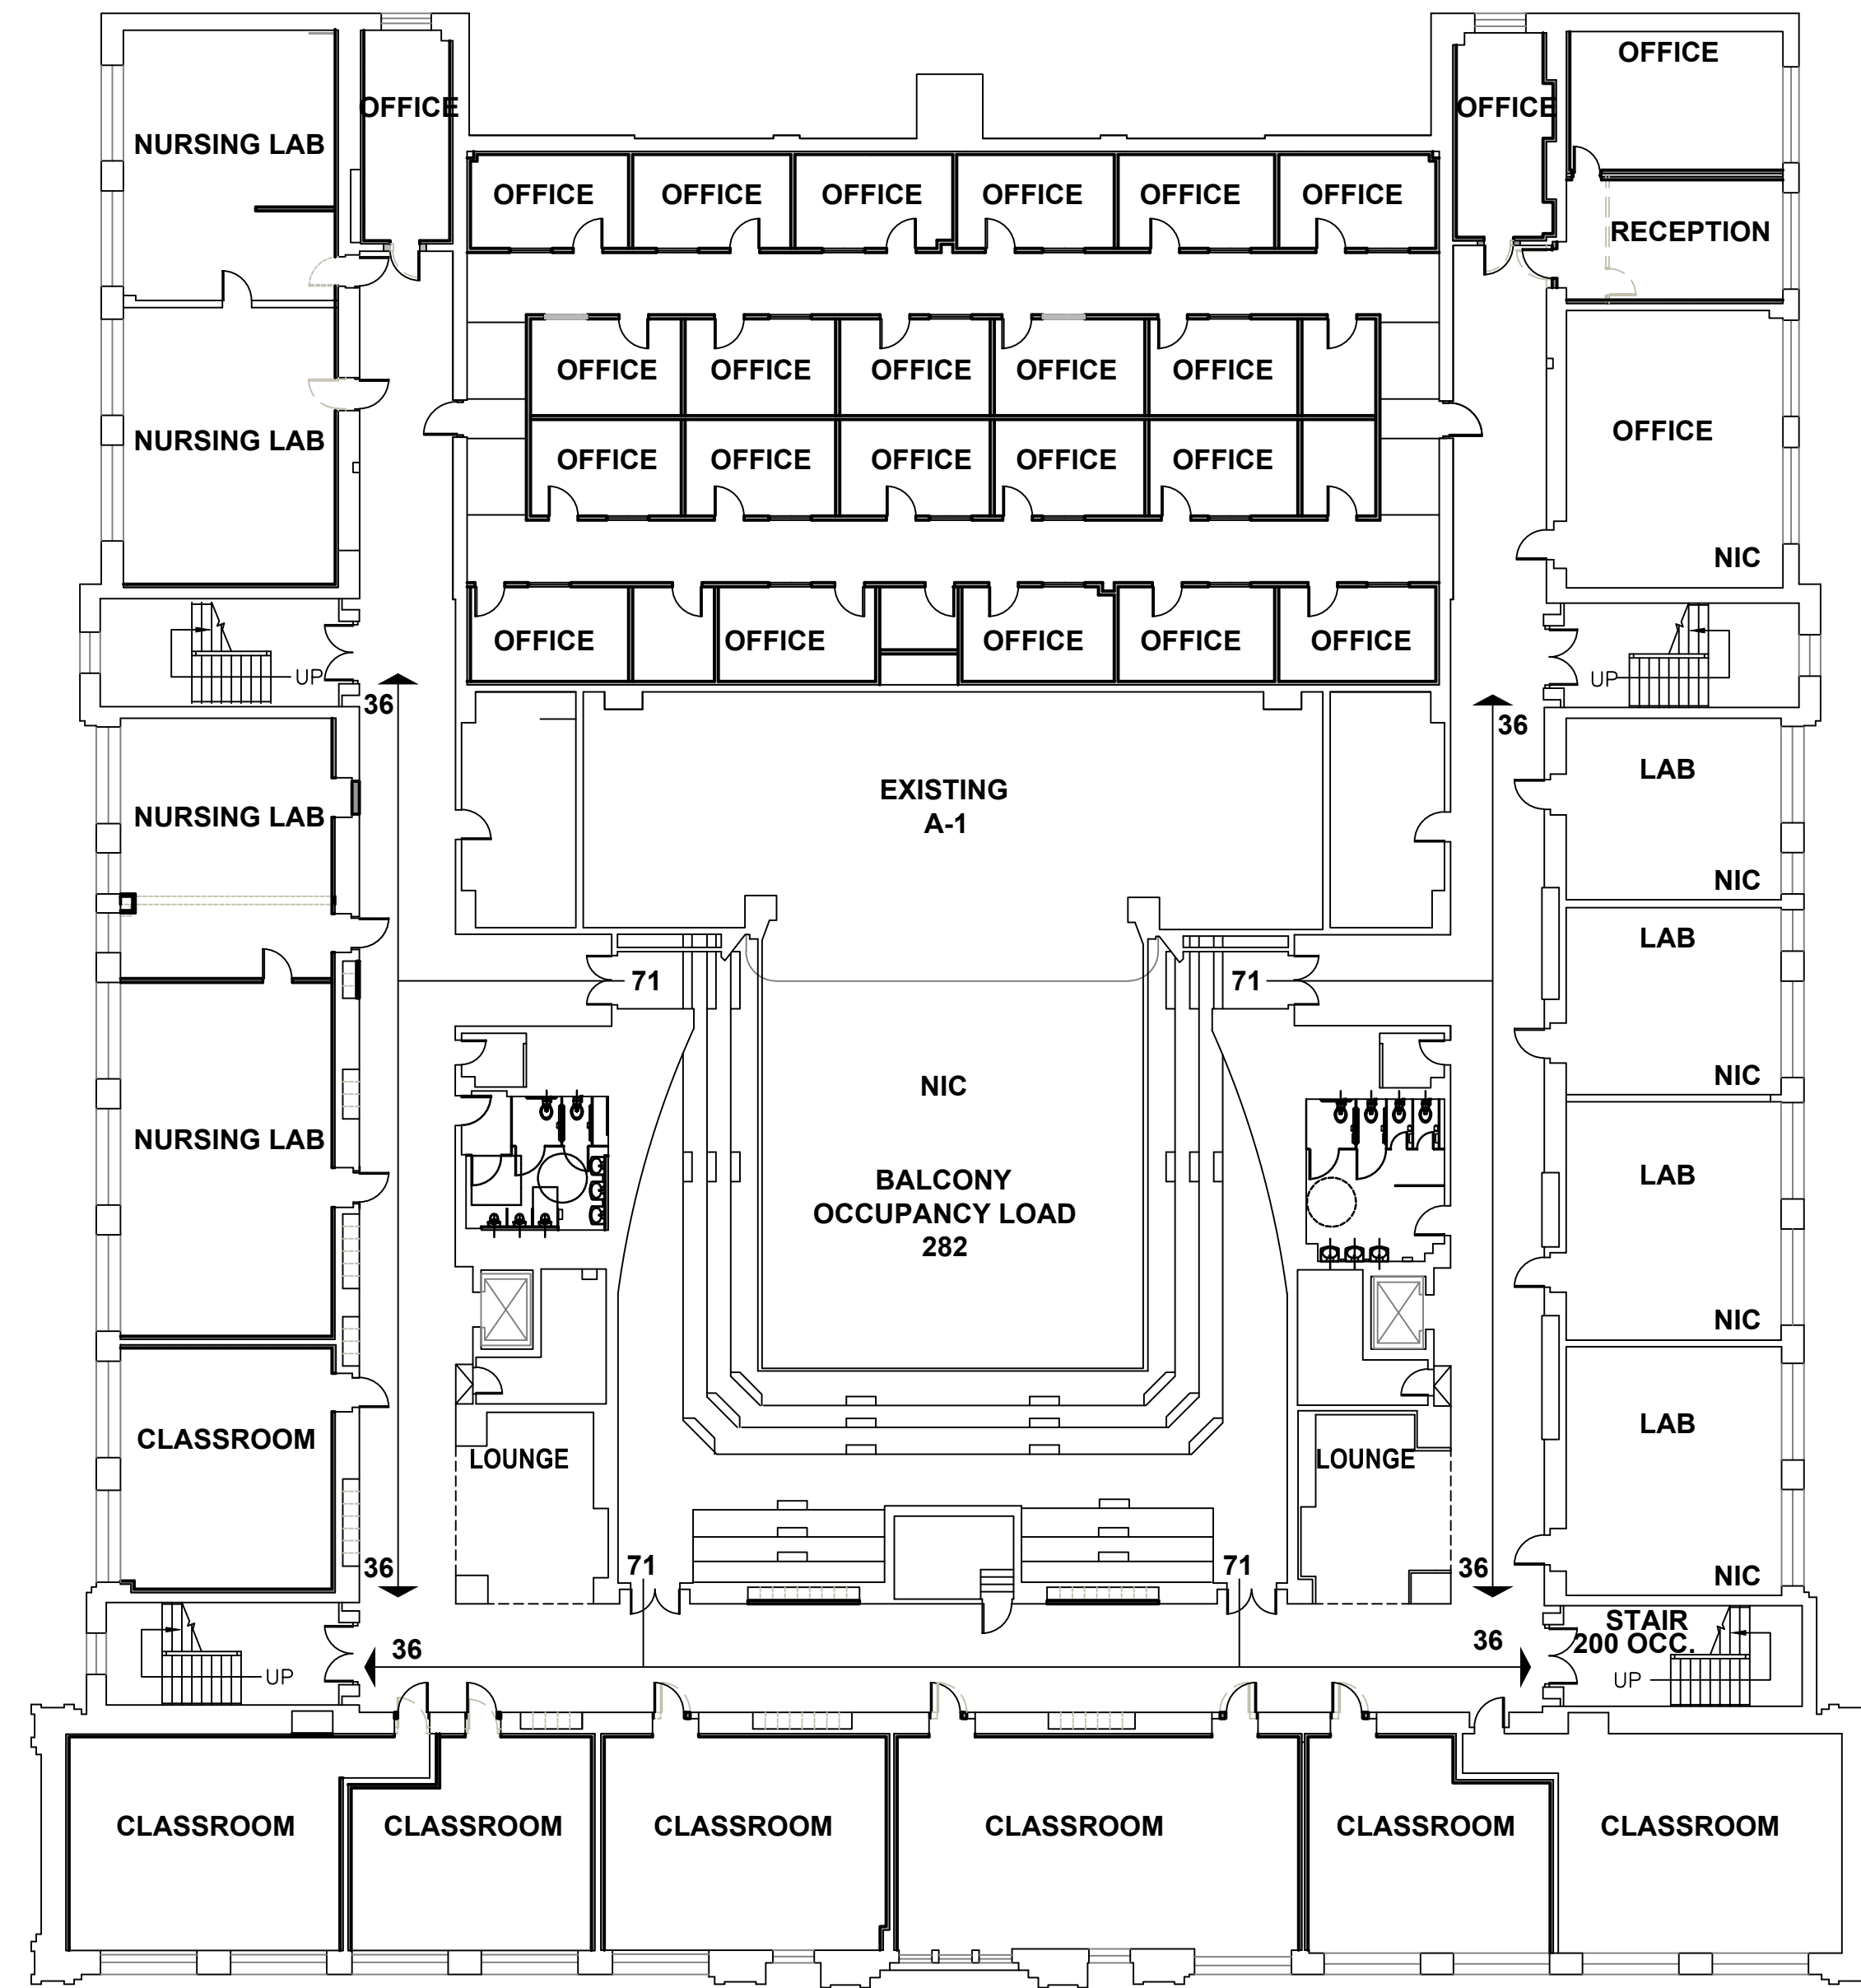


SECOND FLOOR - ASSEMBLY OCCUPANCY EGRESS

TOTAL 282 OCC A-1

NON-SIMULTANEOUS USE OF BUSINESS AND ASSEMBLY

EXIT STAIRS 4x200=800 (CONTROLS)
 EXIT DOOR 4x340=1,360

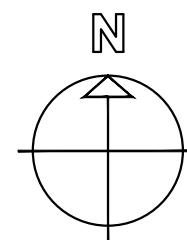

| | | | | | |
|---|---------|-------------------------------|--|-------------------|-----------------------------|
| drawing title CODE INFORMATION | | | STATE OF CONNECTICUT DEPARTMENT OF ADMINISTRATIVE SERVICES | | |
| REVISIONS | | | drawing prepared by AMES & WHITAKER ARCHITECTS 31 LIBERTY STREET SOUTHINGTON, CT | | |
| mark | date | description | date | scale | AS NOTED |
| | 8/4/17 | SCHEMATIC DESIGN SUBMISSION | 07/25/18 | | |
| | 1/15/18 | DESIGN DEVELOPMENT SUBMISSION | | | |
| | 4/16/18 | CONSTRUCTION DOCUMENTS | | | |
| | 5/23/18 | | | | |
| | 7/25/18 | | | | |
| | 1/21/19 | | | | |
| project WESTERN CT STATE UNIVERSITY WHITE HALL 2ND AND 3RD FLOOR RENOVATIONS DANBURY, CONNECTICUT | | | drawn by CA/SP | approved by AL | drawing no. G1.02 |
| CAD no. | | | project no. BI-RD-299 | | |



3011 Building Information For Code Analyses

Page 1 of 5

State of Connecticut Department of Administrative Services Division of Construction Services Office of Design and Construction - Code Unit 165 Capitol Avenue, Room 483 Hartford, CT 06106

Project Number: BI-RD-299 Project Name: Renovations to Second and Third Floors, White Hall, Western Connecticut State University Project Location: 181 White Street, Danbury, CT Date: 4/16/2018 Licensed Code Inspector: (Name) (Signature)

The information on this form is intended to expedite the plan review process and is for archival purposes. It assembles all code related information into one table. The information shall be placed on the drawings and become a permanent record of the code information applicable to this building.

PART 1 - CT STATE BUILDING CODE

- 1.0 EXISTING BUILDING: 1.1 Continuation of Existing Use, 1.2 Change of Use, 1.3 Complying with International Existing Building Code, 2.0 NEW BUILDINGS OR ADDITIONS: 2.1 Exceeds Threshold Building Limits, 3.0 OCCUPANCY CLASSIFICATION: 3.1 Mixed Occupancies, 4.0 HEIGHT AND AREA COMPUTATION + CONSTRUCTION TYPE: Existing Bldg. Assumed Construction Type III B

GENERAL BUILDING LIMITATIONS (Chapters 5 & 6)

Use Case 1 to determine the allowable height and area and permitted construction types for the building containing a single occupancy or non-separated mixed occupancies. Use Case 2 to determine the allowable height and area and permitted types of construction for the building containing separated mixed occupancies.

AREA MODIFICATIONS TO TABLE 503

Table with columns for % of allowable tabular area, % increase for frontage, % increase for automatic sprinklers, Total percentage factor, Conversion factor, and calculations for I_f.



3011 Building Information For Code Analyses

Page 2 of 5

Date: Project Number:

CASE 1 - SINGLE OCCUPANCY OR NON-SEPARATED USES (302.3.1)

Using Table 503, identify the allowable height and area of the single occupancy or the most restrictive of the non-separated mixed occupancies. Construction types providing an allowable tabular area equal to or greater than the adjusted building area and allowable heights (as modified by Section 504) equal to or greater than the actual building height are permitted.

Table with columns for DETERMINE CONSTRUCTION TYPE and ALLOWABLE AREA (506.4), including rows for actual building area, adjusted building area, actual building height, allowable building height, permitted construction types, and type of construction assumed.

CASE 2 - MIXED OCCUPANCY SEPARATED USES (302.3.2)

Using Table 503, identify the allowable height and area of each of the separated uses within the building. Construction types providing for each story of the building, tabular areas (as modified by Section 506), which result in a sum of the ratios of 1.00 or less and allowable heights (as modified by Section 504) equal to or greater than the actual height of the use are permitted.

Table with columns for Story, Group, Actual floor area, Adjusted floor area, Actual height, and Allowable height, including a summation formula for adjusted floor area.



3011 Building Information For Code Analyses

Page 3 of 5

Date: Project Number:

ALLOWABLE AREA (506.4)

Table for ALLOWABLE AREA (506.4) showing calculations for allowable area per floor (A_f) and total floor area, including permitted types of construction (IIB, IIB).

MEZZANINES (505)

Table for MEZZANINES (505) with rows for Area limitation (505.2), Egress (505.3), Openness (505.4), and Equipment platforms (505.5).

UNLIMITED AREA BUILDINGS (507)

Table for UNLIMITED AREA BUILDINGS (507) listing various building types and their corresponding occupancy classifications.

SPECIAL PROVISIONS (508)

Table for SPECIAL PROVISIONS (508) with a row for Special condition applicable (508.1).



3011 Building Information For Code Analyses

Page 4 of 5

Date: Project Number:

CONSTRUCTION INFORMATION

- 6.0 MEANS OF EGRESS: 6.1 Total Occupant Load, 6.2 Total Occupant Load, 6.3 Total Capacity Of Exits, 6.4 Total Number of Exits, 7.0 FIRE RESISTANT RATING OF STRUCTURE ELEMENTS, 7.1 Exterior Walls, 7.2 Fire Walls & Party Walls, 7.3 Fire Separation Assemblies, 7.4 Fire Partitions, 7.5 Dwelling Unit Separations, 7.6 Smoke Barriers, 7.7 Other Non bearing Partitions, 7.8 Interior Bearing Walls, Bearing Partitions, Columns, Girders, Trusses and Framing, 7.9 Floor Construction Including Beams, 7.10 Roof Construction, 8.0 FIRE PROTECTION SYSTEM: 8.1 Fire Suppression System, 8.2 Alarms, 8.3 Automatic Fire Detection System, 8.4 Smoke Control System, 8.5 Supervision



3011 Building Information For Code Analyses

Page 5 of 5


Date: Project Number:

PART 2 - CONNECTICUT STATE FIRE SAFETY CODE



Table for PART 2 - CONNECTICUT STATE FIRE SAFETY CODE with rows for Classification of Occupancy, Construction Classification, Minimum Construction Type Required, Actual Construction Type Provided, Notification/Alarms, Detection, and Extinguishment Requirements.

END BUILDING INFORMATION FOR CODE ANALYSES

Table containing drawing title, code information, revisions, drawing prepared by (AMES & WHITAKER ARCHITECTS), drawing date (8/4/17), and project name (WESTERN CT STATE UNIVERSITY WHITE HALL 2ND AND 3RD FLOOR RENOVATIONS).

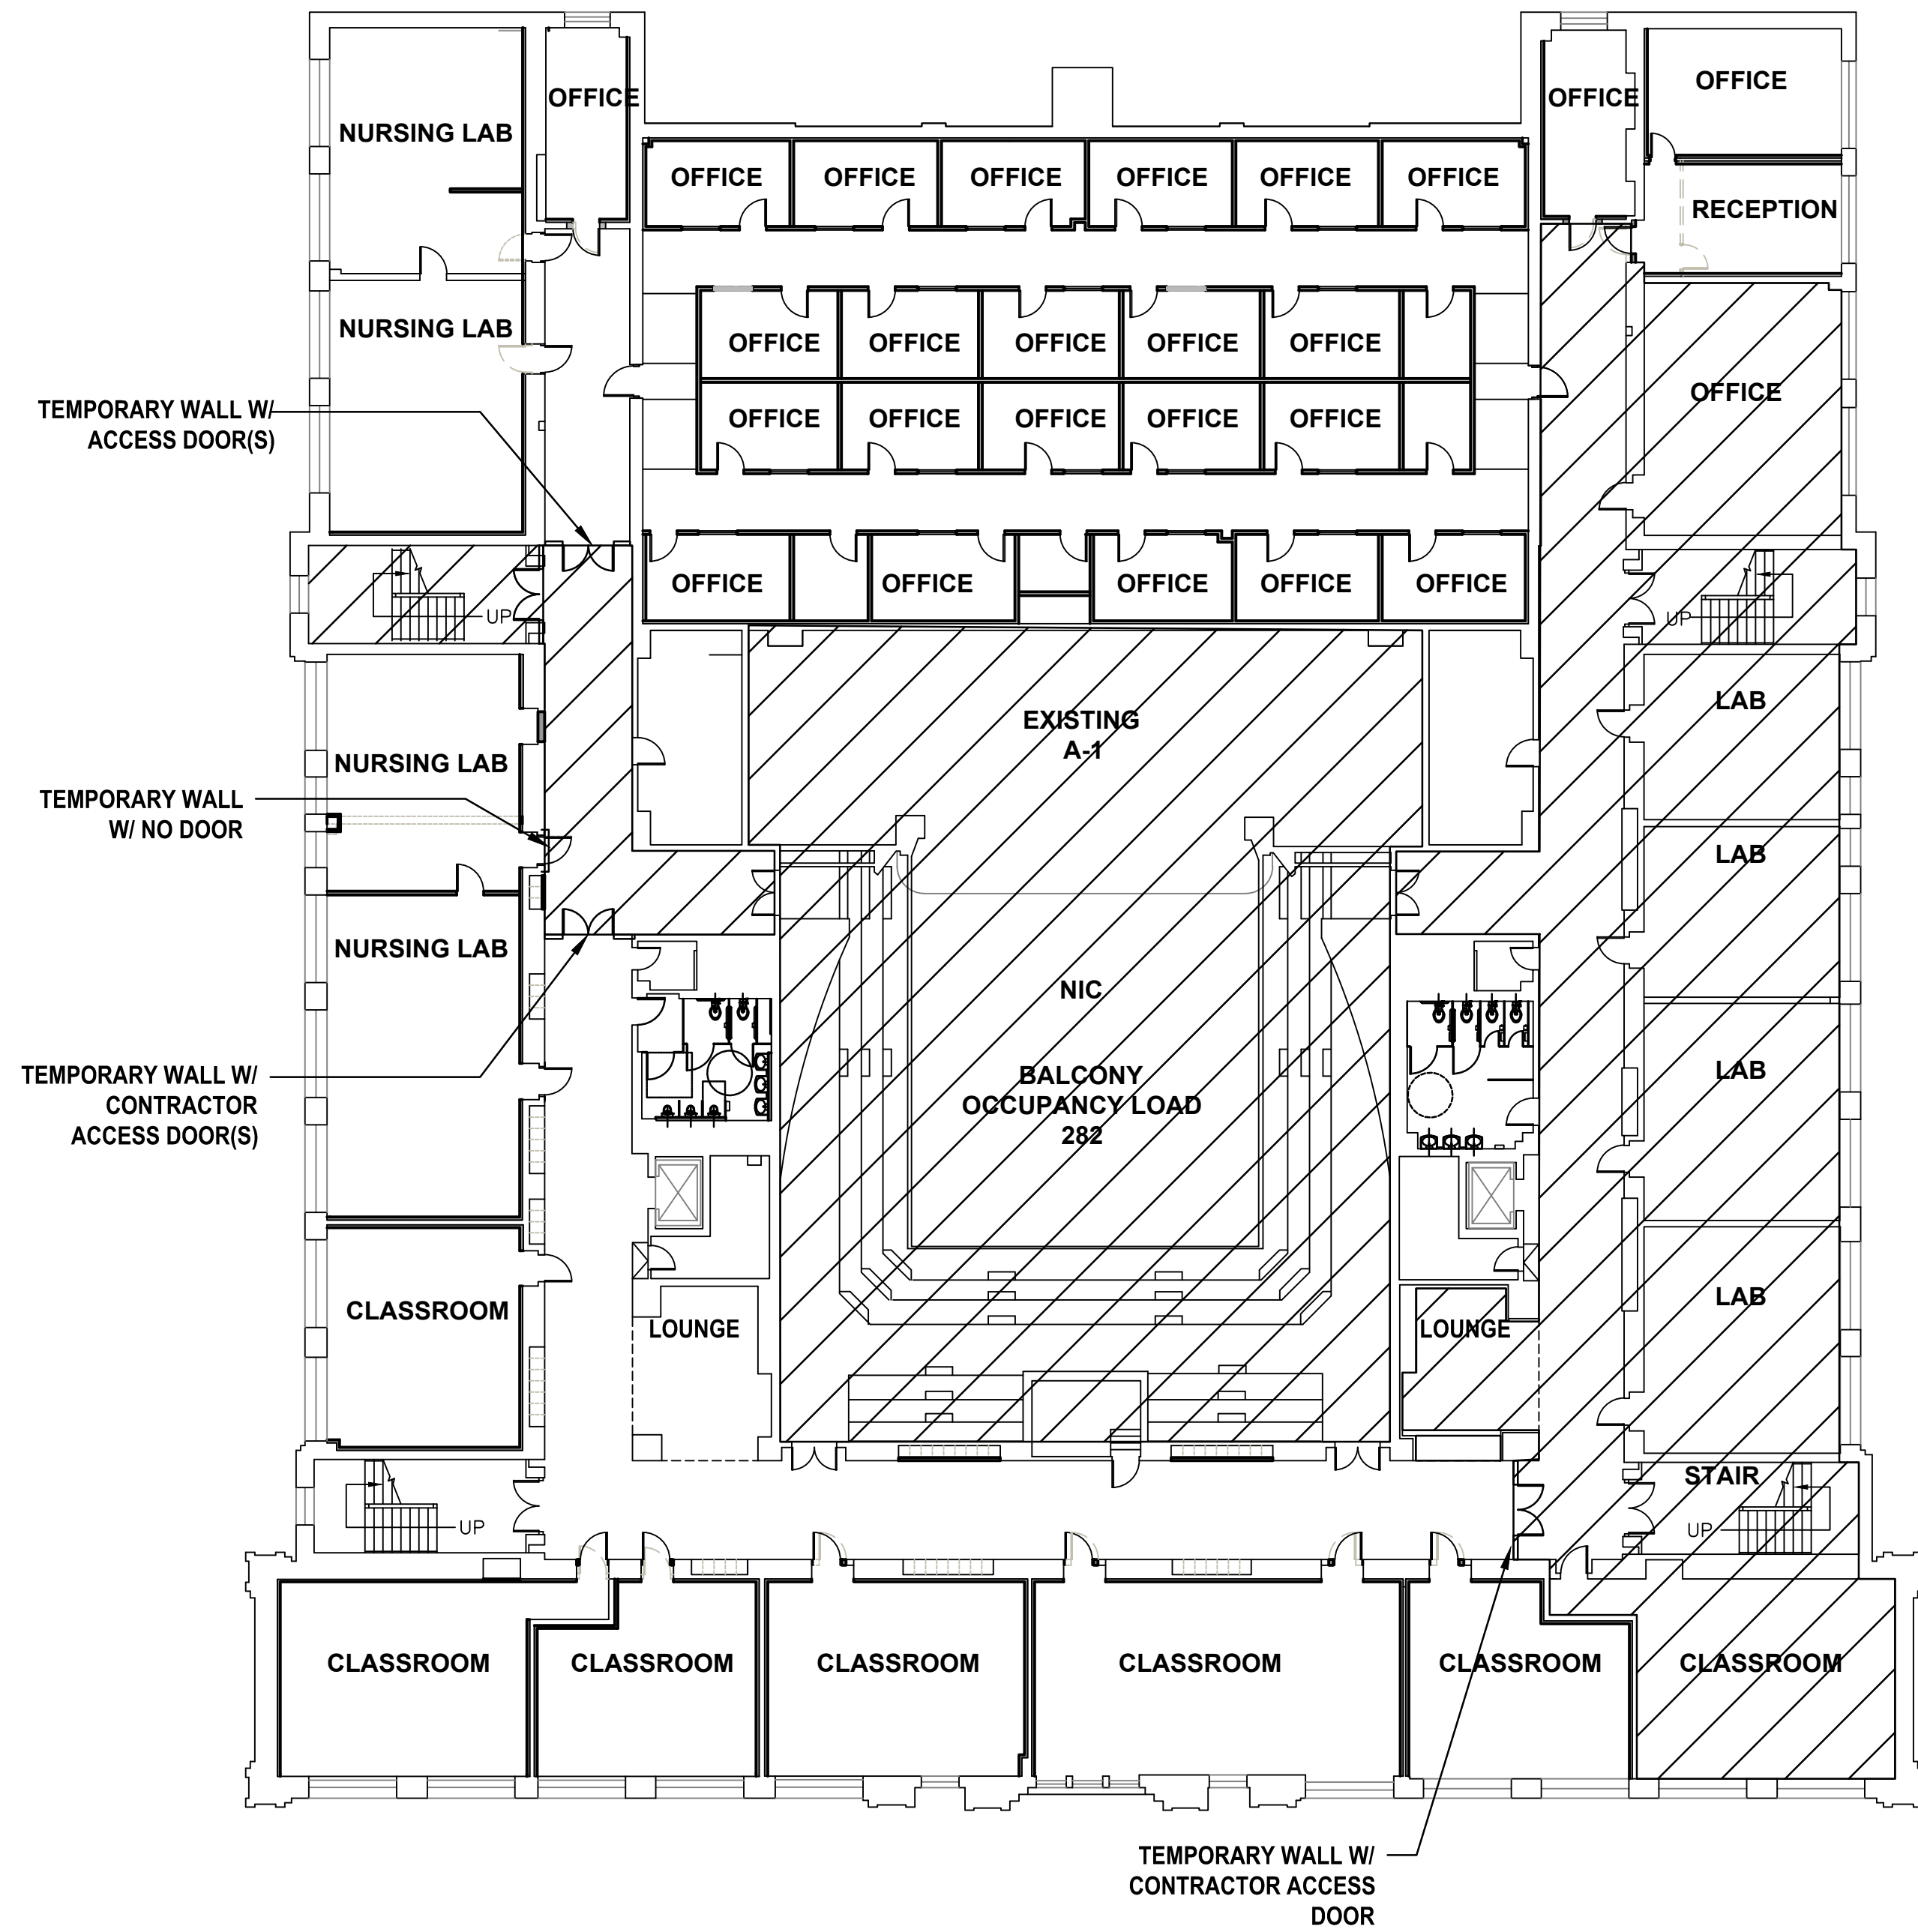

PROPOSED CONSTRUCTION EGRESS PLAN - SECOND FLOOR

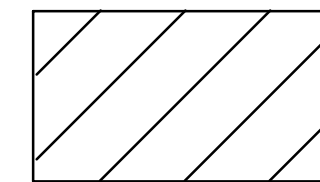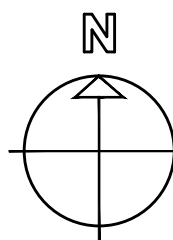


AREA OCCUPIED BY OWNER DURING CONSTRUCTION


GENERAL NOTES:

1. ALL TEMPORARY PARTITIONS SHALL BE 1 HOUR RATED PARTITIONS UL U404.
2. CONTRACTOR TO PROVIDE TWO MEANS OF EGRESS AT ALL TIMES.
3. PROVIDE (2) 3'-0" X 6'-8" TEMPORARY ACCESS DOORS AT EACH LOCATION. PROVIDE 1 HOUR RATED DOORS.
4. PROVIDE TEMPORARY ACCESS DOOR HARDWARE:


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|-----------------------------|---------------------------------|
| PANIC BAR WITH LEVER HANDLE | - TYPE 28, FUNCTION 09, GRADE 1 |
| LOCKSET | - F82 GRADE 1, SERIES 4000 |
| HINGES | - 1-1/2 PAIRS OF A5111 |

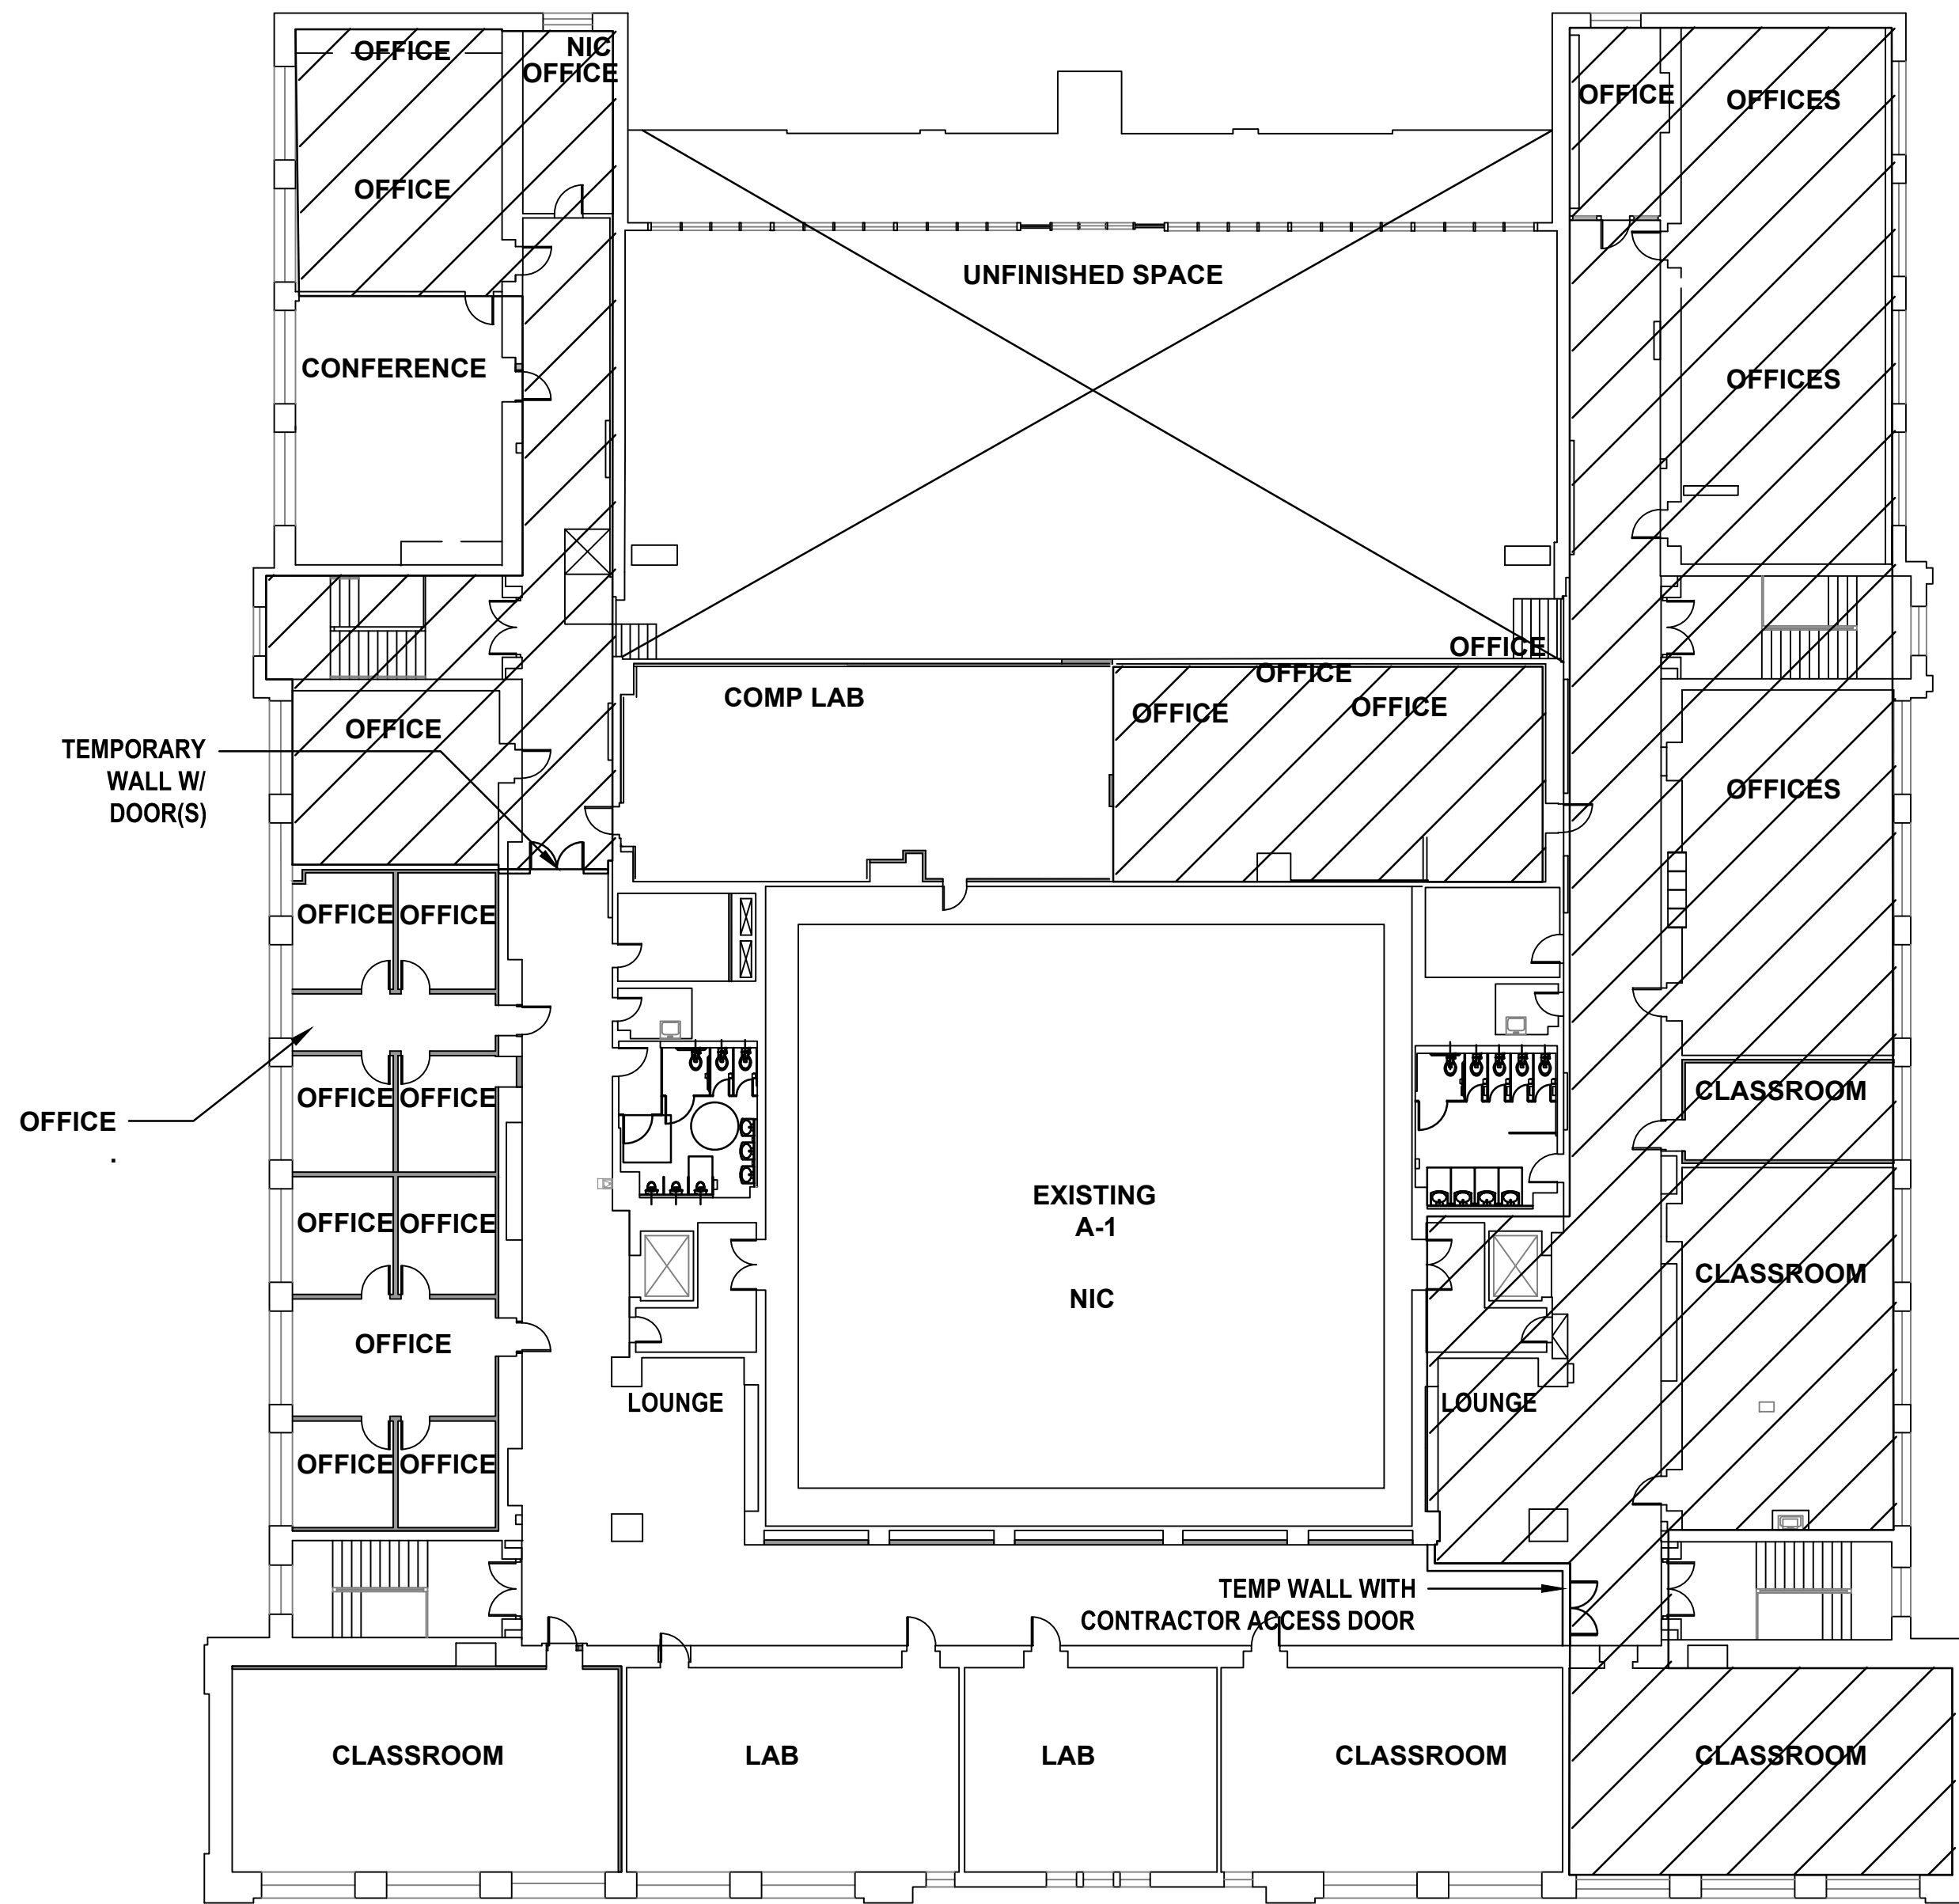



PROPOSED CONSTRUCTION EGRESS PLAN - THIRD FLOOR

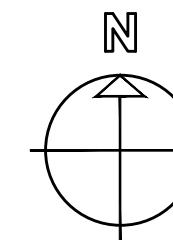

| | | | | | |
|---|---------|-------------------------------|---|-------------------|-------------------|
| drawing title CONSTRUCTION PARTITIONS | | | STATE OF CONNECTICUT DEPARTMENT OF ADMINISTRATIVE SERVICES | | |
| REVISIONS | | | | | |
| mark | date | description | drawing prepared by | date | scale |
| | 8/4/17 | SCHEMATIC DESIGN SUBMISSION | AMES & WHITAKER ARCHITECTS 31 LIBERTY STREET SOUTHINGTON, CT | 07/25/18 | AS NOTED |
| | 1/15/18 | DESIGN DEVELOPMENT SUBMISSION | | project | |
| | 4/16/18 | CONSTRUCTION DOCUMENTS | WESTERN CT STATE UNIVERSITY WHITE HALL 2ND AND 3RD FLOOR RENOVATIONS DANBURY, CONNECTICUT | drawn by CA/SP | approved by AL |
| | 5/23/18 | | | | |
| | 7/25/18 | | | | |
| | 1/21/19 | | | | |
| CAD no. | | | project no. | G1.04 | |
| | | | BI-RD-299 | | |

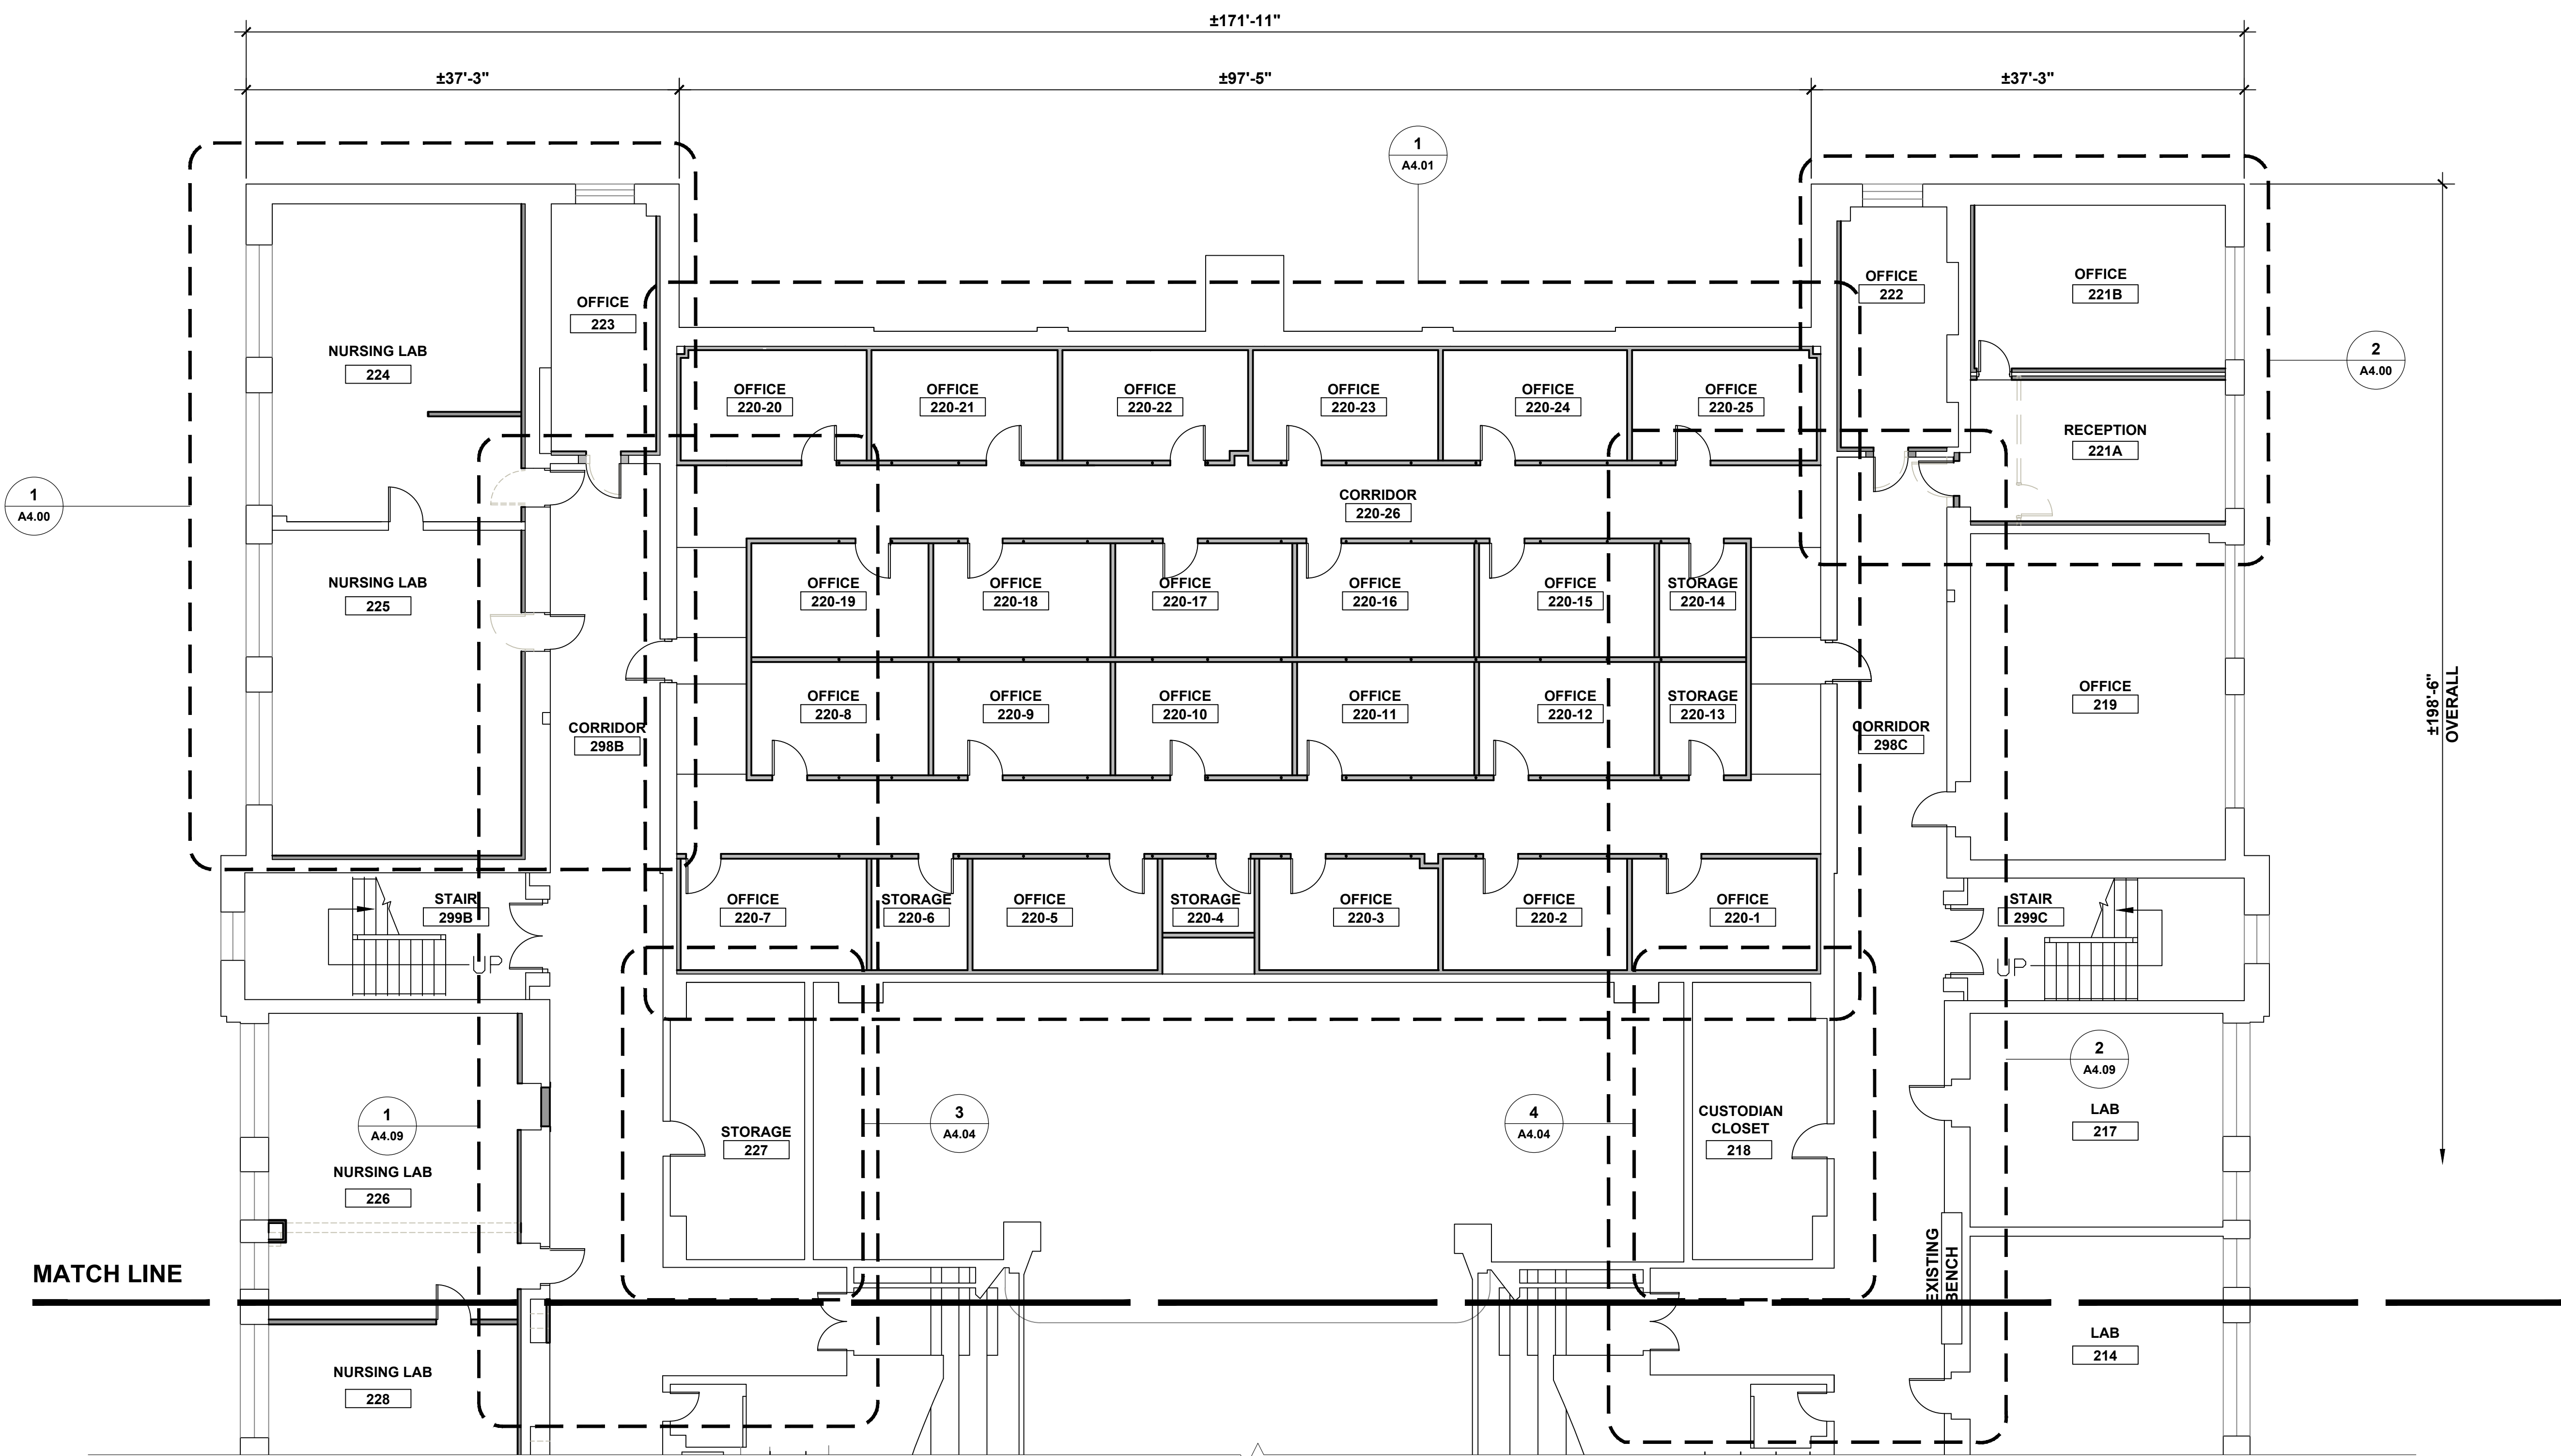


1 NORTH WING PARTIAL PLAN

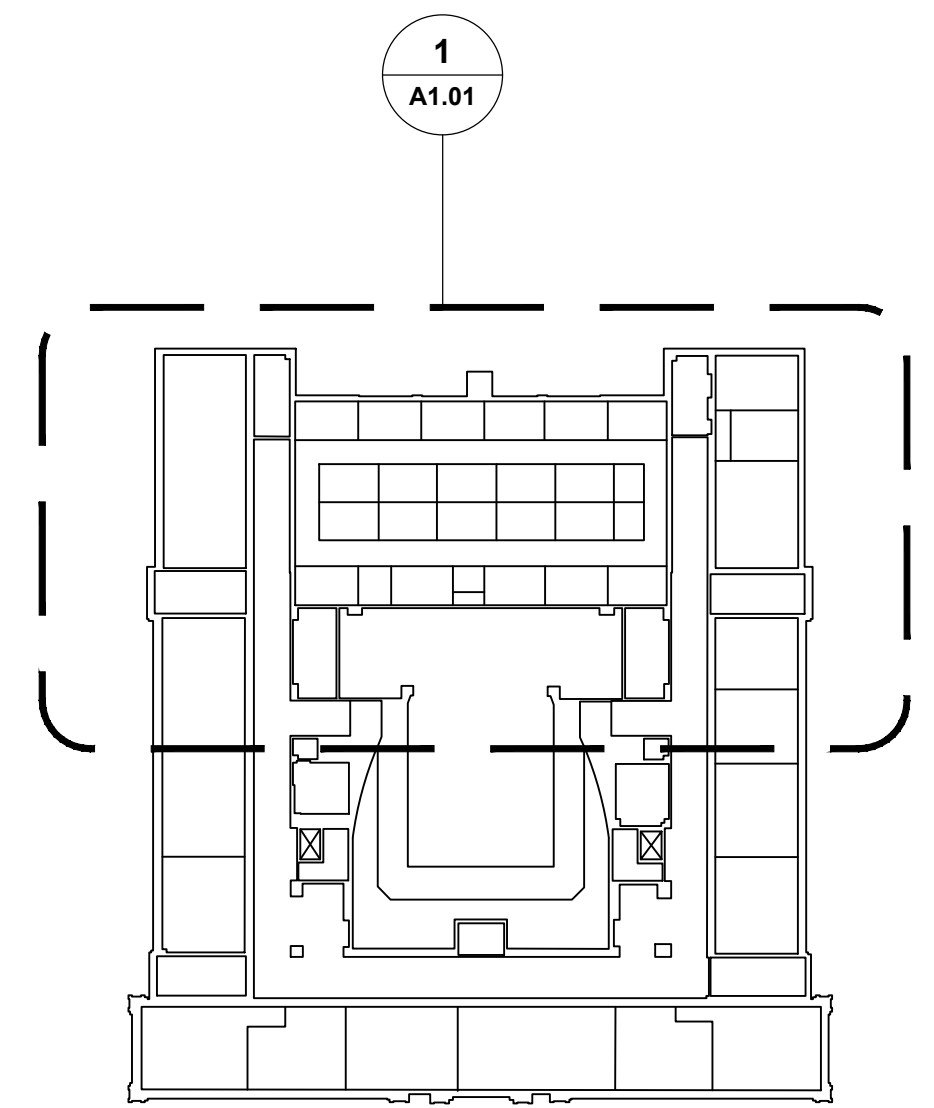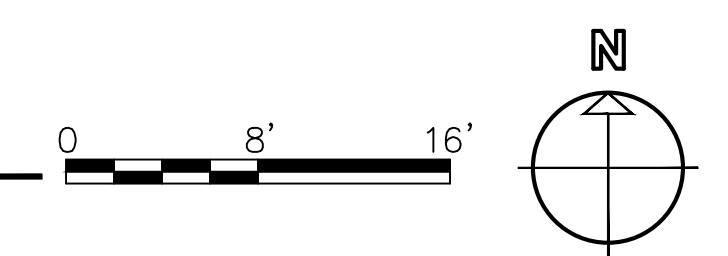


KEY PLAN

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|---|---------|-------------------------------|--|-------------------|-----------------------------|
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| REVISIONS | | | drawing prepared by AMES & WHITAKER ARCHITECTS 31 LIBERTY STREET SOUTHINGTON, CT | | |
| mark | date | description | date | scale | AS NOTED |
| | 8/4/17 | SCHEMATIC DESIGN SUBMISSION | 07/25/18 | | |
| | 1/15/18 | DESIGN DEVELOPMENT SUBMISSION | | | |
| | 4/16/18 | CONSTRUCTION DOCUMENTS | | | |
| | 5/23/18 | | | | |
| | 7/25/18 | | | | |
| | 1/21/19 | | | | |
| project WESTERN CT STATE UNIVERSITY WHITE HALL 2ND AND 3RD FLOOR RENOVATIONS DANBURY, CONNECTICUT | | | drawn by CA/SP | approved by AL | drawing no. A1.01 |
| CAD no. | | | project no. BI-RD-299 | | |

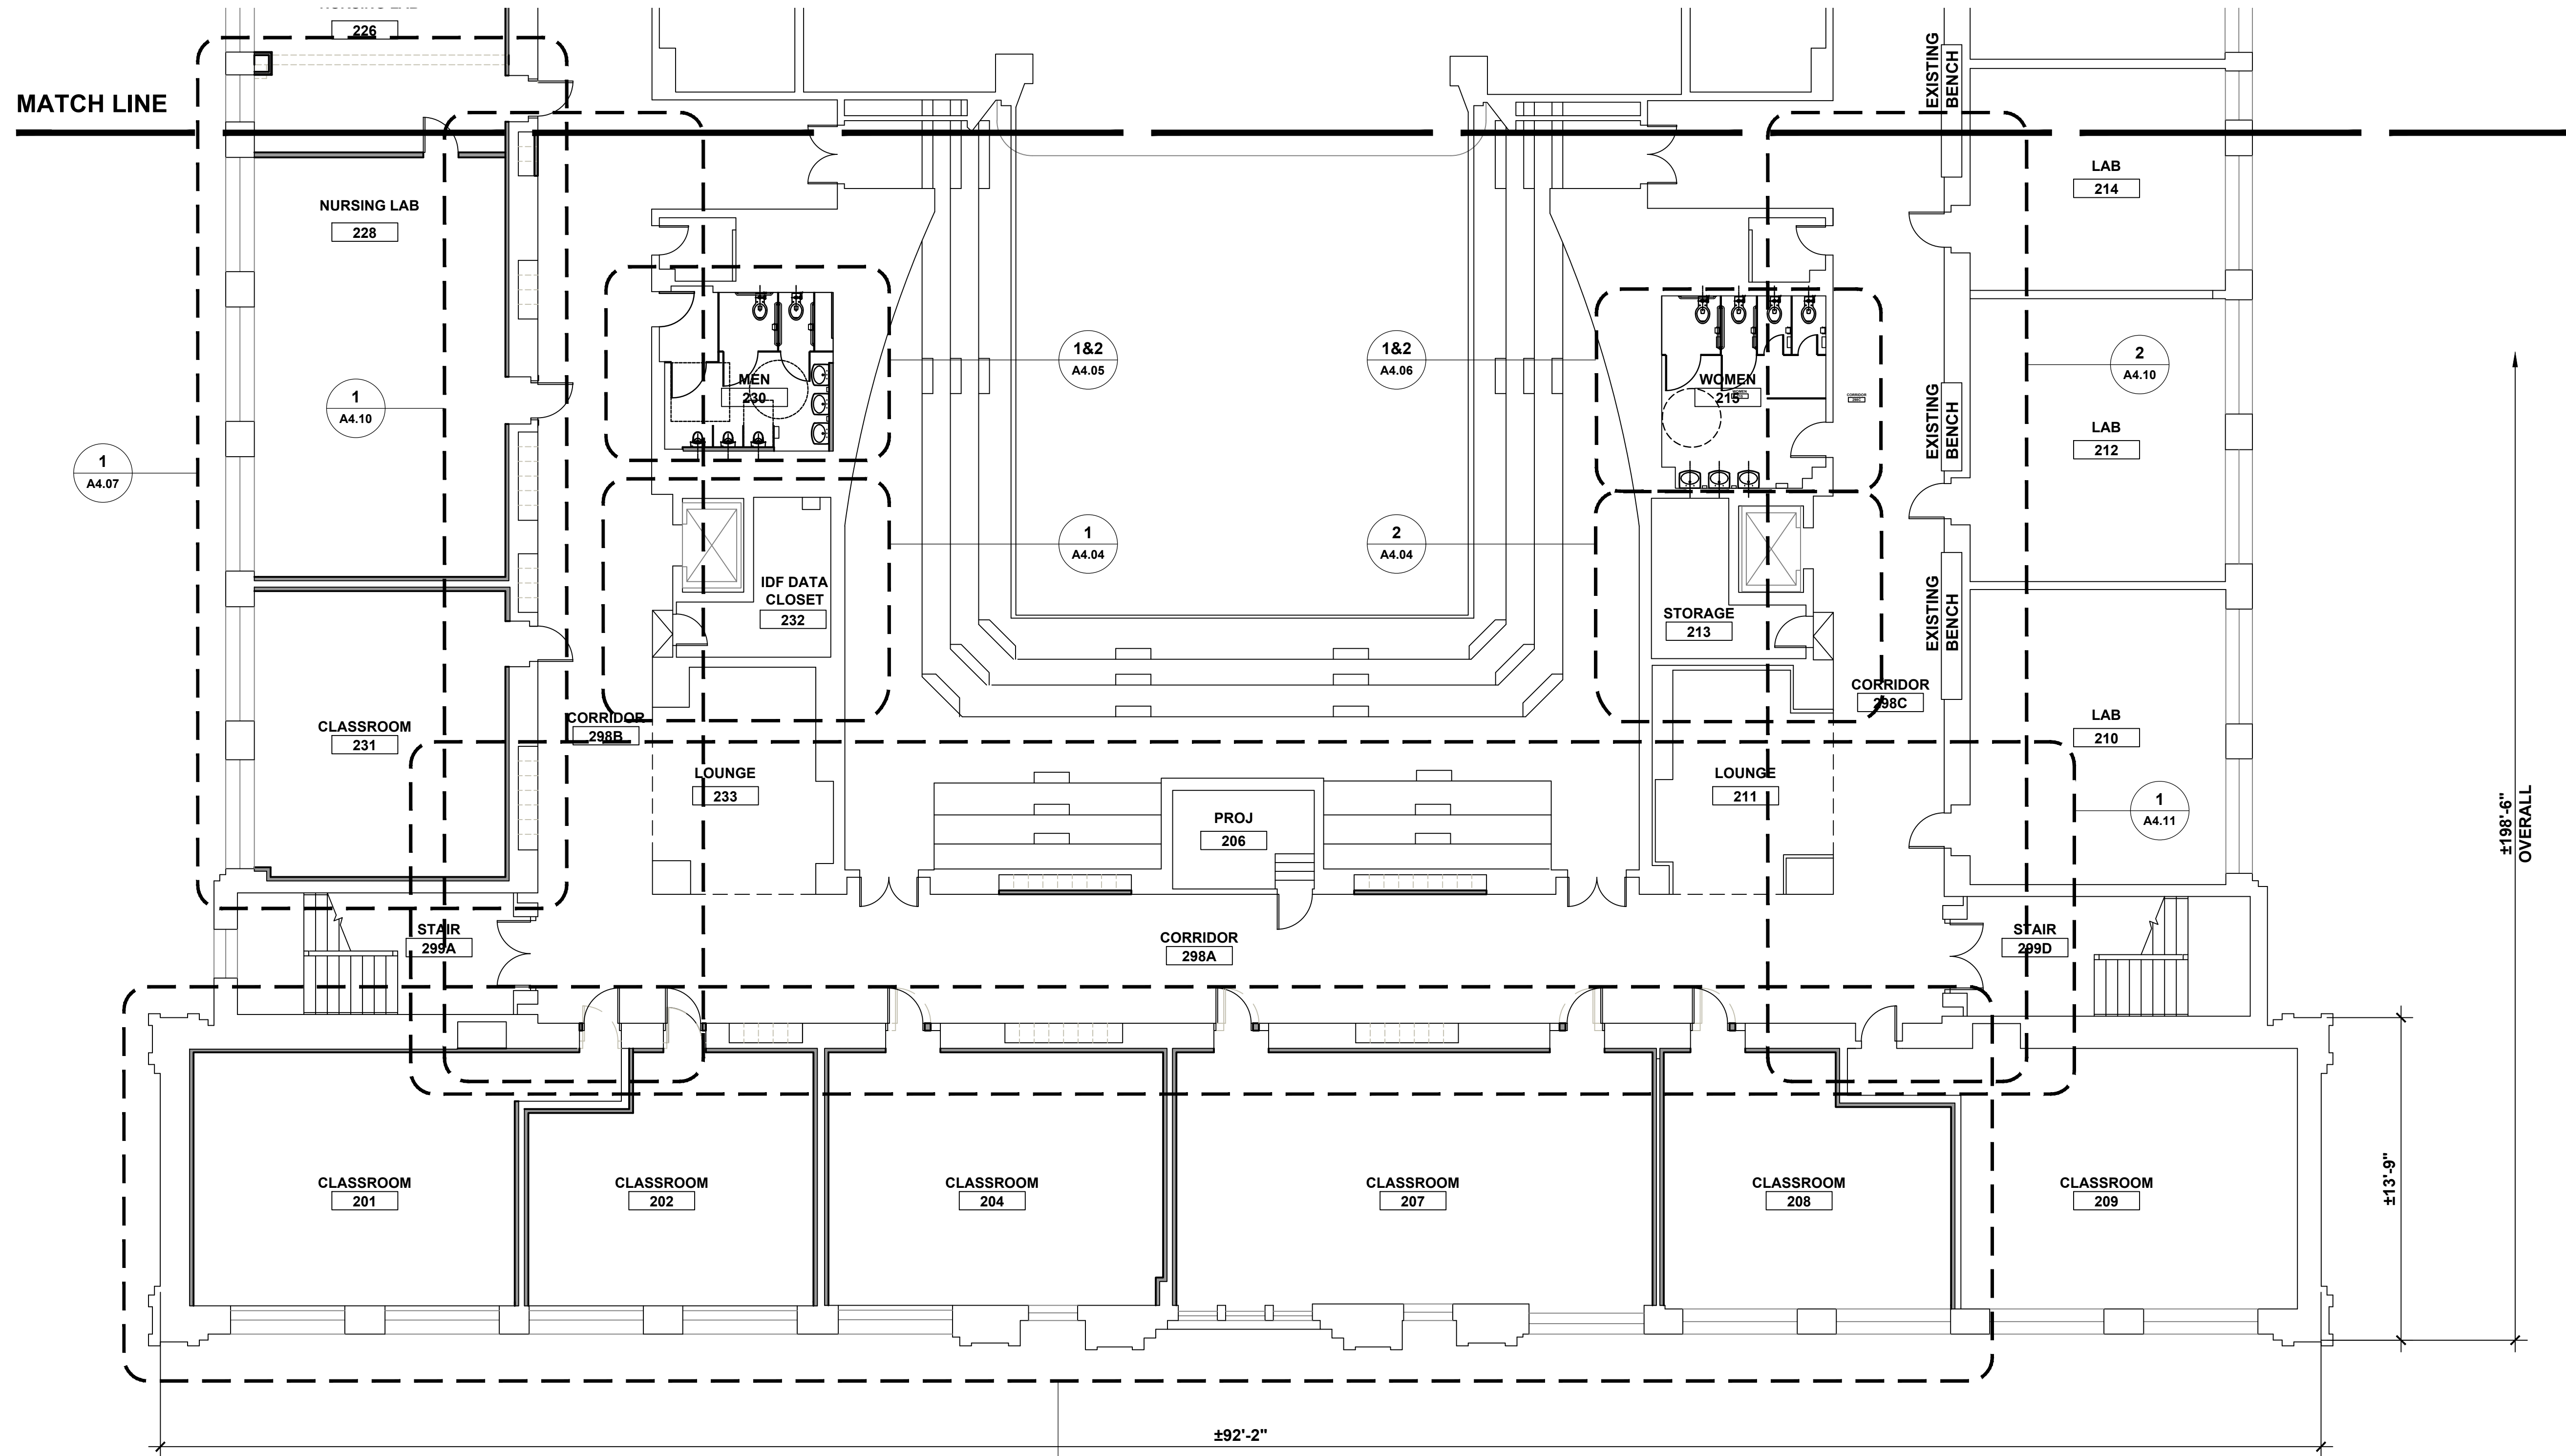


1 SOUTH WING PARTIAL PLAN


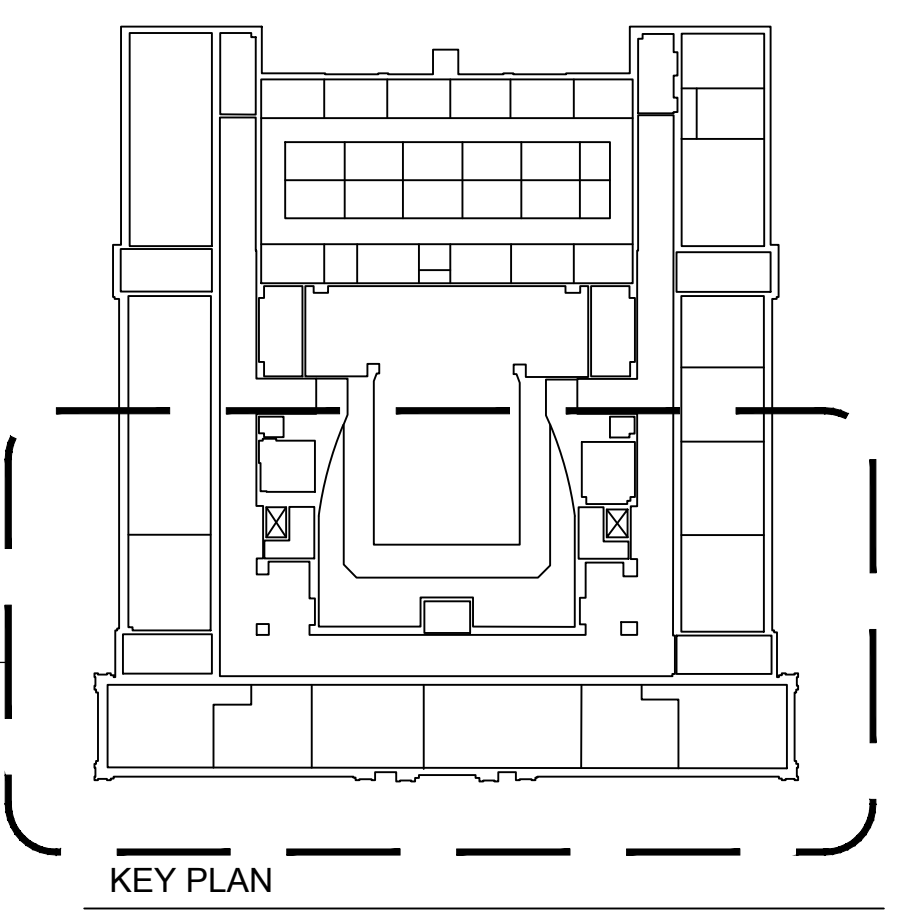


KEY PLAN

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| REVISIONS | | | | | | |
| mark | date | description | drawing prepared by | date | scale | |
| | 8/4/17 | SCHEMATIC DESIGN SUBMISSION | AMES & WHITAKER ARCHITECTS 31 LIBERTY STREET SOUTHINGTON, CT | 07/25/18 | AS NOTED | |
| | 1/15/18 | DESIGN DEVELOPMENT SUBMISSION | | | | |
| | 4/16/18 | CONSTRUCTION DOCUMENTS | | | | |
| | 5/23/18 | | | | | |
| | 7/25/18 | | | | | |
| | 1/21/19 | | | | | |
| | | | project WESTERN CT STATE UNIVERSITY WHITE HALL 2ND AND 3RD FLOOR RENOVATIONS DANBURY, CONNECTICUT | drawn by CA/SP | approved by AL | |
| | | | CAD no. | project no. BI-RD-299 | drawing no. A1.02 | |

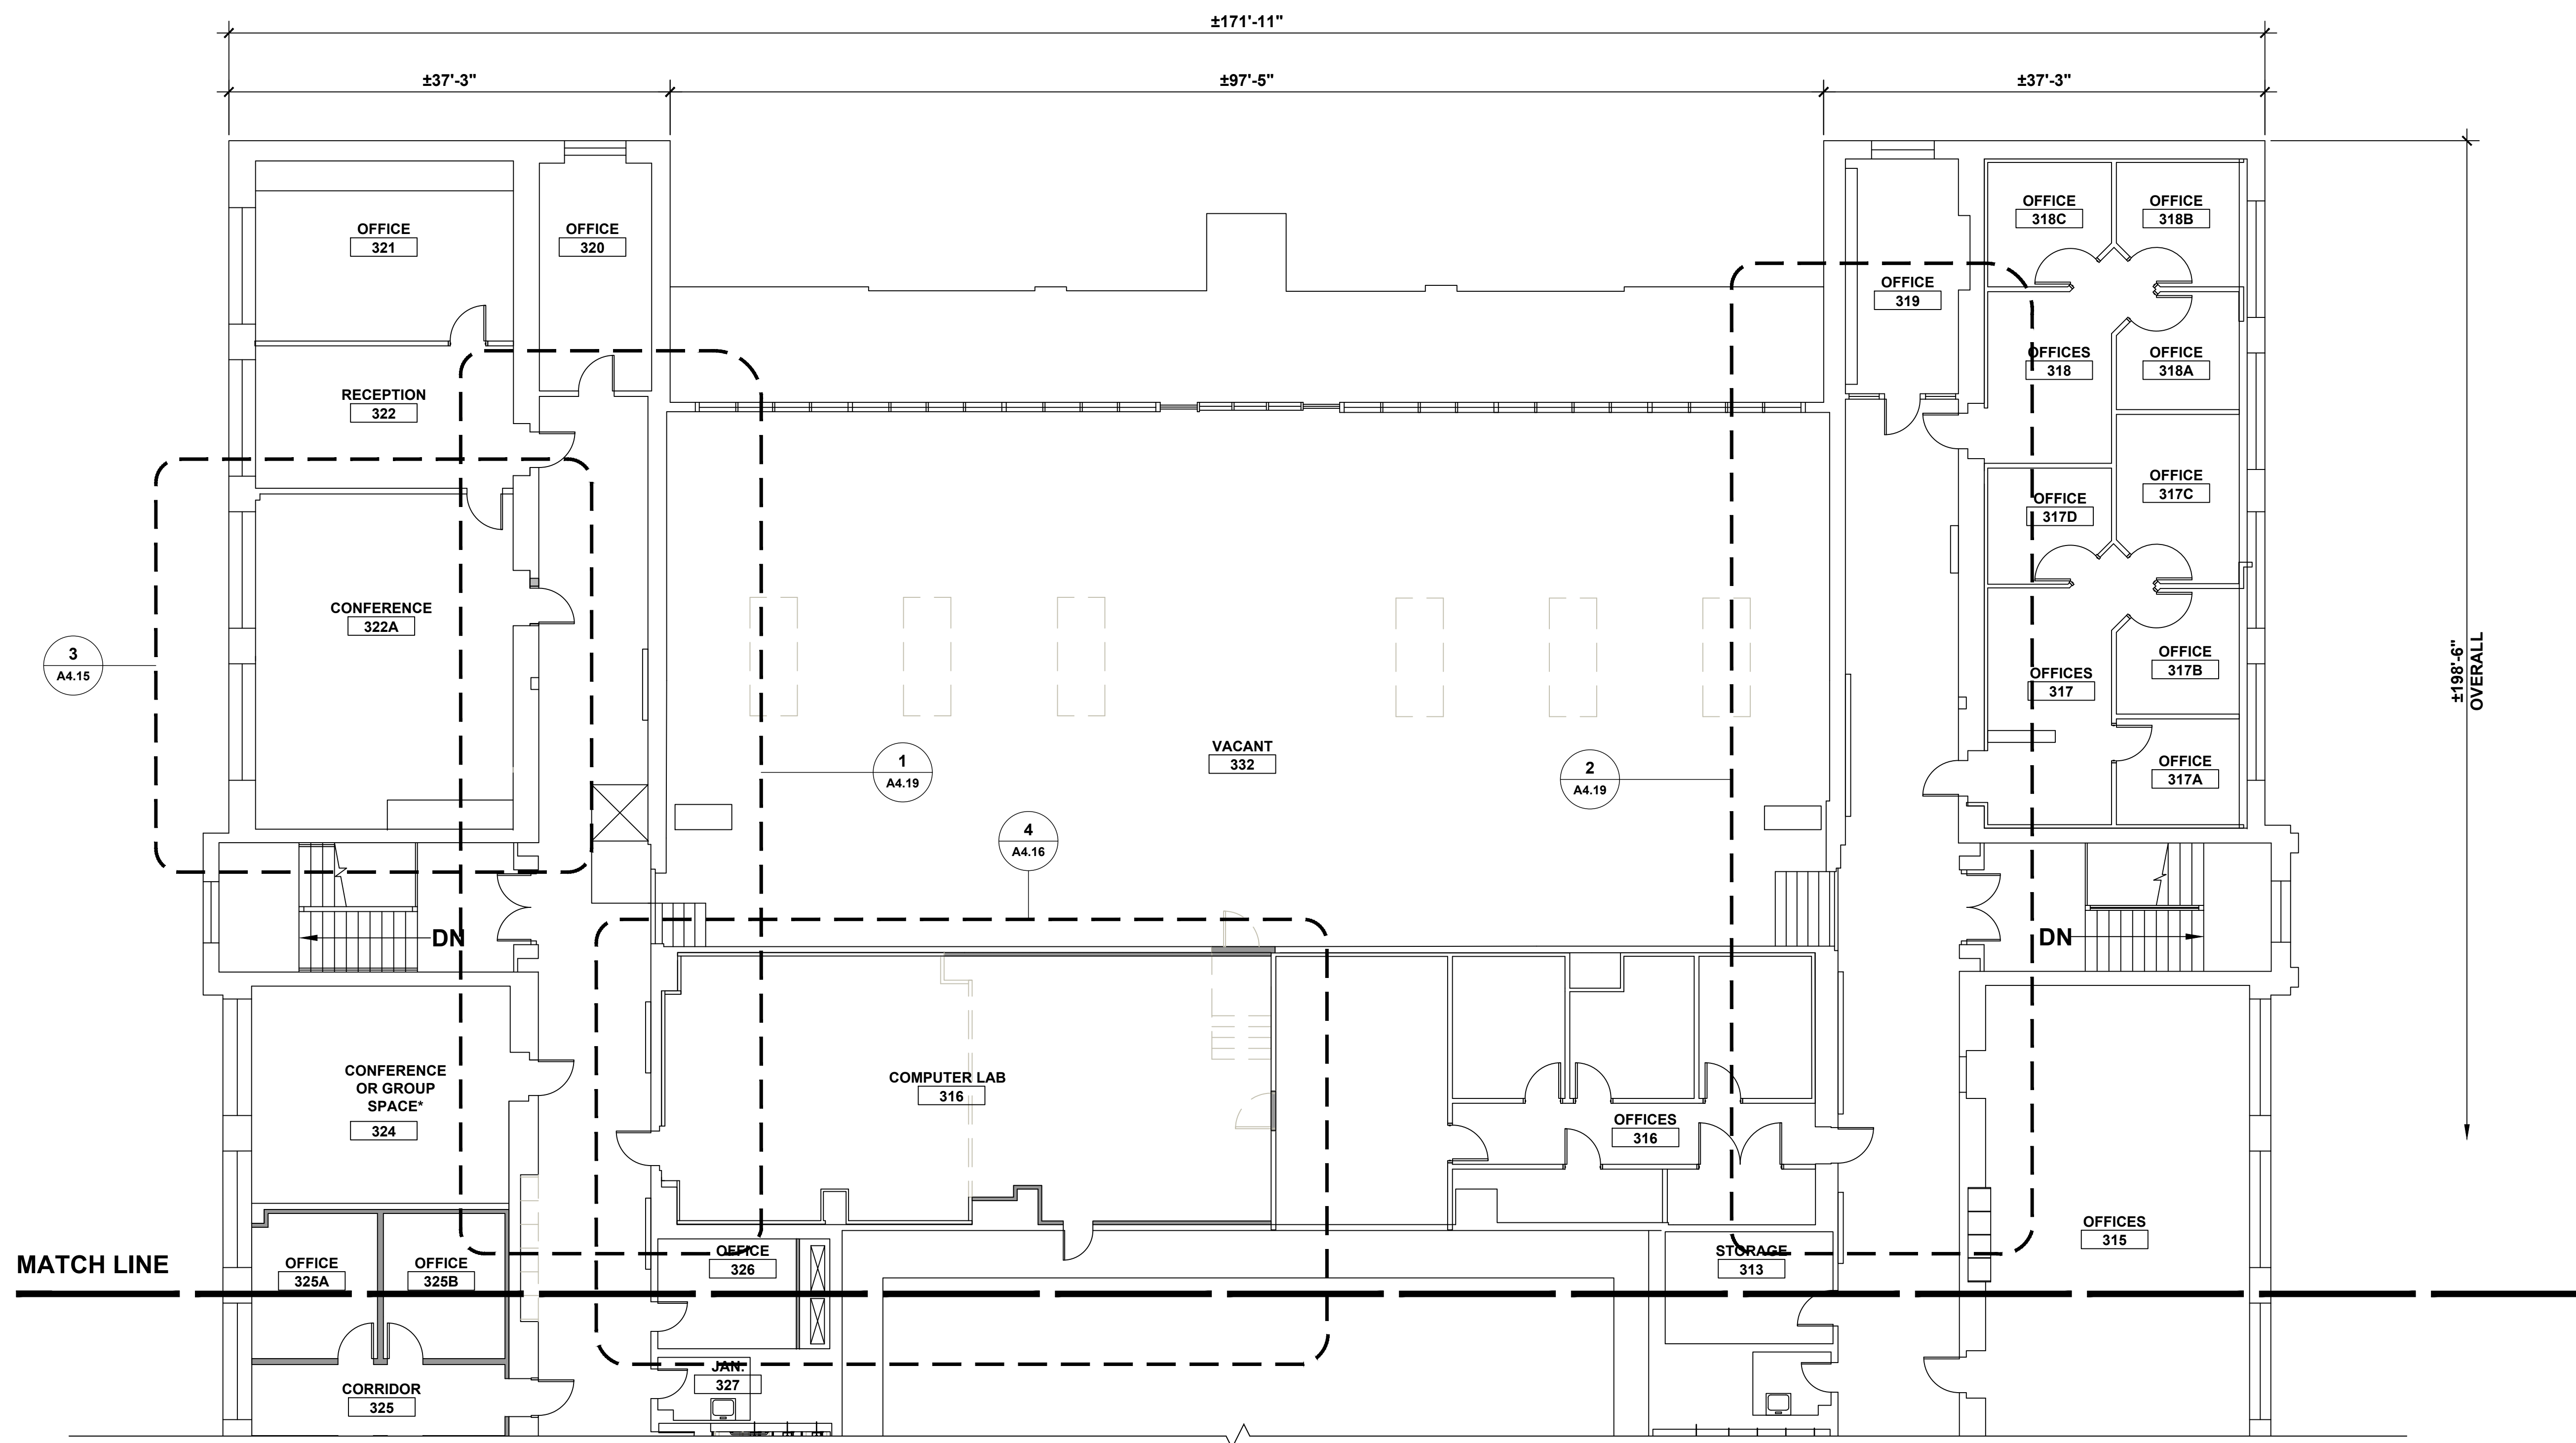


1 THIRD FLOOR - NORTH PARTIAL PLAN

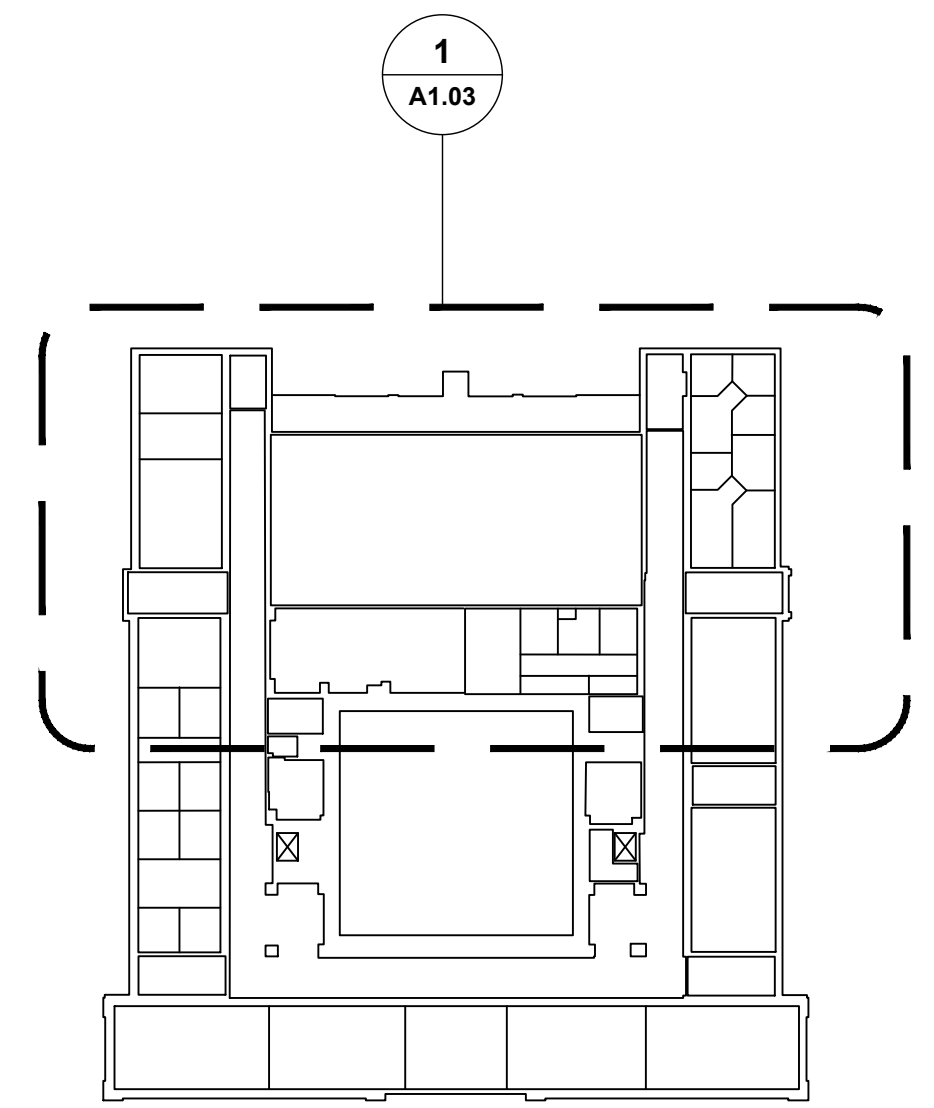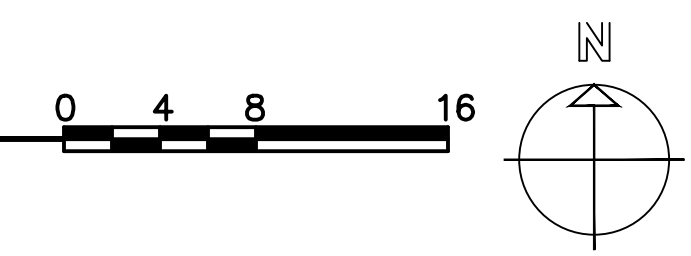


KEY PLAN

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| REVISIONS | | | drawing prepared by AMES & WHITAKER ARCHITECTS 31 LIBERTY STREET SOUTHINGTON, CT | | |
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| | 8/4/17 | SCHEMATIC DESIGN SUBMISSION | 07/25/18 | | |
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| CAD no. | | | project no. BI-RD-299 | | |

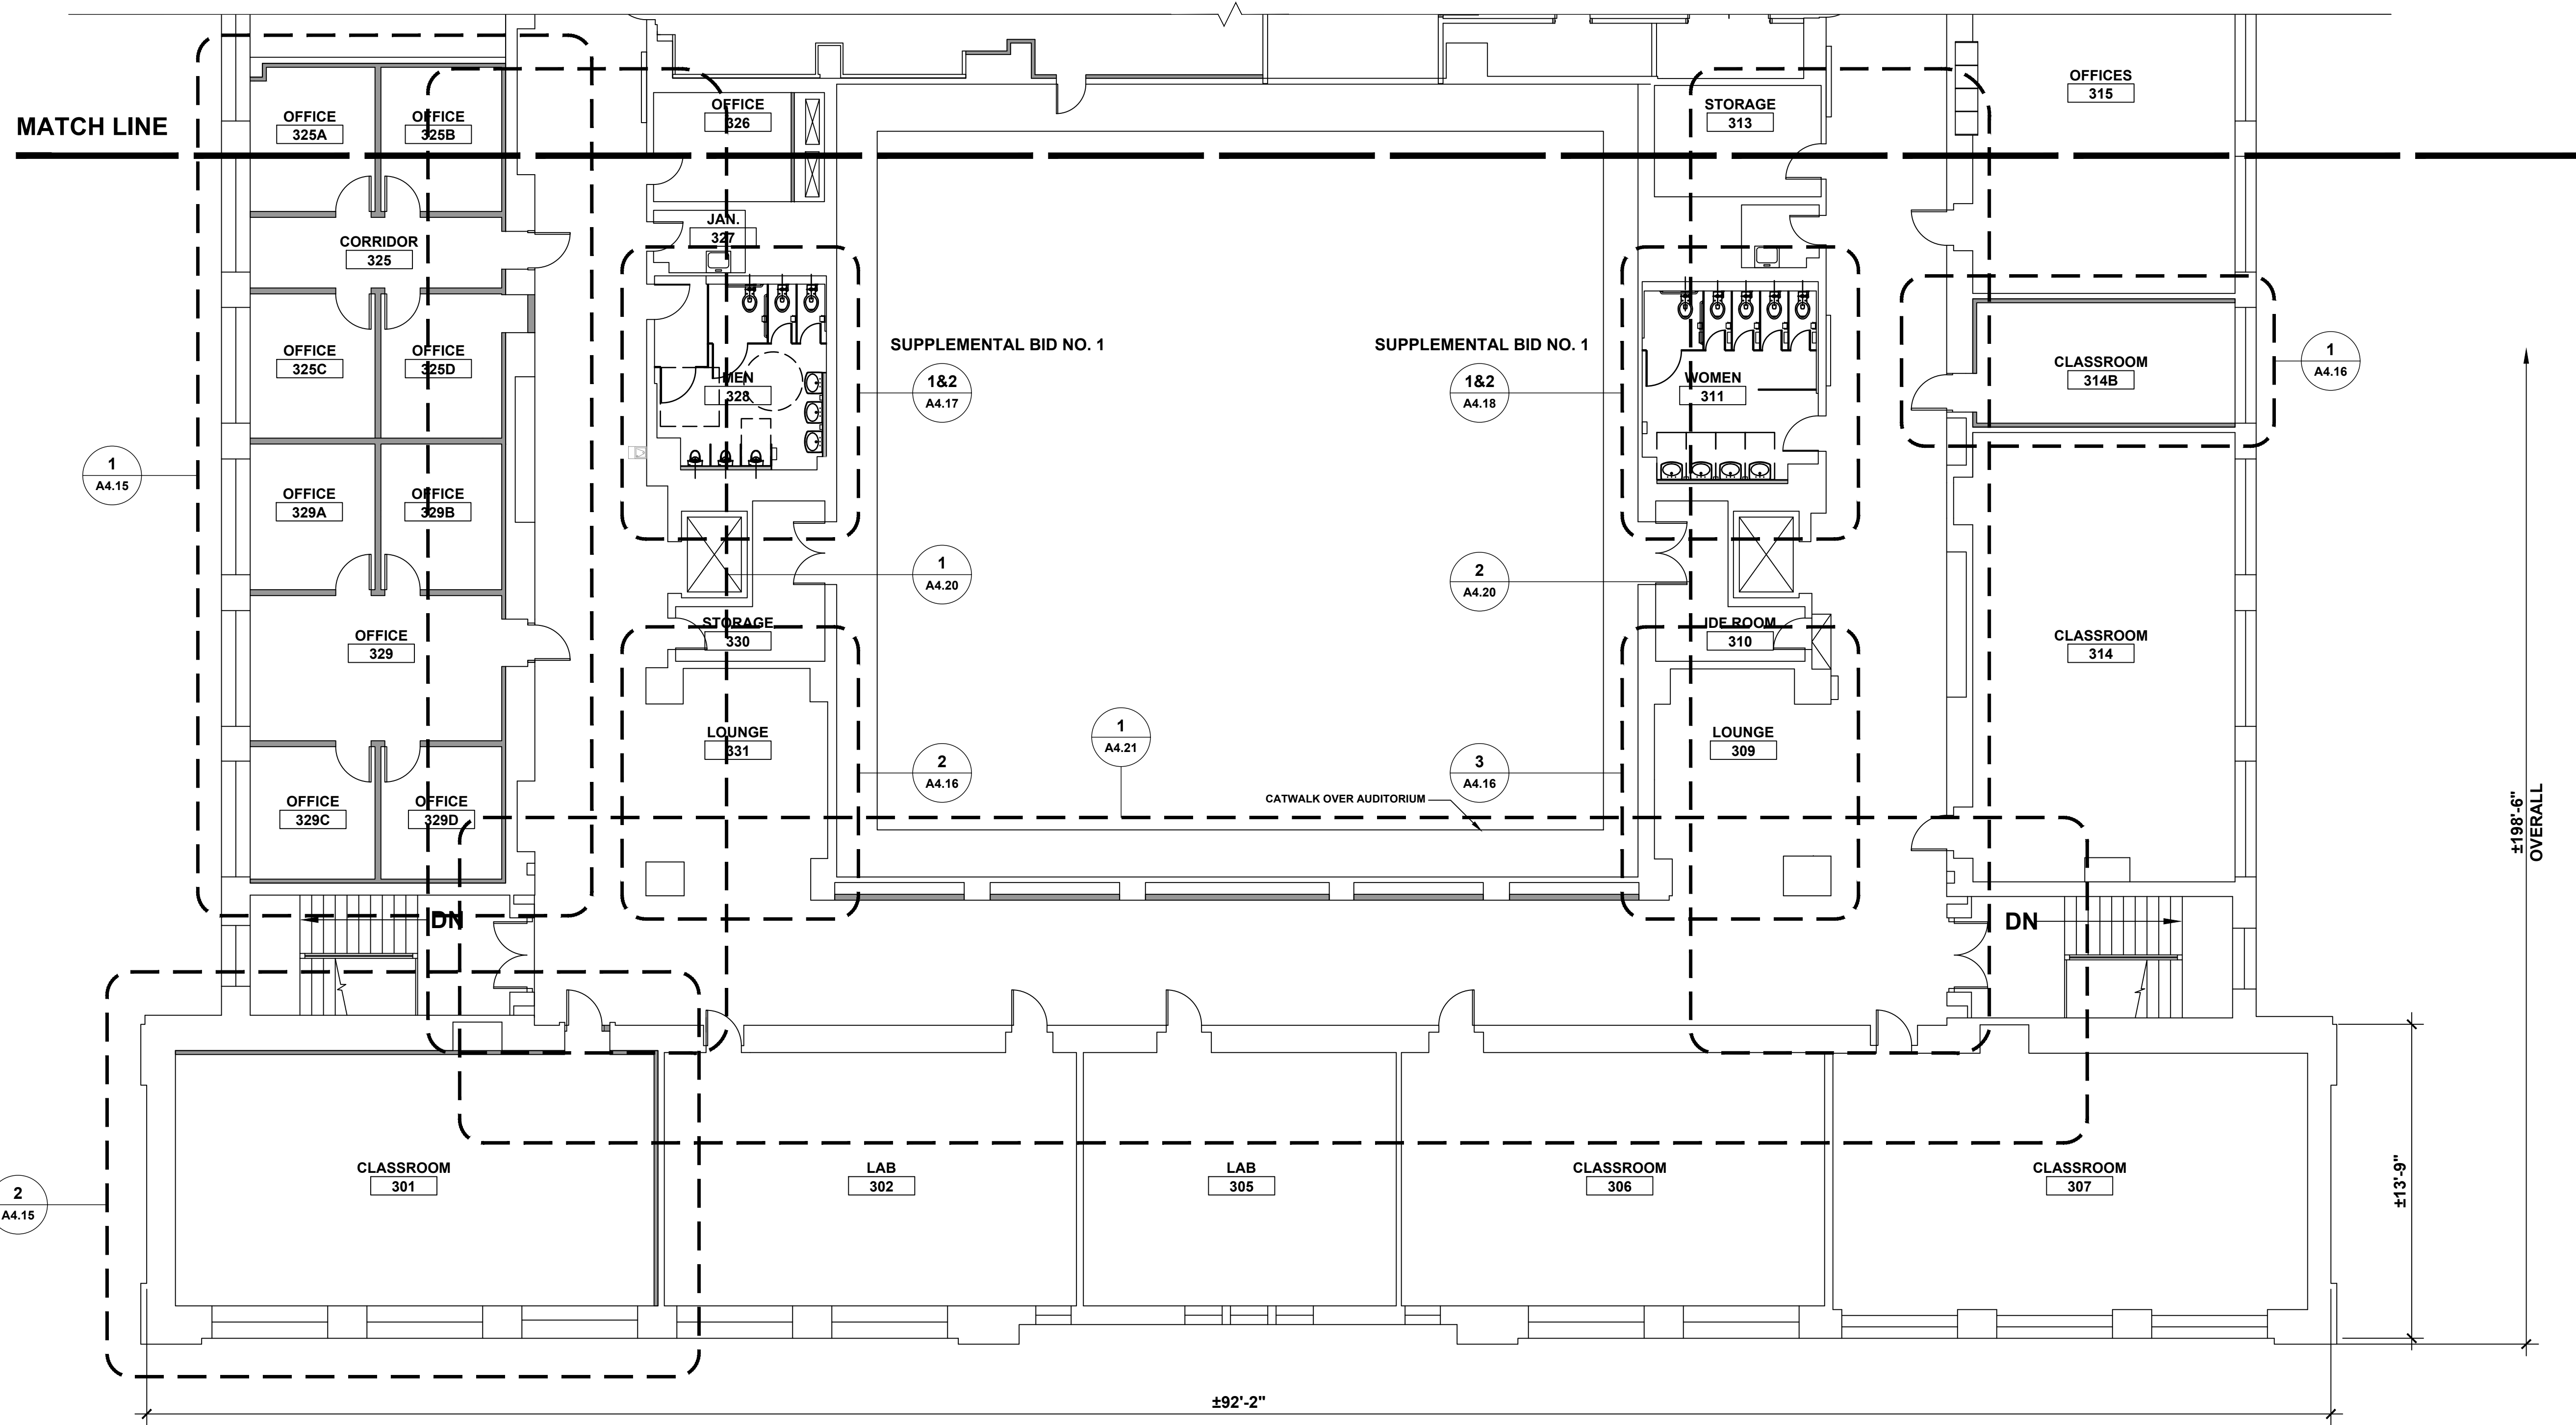


1 THIRD FLOOR - SOUTH PARTIAL PLAN

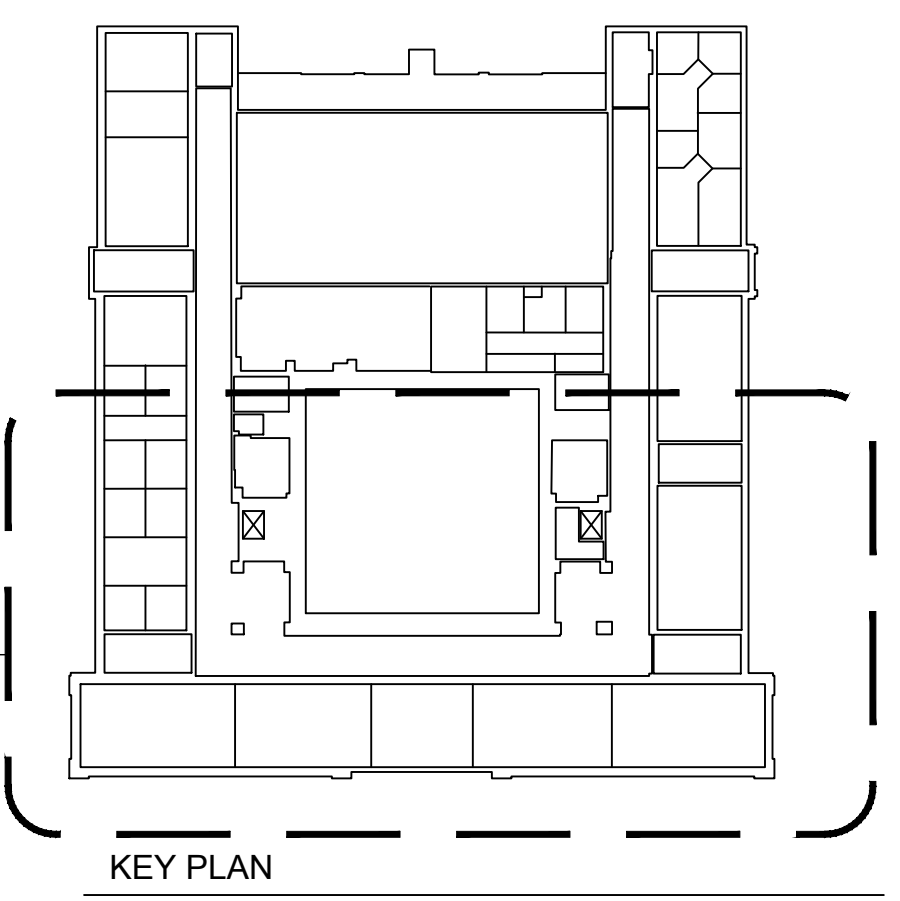


KEY PLAN

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| REVISIONS | | | drawing prepared by AMES & WHITAKER ARCHITECTS 31 LIBERTY STREET SOUTHINGTON, CT | | |
| mark | date | description | date | scale | AS NOTED |
| | 8/4/17 | SCHEMATIC DESIGN SUBMISSION | 07/25/18 | | |
| | 1/15/18 | DESIGN DEVELOPMENT SUBMISSION | | | |
| | 4/16/18 | CONSTRUCTION DOCUMENTS | | | |
| | 5/23/18 | | | | |
| | 7/25/18 | | | | |
| project WESTERN CT STATE UNIVERSITY WHITE HALL 2ND AND 3RD FLOOR RENOVATIONS DANBURY, CONNECTICUT | | | drawn by SP/CA | approved by AL | drawing no. A1.04 |
| CAD no. | | | project no. BI-RD-299 | | |

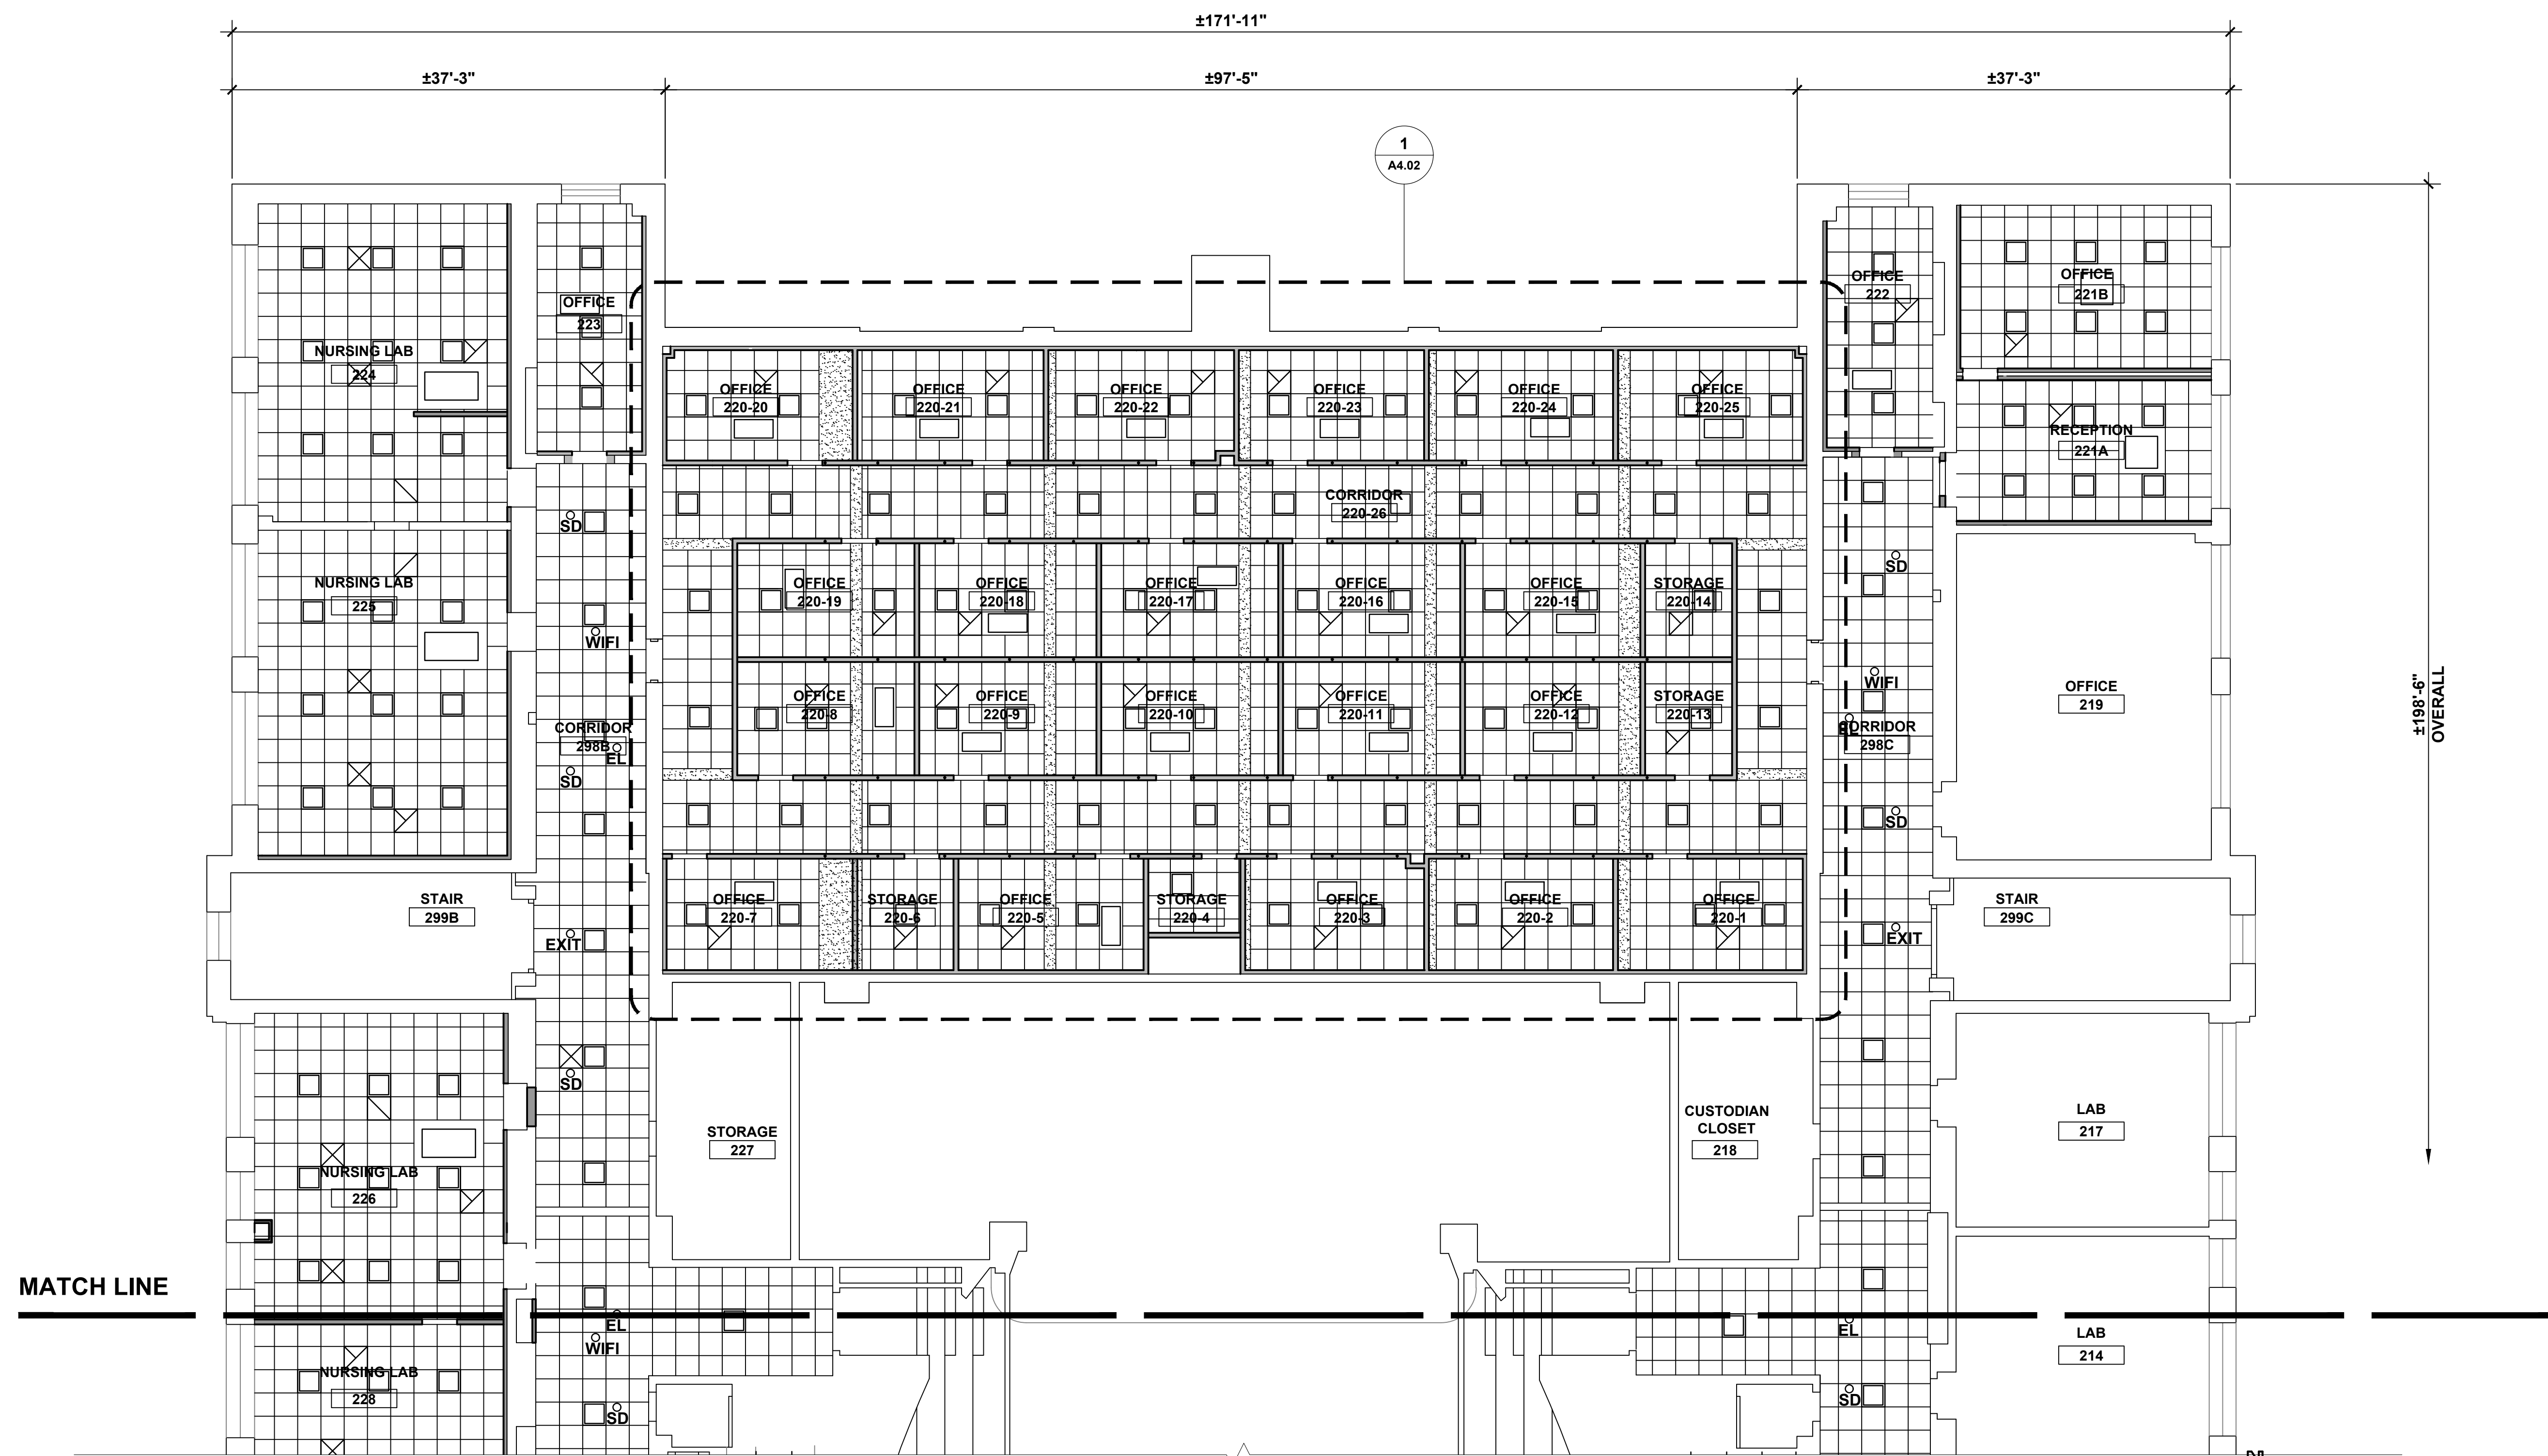

1 NORTH WING PARTIAL PLAN




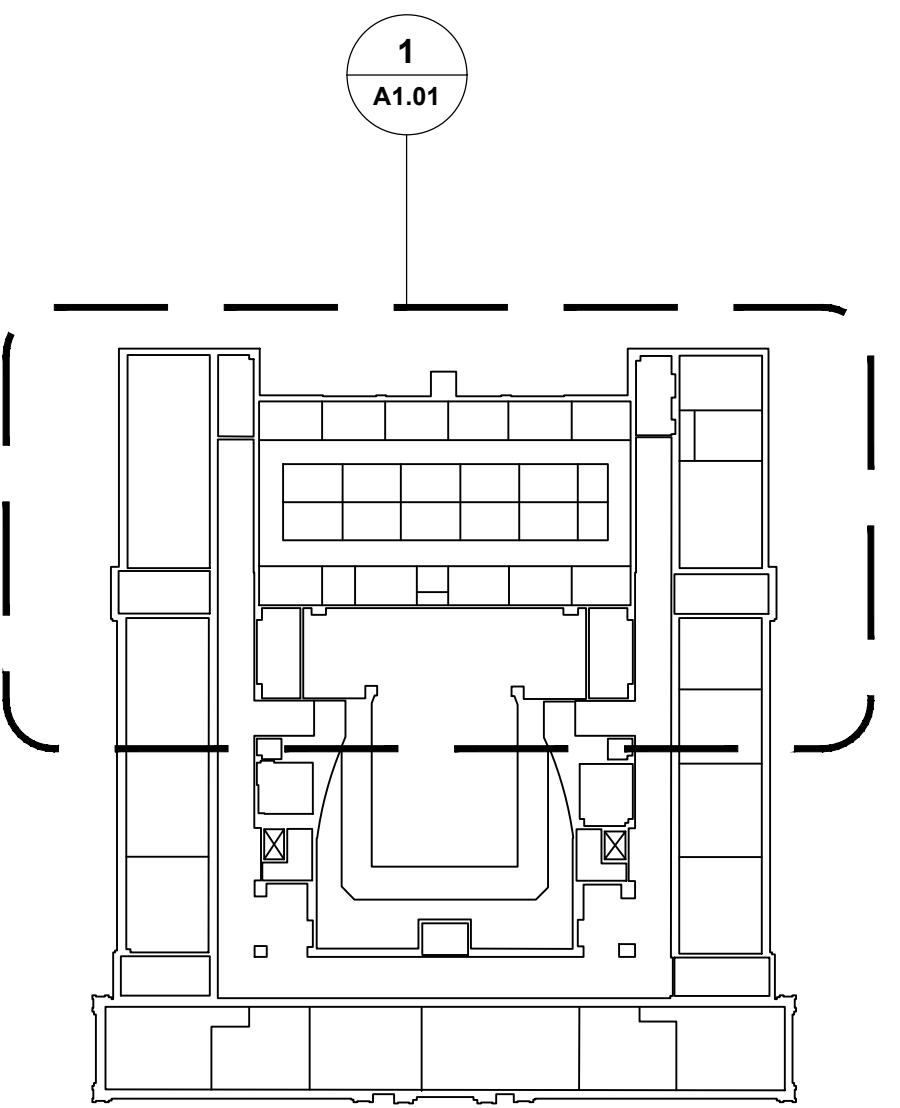


KEY PLAN

CEILING LEGEND


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|--|--------------------------------|
| | 2 x 2 SUSPENDED CEILING |
| | GYPSUM BOARD CEILING, PAINTED |
| | SUPPLY DIFFUSER |
| | RETURN DIFFUSER |
| | RECESSED FLUORESCENT LUMINAIRE |

- REFLECTED CEILING NOTES**
- COORDINATE WITH MECHANICAL AND ELECTRICAL DRAWINGS FOR LOCATIONS AND FIXTURE DESCRIPTIONS OF LIGHTING, SUPPLY/RETURN DIFFUSERS, AND RADIANT CEILING HEATING PANELS.
 - REFER TO MECHANICAL PLANS FOR DUCT PENETRATIONS AT CORRIDOR WALLS. COORDINATE SIZE OF OPENINGS TO ACCOMMODATE FIRE DAMPERS SHOWN ON DETAIL 5/M3.01.
 - INFILL MASONRY WALL WHERE EXISTING DUCTS REMOVED. SEE MASONRY INFILL DETAIL.

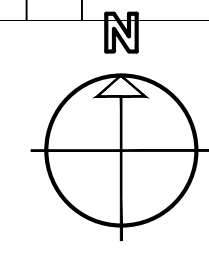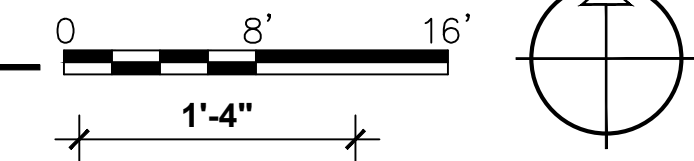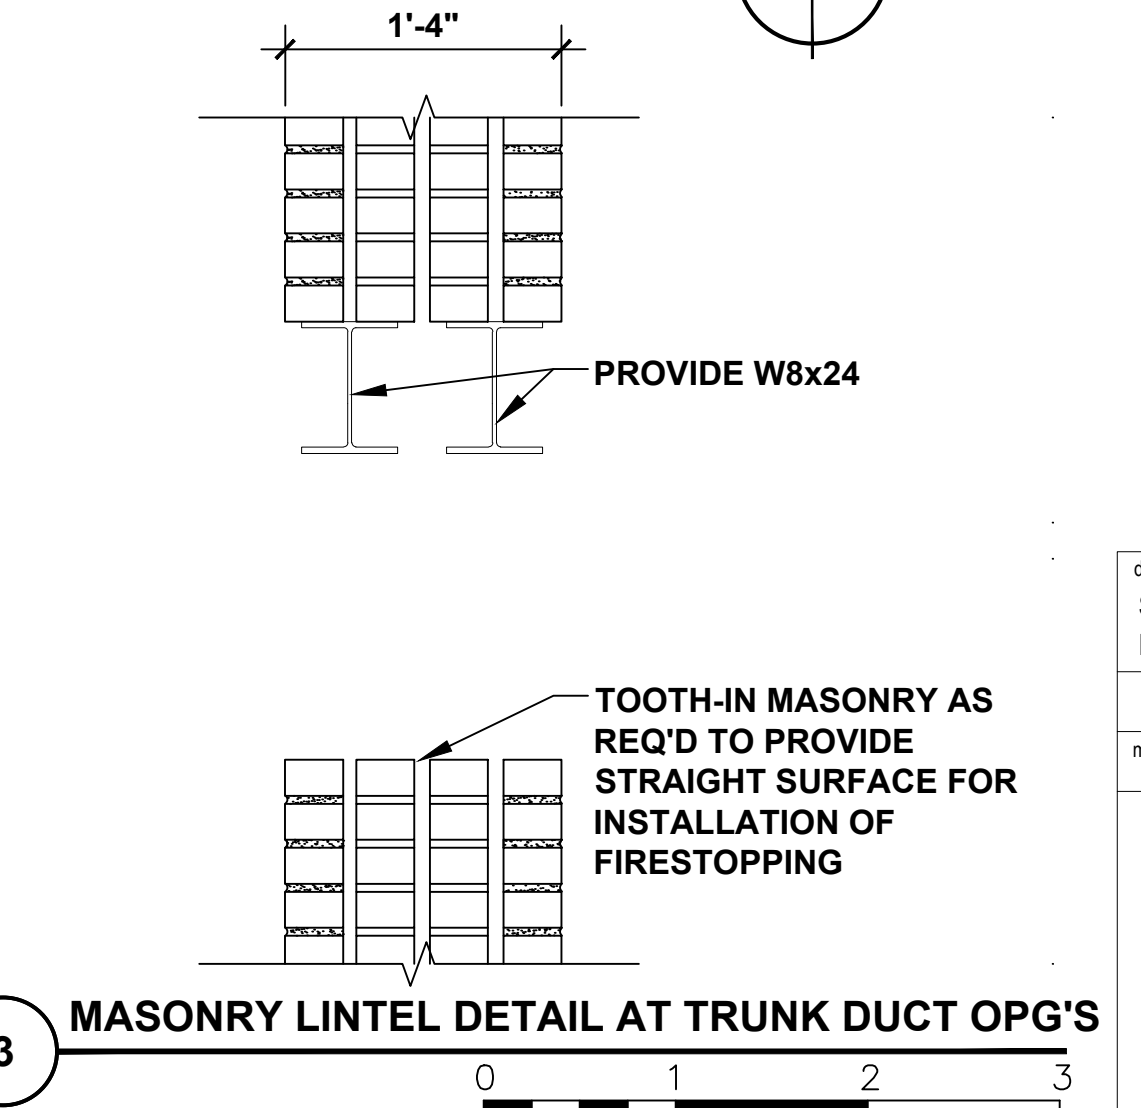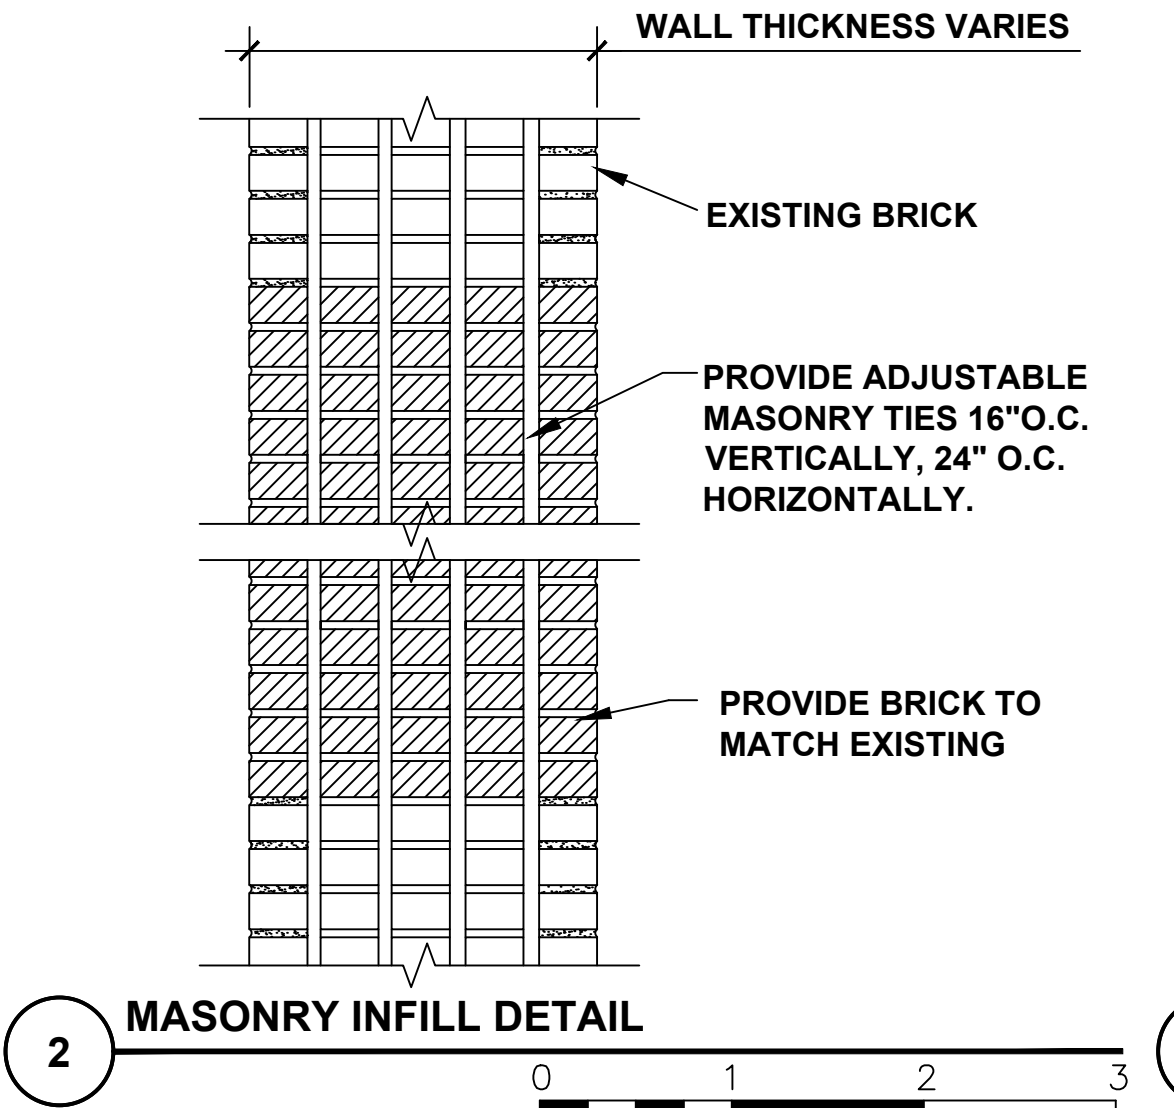


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|--|---------|--|---|
| drawing title SECOND FLOOR - NORTH REFLECTED CEILING PLAN | | STATE OF CONNECTICUT DEPARTMENT OF ADMINISTRATIVE SERVICES | |
| REVISIONS | | drawing prepared by AMES & WHITAKER ARCHITECTS 31 LIBERTY STREET SOUTHINGTON, CT | |
| mark | date | description | date |
| | 8/4/17 | SCHEMATIC DESIGN SUBMISSION | 07/25/18 |
| | 1/15/18 | DESIGN DEVELOPMENT SUBMISSION | scale AS NOTED |
| | 4/16/18 | CONSTRUCTION DOCUMENTS | project WESTERN CT STATE UNIVERSITY WHITE HALL 2ND AND 3RD FLOOR RENOVATIONS DANBURY, CONNECTICUT |
| | 5/23/18 | | drawn by CAV/SP |
| | 7/25/18 | | approved by AL |
| | 1/21/19 | | drawing no. A1.05 |
| CAD no. | | project no. BI-RD-299 | |

MATCH LINE

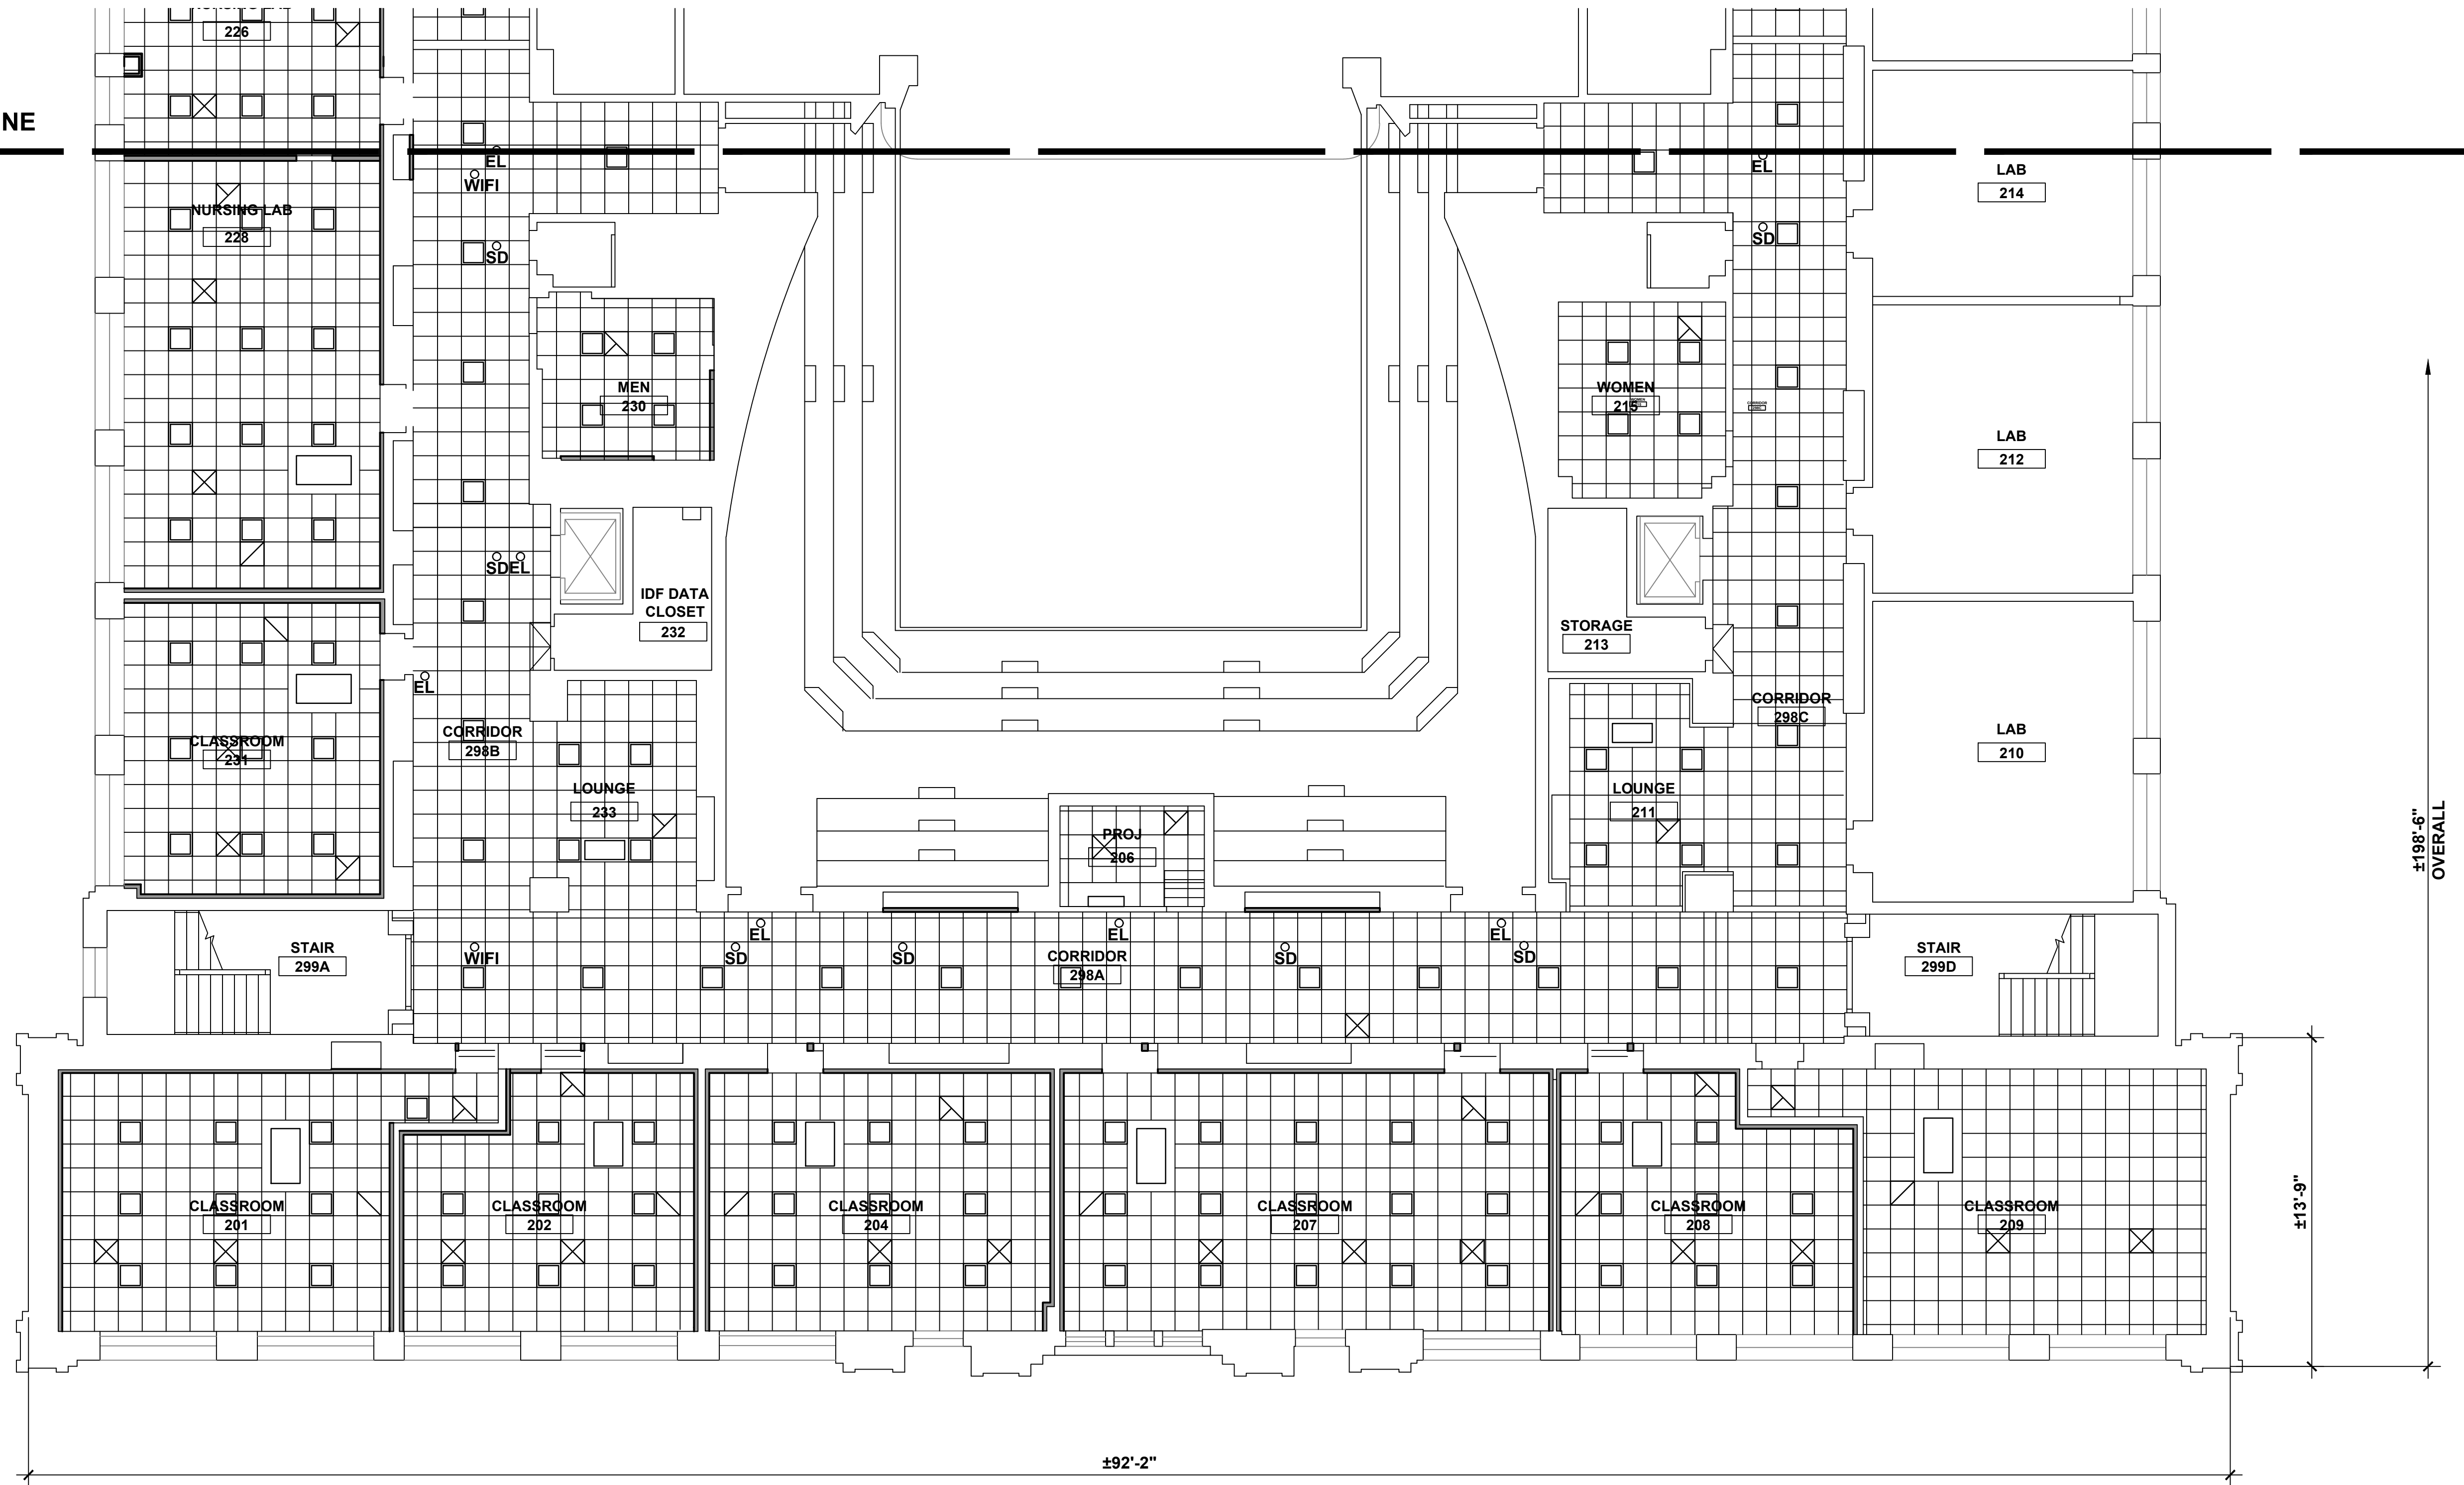

±13'-9" OVERALL


1 SOUTH WING PARTIAL PLAN

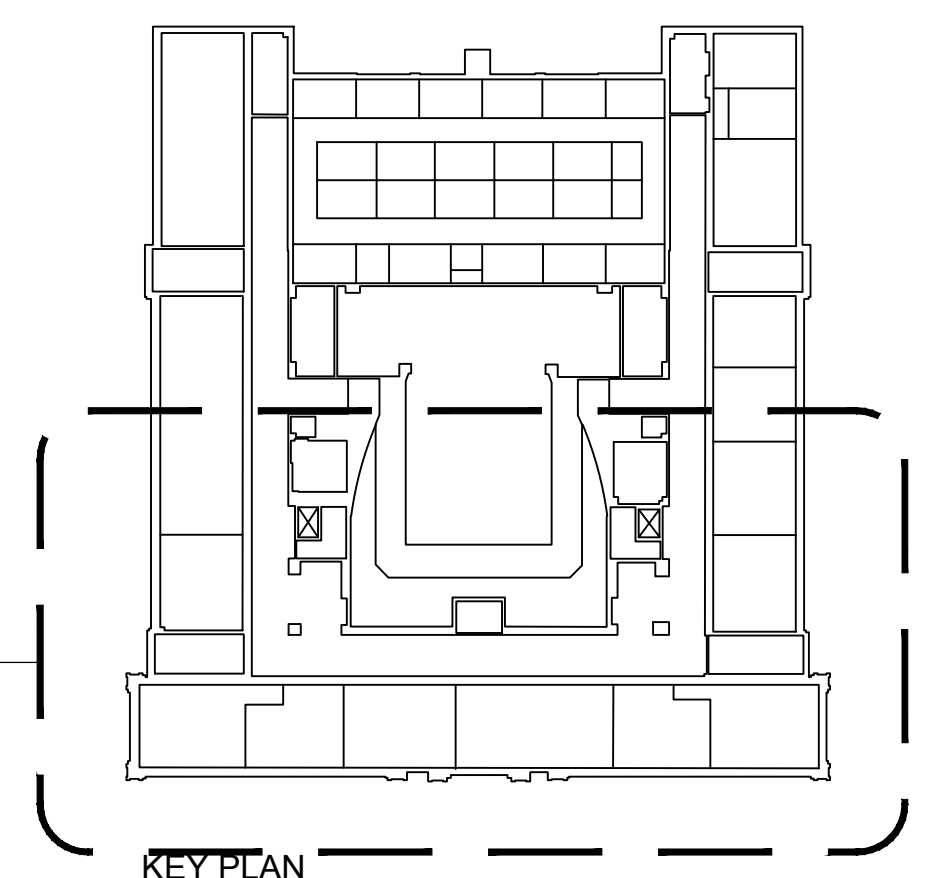


KEY PLAN

| CEILING LEGEND | |
|----------------|--------------------------------|
| | 2 x 2 SUSPENDED CEILING |
| | GYPSUM BOARD CEILING, PAINTED |
| | SUPPLY DIFFUSER |
| | RETURN DIFFUSER |
| | RECESSED FLUORESCENT LUMINAIRE |

| REFLECTED CEILING NOTES | |
|-------------------------|---|
| 1. | COORDINATE WITH MECHANICAL AND ELECTRICAL DRAWINGS FOR LOCATIONS AND FIXTURE DESCRIPTIONS OF LIGHTING, SUPPLY/RETURN DIFFUSERS, AND RADIANT CEILING HEATING PANELS. |
| 2. | REFER TO MECHANICAL PLANS FOR DUCT PENETRATIONS AT CORRIDOR WALLS. COORDINATE SIZE OF OPENINGS TO ACCOMMODATE FIRE DAMPERS SHOWN ON DETAIL 5/M3.01. |
| 3. | INFILL MASONRY WALL WHERE EXISTING DUCTS REMOVED. SEE MASONRY INFILL DETAIL. |

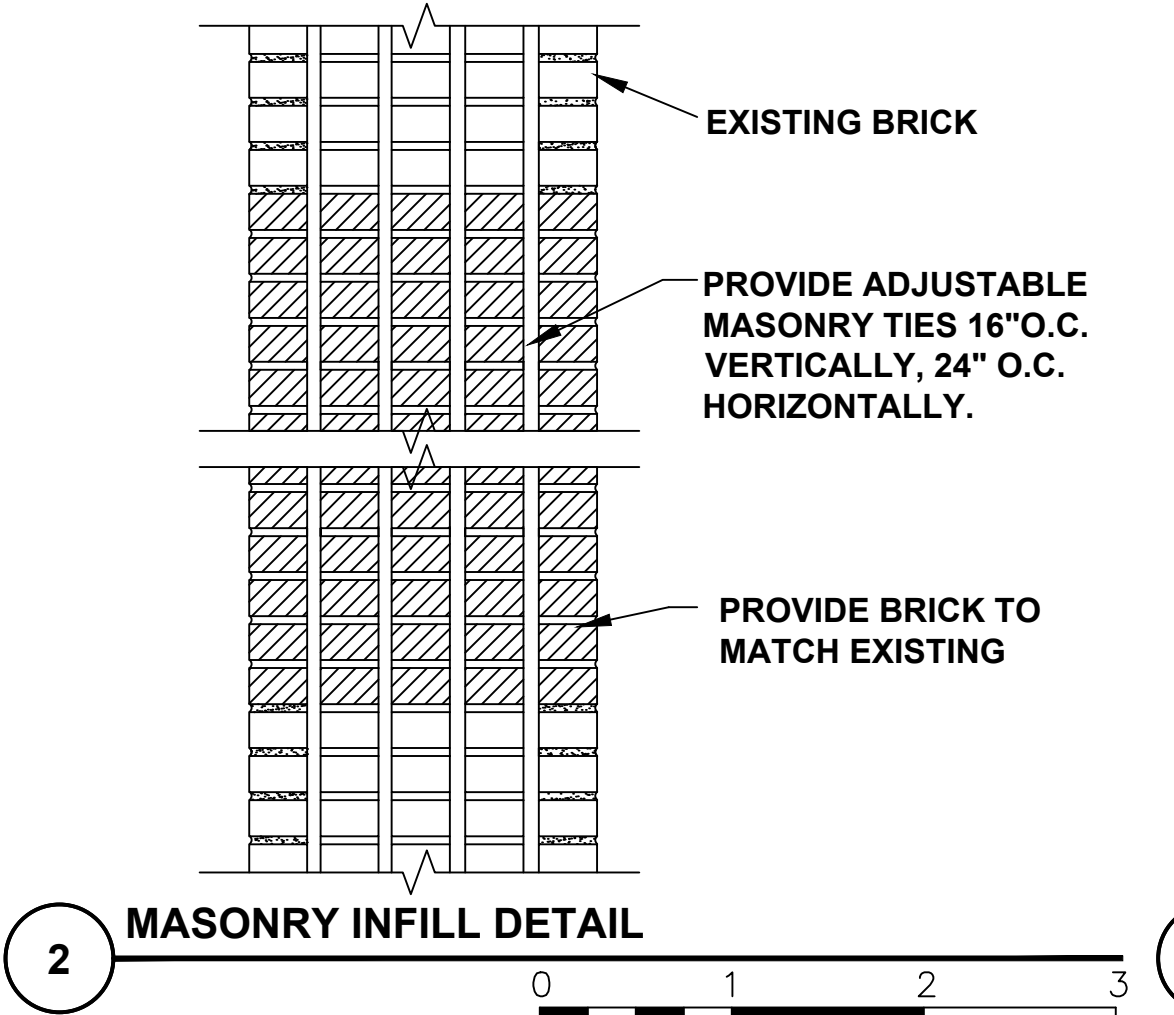


2 MASONRY INFILL DETAIL


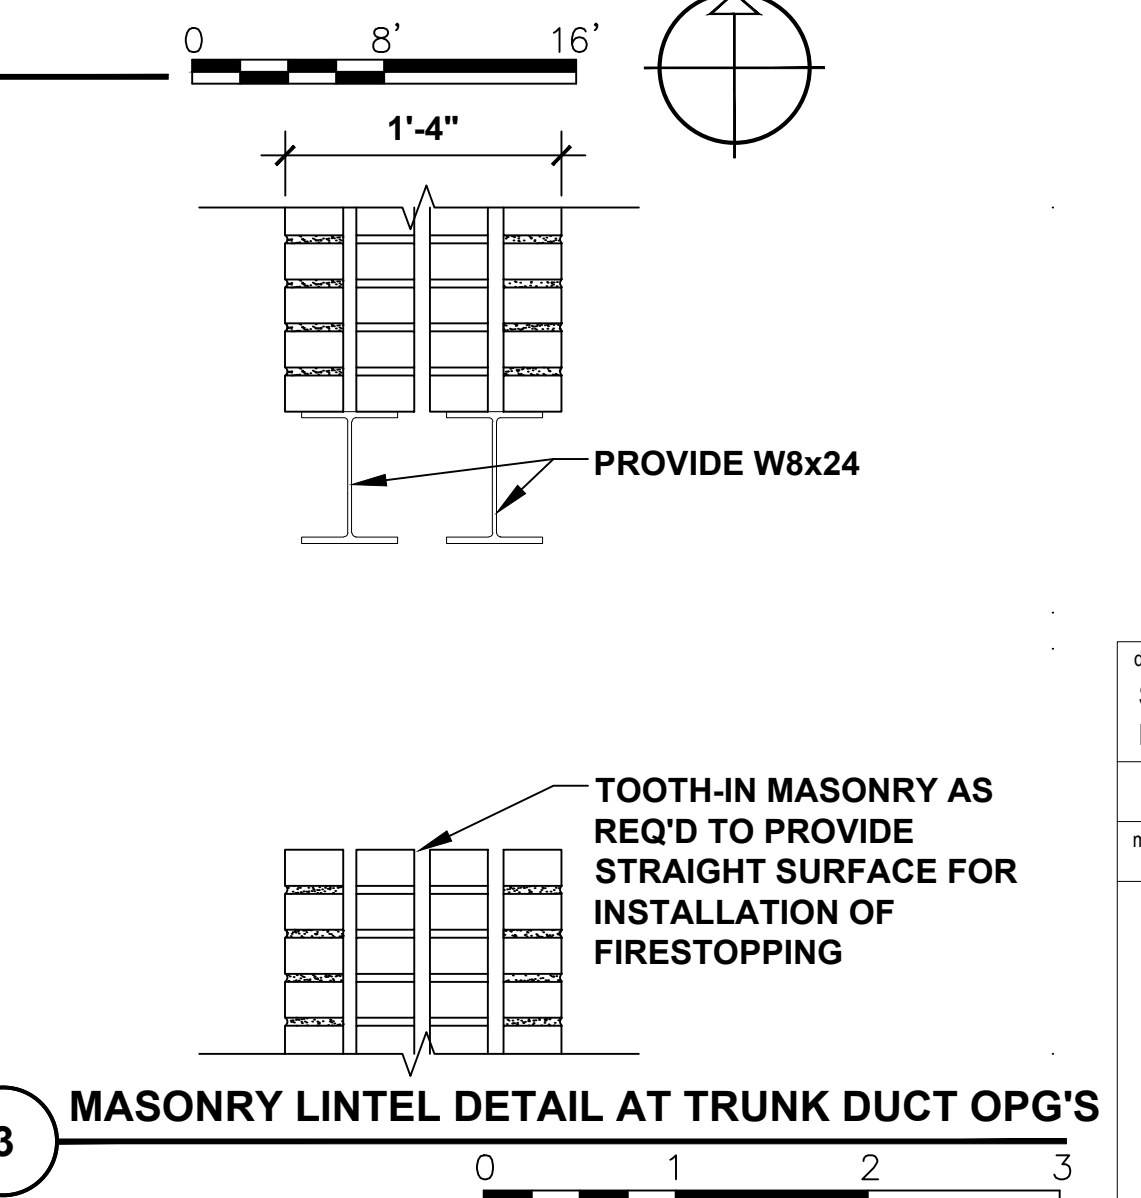


3 MASONRY LINTEL DETAIL AT TRUNK DUCT OPG'S

| STATE OF CONNECTICUT DEPARTMENT OF ADMINISTRATIVE SERVICES | | |
|---|---------|-------------------------------|
| drawing title SECOND FLOOR - SOUTH REFLECTED CEILING PLAN | | date 07/25/18 |
| drawing prepared by AMES & WHITAKER ARCHITECTS 31 LIBERTY STREET SOUTHINGTON, CT | | scale AS NOTED |
| REVISIONS | | |
| mark | date | description |
| | 8/4/17 | SCHEMATIC DESIGN SUBMISSION |
| | 1/15/18 | DESIGN DEVELOPMENT SUBMISSION |
| | 4/16/18 | CONSTRUCTION DOCUMENTS |
| | 5/23/18 | |
| | 7/25/18 | |
| | 1/21/19 | |
| project WESTERN CT STATE UNIVERSITY WHITE HALL 2ND AND 3RD FLOOR RENOVATIONS DANBURY, CONNECTICUT | | drawn by CAV/SP |
| approved by AL | | drawing no. A1.06 |
| CAD no. BI-RD-299 | | |

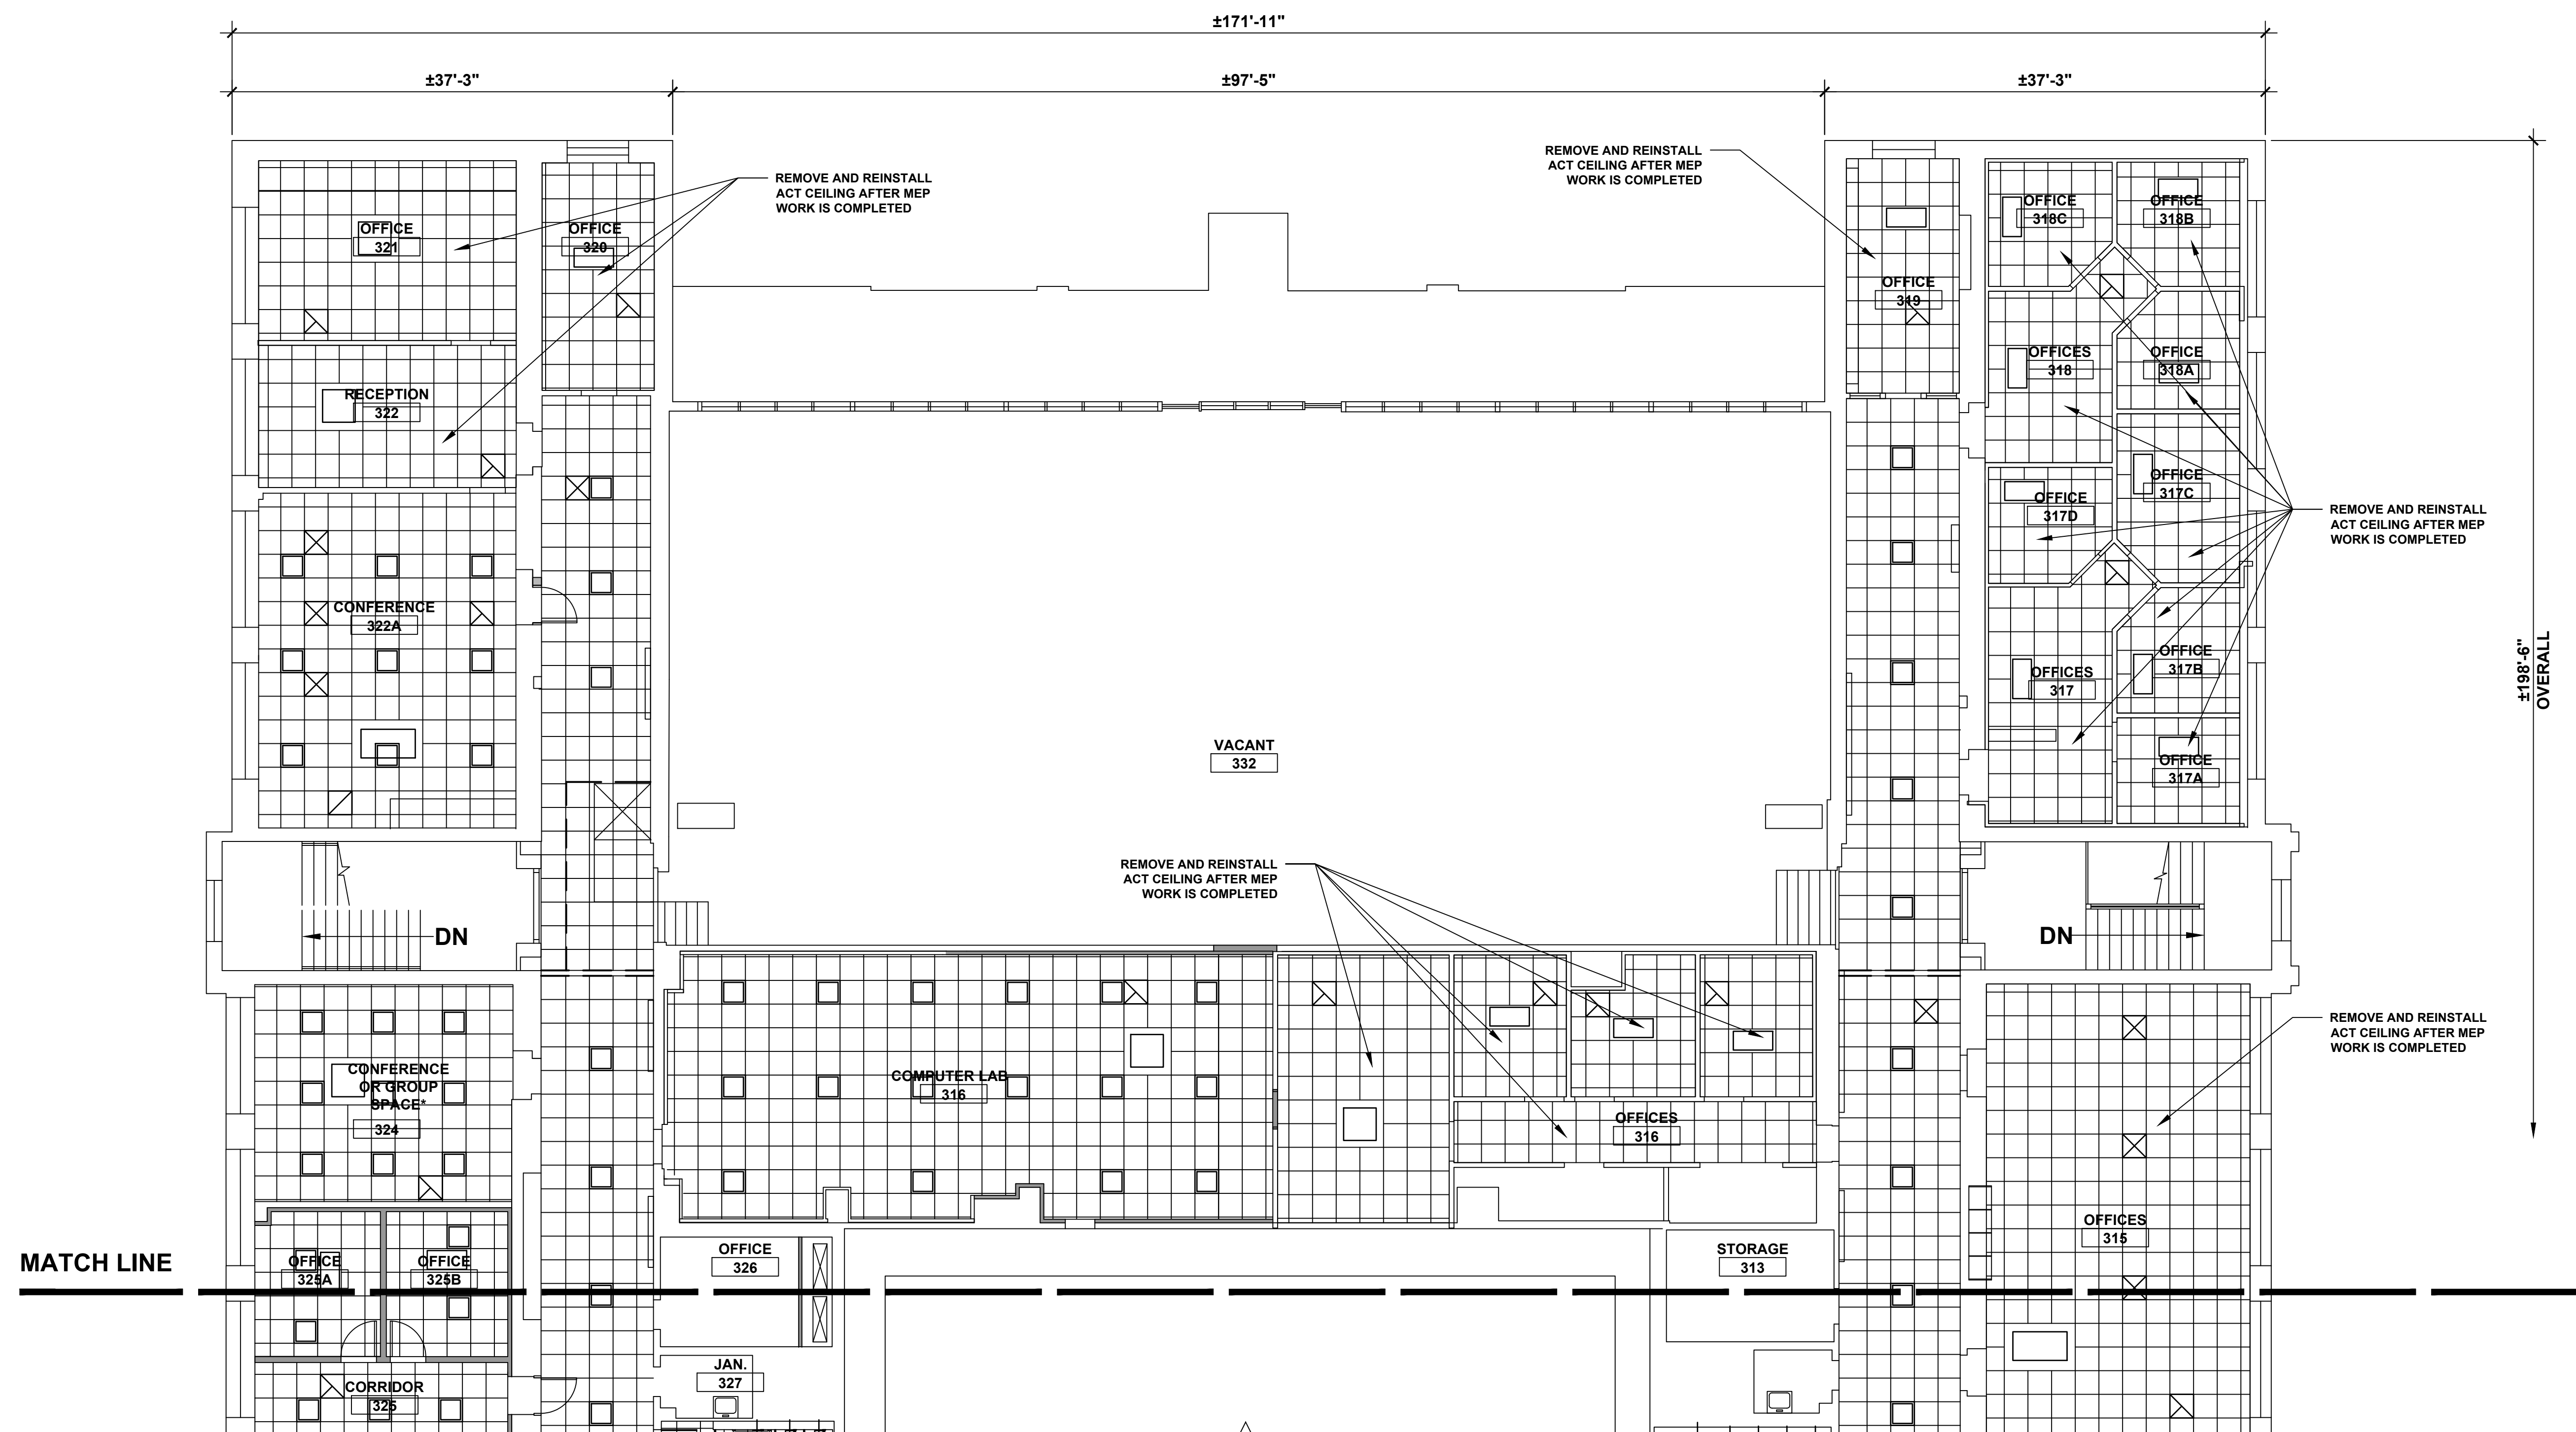

1 THIRD FLOOR - NORTH PARTIAL PLAN

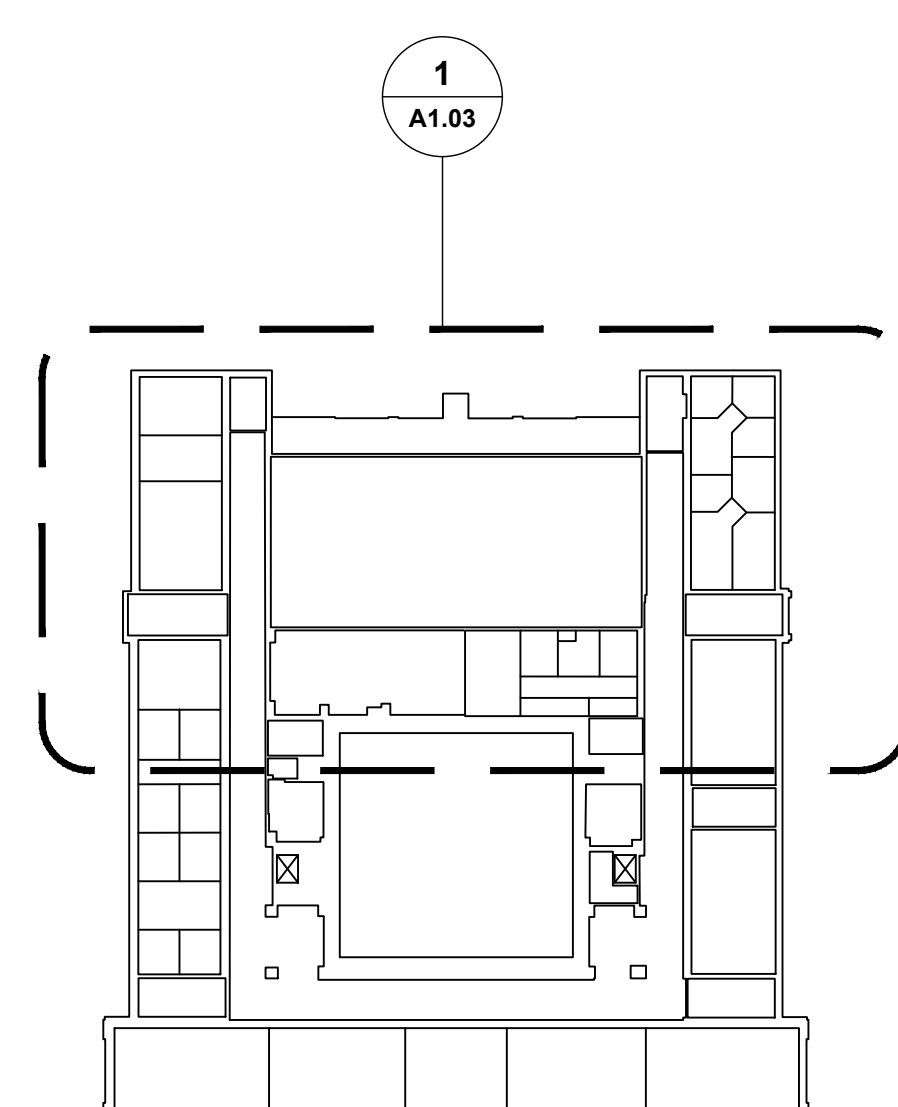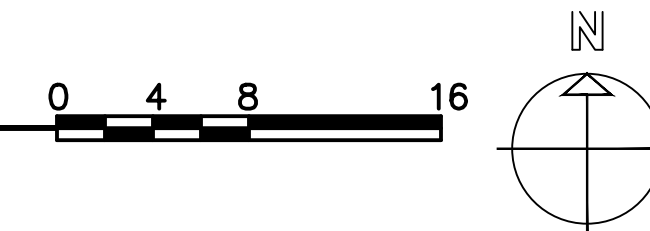


KEY PLAN

CEILING LEGEND

| | |
|--|--------------------------------|
| | 2 x 2 SUSPENDED CEILING |
| | GYPSUM BOARD CEILING, PAINTED |
| | SUPPLY DIFFUSER |
| | RETURN DIFFUSER |
| | RECESSED FLUORESCENT LUMINAIRE |

REFLECTED CEILING NOTES


- COORDINATE WITH MECHANICAL AND ELECTRICAL DRAWINGS FOR LOCATIONS AND FIXTURE DESCRIPTIONS OF LIGHTING, SUPPLY/RETURN DIFFUSERS, AND RADIANT CEILING HEATING PANELS.
- REFER TO MECHANICAL PLANS FOR DUCT PENETRATIONS AT CORRIDOR WALLS. COORDINATE SIZE OF OPENINGS TO ACCOMMODATE FIRE DAMPERS SHOWN ON DETAIL 5/M3.01.
- INFILL MASONRY WALL WHERE EXISTING DUCTS REMOVED. SEE MASONRY INFILL DETAIL.

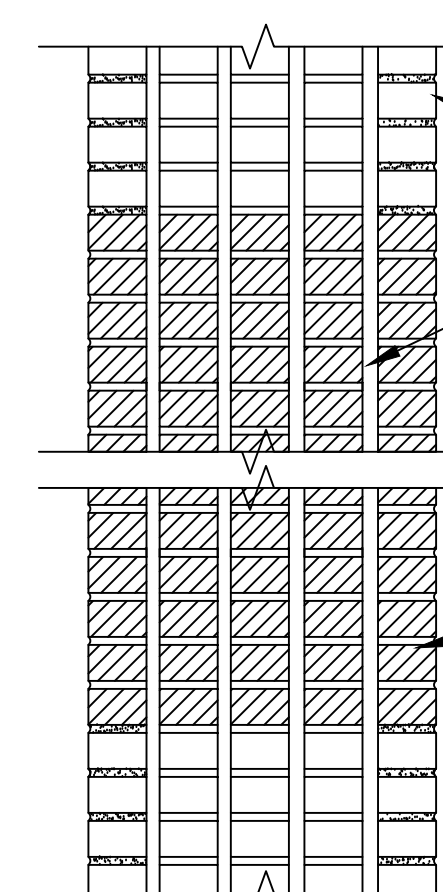


2 MASONRY INFILL DETAIL



| | | | | | |
|---|---------|-------------------------------|--|-------------------|-----------------------------|
| drawing title THIRD FLOOR - NORTH REFLECTED CEILING PLAN | | | STATE OF CONNECTICUT DEPARTMENT OF ADMINISTRATIVE SERVICES | | |
| REVISIONS | | | drawing prepared by AMES & WHITAKER ARCHITECTS 31 LIBERTY STREET SOUTHINGTON, CT | | |
| mark | date | description | date | scale | AS NOTED |
| | 8/4/17 | SCHEMATIC DESIGN SUBMISSION | 07/25/18 | | |
| | 1/15/18 | DESIGN DEVELOPMENT SUBMISSION | | | |
| | 4/16/18 | CONSTRUCTION DOCUMENTS | | | |
| | 5/23/18 | | | | |
| | 7/25/18 | | | | |
| project WESTERN CT STATE UNIVERSITY WHITE HALL 2ND AND 3RD FLOOR RENOVATIONS DANBURY, CONNECTICUT | | | drawn by SP/CA | approved by AL | drawing no. A1.07 |
| CAD no. | | | project no. BI-RD-299 | | |

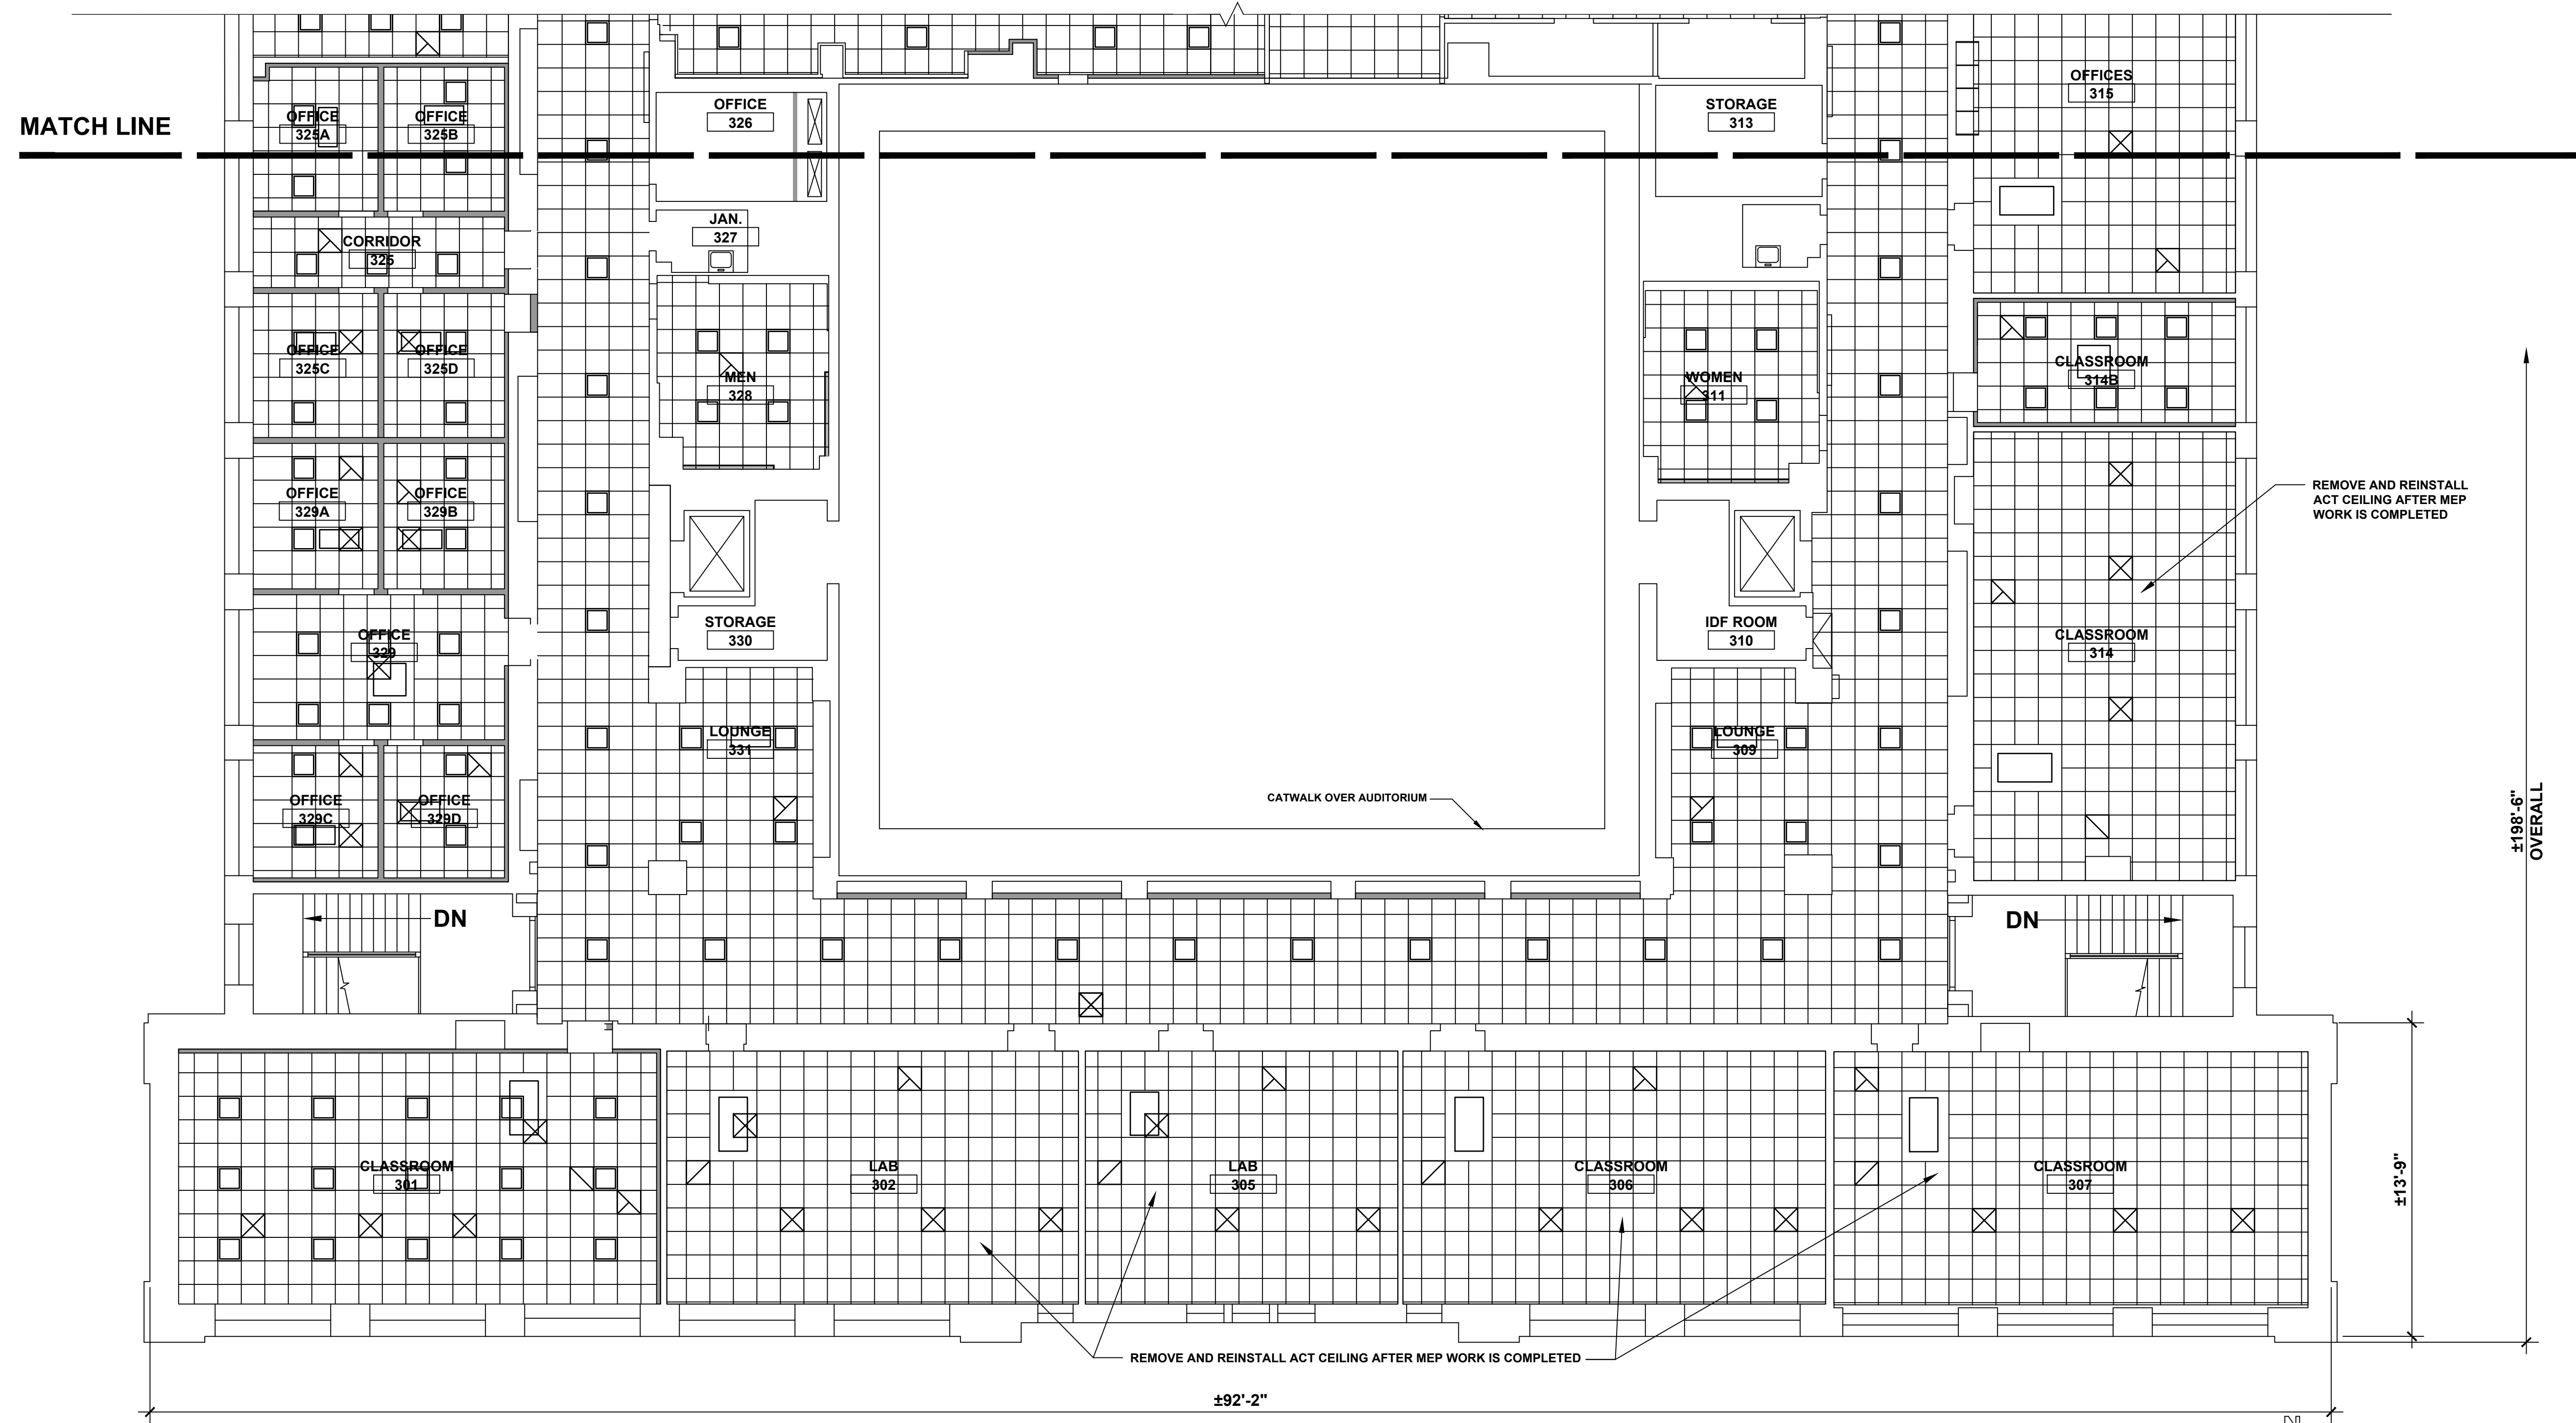


1 THIRD FLOOR - SOUTH PARTIAL PLAN

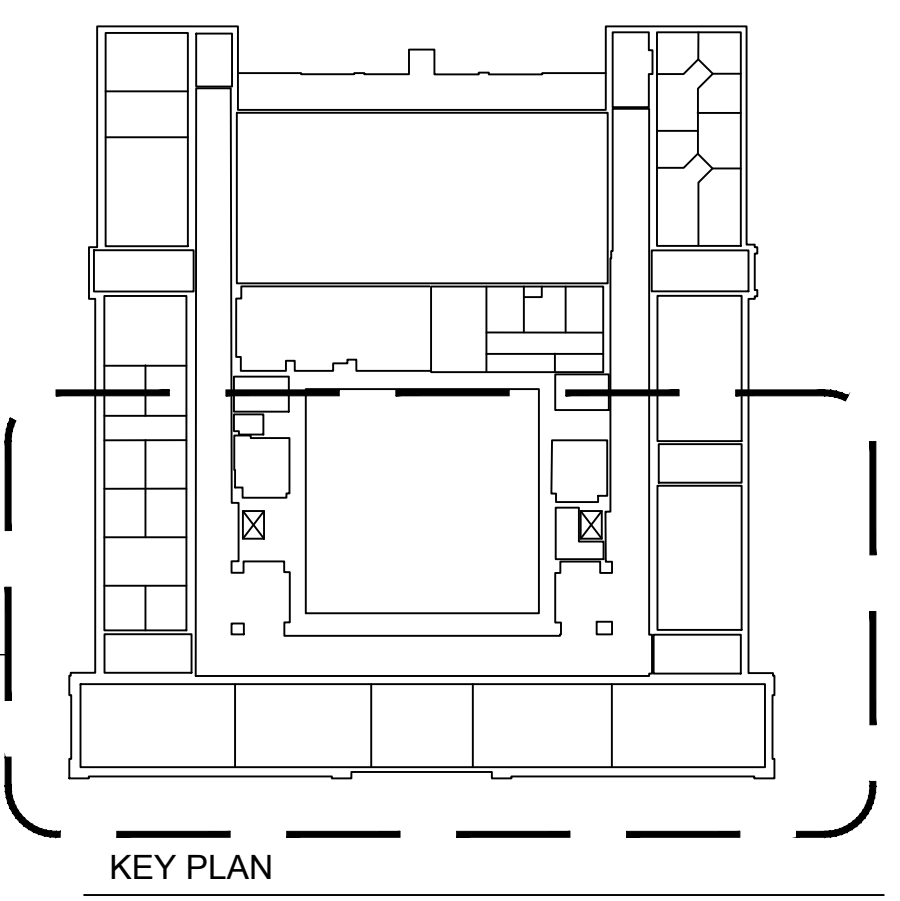


CEILING LEGEND

| | |
|--|--------------------------------|
| | 2 x 2 SUSPENDED CEILING |
| | GYPSUM BOARD CEILING, PAINTED |
| | SUPPLY DIFFUSER |
| | RETURN DIFFUSER |
| | RECESSED FLUORESCENT LUMINAIRE |




- REFLECTED CEILING NOTES**
- COORDINATE WITH MECHANICAL AND ELECTRICAL DRAWINGS FOR LOCATIONS AND FIXTURE DESCRIPTIONS OF LIGHTING, SUPPLY/RETURN DIFFUSERS, AND RADIANT CEILING HEATING PANELS.
 - REFER TO MECHANICAL PLANS FOR DUCT PENETRATIONS AT CORRIDOR WALLS. COORDINATE SIZE OF OPENINGS TO ACCOMMODATE FIRE DAMPERS SHOWN ON DETAIL 5/M3.01.
 - INFILL MASONRY WALL WHERE EXISTING DUCTS REMOVED. SEE MASONRY INFILL DETAIL.

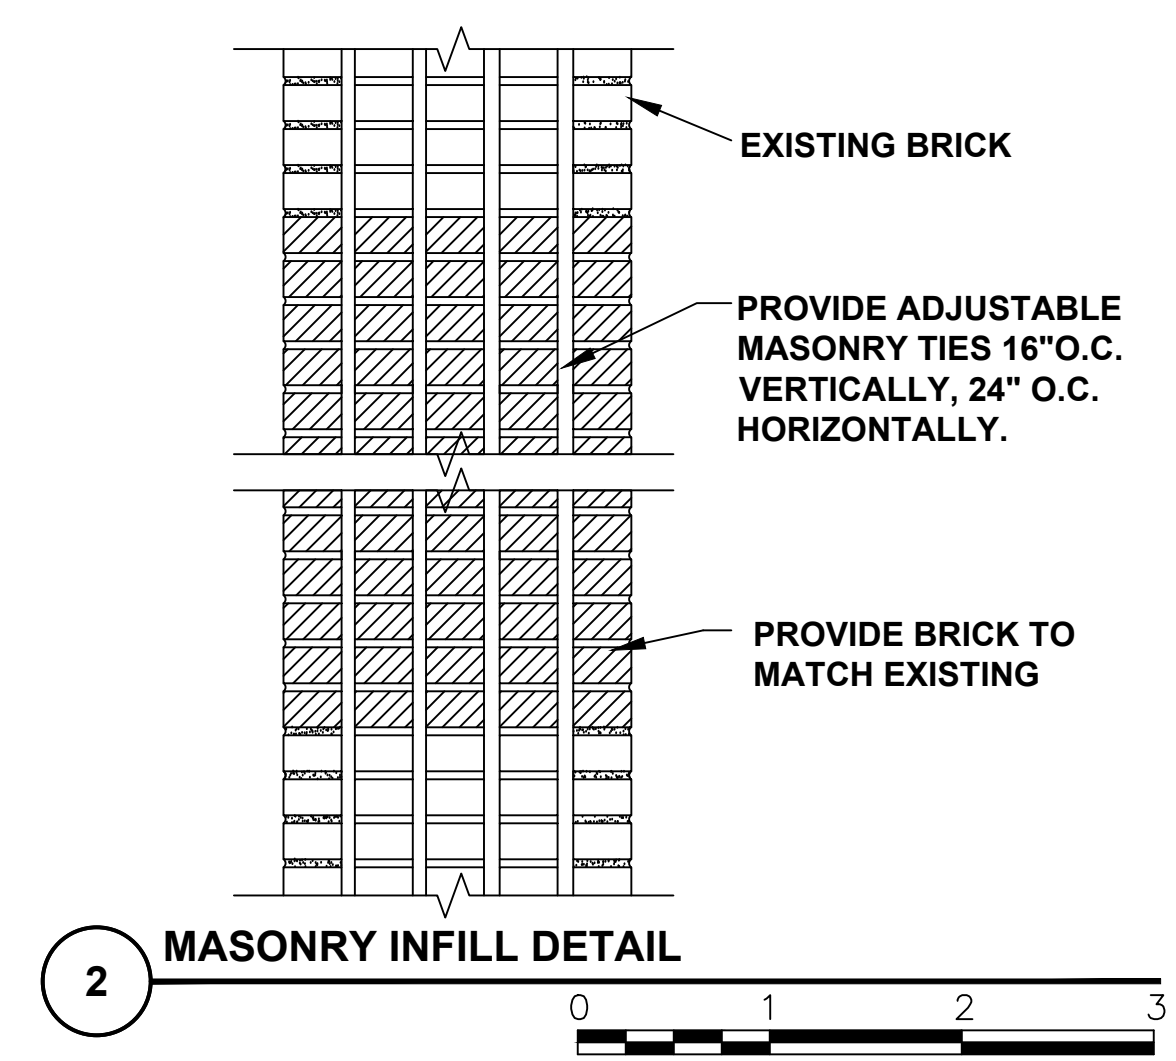

| | | | |
|--|---------|---|---|
| drawing title THIRD FLOOR - SOUTH REFLECTED CEILING PLAN | | STATE OF CONNECTICUT DEPARTMENT OF ADMINISTRATIVE SERVICES | |
| REVISIONS | | | |
| mark | date | description | date |
| | 8/4/17 | SCHEMATIC DESIGN SUBMISSION | 07/25/18 |
| | 1/15/18 | DESIGN DEVELOPMENT SUBMISSION | scale AS NOTED |
| | 4/16/18 | CONSTRUCTION DOCUMENTS | |
| | 5/23/18 | | |
| | 7/25/18 | | |
| drawing prepared by AMES & WHITAKER ARCHITECTS 31 LIBERTY STREET SOUTHINGTON, CT | | project WESTERN CT STATE UNIVERSITY WHITE HALL 2ND AND 3RD FLOOR RENOVATIONS DANBURY, CONNECTICUT | date 07/25/18 scale AS NOTED |
| CAD no. | | project no. BI-RD-299 | drawn by SP/CA approved by AL drawing no. A1.08 |

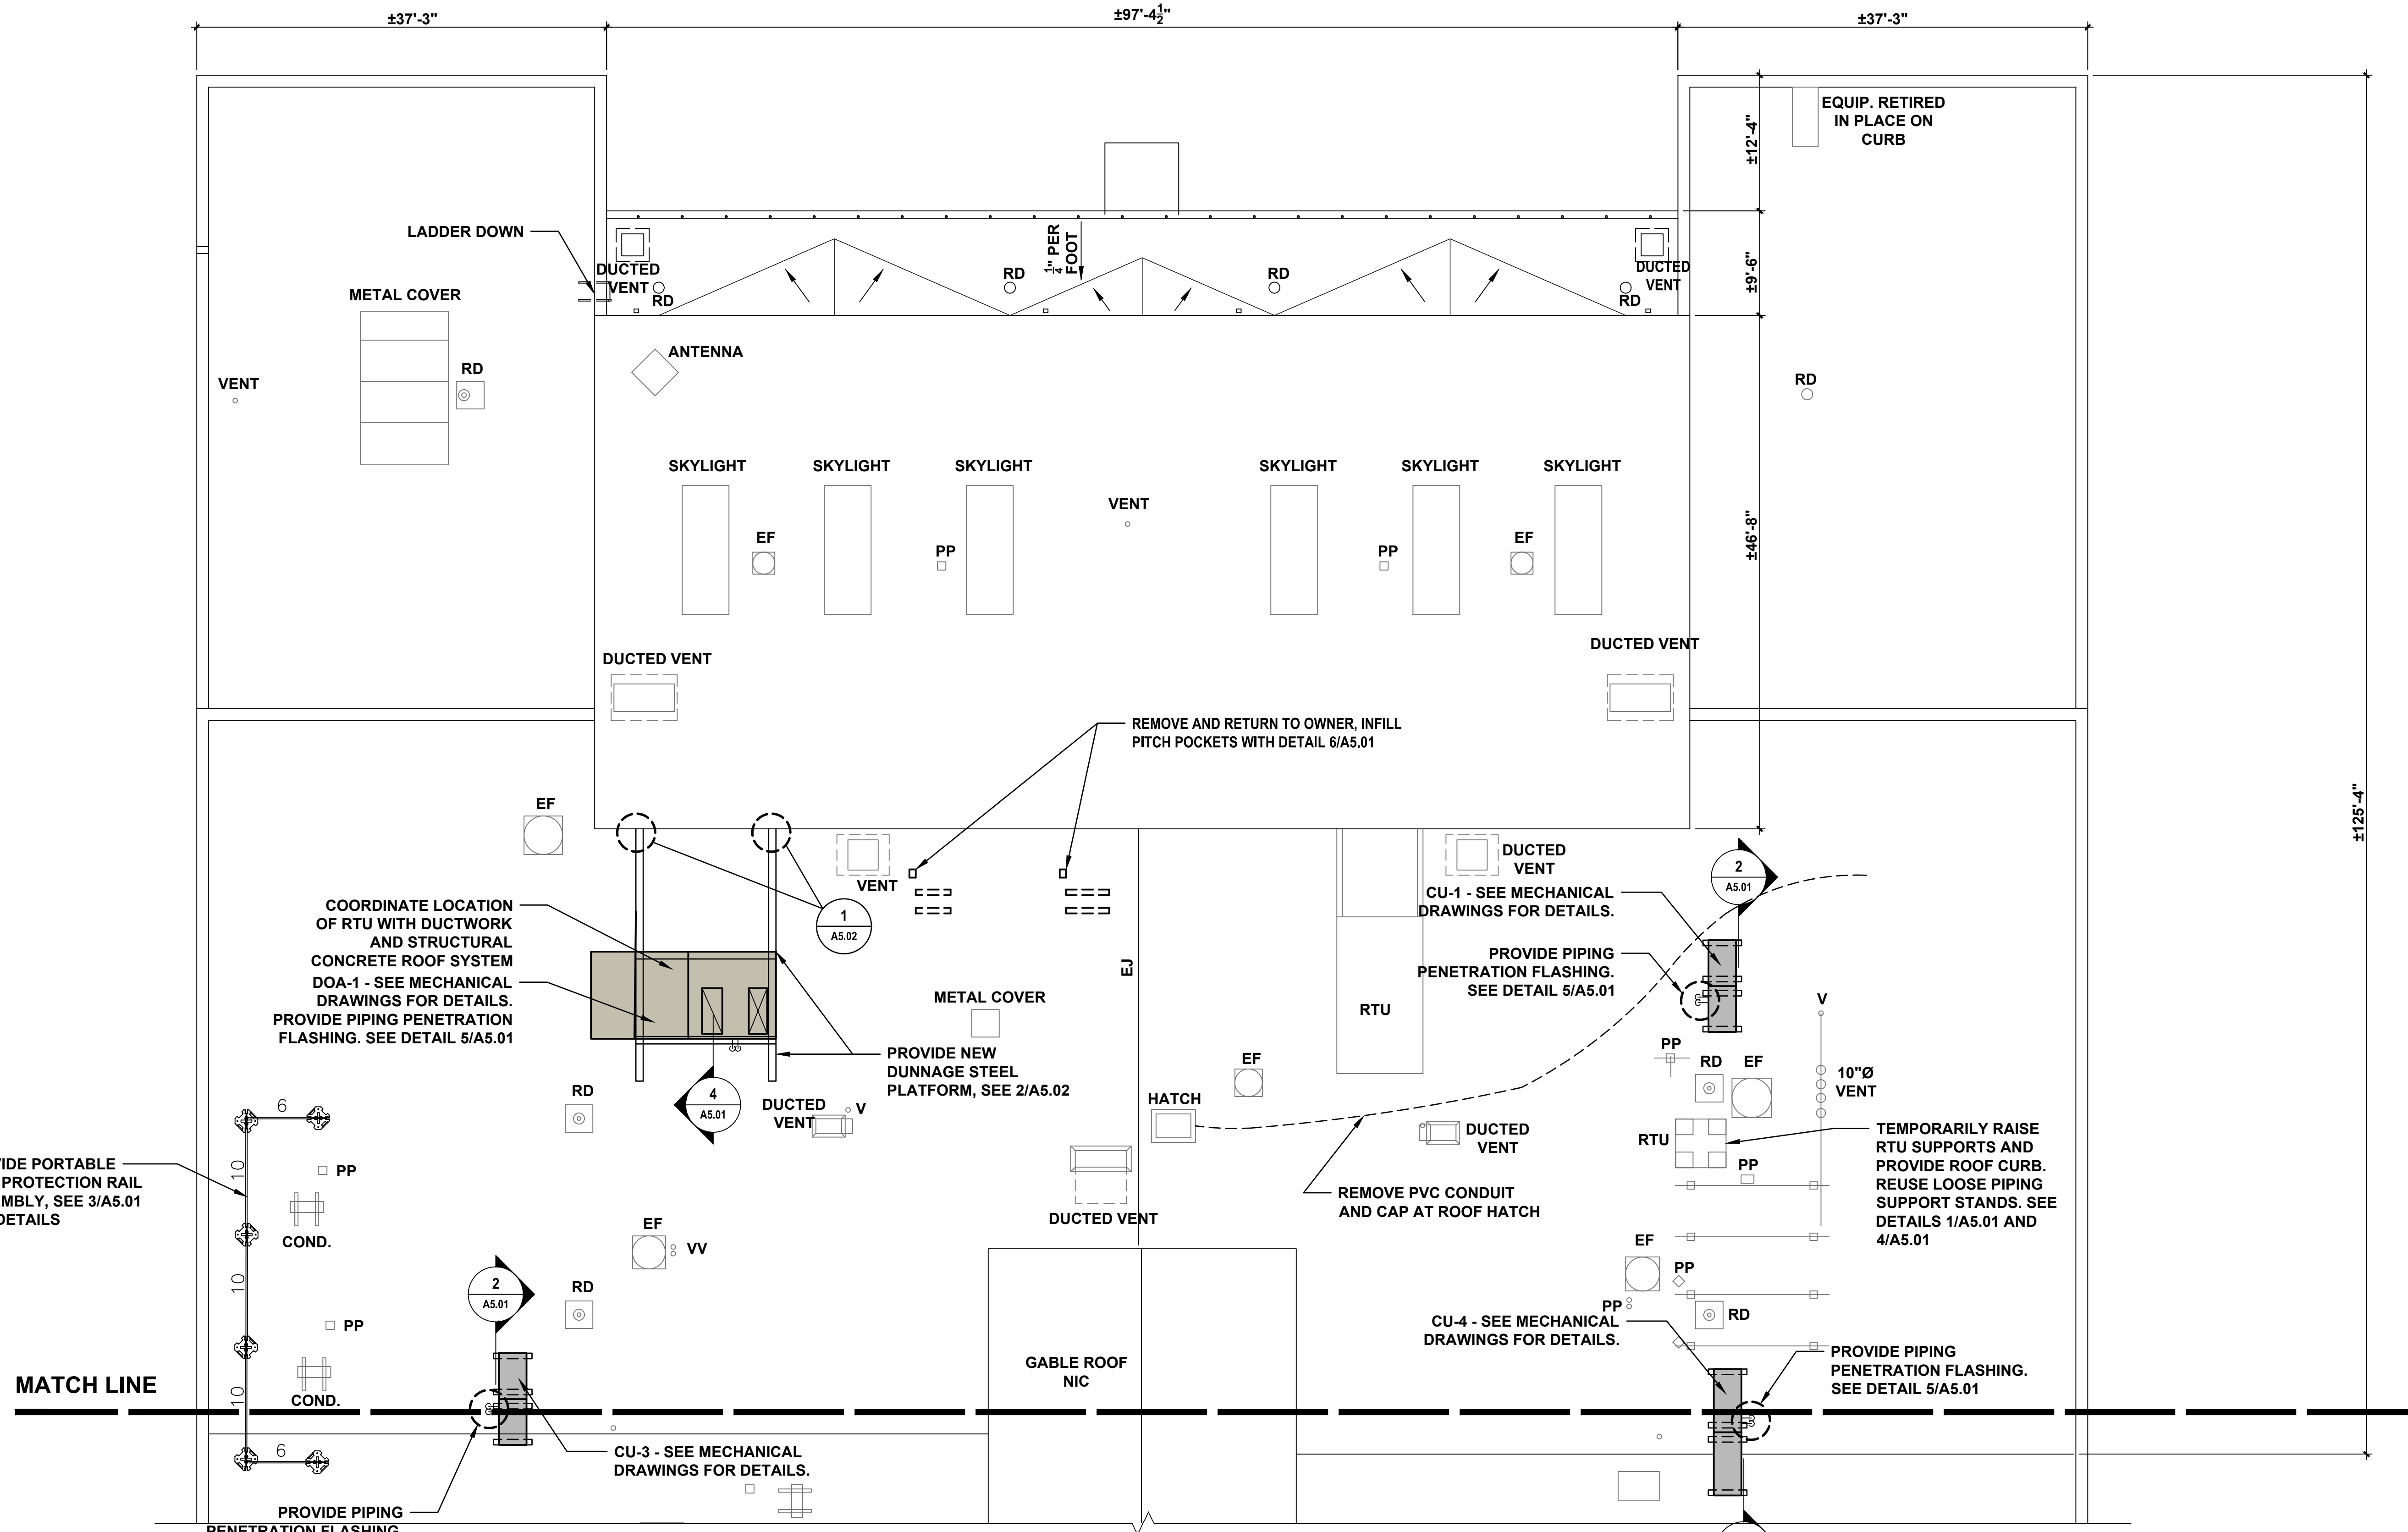


1 ROOF PLAN NORTH

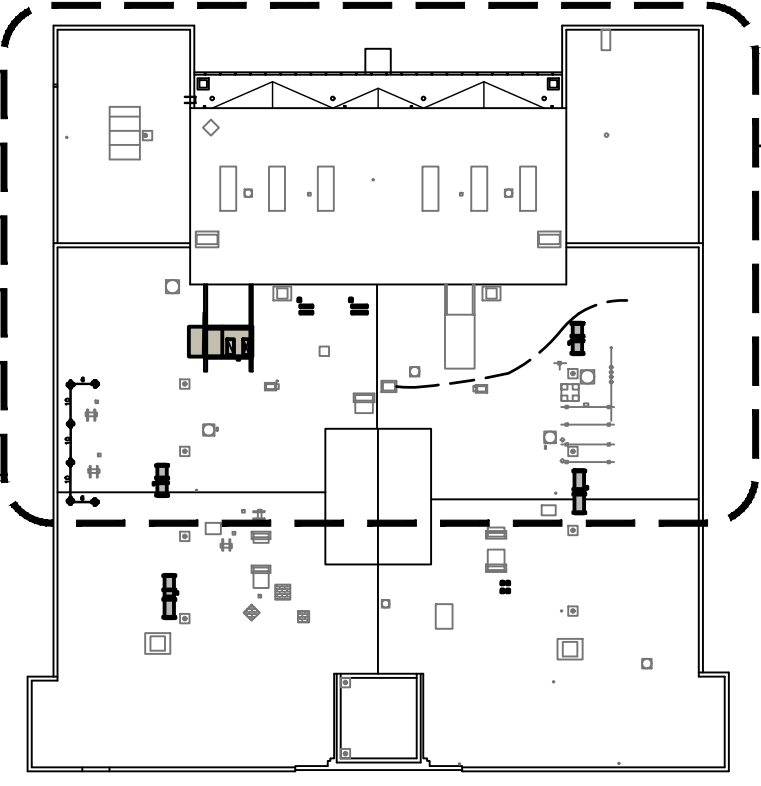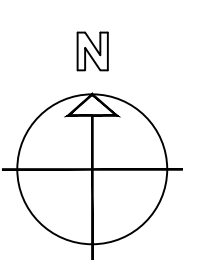
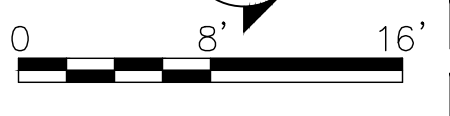


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| drawing title ROOF - NORTH PARTIAL PLAN | | | STATE OF CONNECTICUT DEPARTMENT OF ADMINISTRATIVE SERVICES | | | |
| REVISIONS | | | | | | |
| mark | date | description | drawing prepared by | date | scale | |
| | 8/4/17 | SCHEMATIC DESIGN SUBMISSION | AMES & WHITAKER ARCHITECTS 31 LIBERTY STREET SOUTHINGTON, CT | 07/25/18 | AS NOTED | |
| | 1/15/18 | DESIGN DEVELOPMENT SUBMISSION | | project | | |
| | 4/16/18 5/23/18 7/25/18 | CONSTRUCTION DOCUMENTS | | WESTERN CT STATE UNIVERSITY WHITE HALL 2ND AND 3RD FLOOR RENOVATIONS DANBURY, CONNECTICUT | drawn by SP/CA approved by AL | drawing no. A1.09 |
| CAD no. | | | project no. BI-RD-299 | | | |

| FALL PROTECTION LEGEND | |
|------------------------|--|
| | 6 PORTABLE FALL PROTECTION: BASE PLATE |
| | 3 PORTABLE FALL PROTECTION: 42" HIGH x 10'-0" RAIL |
| | 2 PORTABLE FALL PROTECTION: 42" HIGH x 6'-0" RAIL |

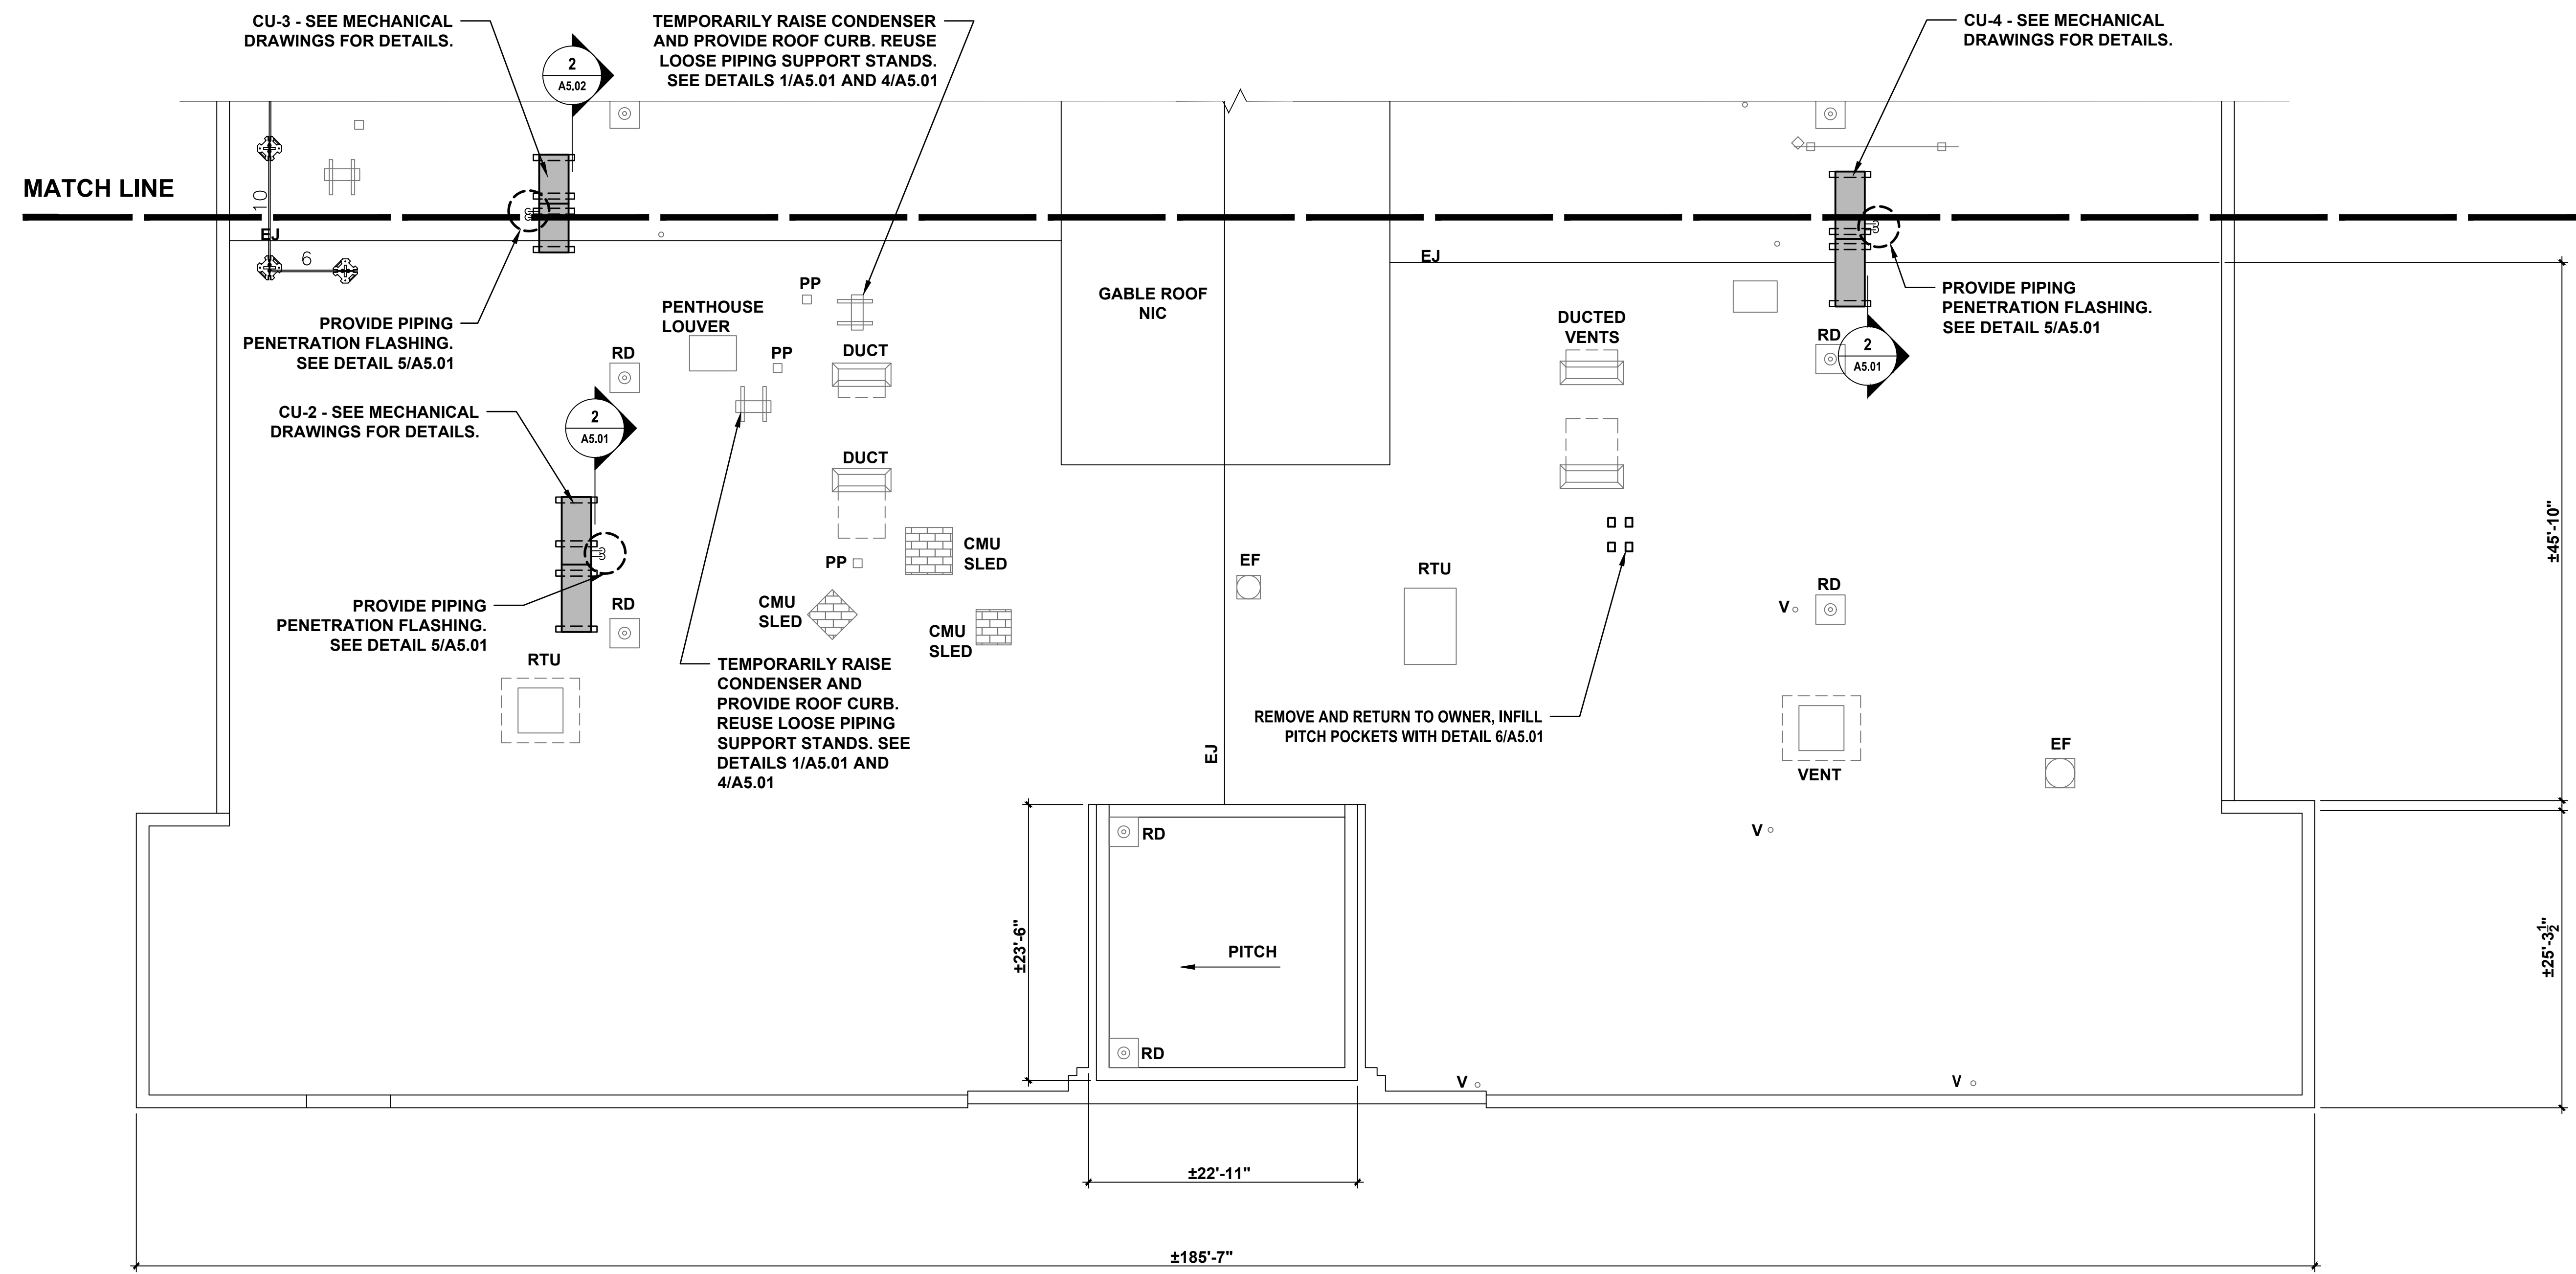

1 ROOF PLAN SOUTH

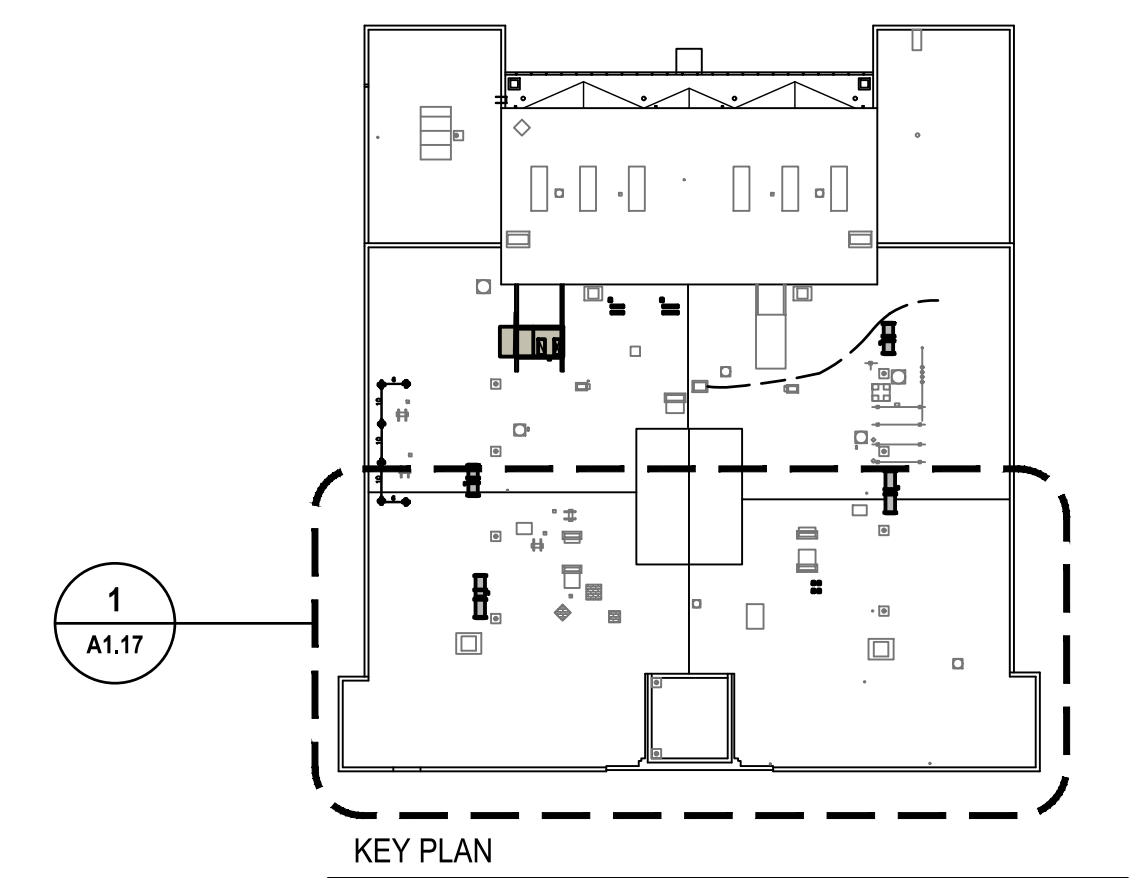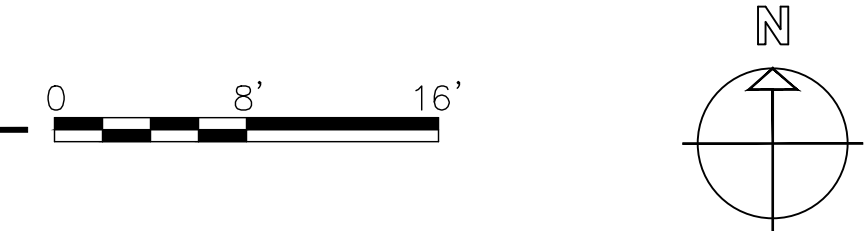


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| drawing title ROOF - SOUTH PARTIAL PLAN | | | STATE OF CONNECTICUT DEPARTMENT OF ADMINISTRATIVE SERVICES | |
| REVISIONS | | | | |
| mark | date | description | drawing prepared by AMES & WHITAKER ARCHITECTS 31 LIBERTY STREET SOUTHINGTON, CT | date 07/25/18 scale AS NOTED |
| | 8/4/17 | SCHEMATIC DESIGN SUBMISSION | project WESTERN CT STATE UNIVERSITY WHITE HALL 2ND AND 3RD FLOOR RENOVATIONS DANBURY, CONNECTICUT | drawn by SP/CA |
| | 1/15/18 | DESIGN DEVELOPMENT SUBMISSION | | approved by AL |
| | 4/16/18 | CONSTRUCTION DOCUMENTS | | drawing no. A1.10 |
| | 5/23/18 7/25/18 | | | |
| CAD no. | | | project no. BI-RD-299 | |

DOA-1 - SEE MECHANICAL DRAWINGS FOR DETAILS. PROVIDE PIPING PENETRATION FLASHING. SEE DETAIL 5/A5.01.



COORDINATE THE LOCATION OF RTU WITH DUCTWORK AND STRUCTURAL CONCRETE ROOF SYSTEM

PROVIDE NEW DUNNAGE STEEL PLATFORM, SEE 2/A5.02


1
A5.02

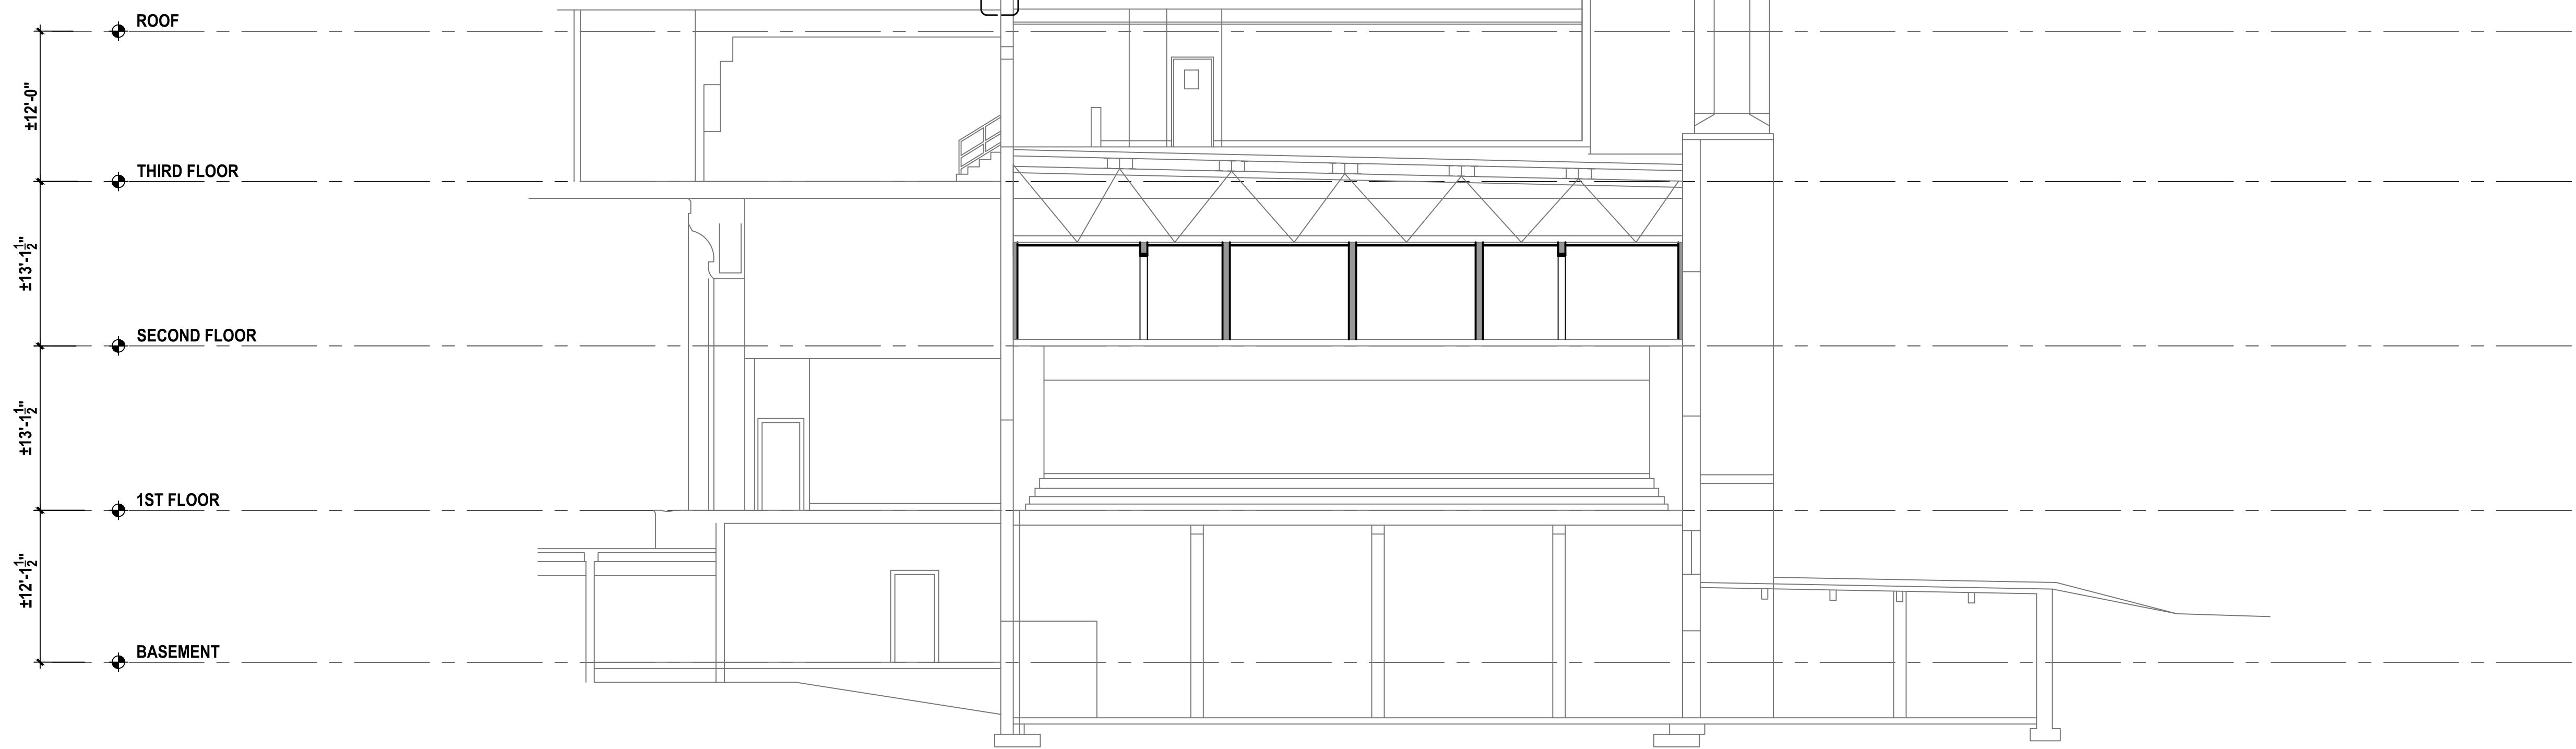


1 BUILDING SECTION

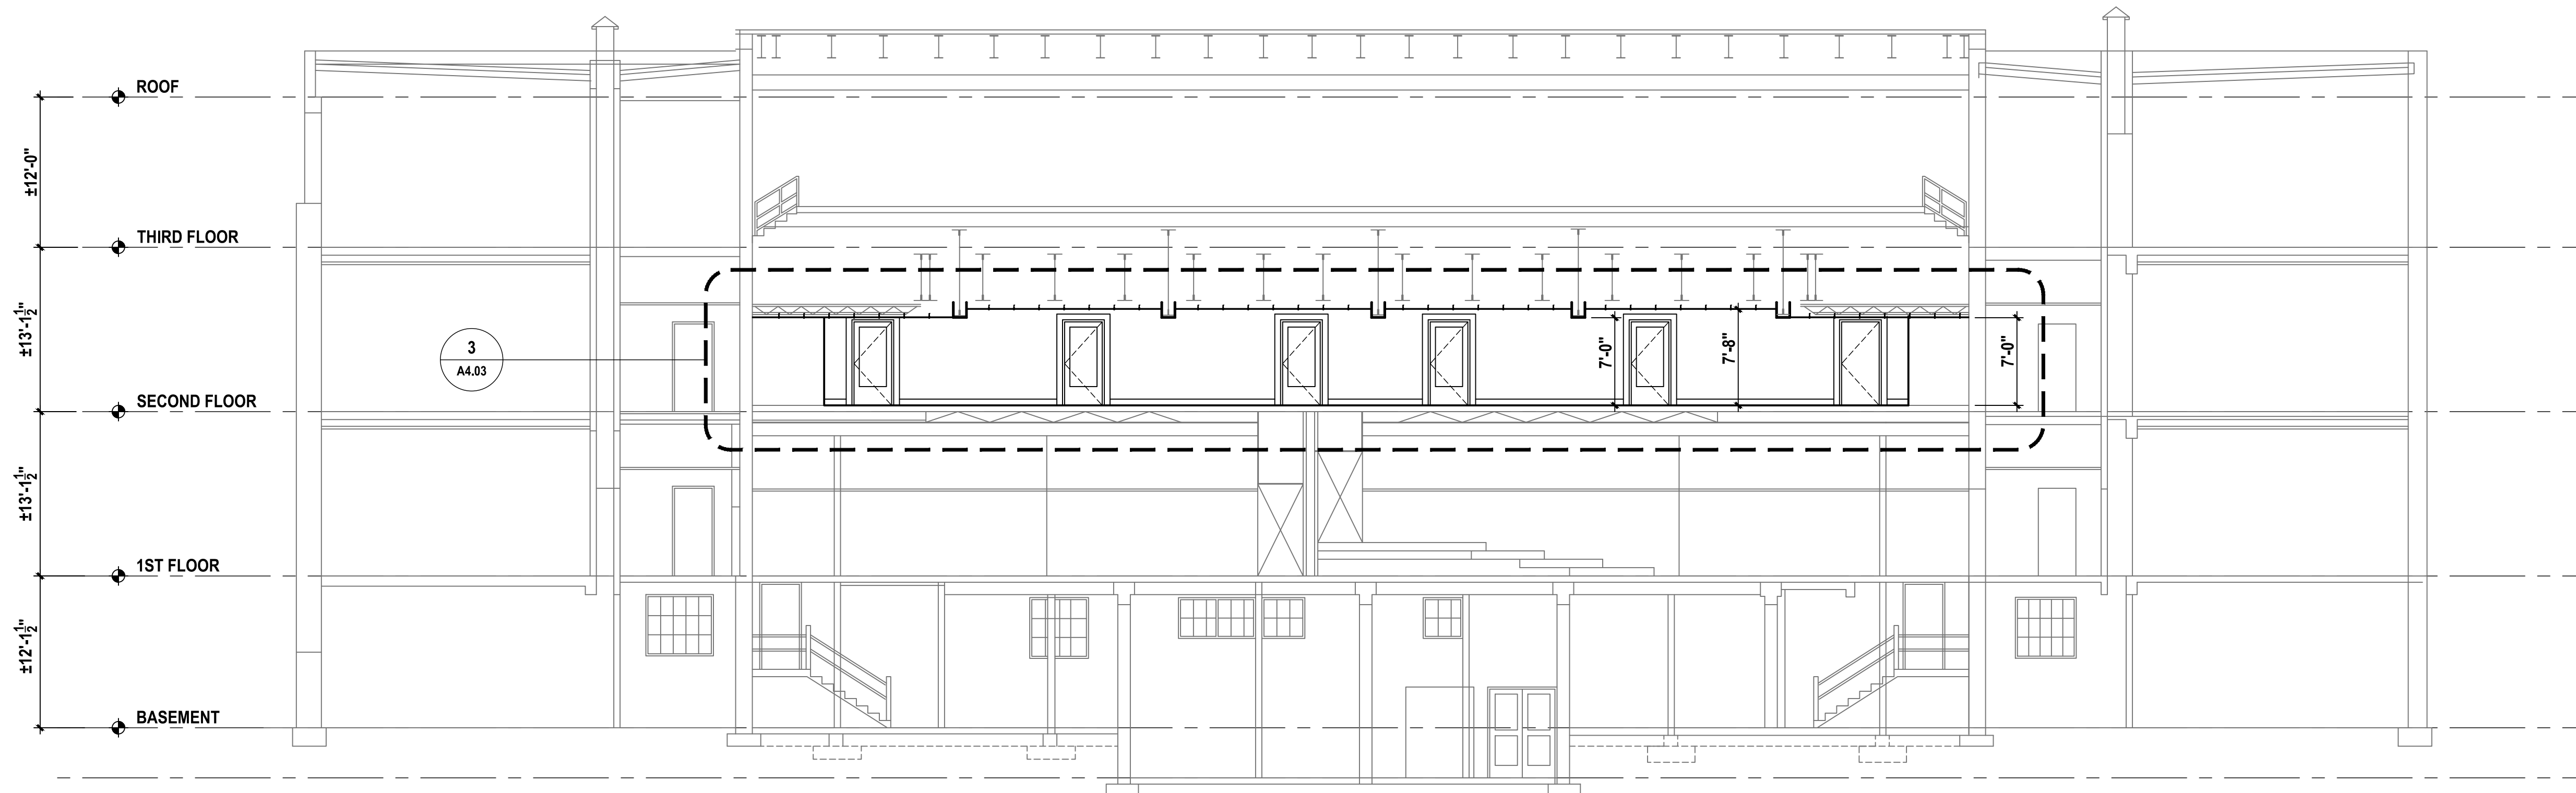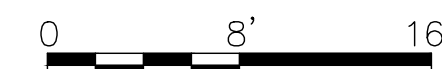



2 BUILDING SECTION

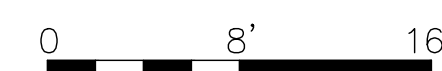



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| drawing title BUILDING SECTIONS | | | STATE OF CONNECTICUT DEPARTMENT OF ADMINISTRATIVE SERVICES | | |
| REVISIONS | | | drawing prepared by AMES & WHITAKER ARCHITECTS 31 LIBERTY STREET SOUTHINGTON, CT | | |
| mark | date | description | date | scale | AS NOTED |
| | 8/4/17 | SCHEMATIC DESIGN SUBMISSION | 07/25/18 | | |
| | 1/15/18 | DESIGN DEVELOPMENT SUBMISSION | | | |
| | 4/16/18 | CONSTRUCTION DOCUMENTS | | | |
| | 5/23/18 | | | | |
| | 7/25/18 | | | | |
| project WESTERN CT STATE UNIVERSITY WHITE HALL 2ND AND 3RD FLOOR RENOVATIONS DANBURY, CONNECTICUT | | | drawn by CA/SP | approved by AL | |
| CAD no. | | | project no. BI-RD-299 | drawing no. A3.01 | |

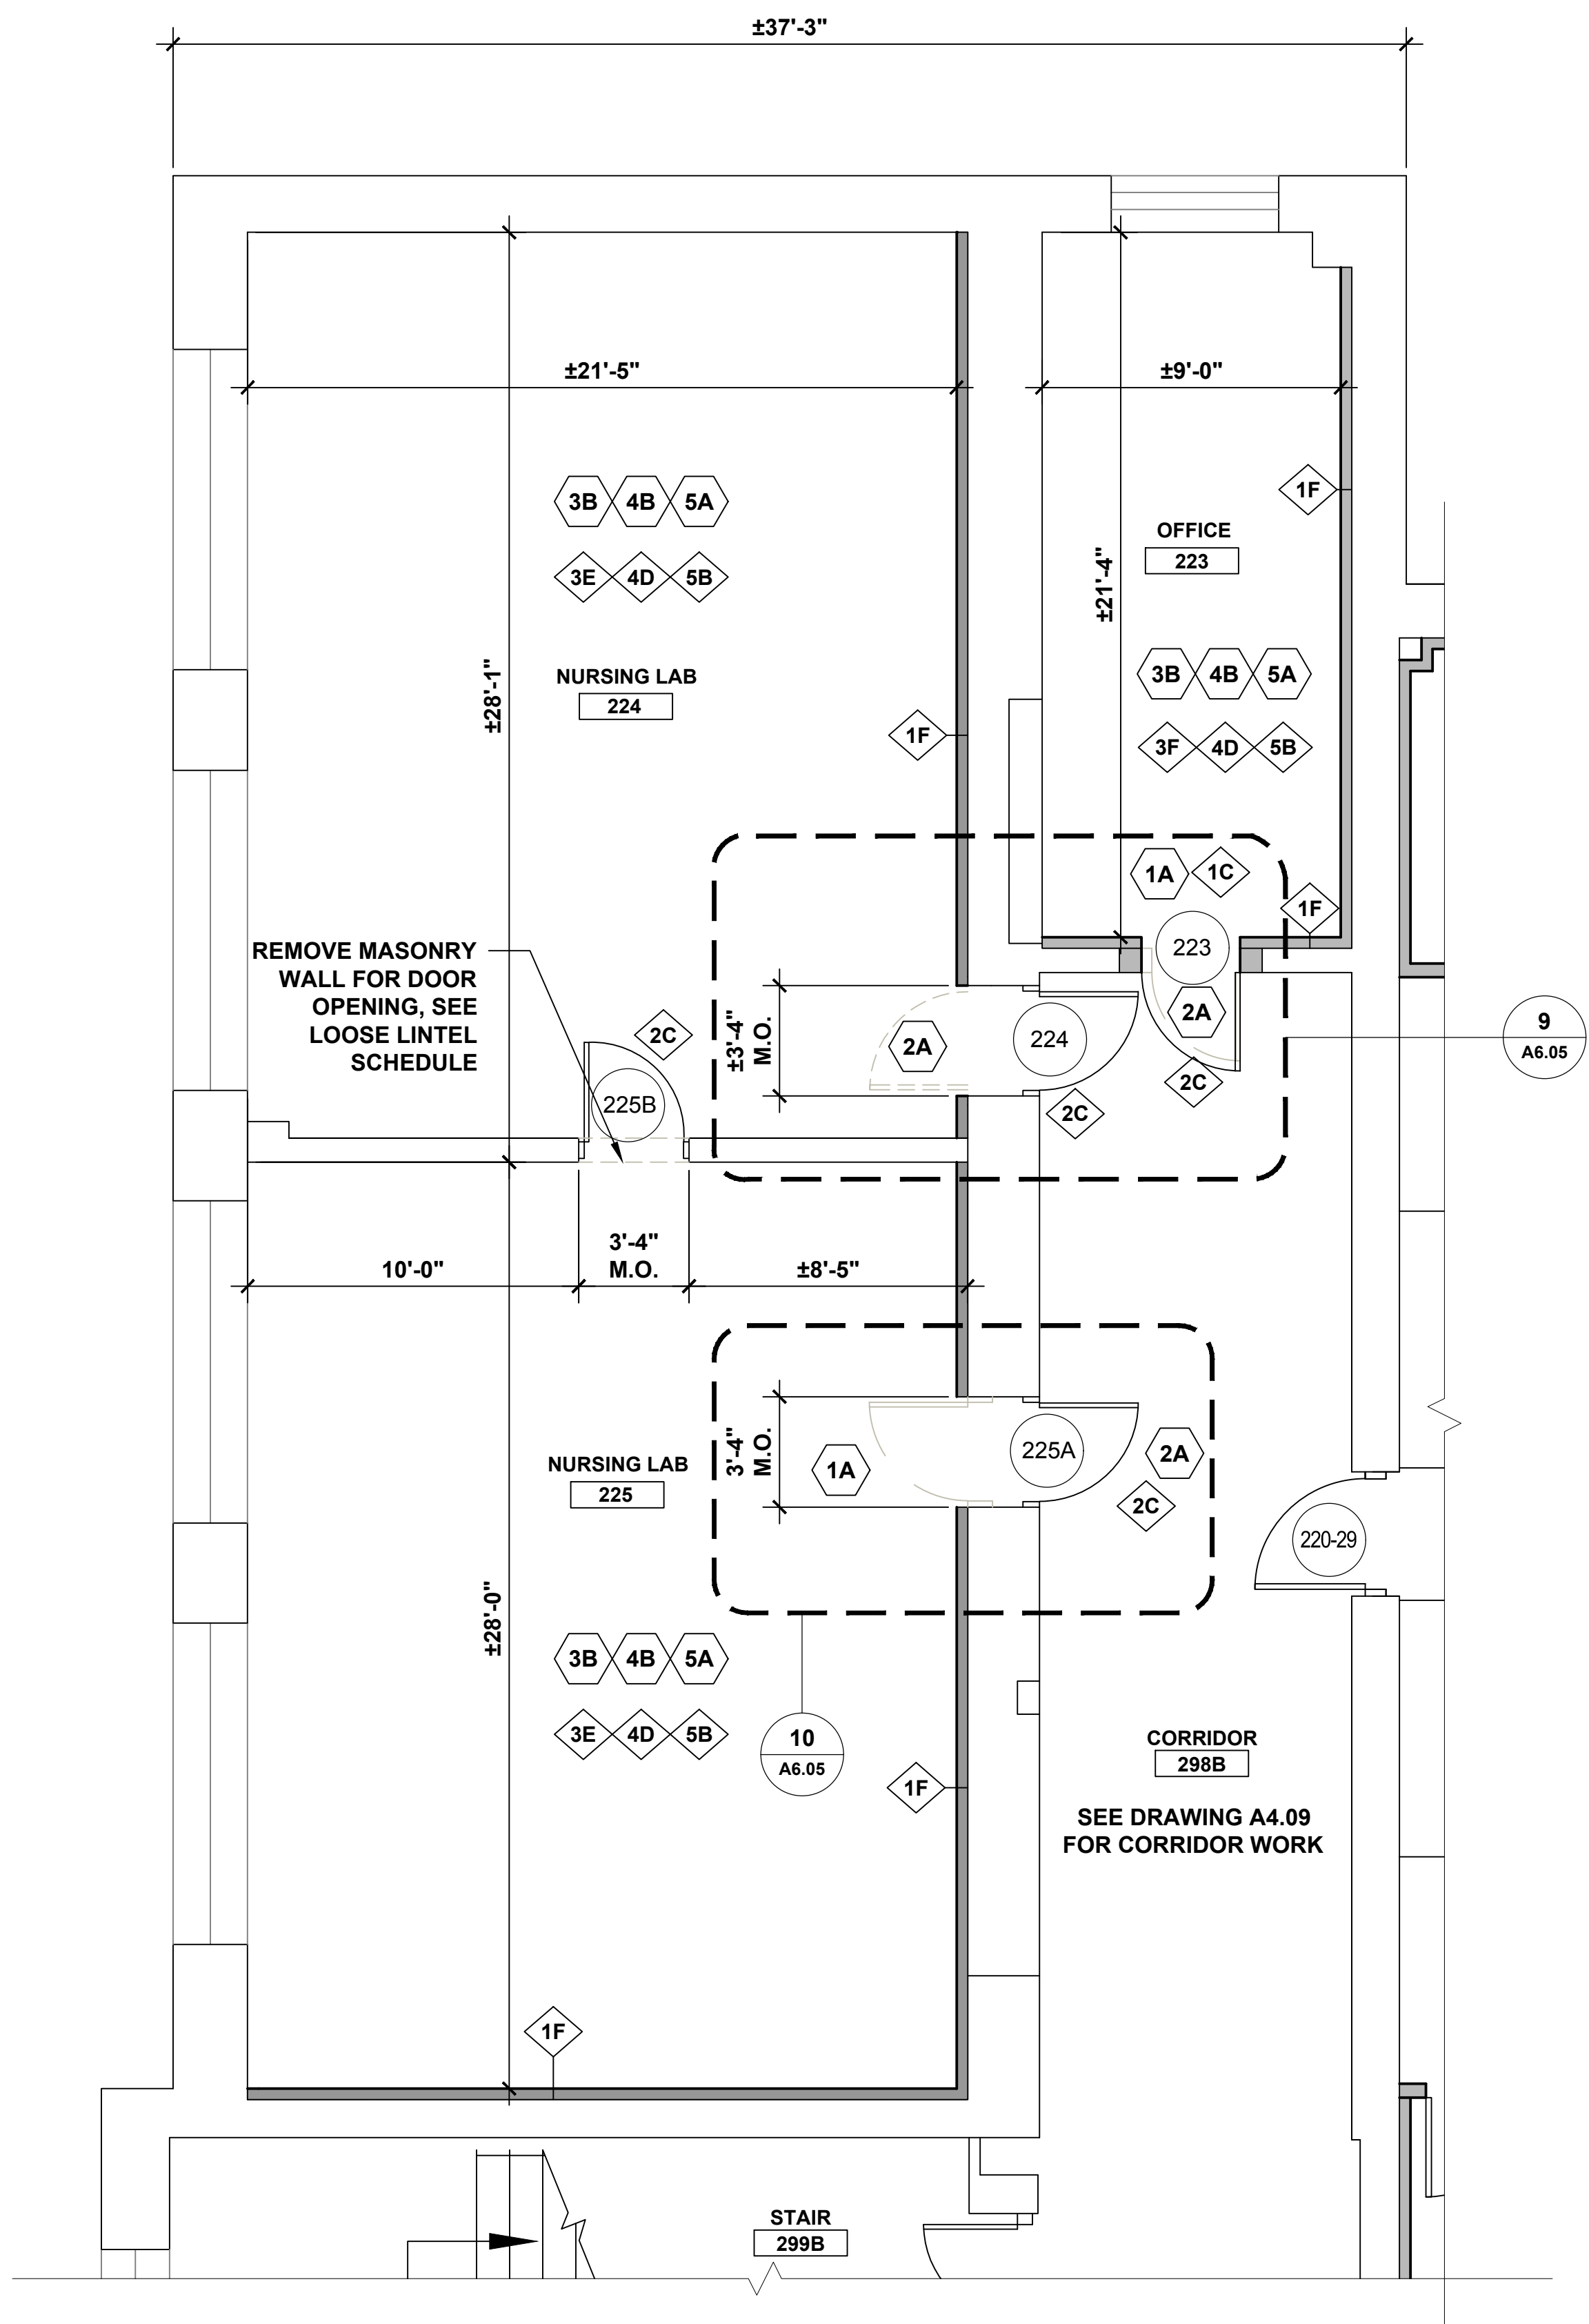

1 NORTHWEST CORNER PARTIAL PLAN

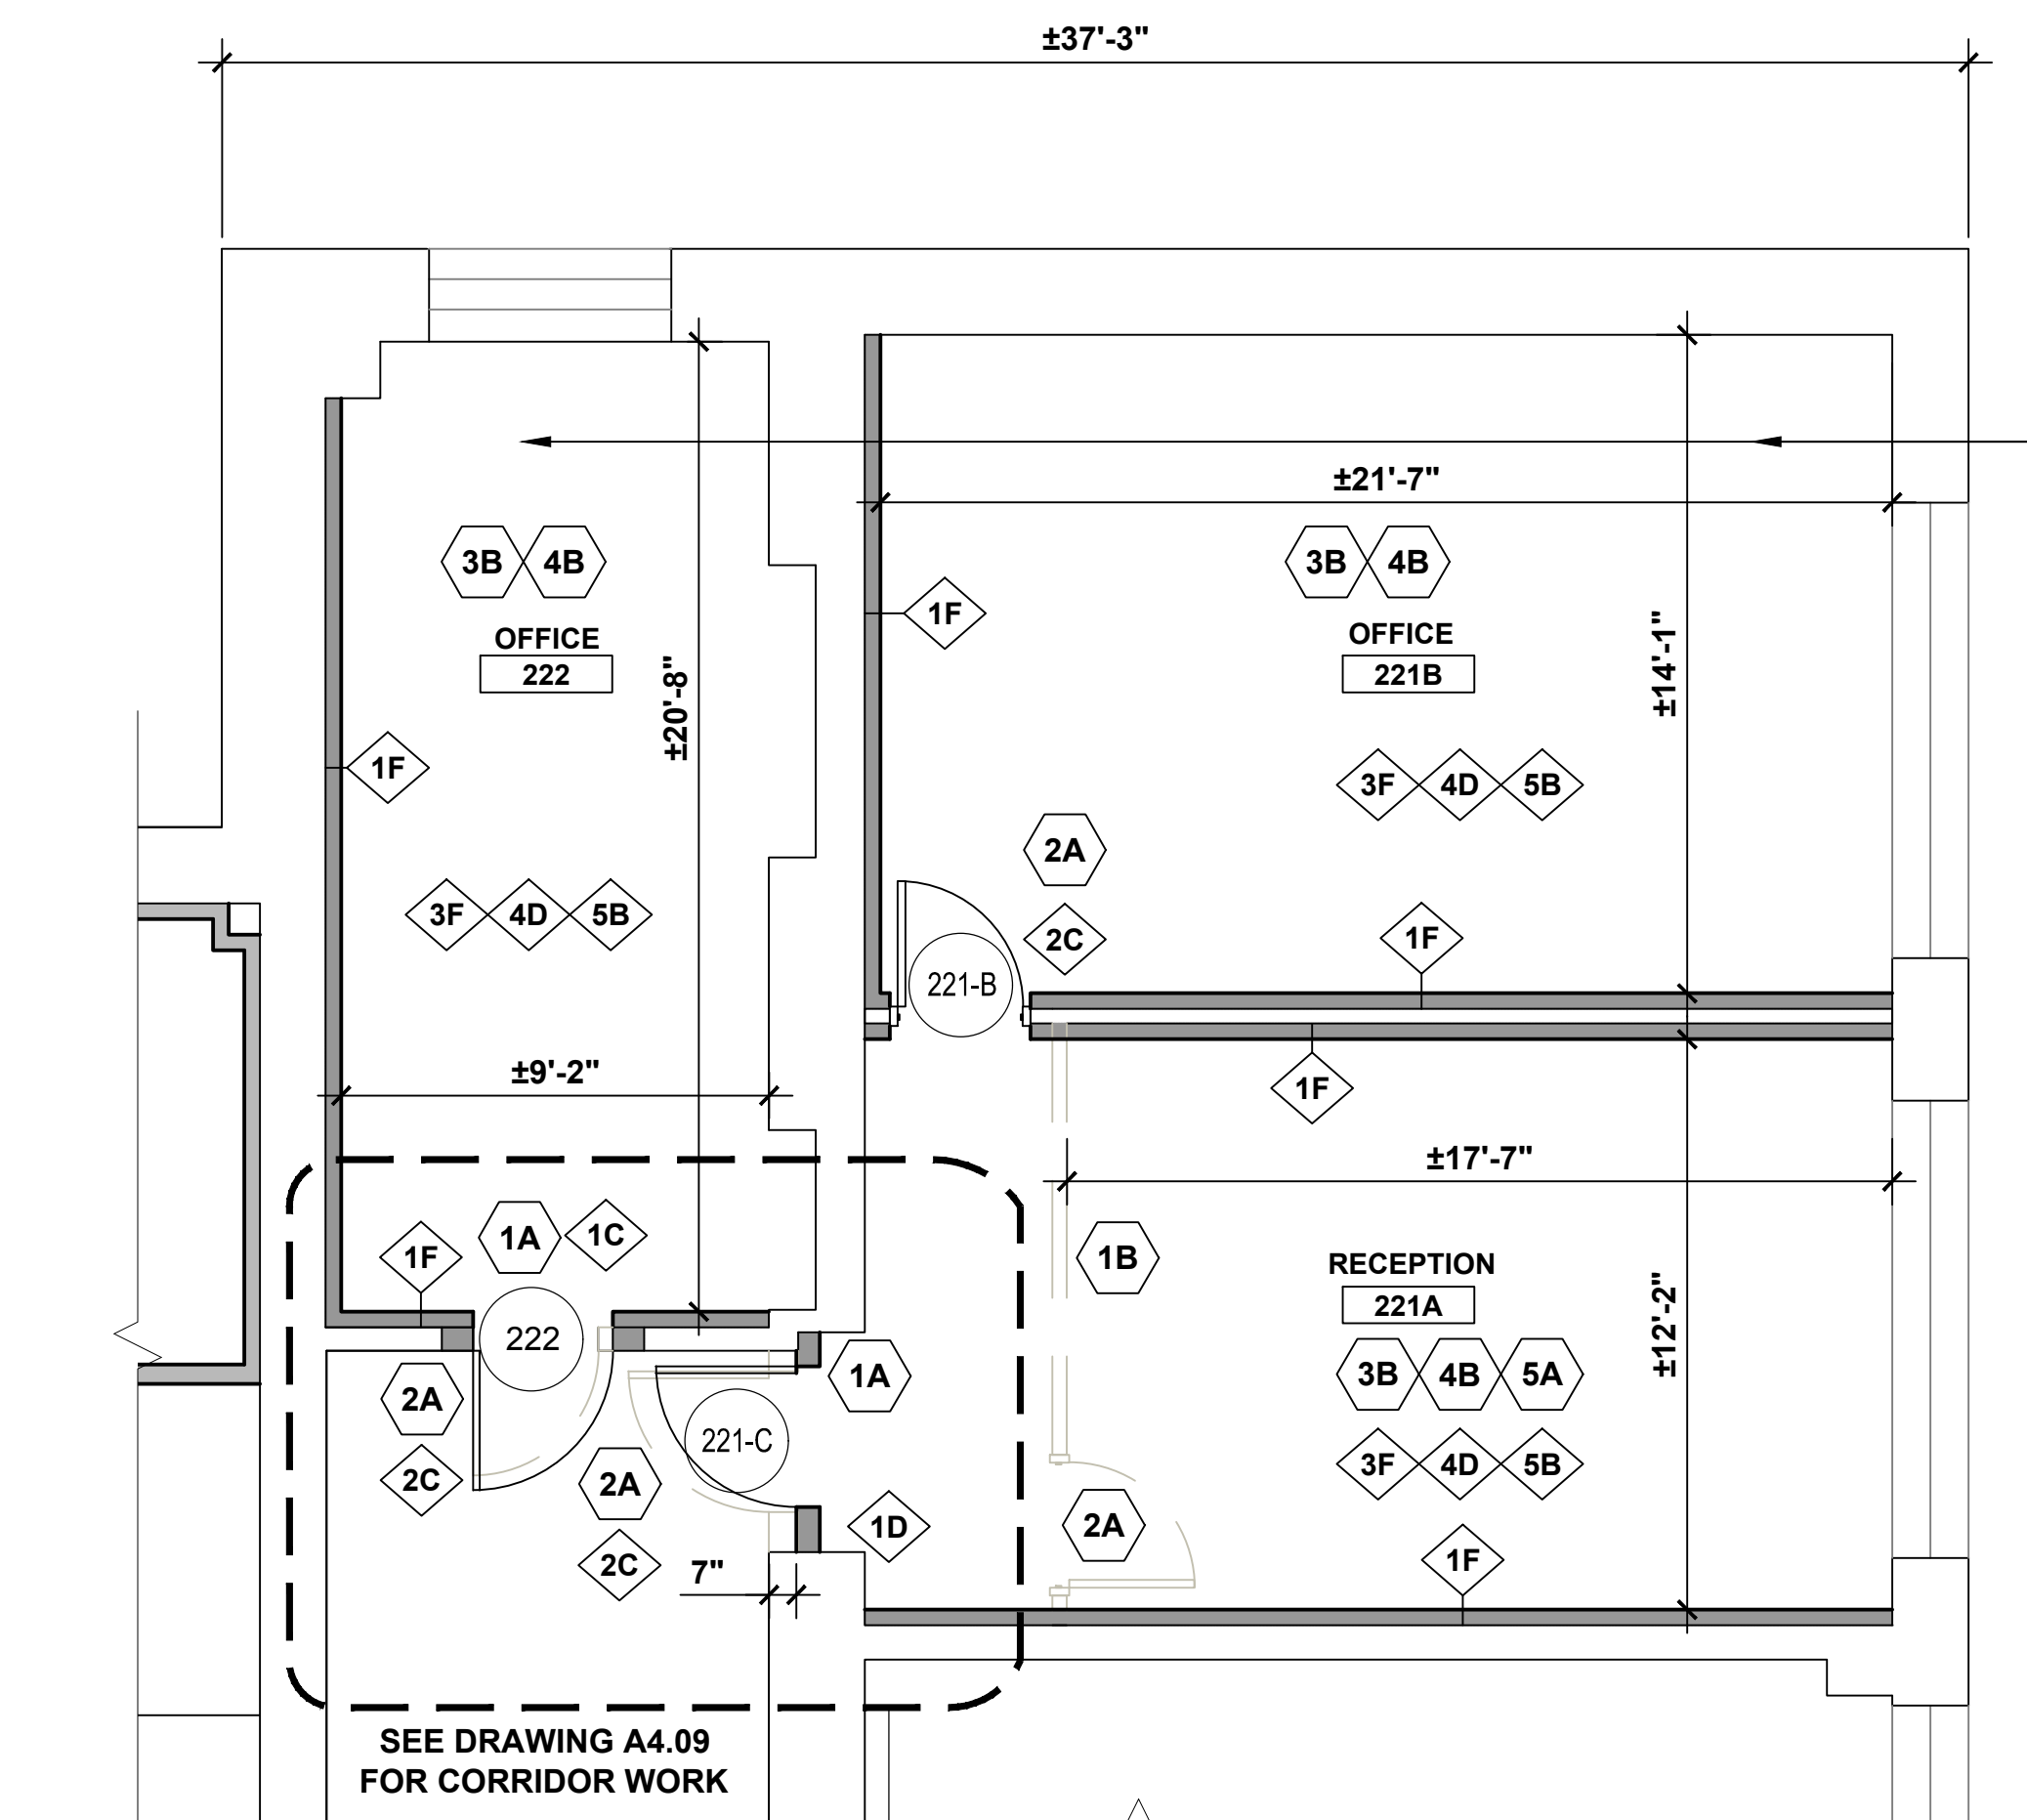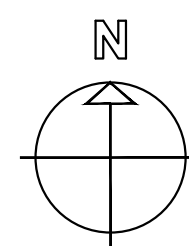


2 NORTHEAST CORNER PARTIAL PLAN

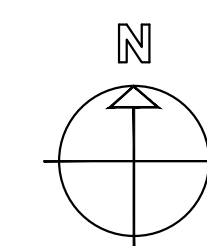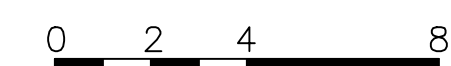

| LOOSE LINTEL SCHEDULE | |
|--|-------------------------|
| LOOSE LINTELS SHALL CONSIST OF ONE ANGLE FOR EACH 4" OF MASONRY AS FOLLOWS | |
| SIZE OF MASONRY OPENING | SIZE OF ANGLE |
| UP TO 4'-0" | 3 1/2" X 3 1/2" X 5/16" |
| UP TO 5'-6" | 5" X 3 1/2" X 5/16" |

NOTE: THE LONG LEGS OF ALL ANGLES ARE TO BE VERTICAL. LINTELS ARE TO BEAR 8" ON MASONRY AT EACH END.

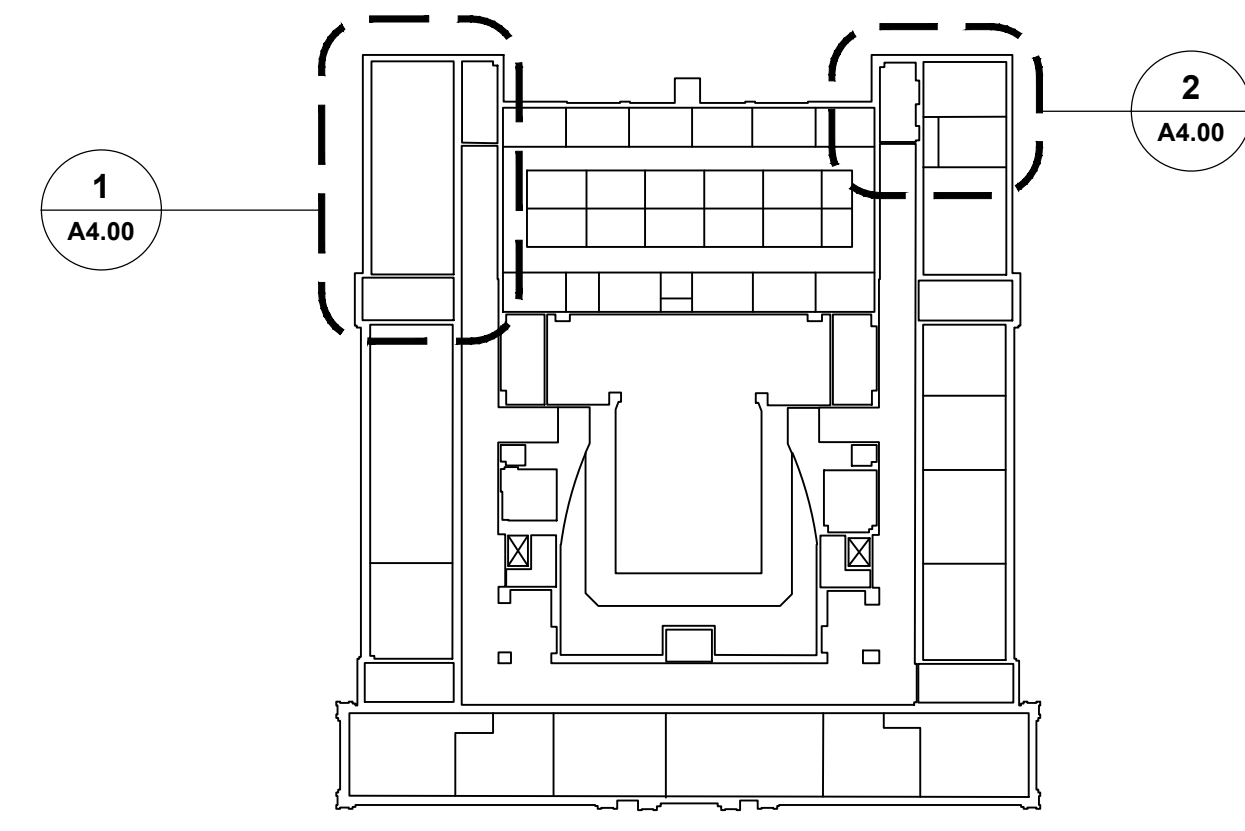


KEY PLAN

- DEMOLITION KEY NOTES**
- 1A REMOVE MASONRY WALL.
 - 1B REMOVE STUD AND GYP BD WALL.
 - 2A REMOVE DOOR AND FRAME.
 - 2B REMOVE DOOR. EXISTING FRAME TO REMAIN.
 - 3A REMOVE C.T. FLOOR.
 - 3B REMOVE VCT FLOOR.
 - 3C REMOVE CARPET.
 - 4A REMOVE C.T. WAINSCOT AND BASE.
 - 4B REMOVE VINYL BASE
 - 5A REMOVE ACT CEILING.
 - 6A REMOVE LAV.
 - 6B REMOVE TOILET & TOILET PARTITION.
 - 6C REMOVE URINAL AND URINAL SCREEN.

- NEW WORK KEY NOTES**
- 1C PROVIDE MASONRY WALL.
 - 1D PROVIDE 1 HOUR RATED WALL, 3/8" METAL STUDS WITH 5/8" TYPE 'X' GYP. BOARD BOTH SIDES
 - 1E PROVIDE 5/8" MOISTURE RESISTANT GYP BD ON EXISTING STUDS.
 - 1F PROVIDE 3 5/8" METAL STUDS WITH 5/8" TYPE 'X' GYP. BOARD ONE SIDE
 - 1G PROVIDE 3/8" METAL STUDS WITH 5/8" TYPE 'X' GYP. BOARD BOTH SIDES
 - 2C PROVIDE WOOD DOOR AND HM FRAME.
 - 2D PROVIDE WOOD DOOR IN EXISTING HM FRAME.
 - 3D PROVIDE CT FLOOR AND CT BASE.
 - 3E PROVIDE VCT AND RESILIENT BASE.
 - 3F PROVIDE CARPET AND RESILIENT BASE.
 - 3G EXISTING FLOORING TO REMAIN. (PROTECT DURING RENOVATION)
 - 4C PROVIDE CT WAINSCOT AND BASE/ PAINT ABOVE
 - 4D PREP AND PAINT WALLS
 - 4E PROVIDE HORIZONTAL WINDOW BLINDS
 - 5B PROVIDE ACT CEILING.
 - 5C REMOVE & REINSTALL ACT CEILING AFTER MEP WORK IS COMPLETED.
 - 5D PROVIDE GYPSUM BOARD CEILING/SOFFIT AND PAINT
 - 5E PAINT EXISTING CEILING
 - 6D PROVIDE LAV
 - 6E PROVIDE TOILET & PARTITION
 - 6F PROVIDE URINAL & SCREEN
 - 7A REMOVE TACK BOARDS. INSTALL PROVIDED OR EXISTING BOARDS AFTER ALL CORRIDOR WORK HAS BEEN COMPLETED. COORDINATE LOCATIONS WITH OWNER.
 - 7B REMOVE BULLETIN BOARD. INSTALL PROVIDED OR EXISTING BOARDS AFTER ALL CORRIDOR WORK HAS BEEN COMPLETED. COORDINATE LOCATIONS WITH OWNER.
 - 7C EXISTING DISPLAY CASES TO REMAIN IN PLACE. PAINT INTERIOR TO MATCH CORRIDOR COLOR. PAINT TRIM TO MATCH DOOR TRIM COLOR.

| REVISIONS | | | STATE OF CONNECTICUT DEPARTMENT OF ADMINISTRATIVE SERVICES | |
|---|--|-------------------------------|--|---|
| mark | date | description | drawing prepared by | date |
| | 8/4/17 | SCHEMATIC DESIGN SUBMISSION | AMES & WHITAKER ARCHITECTS 31 LIBERTY STREET SOUTHINGTON, CT | 07/25/18 |
| | 1/15/18 | DESIGN DEVELOPMENT SUBMISSION | | scale AS NOTED |
| | 4/16/18 5/23/18 7/25/18 1/21/19 | CONSTRUCTION DOCUMENTS | | drawn by CA/SP approved by AL drawing no. A4.00 |
| drawing title SECOND FLOOR - NORTH PARTIAL PLANS | | | CAD no. | project no. BI-RD-299 |

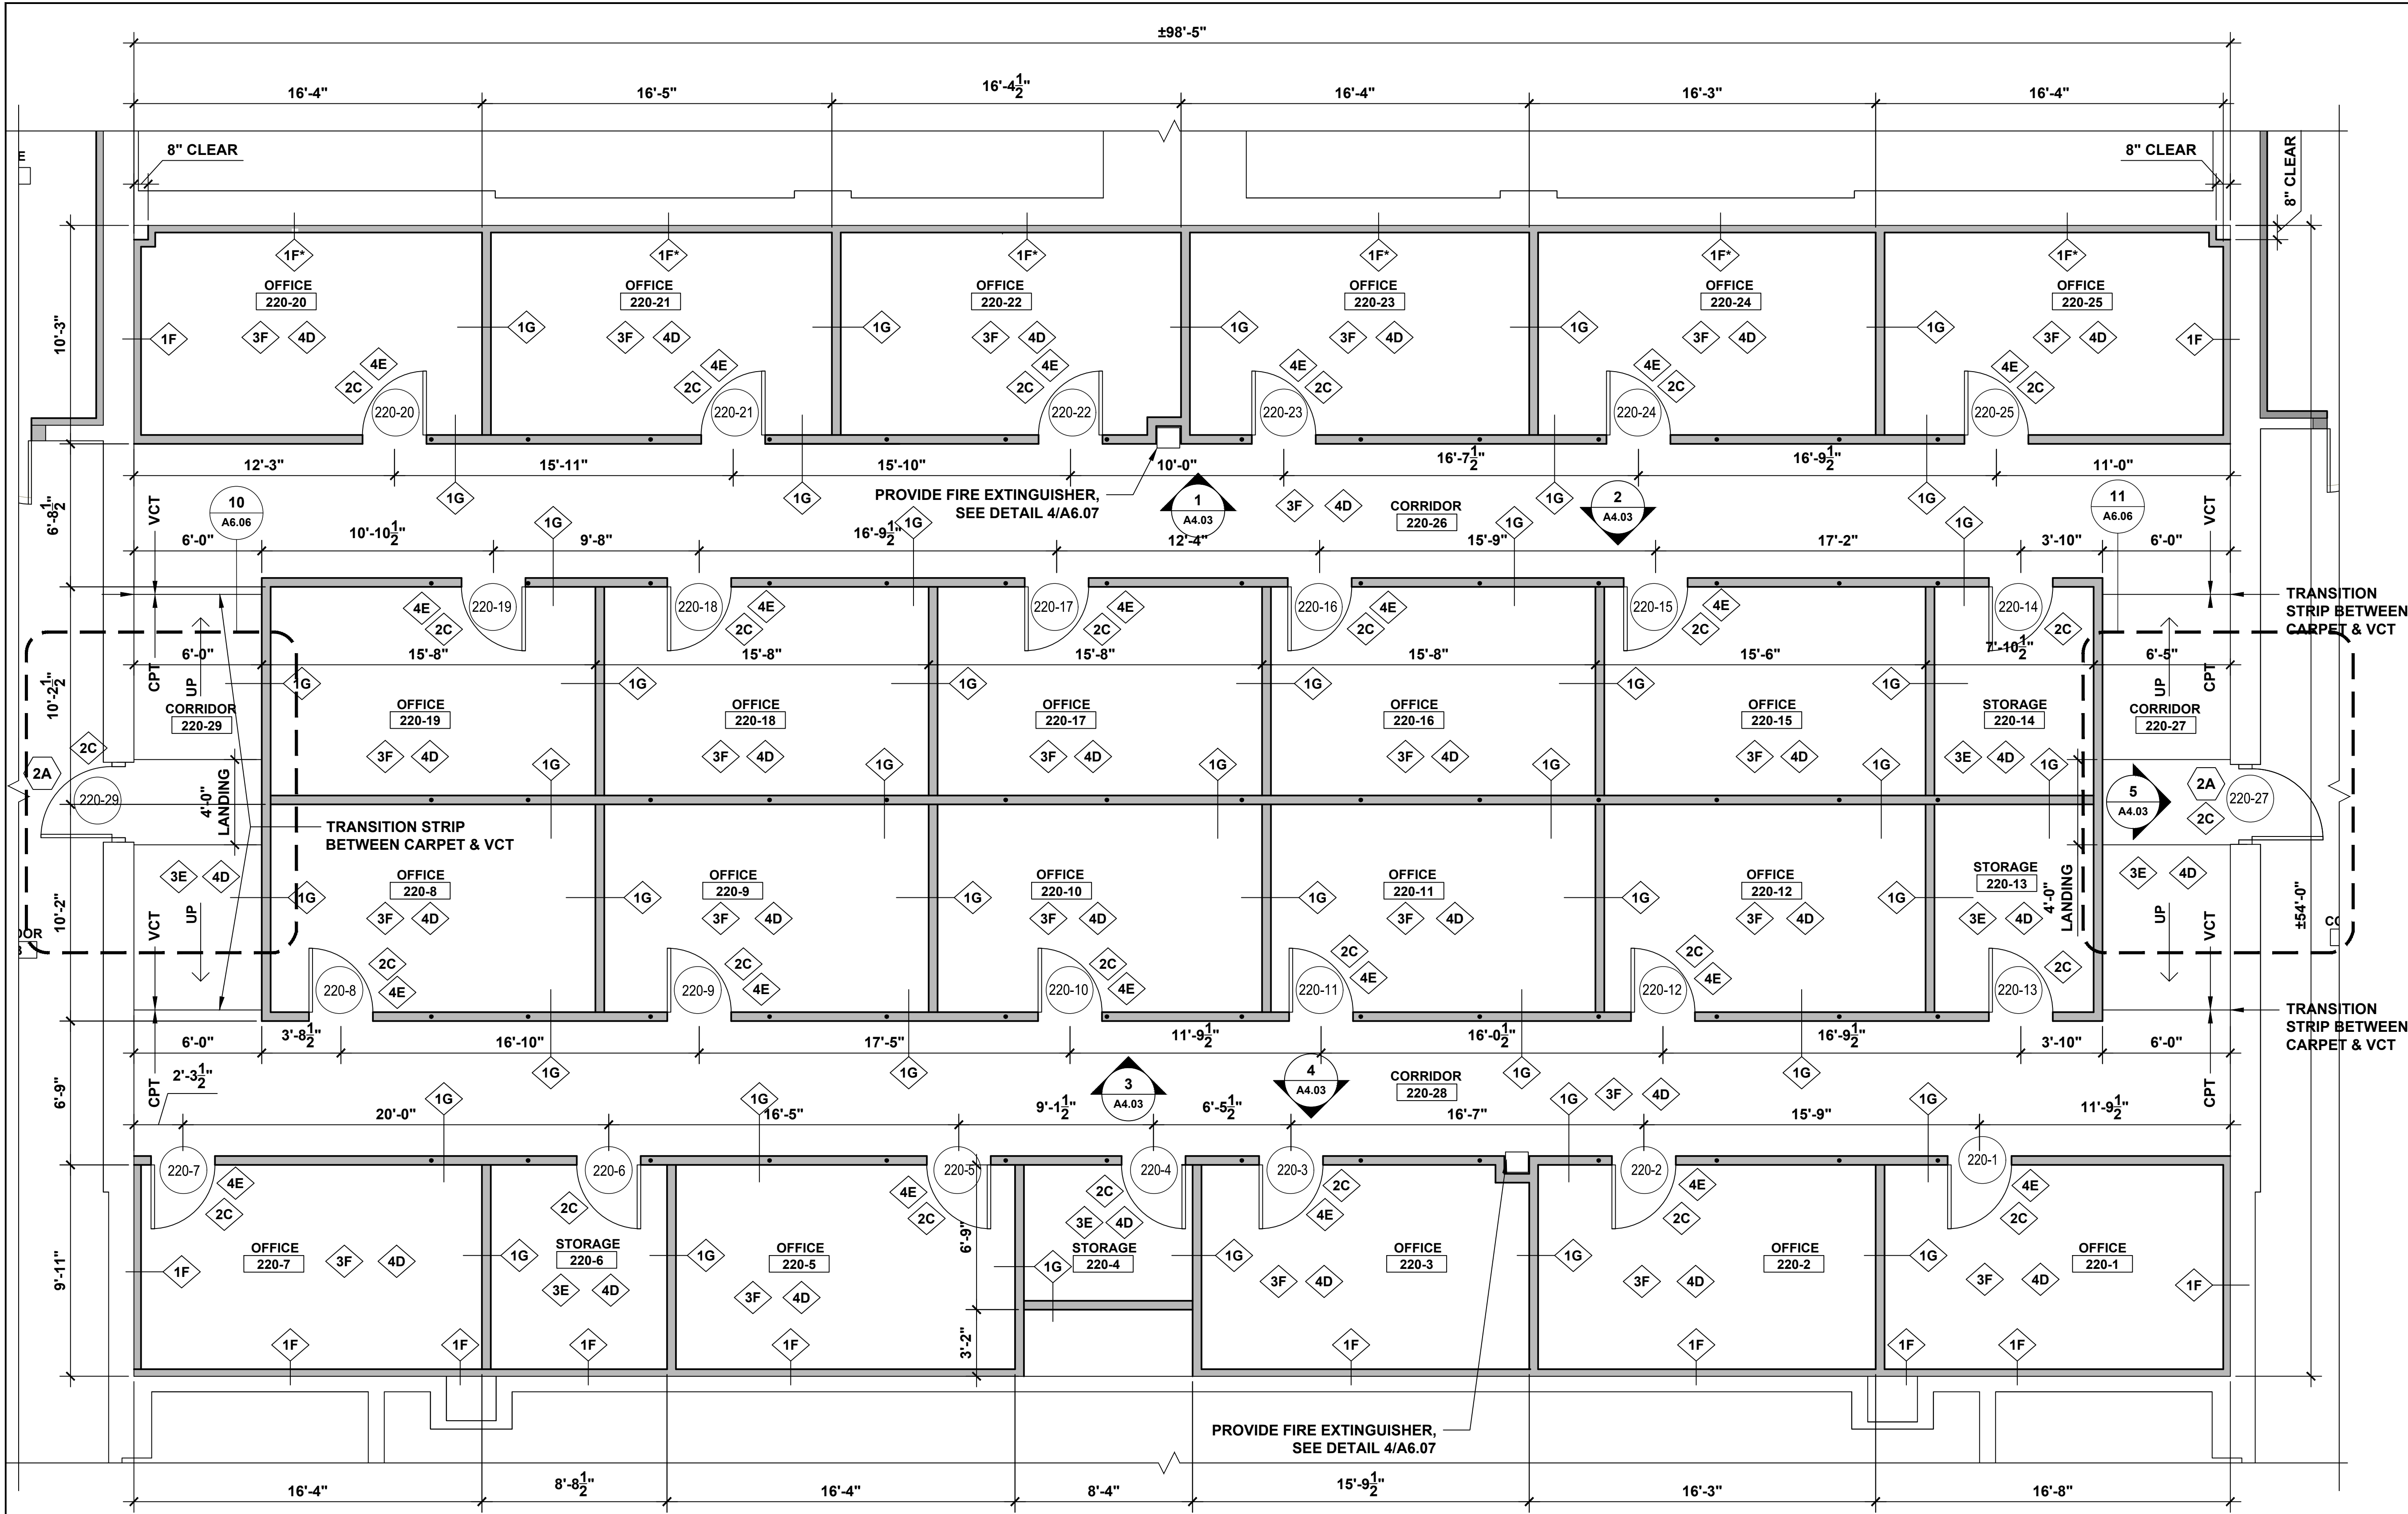



- DEMOLITION KEY NOTES**
- 1A REMOVE MASONRY WALL.
 - 1B REMOVE STUD AND GYP BD WALL.
 - 2A REMOVE DOOR AND FRAME.
 - 2B REMOVE DOOR, EXISTING FRAME TO REMAIN.
 - 3A REMOVE C.T. FLOOR.
 - 3B REMOVE VCT FLOOR.
 - 3C REMOVE CARPET.
 - 4A REMOVE C.T. WAINSCOT AND BASE.
 - 4B REMOVE VINYL BASE
 - 5A REMOVE ACT CEILING.
 - 6A REMOVE LAV.
 - 6B REMOVE TOILET & TOILET PARTITION.
 - 6C REMOVE URINAL AND URINAL SCREEN.

- NEW WORK KEY NOTES**
- 1C PROVIDE MASONRY WALL.
 - 1D PROVIDE 1 HOUR RATED WALL, 3/8" METAL STUDS WITH 5/8" TYPE 'X' GYP. BOARD BOTH SIDES
 - 1E PROVIDE 5/8" MOISTURE RESISTANT GYP BD ON EXISTING STUDS.
 - 1F PROVIDE 3 3/8" METAL STUDS WITH 5/8" TYPE 'X' GYP. BOARD ONE SIDE
 - 1G PROVIDE 3/8" METAL STUDS WITH 5/8" TYPE 'X' GYP. BOARD BOTH SIDES
 - 2C PROVIDE WOOD DOOR AND HM FRAME.
 - 2D PROVIDE WOOD DOOR IN EXISTING HM FRAME.
 - 3D PROVIDE CT FLOOR AND CT BASE.
 - 3E PROVIDE VCT AND RESILIENT BASE.
 - 3F PROVIDE CARPET AND RESILIENT BASE.
 - 3G EXISTING FLOORING TO REMAIN. (PROTECT DURING RENOVATION)
 - 4C PROVIDE CT WAINSCOT AND BASE/ PAINT ABOVE
 - 4D PREP AND PAINT WALLS
 - 4E PROVIDE HORIZONTAL WINDOW BLINDS
 - 5B PROVIDE ACT CEILING.
 - 5C REMOVE & REINSTALL ACT CEILING AFTER MEP WORK IS COMPLETED.
 - 5D PROVIDE GYPSUM BOARD CEILING/SOFFIT AND PAINT
 - 5E PAINT EXISTING CEILING
 - 6D PROVIDE LAV
 - 6E PROVIDE TOILET & PARTITION
 - 6F PROVIDE URINAL & SCREEN
 - 7A REMOVE TACK BOARDS. INSTALL PROVIDED OR EXISTING BOARDS AFTER ALL CORRIDOR WORK HAS BEEN COMPLETED. COORDINATE LOCATIONS WITH OWNER.
 - 7B REMOVE BULLETIN BOARD. INSTALL PROVIDED OR EXISTING BOARDS AFTER ALL CORRIDOR WORK HAS BEEN COMPLETED. COORDINATE LOCATIONS WITH OWNER.
 - 7C EXISTING DISPLAY CASES TO REMAIN IN PLACE. PAINT INTERIOR TO MATCH CORRIDOR COLOR. PAINT TRIM TO MATCH DOOR TRIM COLOR.

1 NORTH CENTER PARTIAL PLAN


GENERAL NOTES

- SEE DWG A6.07 FOR PARTITION TYPES.
- CENTER ALL WEST TO EAST WALLS ON EXISTING ROD STRUCTURE.

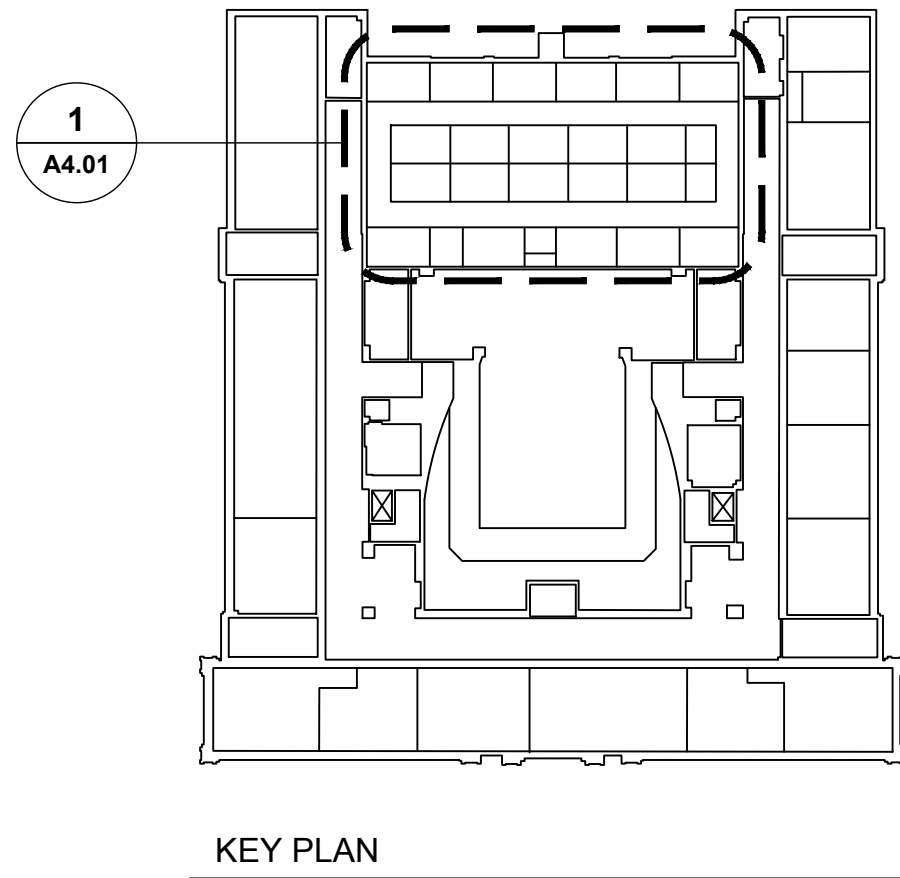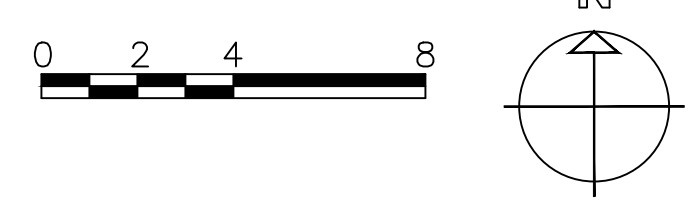

| | | | |
|---|---------|---|---|
| drawing title SECOND FLOOR - NORTH CENTER PARTIAL PLAN | | STATE OF CONNECTICUT DEPARTMENT OF ADMINISTRATIVE SERVICES | |
| REVISIONS | | | |
| mark | date | description | drawing prepared by |
| | 8/4/17 | SCHEMATIC DESIGN SUBMISSION | AMES & WHITAKER ARCHITECTS |
| | 1/15/18 | DESIGN DEVELOPMENT SUBMISSION | 31 LIBERTY STREET SOUTHINGTON, CT |
| | 4/16/18 | CONSTRUCTION DOCUMENTS | project WESTERN CT STATE UNIVERSITY WHITE HALL 2ND AND 3RD FLOOR RENOVATIONS DANBURY, CONNECTICUT |
| | 5/23/18 | | date 07/25/18 |
| | 7/25/18 | | scale AS NOTED |
| | | | drawn by CA/SP |
| | | | approved by AL |
| | | | drawing no. A4.01 |
| | | | CAD no. BI-RD-299 |

±97'-9"

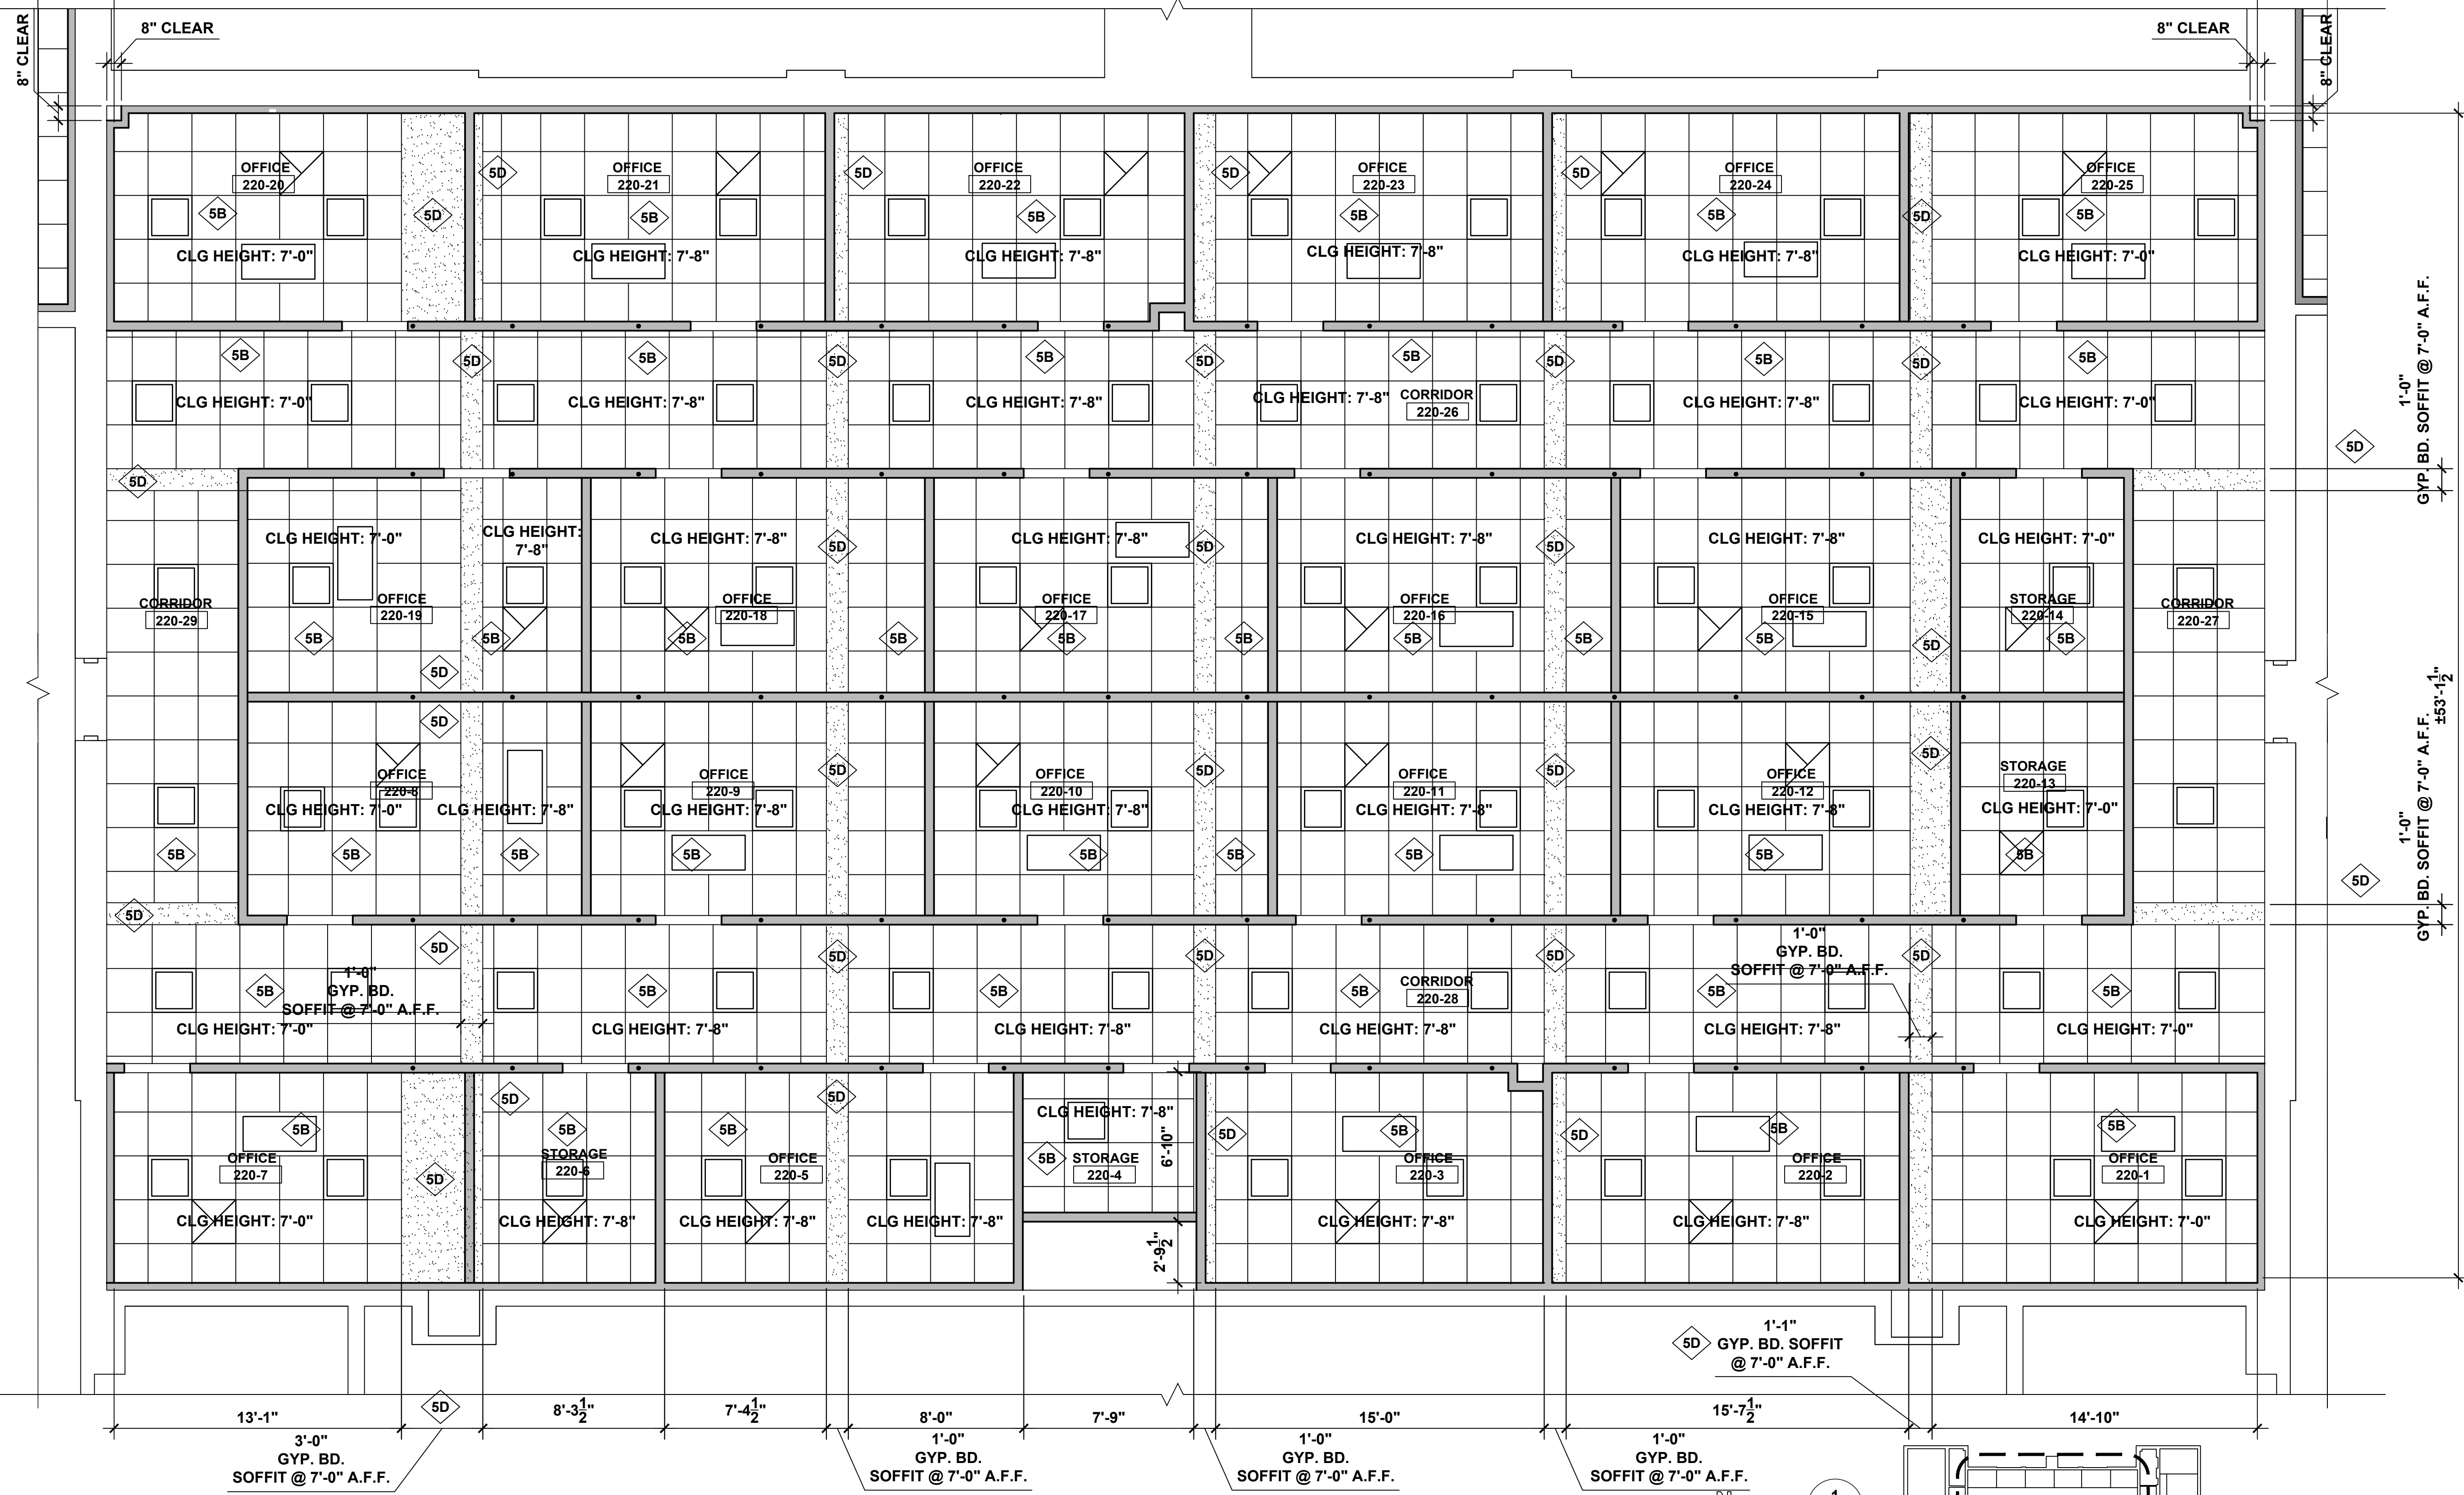


- DEMOLITION KEY NOTES**
- 1A REMOVE MASONRY WALL.
 - 1B REMOVE STUD AND GYP BD WALL.
 - 2A REMOVE DOOR AND FRAME.
 - 2B REMOVE DOOR. EXISTING FRAME TO REMAIN.
 - 3A REMOVE C.T. FLOOR.
 - 3B REMOVE VCT FLOOR.
 - 3C REMOVE CARPET.
 - 4A REMOVE C.T. WAINSCOT AND BASE.
 - 4B REMOVE VINYL BASE
 - 5A REMOVE ACT CEILING.
 - 6A REMOVE LAV.
 - 6B REMOVE TOILET & TOILET PARTITION.
 - 6C REMOVE URINAL AND URINAL SCREEN.

- NEW WORK KEY NOTES**
- 1C PROVIDE MASONRY WALL.
 - 1D PROVIDE 1 HOUR RATED WALL, 3/8" METAL STUDS WITH 5/8" TYPE 'X' GYP. BOARD BOTH SIDES
 - 1E PROVIDE 5/8" MOISTURE RESISTANT GYP BD ON EXISTING STUDS.
 - 1F PROVIDE 3/8" METAL STUDS WITH 5/8" TYPE 'X' GYP. BOARD ONE SIDE
 - 1G PROVIDE 3/8" METAL STUDS WITH 5/8" TYPE 'X' GYP. BOARD BOTH SIDES
 - 2C PROVIDE WOOD DOOR AND HM FRAME.
 - 2D PROVIDE WOOD DOOR IN EXISTING HM FRAME.
 - 3D PROVIDE CT FLOOR AND CT BASE.
 - 3E PROVIDE VCT AND RESILIENT BASE.
 - 3F PROVIDE CARPET AND RESILIENT BASE.
 - 3G EXISTING FLOORING TO REMAIN. (PROTECT DURING RENOVATION)
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 - 4D PREP AND PAINT WALLS
 - 4E PROVIDE HORIZONTAL WINDOW BLINDS
 - 5B PROVIDE ACT CEILING.
 - 5C REMOVE & REINSTALL ACT CEILING AFTER MEP WORK IS COMPLETED.
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 - 5E PAINT EXISTING CEILING
 - 6D PROVIDE LAV
 - 6E PROVIDE TOILET & PARTITION
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 - 7A REMOVE TACK BOARDS. INSTALL PROVIDED OR EXISTING BOARDS AFTER ALL CORRIDOR WORK HAS BEEN COMPLETED. COORDINATE LOCATIONS WITH OWNER.
 - 7B REMOVE BULLETIN BOARD. INSTALL PROVIDED OR EXISTING BOARDS AFTER ALL CORRIDOR WORK HAS BEEN COMPLETED. COORDINATE LOCATIONS WITH OWNER.
 - 7C EXISTING DISPLAY CASES TO REMAIN IN PLACE. PAINT INTERIOR TO MATCH CORRIDOR COLOR. PAINT TRIM TO MATCH DOOR TRIM COLOR.



1 NORTH CENTER PARTIAL PLAN

CEILING LEGEND

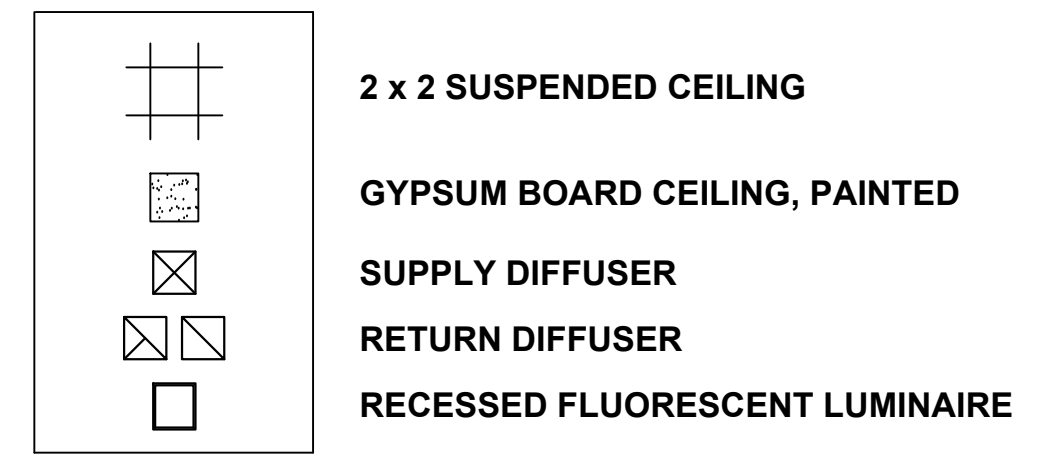


REFLECTED CEILING NOTES



1. COORDINATE WITH MECHANICAL AND ELECTRICAL DRAWINGS FOR LOCATIONS AND FIXTURE DESCRIPTIONS OF LIGHTING, SUPPLY/RETURN DIFFUSERS, AND RADIANT CEILING HEATING PANELS.
2. REFER TO MECHANICAL PLANS FOR DUCT PENETRATIONS AT CORRIDOR WALLS. COORDINATE SIZE OF OPENINGS TO ACCOMMODATE FIRE DAMPERS SHOWN ON DETAIL 5/M3.01.
3. INFILL MASONRY WALL WHERE EXISTING DUCTS REMOVED. SEE MASONRY INFILL DETAIL. ON A1.05

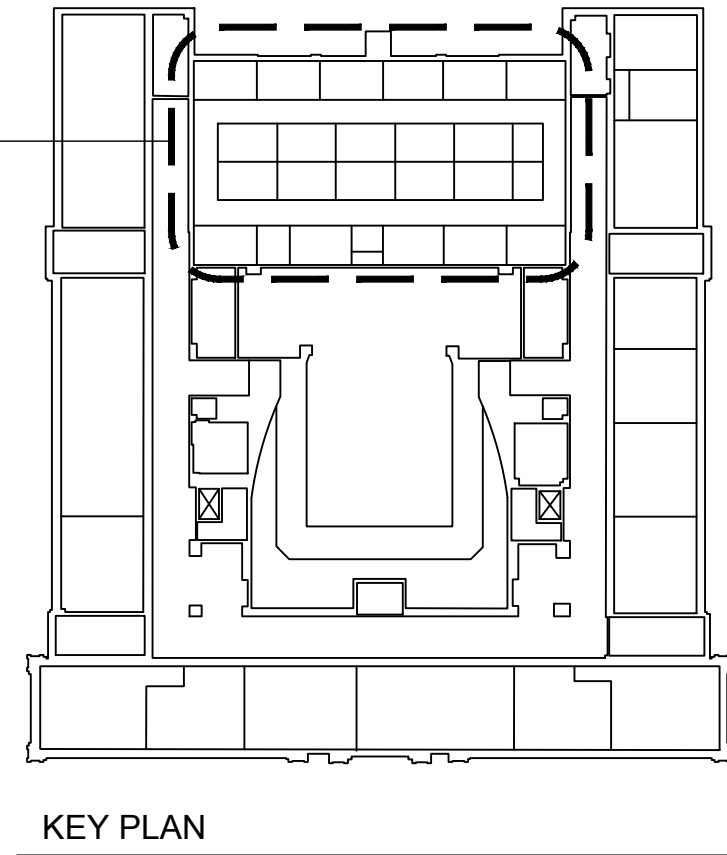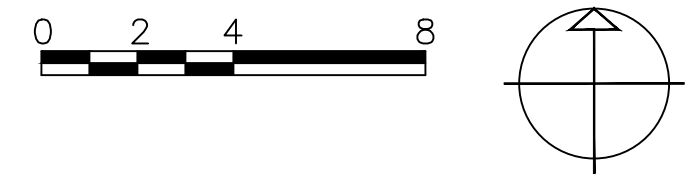



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|---|---------|---|---|
| drawing title SECOND FLOOR - NORTH CENTER REFLECTED CEILING PLAN | | STATE OF CONNECTICUT DEPARTMENT OF ADMINISTRATIVE SERVICES | |
| REVISIONS | | | |
| mark | date | description | drawing prepared by |
| | 8/4/17 | SCHEMATIC DESIGN SUBMISSION | AMES & WHITAKER ARCHITECTS |
| | 1/15/18 | DESIGN DEVELOPMENT SUBMISSION | 31 LIBERTY STREET SOUTHINGTON, CT |
| | 4/16/18 | CONSTRUCTION DOCUMENTS | project WESTERN CT STATE UNIVERSITY WHITE HALL 2ND AND 3RD FLOOR RENOVATIONS DANBURY, CONNECTICUT |
| | 5/23/18 | | date 07/25/18 |
| | 7/25/18 | | scale AS NOTED |
| | | | drawn by CA/SP |
| | | | approved by AL |
| | | | drawing no. A4.02 |
| | | | CAD no. 51-RD-299 |

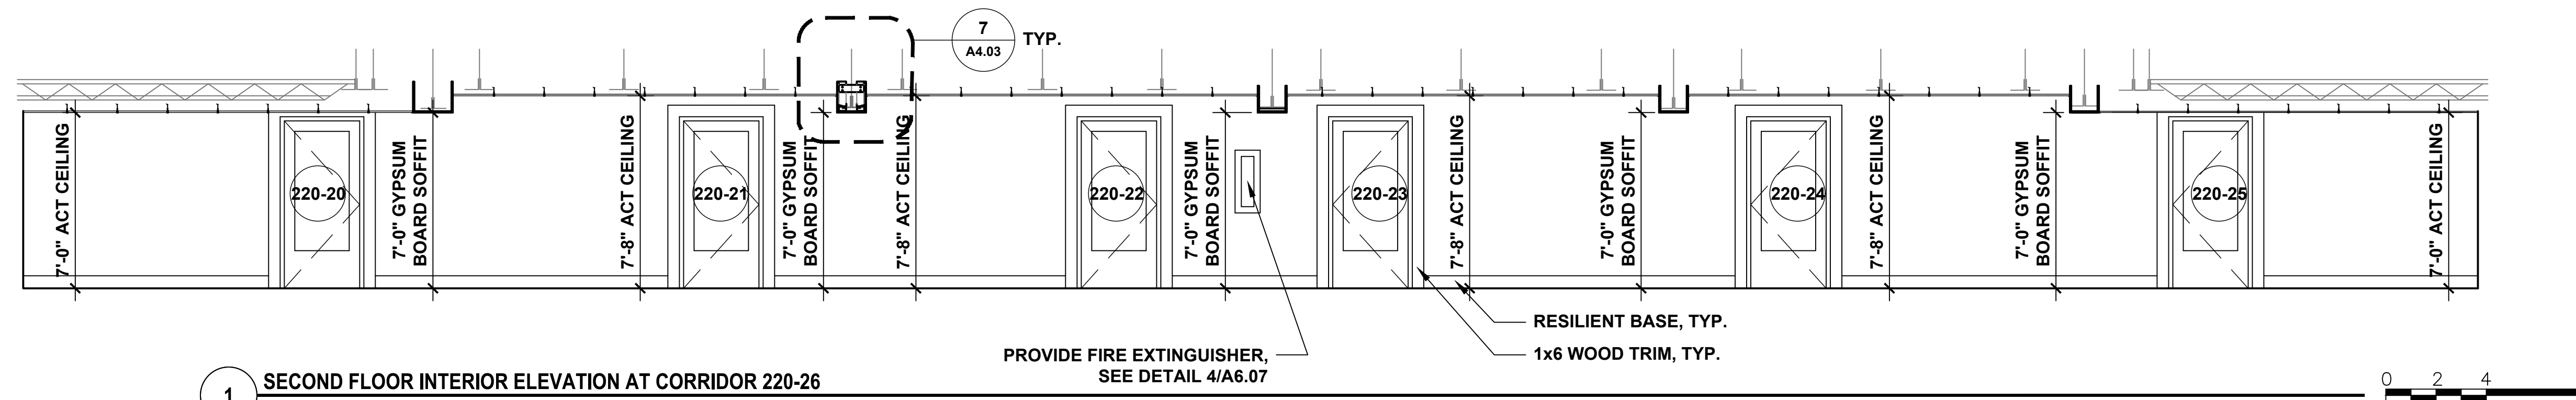


1 SECOND FLOOR INTERIOR ELEVATION AT CORRIDOR 220-26

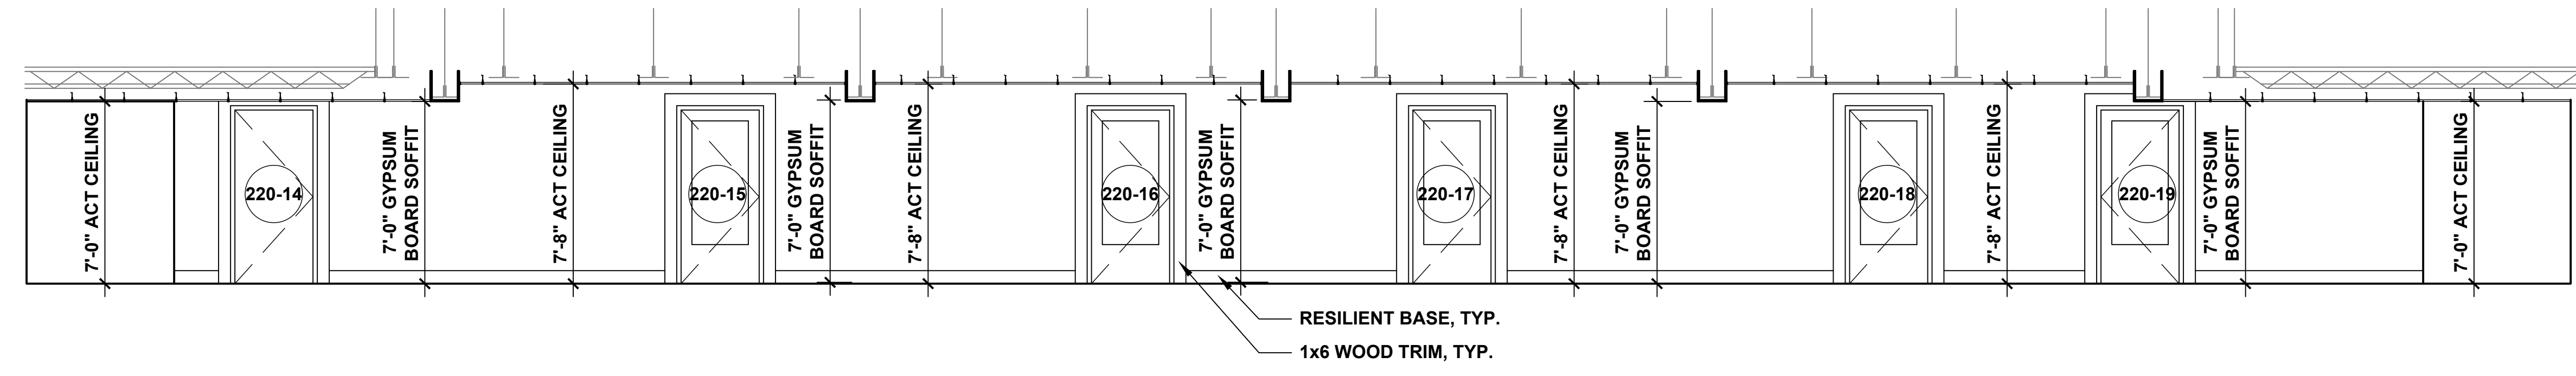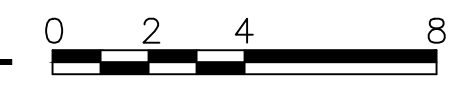



2 SECOND FLOOR INTERIOR ELEVATION AT CORRIDOR 220-26

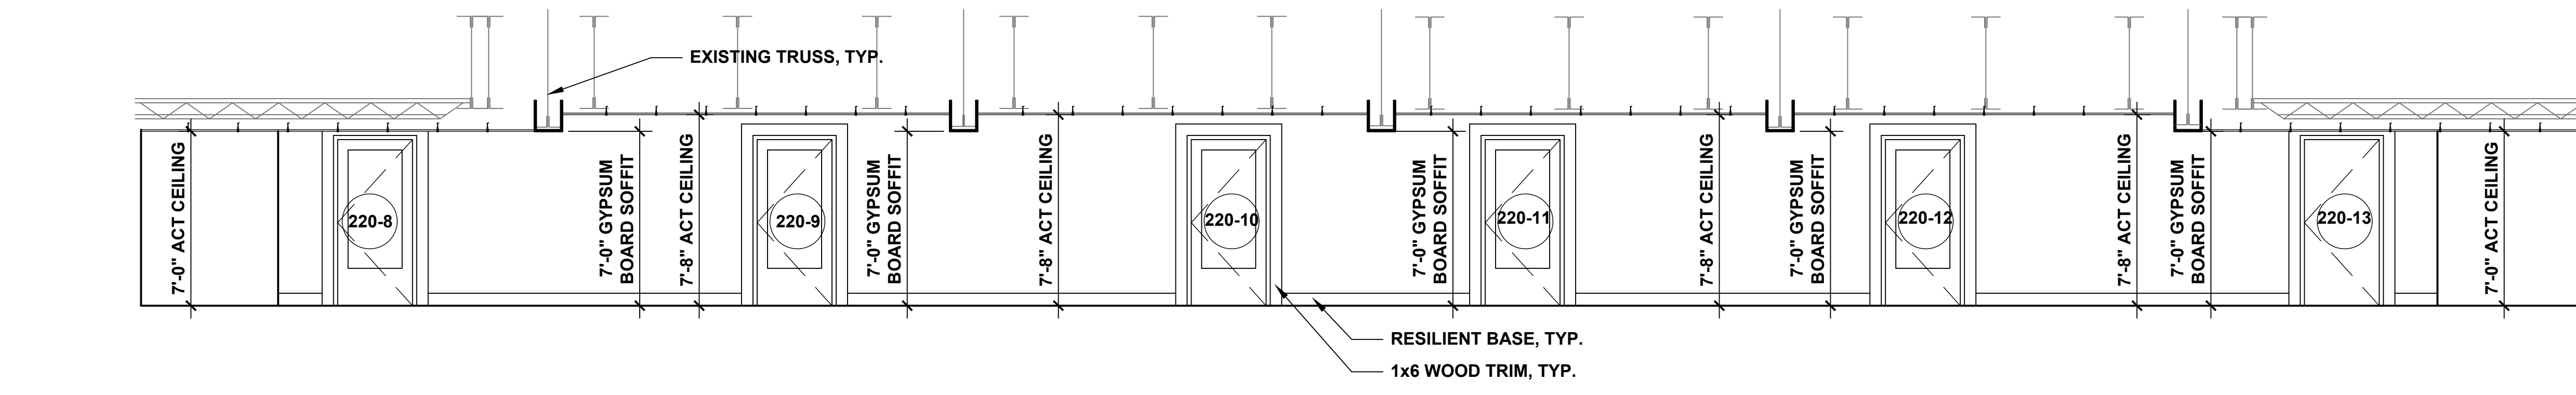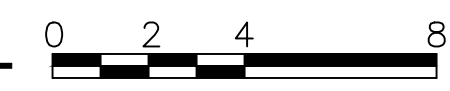



3 SECOND FLOOR INTERIOR ELEVATION AT CORRIDOR 220-28

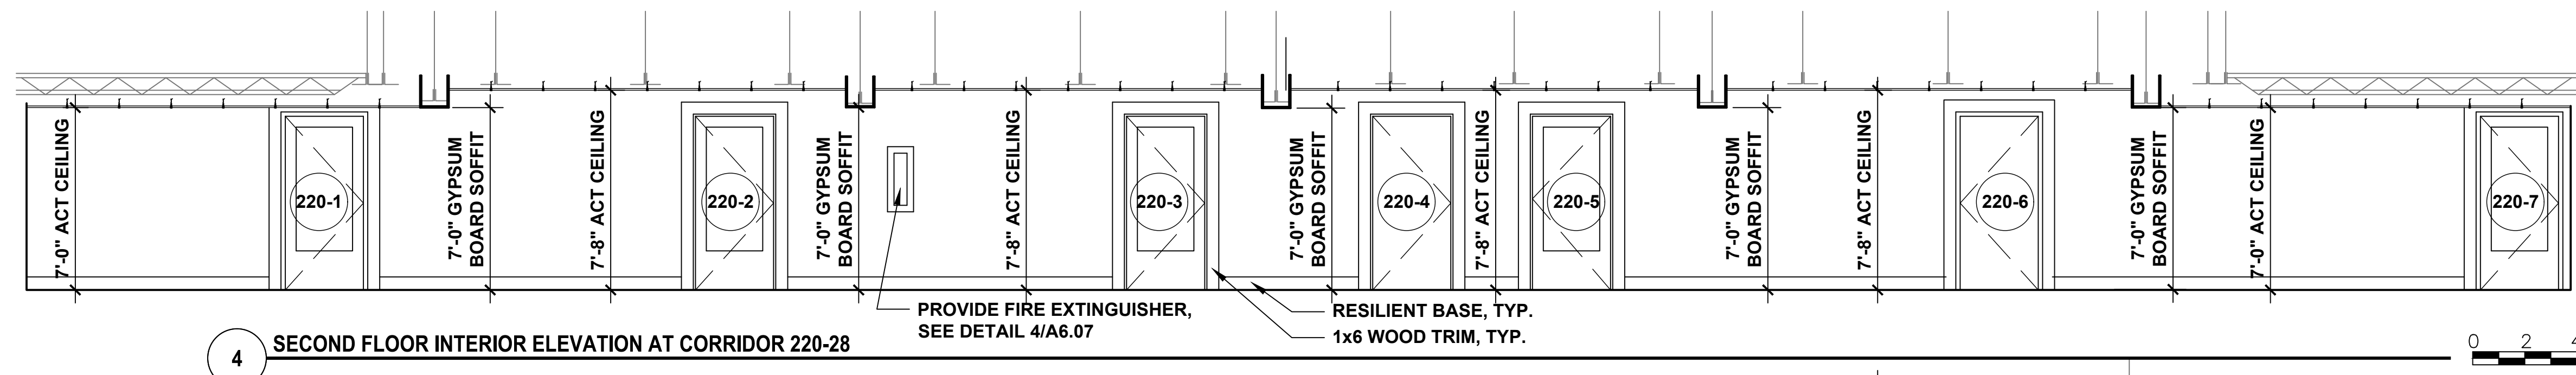

4 SECOND FLOOR INTERIOR ELEVATION AT CORRIDOR 220-28

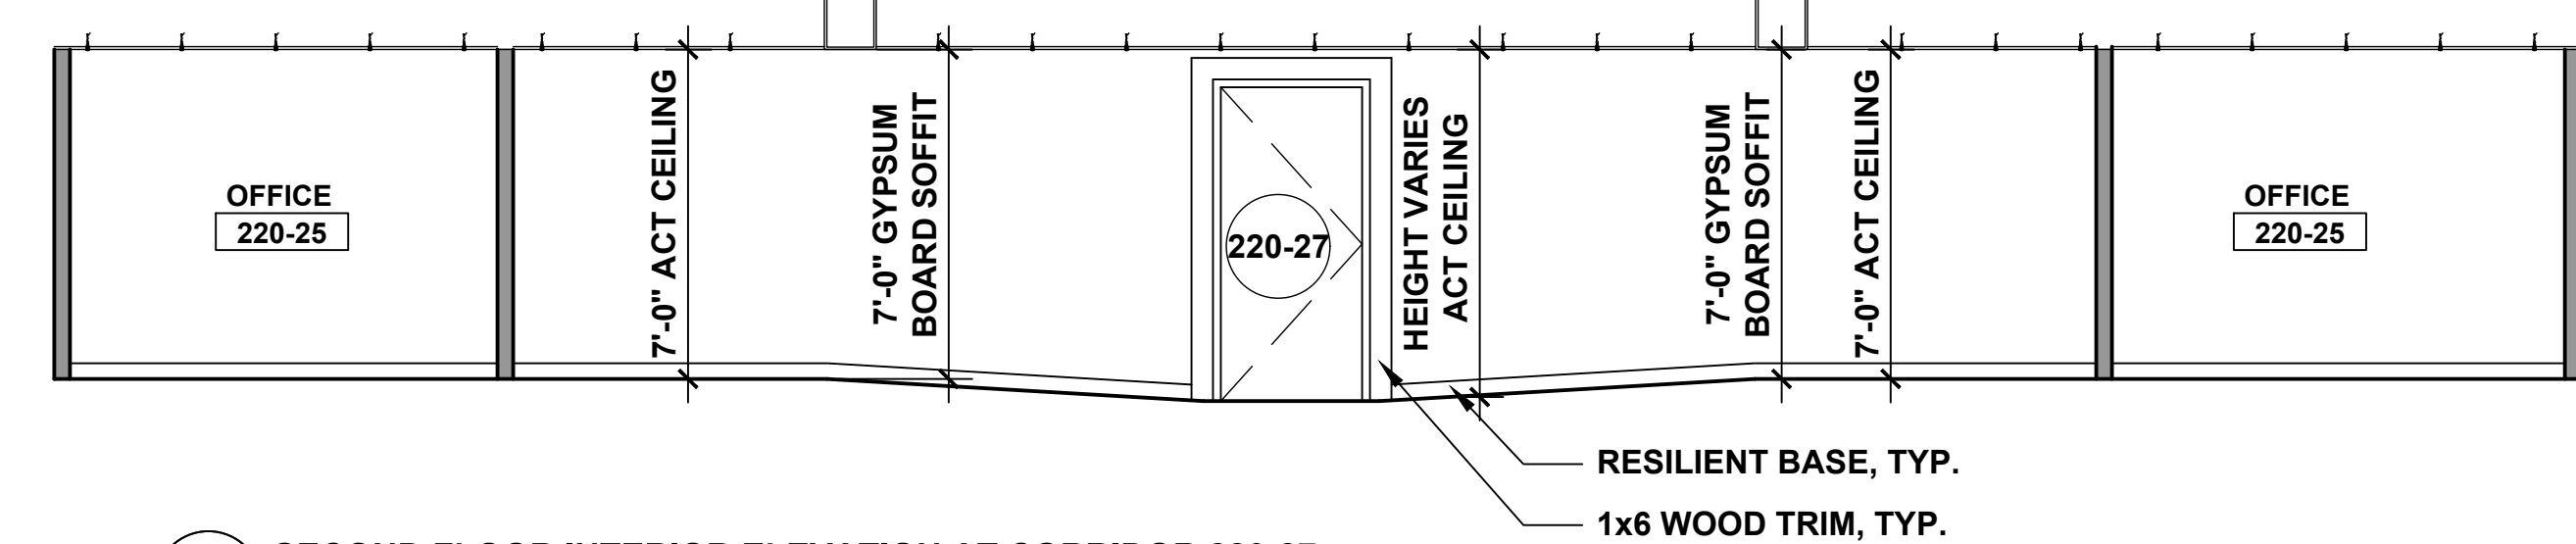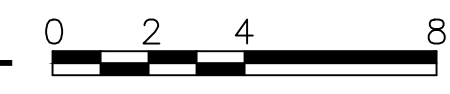

5 SECOND FLOOR INTERIOR ELEVATION AT CORRIDOR 220-27
6 SECOND FLOOR INTERIOR ELEVATION AT CORRIDOR 220-29 SIMILAR

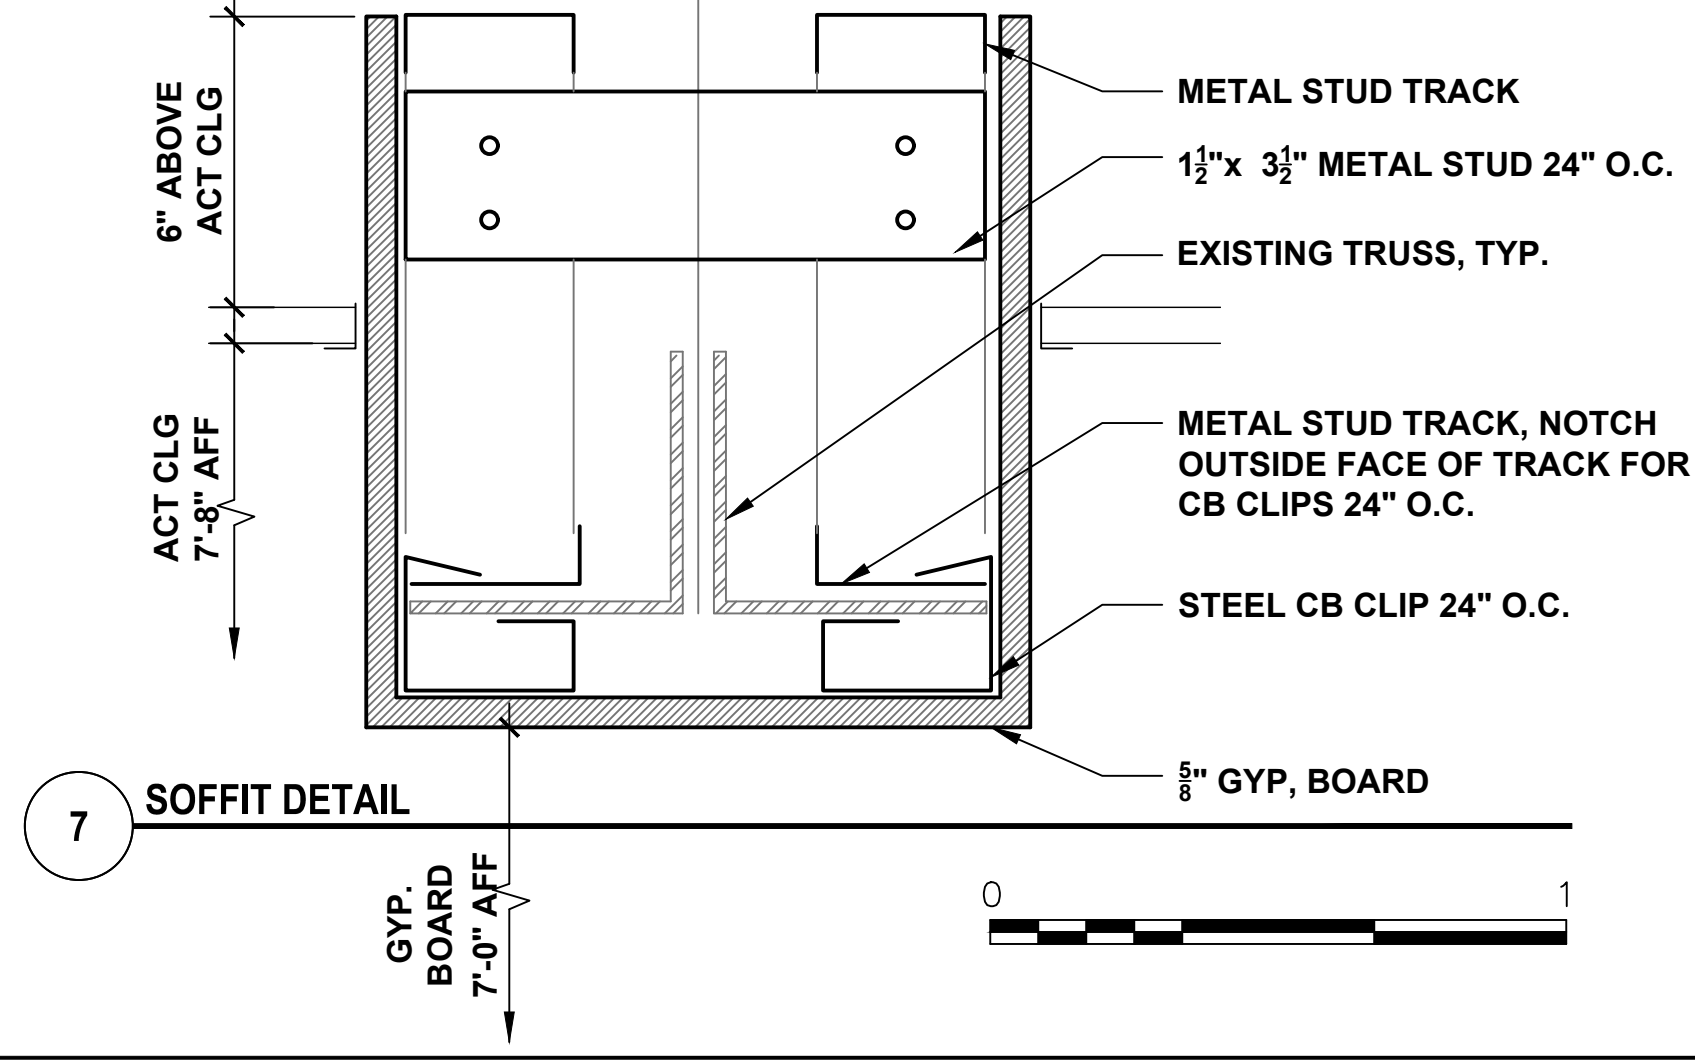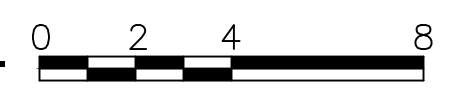


7 SOFFIT DETAIL




- DEMOLITION KEY NOTES**
- 1A REMOVE MASONRY WALL.
 - 1B REMOVE STUD AND GYP BD WALL.
 - 2A REMOVE DOOR AND FRAME.
 - 2B REMOVE DOOR, EXISTING FRAME TO REMAIN.
 - 3A REMOVE C.T. FLOOR.
 - 3B REMOVE VCT FLOOR.
 - 3C REMOVE CARPET.
 - 4A REMOVE C.T. WAINSCOT AND BASE.
 - 4B REMOVE VINYL BASE
 - 5A REMOVE ACT CEILING.
 - 6A REMOVE LAV.
 - 6B REMOVE TOILET & TOILET PARTITION.
 - 6C REMOVE URINAL AND URINAL SCREEN.

- NEW WORK KEY NOTES**
- 1C PROVIDE MASONRY WALL.
 - 1D PROVIDE 1 HOUR RATED WALL, 3/8\"/>
 - 1E PROVIDE 5/8\"/>
 - 1F PROVIDE 3/8\"/>
 - 1G PROVIDE 3/8\"/>
 - 2C PROVIDE WOOD DOOR AND HM FRAME.
 - 2D PROVIDE WOOD DOOR IN EXISTING HM FRAME.
 - 3D PROVIDE CT FLOOR AND CT BASE.
 - 3E PROVIDE VCT AND RESILIENT BASE.
 - 3F PROVIDE CARPET AND RESILIENT BASE.
 - 3G EXISTING FLOORING TO REMAIN. (PROTECT DURING RENOVATION)
 - 4C PROVIDE CT WAINSCOT AND BASE/ PAINT ABOVE
 - 4D PREP AND PAINT WALLS
 - 4E PROVIDE HORIZONTAL WINDOW BLINDS
 - 5B PROVIDE ACT CEILING.
 - 5C REMOVE & REINSTALL ACT CEILING AFTER MEP WORK IS COMPLETED.
 - 5D PROVIDE GYPSUM BOARD CEILING/SOFFIT AND PAINT
 - 5E PAINT EXISTING CEILING
 - 6D PROVIDE LAV
 - 6E PROVIDE TOILET & PARTITION
 - 6F PROVIDE URINAL & SCREEN
 - 7A REMOVE TACK BOARDS. INSTALL PROVIDED OR EXISTING BOARDS AFTER ALL CORRIDOR WORK HAS BEEN COMPLETED. COORDINATE LOCATIONS WITH OWNER.
 - 7B REMOVE BULLETIN BOARD. INSTALL PROVIDED OR EXISTING BOARDS AFTER ALL CORRIDOR WORK HAS BEEN COMPLETED. COORDINATE LOCATIONS WITH OWNER.
 - 7C EXISTING DISPLAY CASES TO REMAIN IN PLACE. PAINT INTERIOR TO MATCH CORRIDOR COLOR. PAINT TRIM TO MATCH DOOR TRIM COLOR.


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|---|--------------------------|---|---|
| drawing title SECOND FLOOR - INTERIOR ELEVATIONS | | STATE OF CONNECTICUT DEPARTMENT OF ADMINISTRATIVE SERVICES | |
| REVISIONS | | drawing prepared by AMES & WHITAKER ARCHITECTS | |
| mark | date | description | date |
| | 8/4/17 | SCHEMATIC DESIGN SUBMISSION | 07/25/18 |
| | 1/15/18 | DESIGN DEVELOPMENT SUBMISSION | scale AS NOTED |
| | 4/16/18 | CONSTRUCTION DOCUMENTS | project WESTERN CT STATE UNIVERSITY WHITE HALL 2ND AND 3RD FLOOR RENOVATIONS DANBURY, CONNECTICUT |
| | 5/23/18 | | drawn by CAV/SP |
| | 7/25/18 | | approved by AL |
| | | | drawing no. A4.03 |
| CAD no. | project no. BI-RD-299 | | |

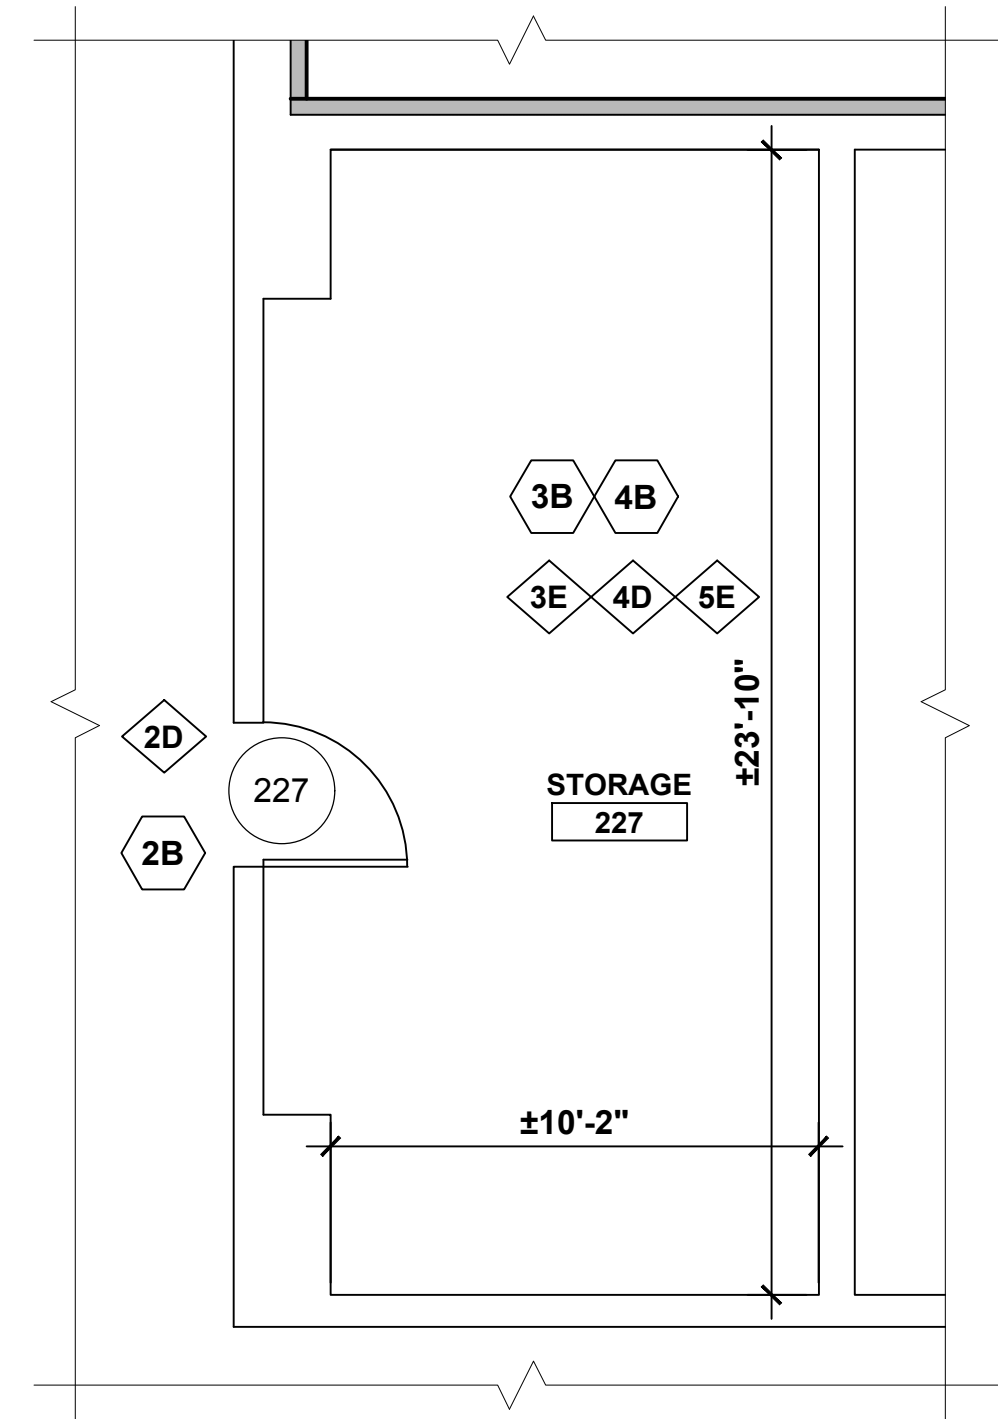


3 NORTHWEST PARTIAL PLAN AT STORAGE ROOM 0 2 4 8

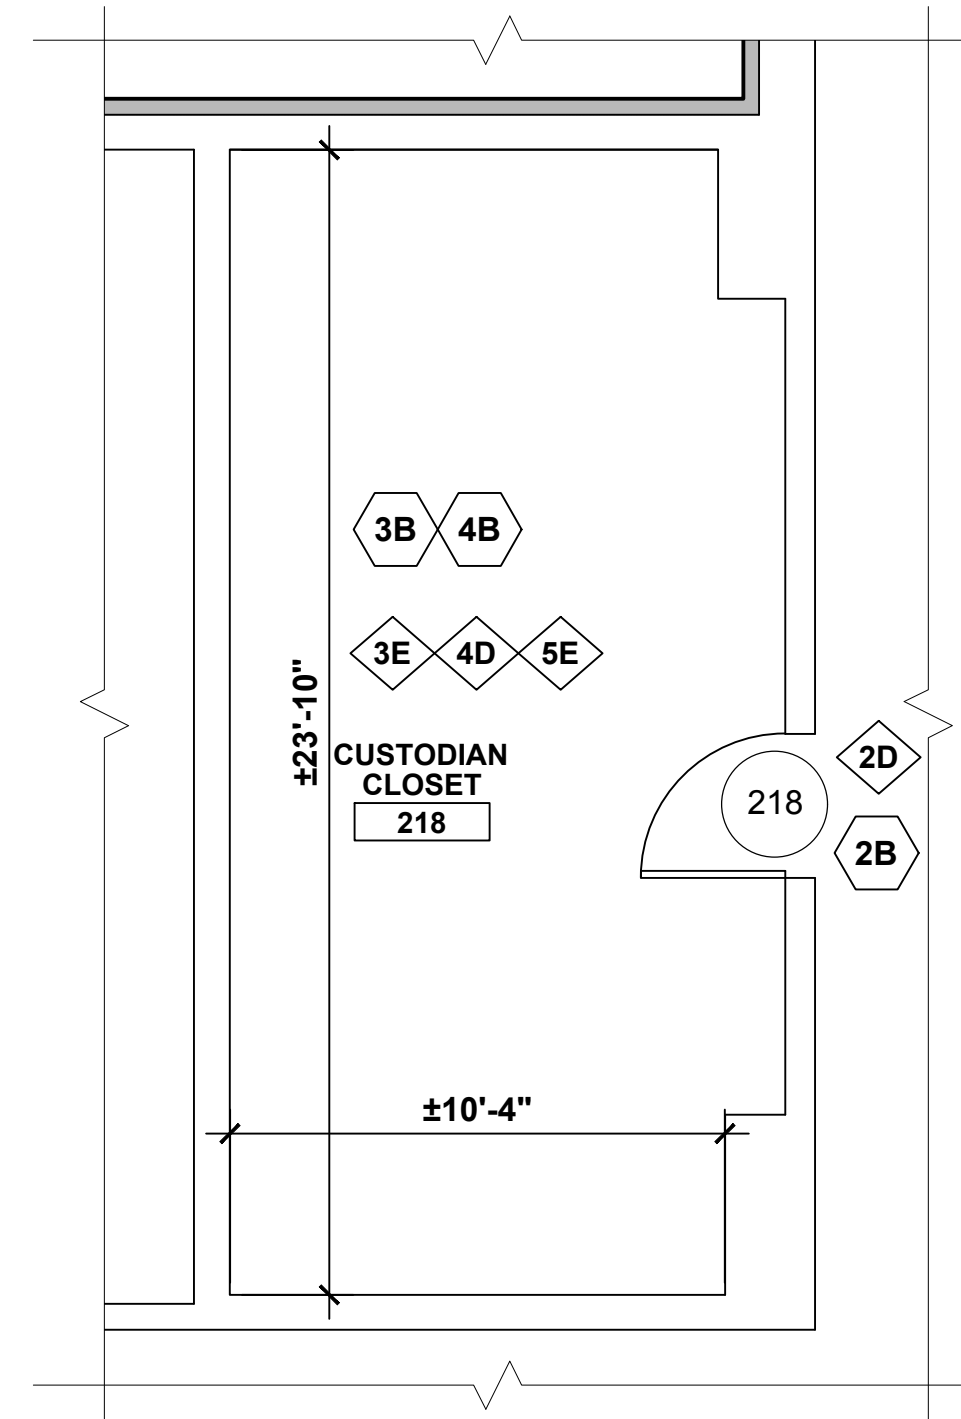


4 NORTHEAST CORNER PARTIAL PLAN AT STORAGE ROOM 0 2 4 8

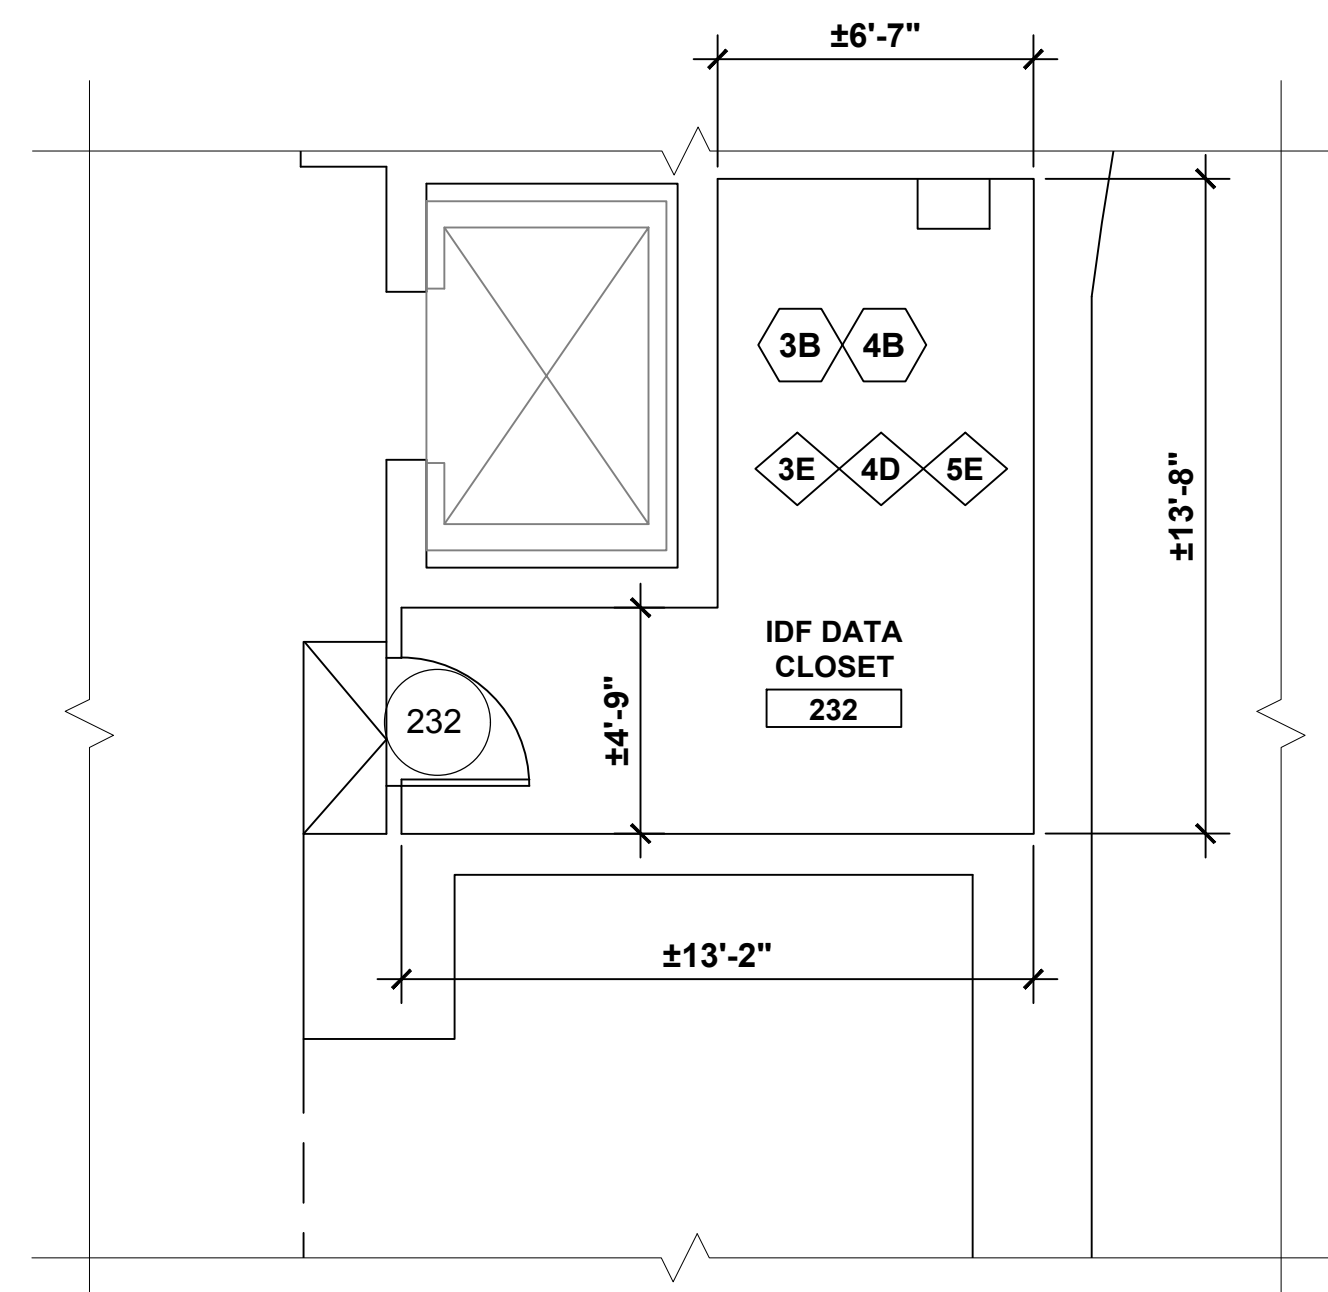

1 SOUTHWEST CORNER PLAN AT IDF DATA CLOSET 0 2 4 8

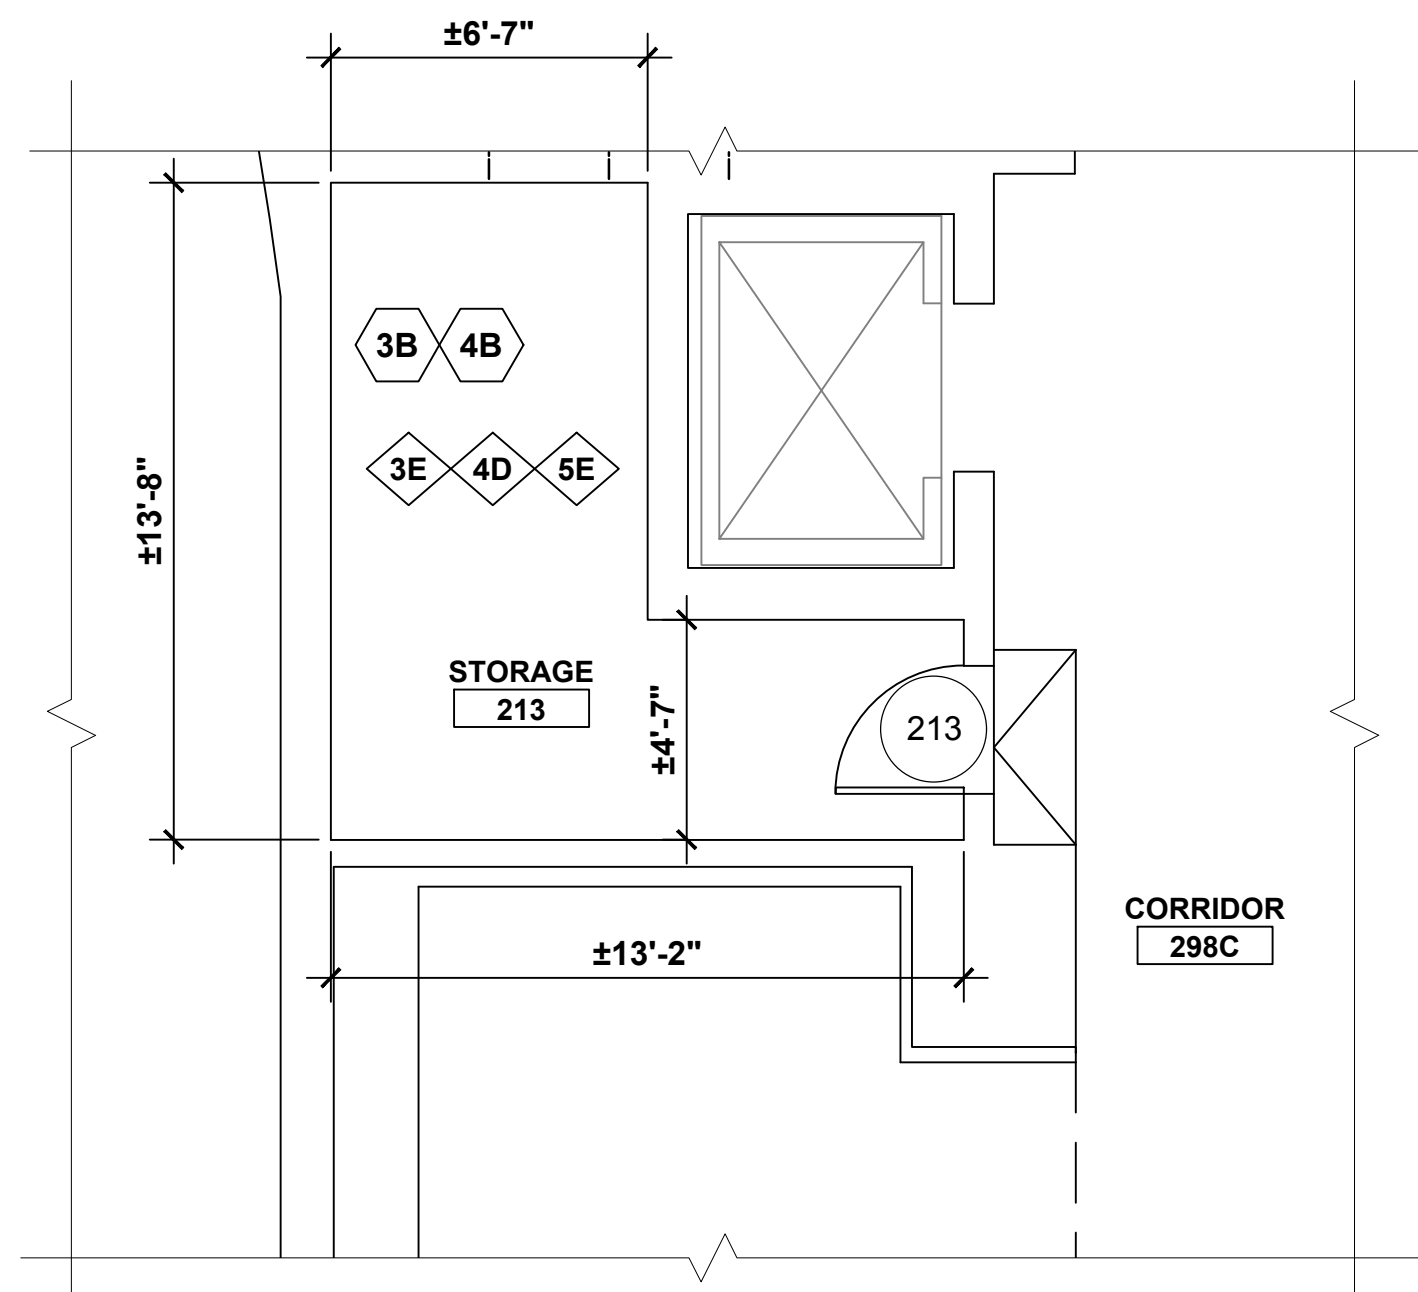

2 SOUTHEAST CORNER PARTIAL PLAN AT STORAGE ROOM 0 2 4 8

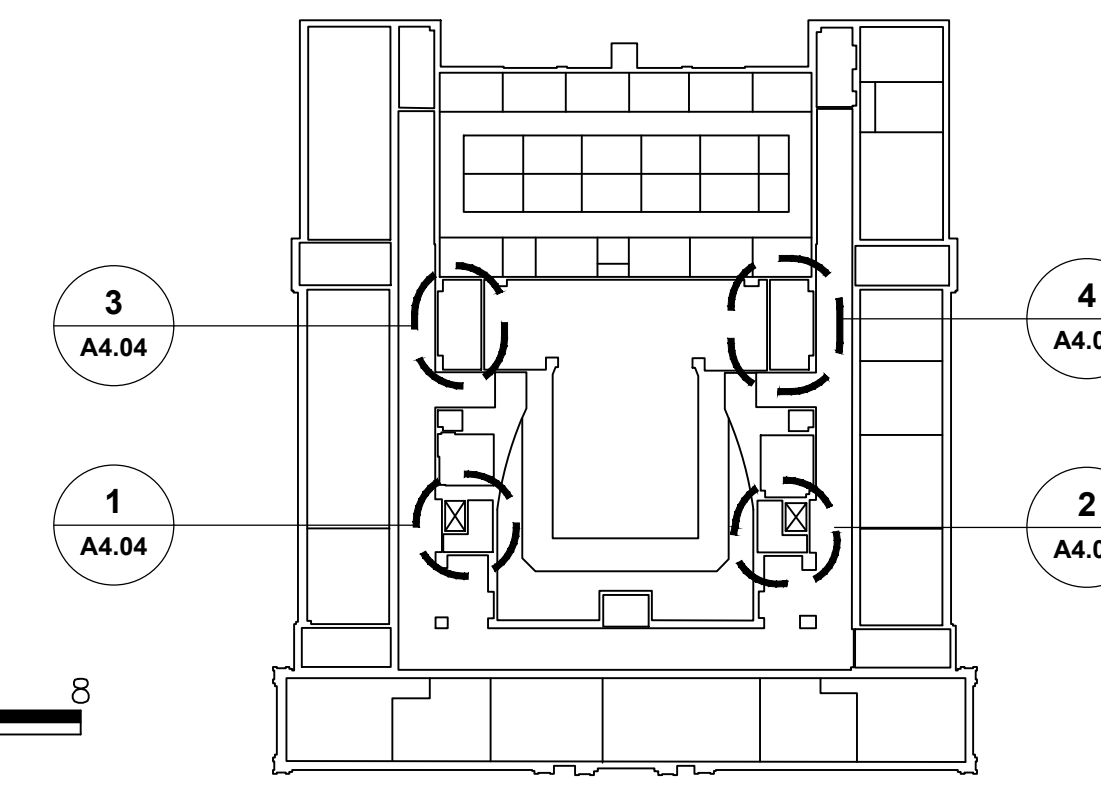

KEY PLAN


DEMOLITION KEY NOTES

- 1A REMOVE MASONRY WALL.
- 1B REMOVE STUD AND GYP BD WALL.
- 2A REMOVE DOOR AND FRAME.
- 2B REMOVE DOOR. EXISTING FRAME TO REMAIN.
- 3A REMOVE C.T. FLOOR.
- 3B REMOVE VCT FLOOR.
- 3C REMOVE CARPET.
- 4A REMOVE C.T. WAINSCOT AND BASE.
- 4B REMOVE VINYL BASE
- 5A REMOVE ACT CEILING.
- 6A REMOVE LAV.
- 6B REMOVE TOILET & TOILET PARTITION.
- 6C REMOVE URINAL AND URINAL SCREEN.

NEW WORK KEY NOTES


- 1C PROVIDE MASONRY WALL.
- 1D PROVIDE 1 HOUR RATED WALL, 3/8" METAL STUDS WITH 5/8" TYPE 'X' GYP. BOARD BOTH SIDES
- 1E PROVIDE 5/8" MOISTURE RESISTANT GYP BD ON EXISTING STUDS.
- 1F PROVIDE 3 3/8" METAL STUDS WITH 5/8" TYPE 'X' GYP. BOARD ONE SIDE
- 1G PROVIDE 3/8" METAL STUDS WITH 5/8" TYPE 'X' GYP. BOARD BOTH SIDES
- 2C PROVIDE WOOD DOOR AND HM FRAME.
- 2D PROVIDE WOOD DOOR IN EXISTING HM FRAME.
- 3D PROVIDE CT FLOOR AND CT BASE.
- 3E PROVIDE VCT AND RESILIENT BASE.
- 3F PROVIDE CARPET AND RESILIENT BASE.
- 3G EXISTING FLOORING TO REMAIN. (PROTECT DURING RENOVATION)
- 4C PROVIDE CT WAINSCOT AND BASE/ PAINT ABOVE
- 4D PREP AND PAINT WALLS
- 4E PROVIDE HORIZONTAL WINDOW BLINDS
- 5B PROVIDE ACT CEILING.
- 5C REMOVE & REINSTALL ACT CEILING AFTER MEP WORK IS COMPLETED.
- 5D PROVIDE GYPSUM BOARD CEILING/SOFFIT AND PAINT
- 5E PAINT EXISTING CEILING
- 6D PROVIDE LAV
- 6E PROVIDE TOILET & PARTITION
- 6F PROVIDE URINAL & SCREEN
- 7A REMOVE TACK BOARDS. INSTALL PROVIDED OR EXISTING BOARDS AFTER ALL CORRIDOR WORK HAS BEEN COMPLETED. COORDINATE LOCATIONS WITH OWNER.
- 7B REMOVE BULLETIN BOARD. INSTALL PROVIDED OR EXISTING BOARDS AFTER ALL CORRIDOR WORK HAS BEEN COMPLETED. COORDINATE LOCATIONS WITH OWNER.
- 7C EXISTING DISPLAY CASES TO REMAIN IN PLACE. PAINT INTERIOR TO MATCH CORRIDOR COLOR. PAINT TRIM TO MATCH DOOR TRIM COLOR.

| | | | |
|---|---------|---|---|
| drawing title SECOND FLOOR - PARTIAL PLANS AT STORAGE ROOMS | | STATE OF CONNECTICUT DEPARTMENT OF ADMINISTRATIVE SERVICES | |
| REVISIONS | | drawing prepared by AMES & WHITAKER ARCHITECTS 31 LIBERTY STREET SOUTHINGTON, CT | |
| mark | date | description | date |
| | 8/4/17 | SCHEMATIC DESIGN SUBMISSION | 07/25/18 |
| | 1/15/18 | DESIGN DEVELOPMENT SUBMISSION | scale AS NOTED |
| | 4/16/18 | CONSTRUCTION DOCUMENTS | project WESTERN CT STATE UNIVERSITY WHITE HALL 2ND AND 3RD FLOOR RENOVATIONS DANBURY, CONNECTICUT |
| | 5/23/18 | | drawn by CA/SP |
| | 7/25/18 | | approved by AL |
| | 1/21/19 | | drawing no. A4.04 |
| CAD no. | | project no. BI-RD-299 | |

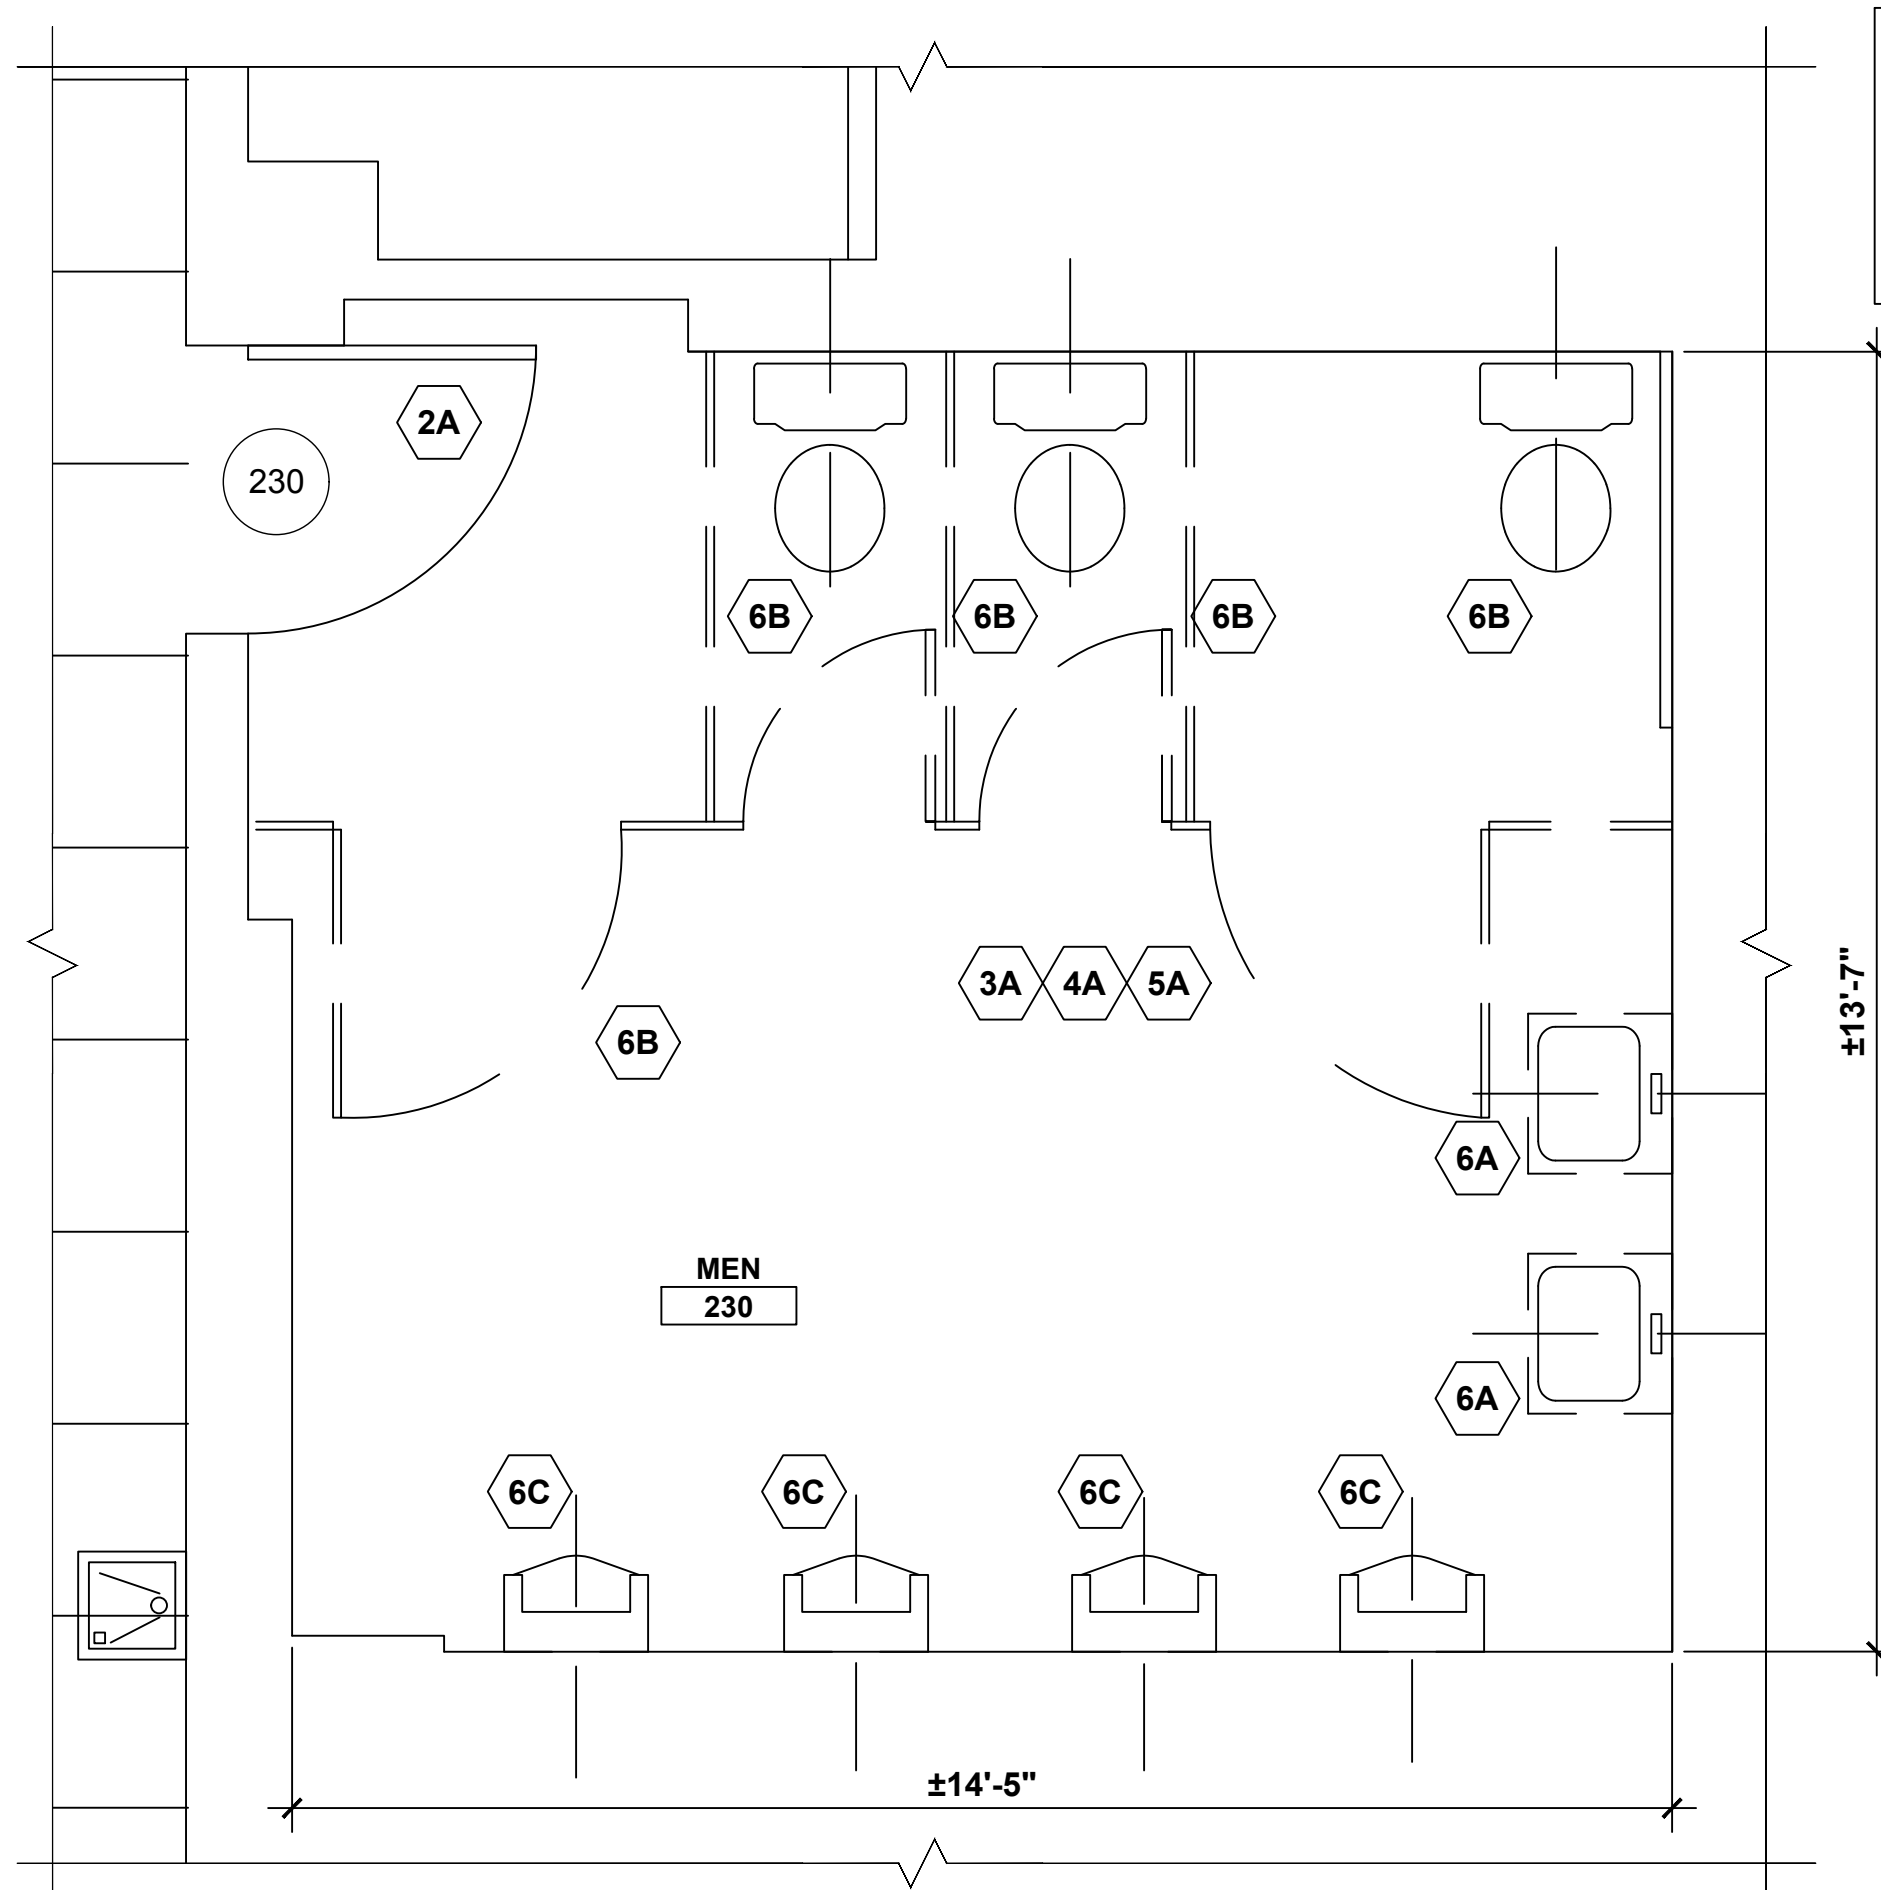


1 MEN'S TOILET ROOM 230 DEMO PLAN

GENERAL DEMO NOTE:
REMOVE PORTIONS OF CHASE WALL AS REQUIRED FOR REMOVAL AND INSTALLATION OF FIXTURES. COORDINATE WITH MEP DWGS.

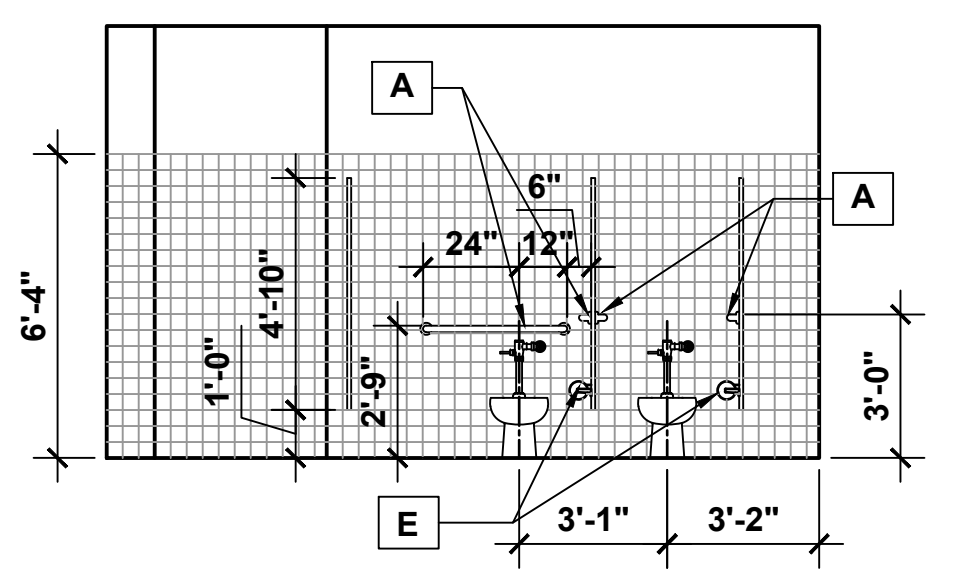


3 MEN'S TOILET ROOM 230 NORTH ELEVATION

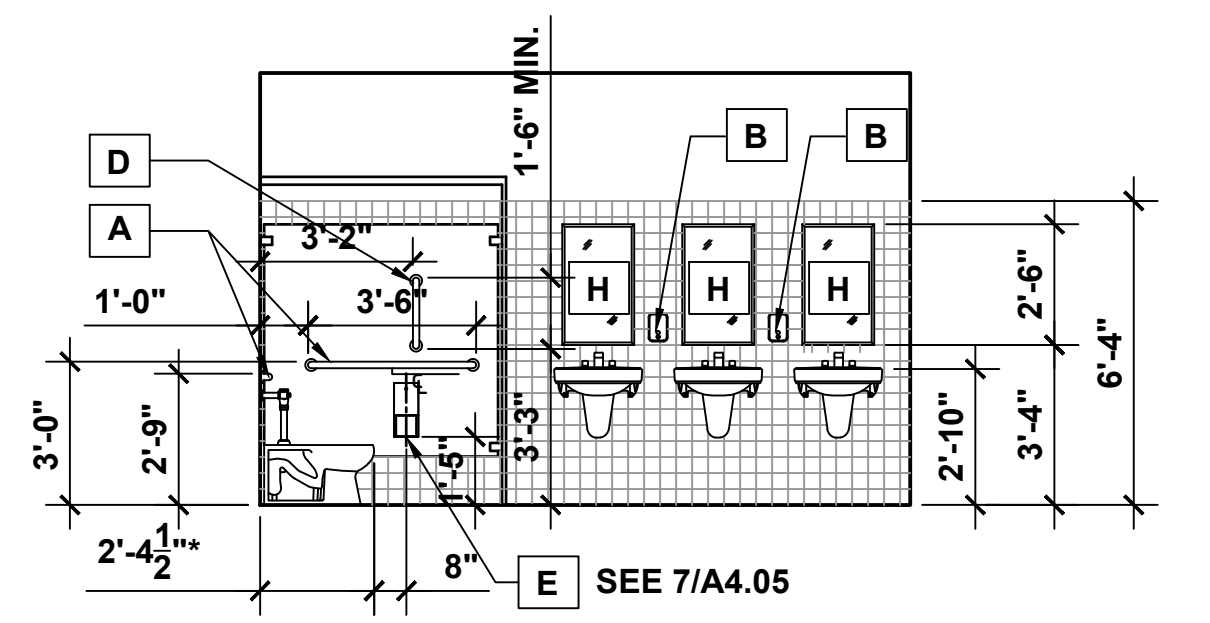


4 MEN'S TOILET ROOM 230 EAST ELEVATION


* WATER CLOSET BASIS OF DESIGN: KOHLER K-4386-0
SEE PLUMBING FIXTURE SCHEDULE, DWG P3.00

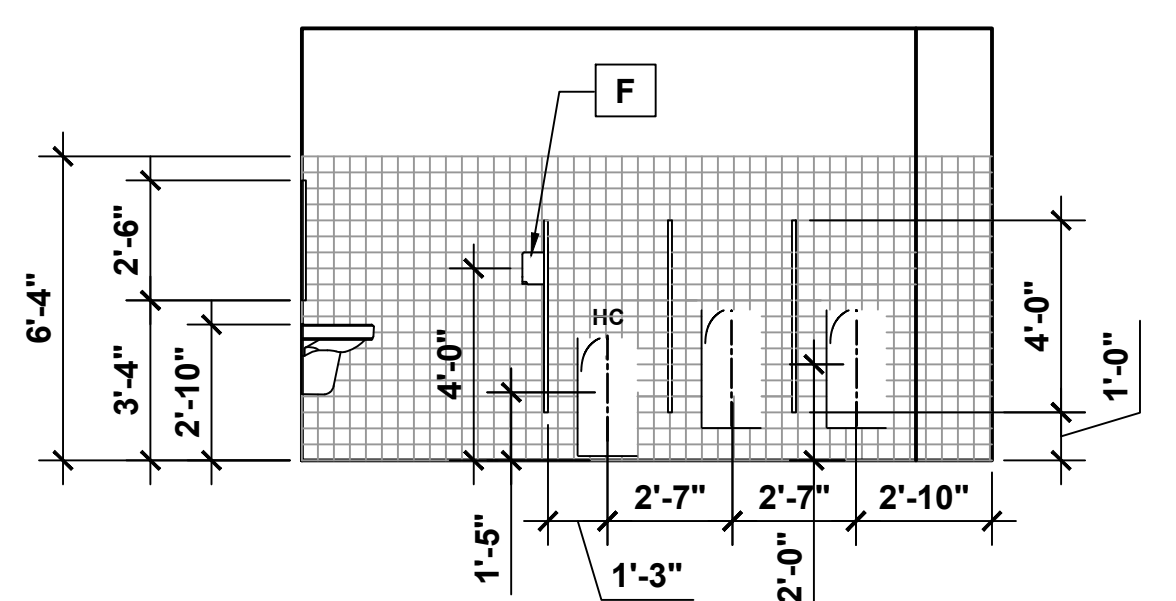

5 MEN'S TOILET ROOM 230 SOUTH ELEVATION

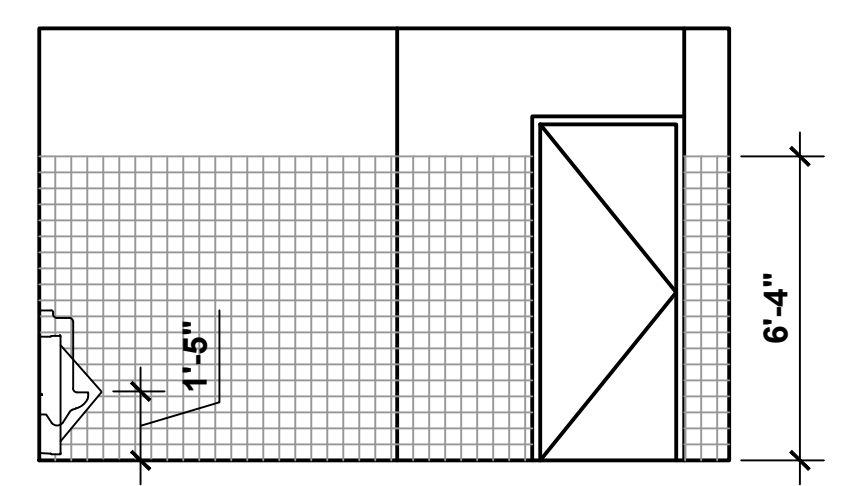

6 MEN'S TOILET ROOM 230 WEST ELEVATION

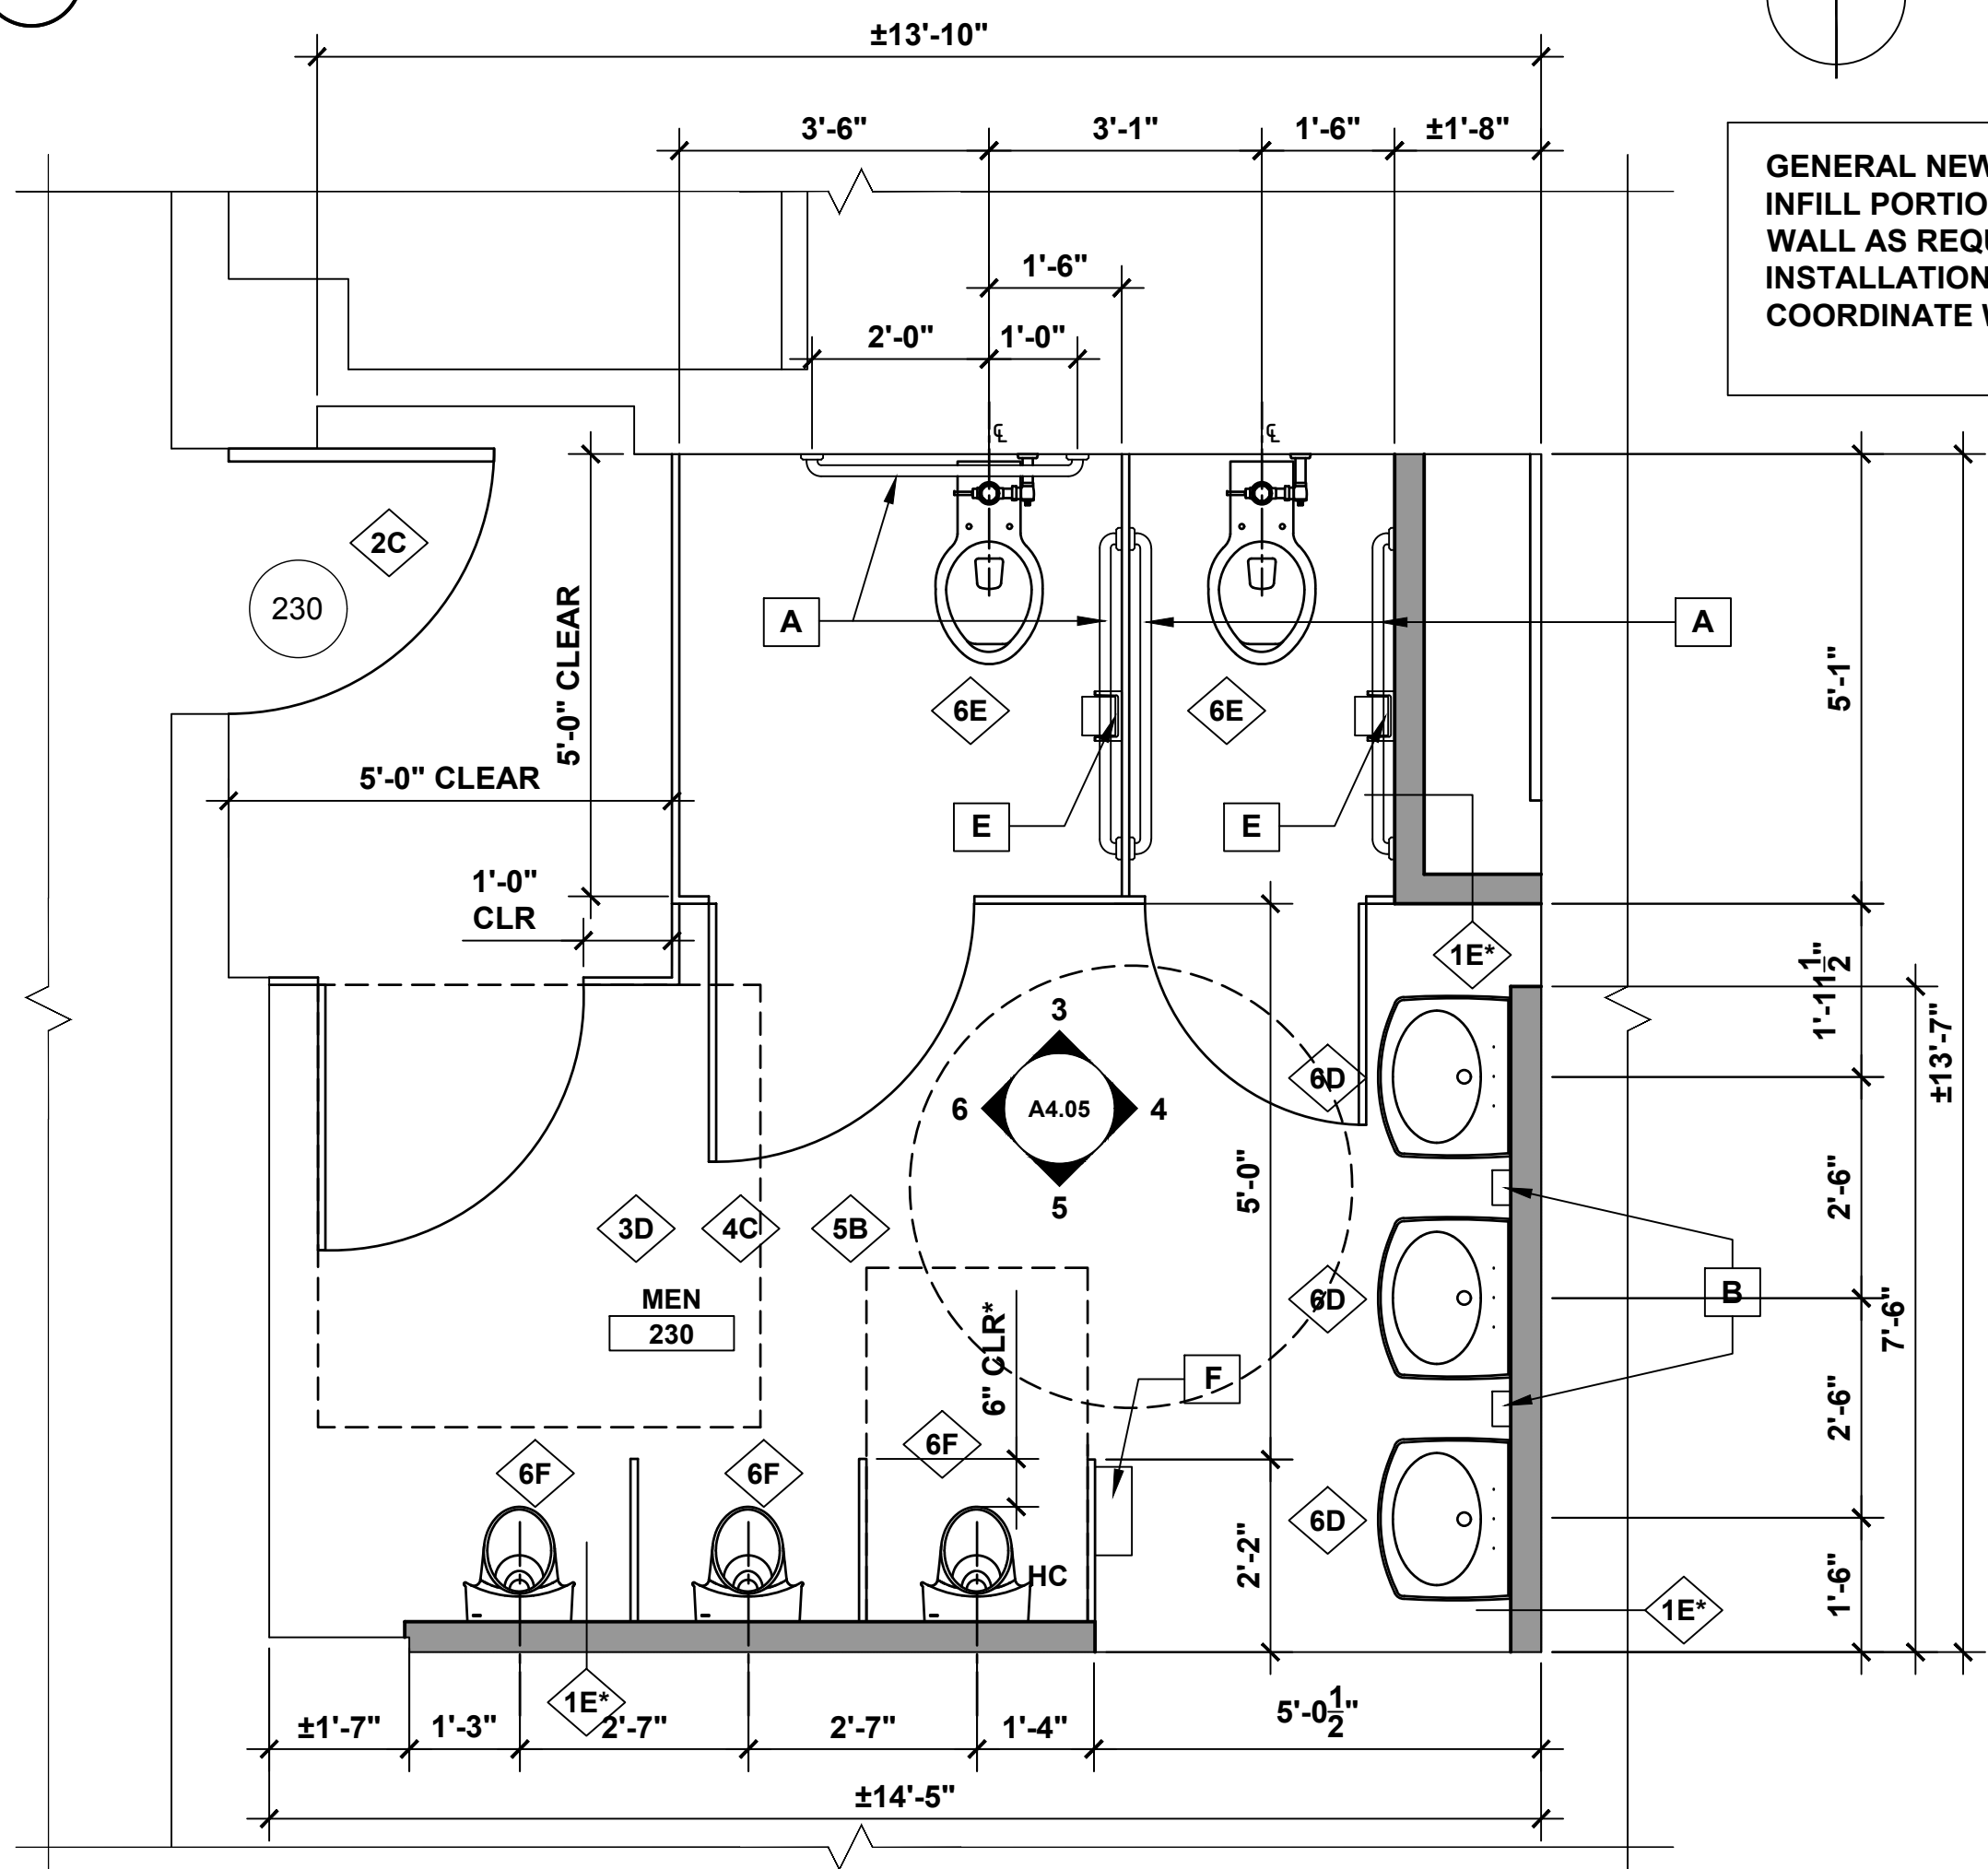


2 MEN'S TOILET ROOM 230 NEW WORK PLAN

GENERAL NEW WORK NOTE:
INFILL PORTIONS OF CHASE WALL AS REQUIRED FOR INSTALLATION OF FIXTURES. COORDINATE WITH MEP DWGS.


*LAVATORY BASIS OF DESIGN:
KOHLER 2035-4
SEE PLUMBING FIXTURE SCHEDULE, DWG P3.00

*URINAL BASIS OF DESIGN:
KOHLER K-4918-0
SEE PLUMBING FIXTURE SCHEDULE, DWG P3.00

- TOILET ACCESSORY KEYNOTES**
- A GRAB BARS - 36" & 42" LENGTHS MOUNTING HEIGHTS AT 33" AND 36" TO TOP OF GRIPPING SURFACE
 - B WALL MOUNTED SOAP DISPENSER MOUNTING HEIGHT - 42" TO CENTER OF NOZZLE, 48" AFF TO CONTROLS MAX. - OWNER SUPPLIED, INSTALLED BY CONTRACTOR
 - C TRASH RECEPTACLE FREE STANDING - BY OWNER
 - D VERTICAL GRAB BAR MOUNTING HEIGHT - 39" TO BOTTOM OF GRAB BAR
 - E TOILET PAPER DISPENSER MOUNTING HEIGHT - 17" TO OUTLET OF DISPENSER AFF - 29" TO TOP OF DISPENSER MAX. - OWNER SUPPLIED, INSTALLED BY CONTRACTOR
 - F PAPER TOWEL DISPENSER MOUNTING HEIGHT - 48" AT CENTER OF DISPENSED AREA; 48" AFF TO CONTROLS MAX. - OWNER SUPPLIED, INSTALLED BY CONTRACTOR
 - G SANITARY NAPKIN RECEPTACLE MOUNTING HEIGHT - 29" AT TOP OF RECEPTACLE - OWNER SUPPLIED, INSTALLED BY CONTRACTOR
 - H LAVATORY MIRROR - SIZE: 18"x30" MOUNTING HEIGHT - 40" TO BOTTOM OF MIRROR

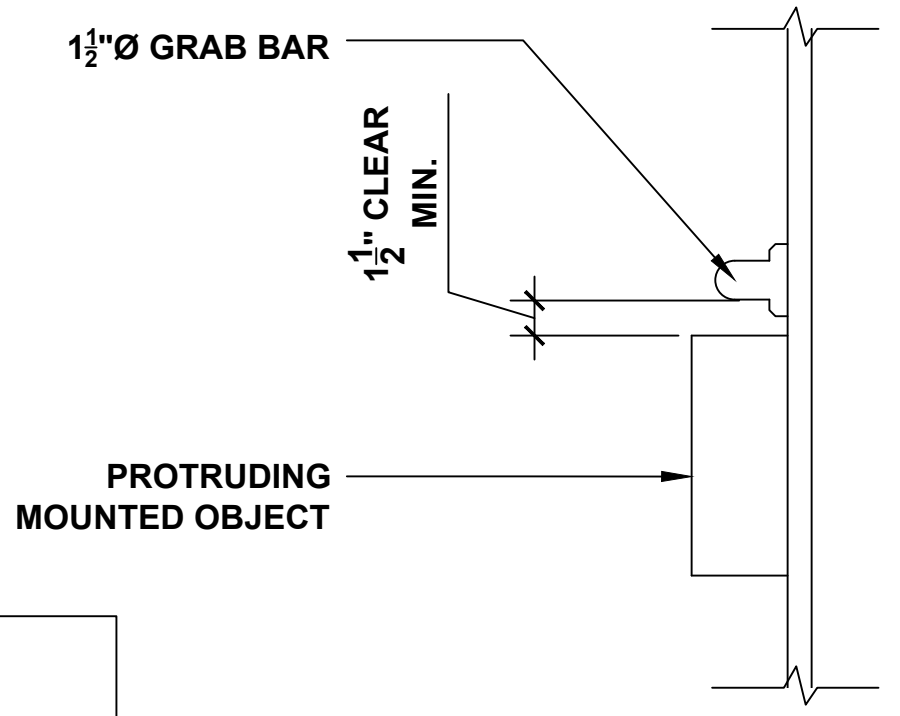

7 DETAIL AT GRAB BARS

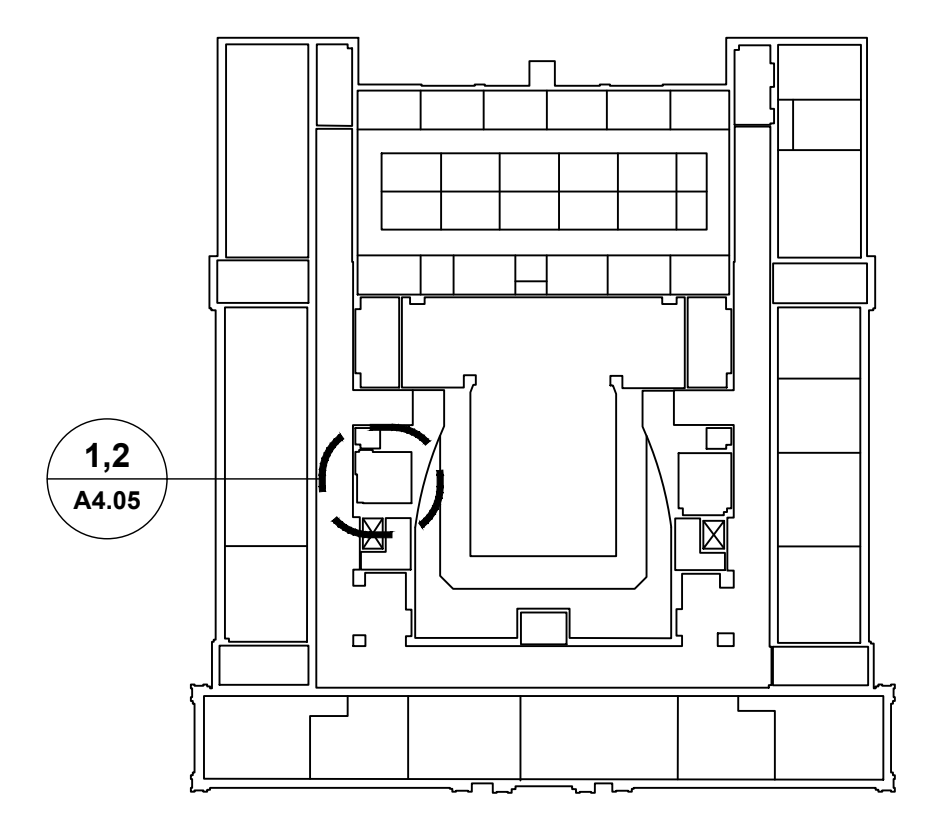


KEY PLAN

- DEMOLITION KEY NOTES**
- 1A REMOVE MASONRY WALL.
 - 1B REMOVE STUD AND GYP BD WALL.
 - 2A REMOVE DOOR AND FRAME.
 - 2B REMOVE DOOR, EXISTING FRAME TO REMAIN.
 - 3A REMOVE C.T. FLOOR.
 - 3B REMOVE VCT FLOOR.
 - 3C REMOVE CARPET.
 - 4A REMOVE C.T. WAINSCOT AND BASE.
 - 4B REMOVE VINYL BASE
 - 5A REMOVE ACT CEILING.
 - 6A REMOVE LAV.
 - 6B REMOVE TOILET & TOILET PARTITION.
 - 6C REMOVE URINAL AND URINAL SCREEN.


- NEW WORK KEY NOTES**
- 1C PROVIDE MASONRY WALL.
 - 1D PROVIDE 1 HOUR RATED WALL, 3/8" METAL STUDS WITH 5/8" TYPE 'X' GYP. BOARD BOTH SIDES
 - 1E PROVIDE 5/8" MOISTURE RESISTANT GYP BD ON EXISTING STUDS.
 - 1F PROVIDE 3/8" METAL STUDS WITH 5/8" TYPE 'X' GYP. BOARD ONE SIDE
 - 1G PROVIDE 3/8" METAL STUDS WITH 5/8" TYPE 'X' GYP. BOARD BOTH SIDES
 - 2C PROVIDE WOOD DOOR AND HM FRAME.
 - 2D PROVIDE WOOD DOOR IN EXISTING HM FRAME.
 - 3D PROVIDE CT FLOOR AND CT BASE.
 - 3E PROVIDE VCT AND RESILIENT BASE.
 - 3F PROVIDE CARPET AND RESILIENT BASE.
 - 3G EXISTING FLOORING TO REMAIN. (PROTECT DURING RENOVATION)
 - 4C PROVIDE CT WAINSCOT AND BASE/ PAINT ABOVE
 - 4D PREP AND PAINT WALLS
 - 4E PROVIDE HORIZONTAL WINDOW BLINDS
 - 5B PROVIDE ACT CEILING.
 - 5C REMOVE & REINSTALL ACT CEILING AFTER MEP WORK IS COMPLETED.
 - 5D PROVIDE GYPSUM BOARD CEILING/SOFFIT AND PAINT
 - 5E PAINT EXISTING CEILING
 - 6D PROVIDE LAV
 - 6E PROVIDE TOILET & PARTITION
 - 6F PROVIDE URINAL & SCREEN
 - 7A REMOVE TACK BOARDS. INSTALL PROVIDED OR EXISTING BOARDS AFTER ALL CORRIDOR WORK HAS BEEN COMPLETED. COORDINATE LOCATIONS WITH OWNER.
 - 7B REMOVE BULLETIN BOARD. INSTALL PROVIDED OR EXISTING BOARDS AFTER ALL CORRIDOR WORK HAS BEEN COMPLETED. COORDINATE LOCATIONS WITH OWNER.
 - 7C EXISTING DISPLAY CASES TO REMAIN IN PLACE. PAINT INTERIOR TO MATCH CORRIDOR COLOR. PAINT TRIM TO MATCH DOOR TRIM COLOR.

| | | | |
|---|--------------------------|---|---|
| drawing title SECOND FLOOR - MEN'S TOILET ROOM | | STATE OF CONNECTICUT DEPARTMENT OF ADMINISTRATIVE SERVICES | |
| REVISIONS | | drawing prepared by AMES & WHITAKER ARCHITECTS | |
| mark | date | description | date |
| | 8/4/17 | SCHEMATIC DESIGN SUBMISSION | 07/25/18 |
| | 1/15/18 | DESIGN DEVELOPMENT SUBMISSION | scale AS NOTED |
| | 4/16/18 | CONSTRUCTION DOCUMENTS | project WESTERN CT STATE UNIVERSITY WHITE HALL 2ND AND 3RD FLOOR RENOVATIONS DANBURY, CONNECTICUT |
| | 5/23/18 | | drawn by CA/SP |
| | 7/25/18 | | approved by AL |
| CAD no. | project no. BI-RD-299 | | drawing no. A4.05 |

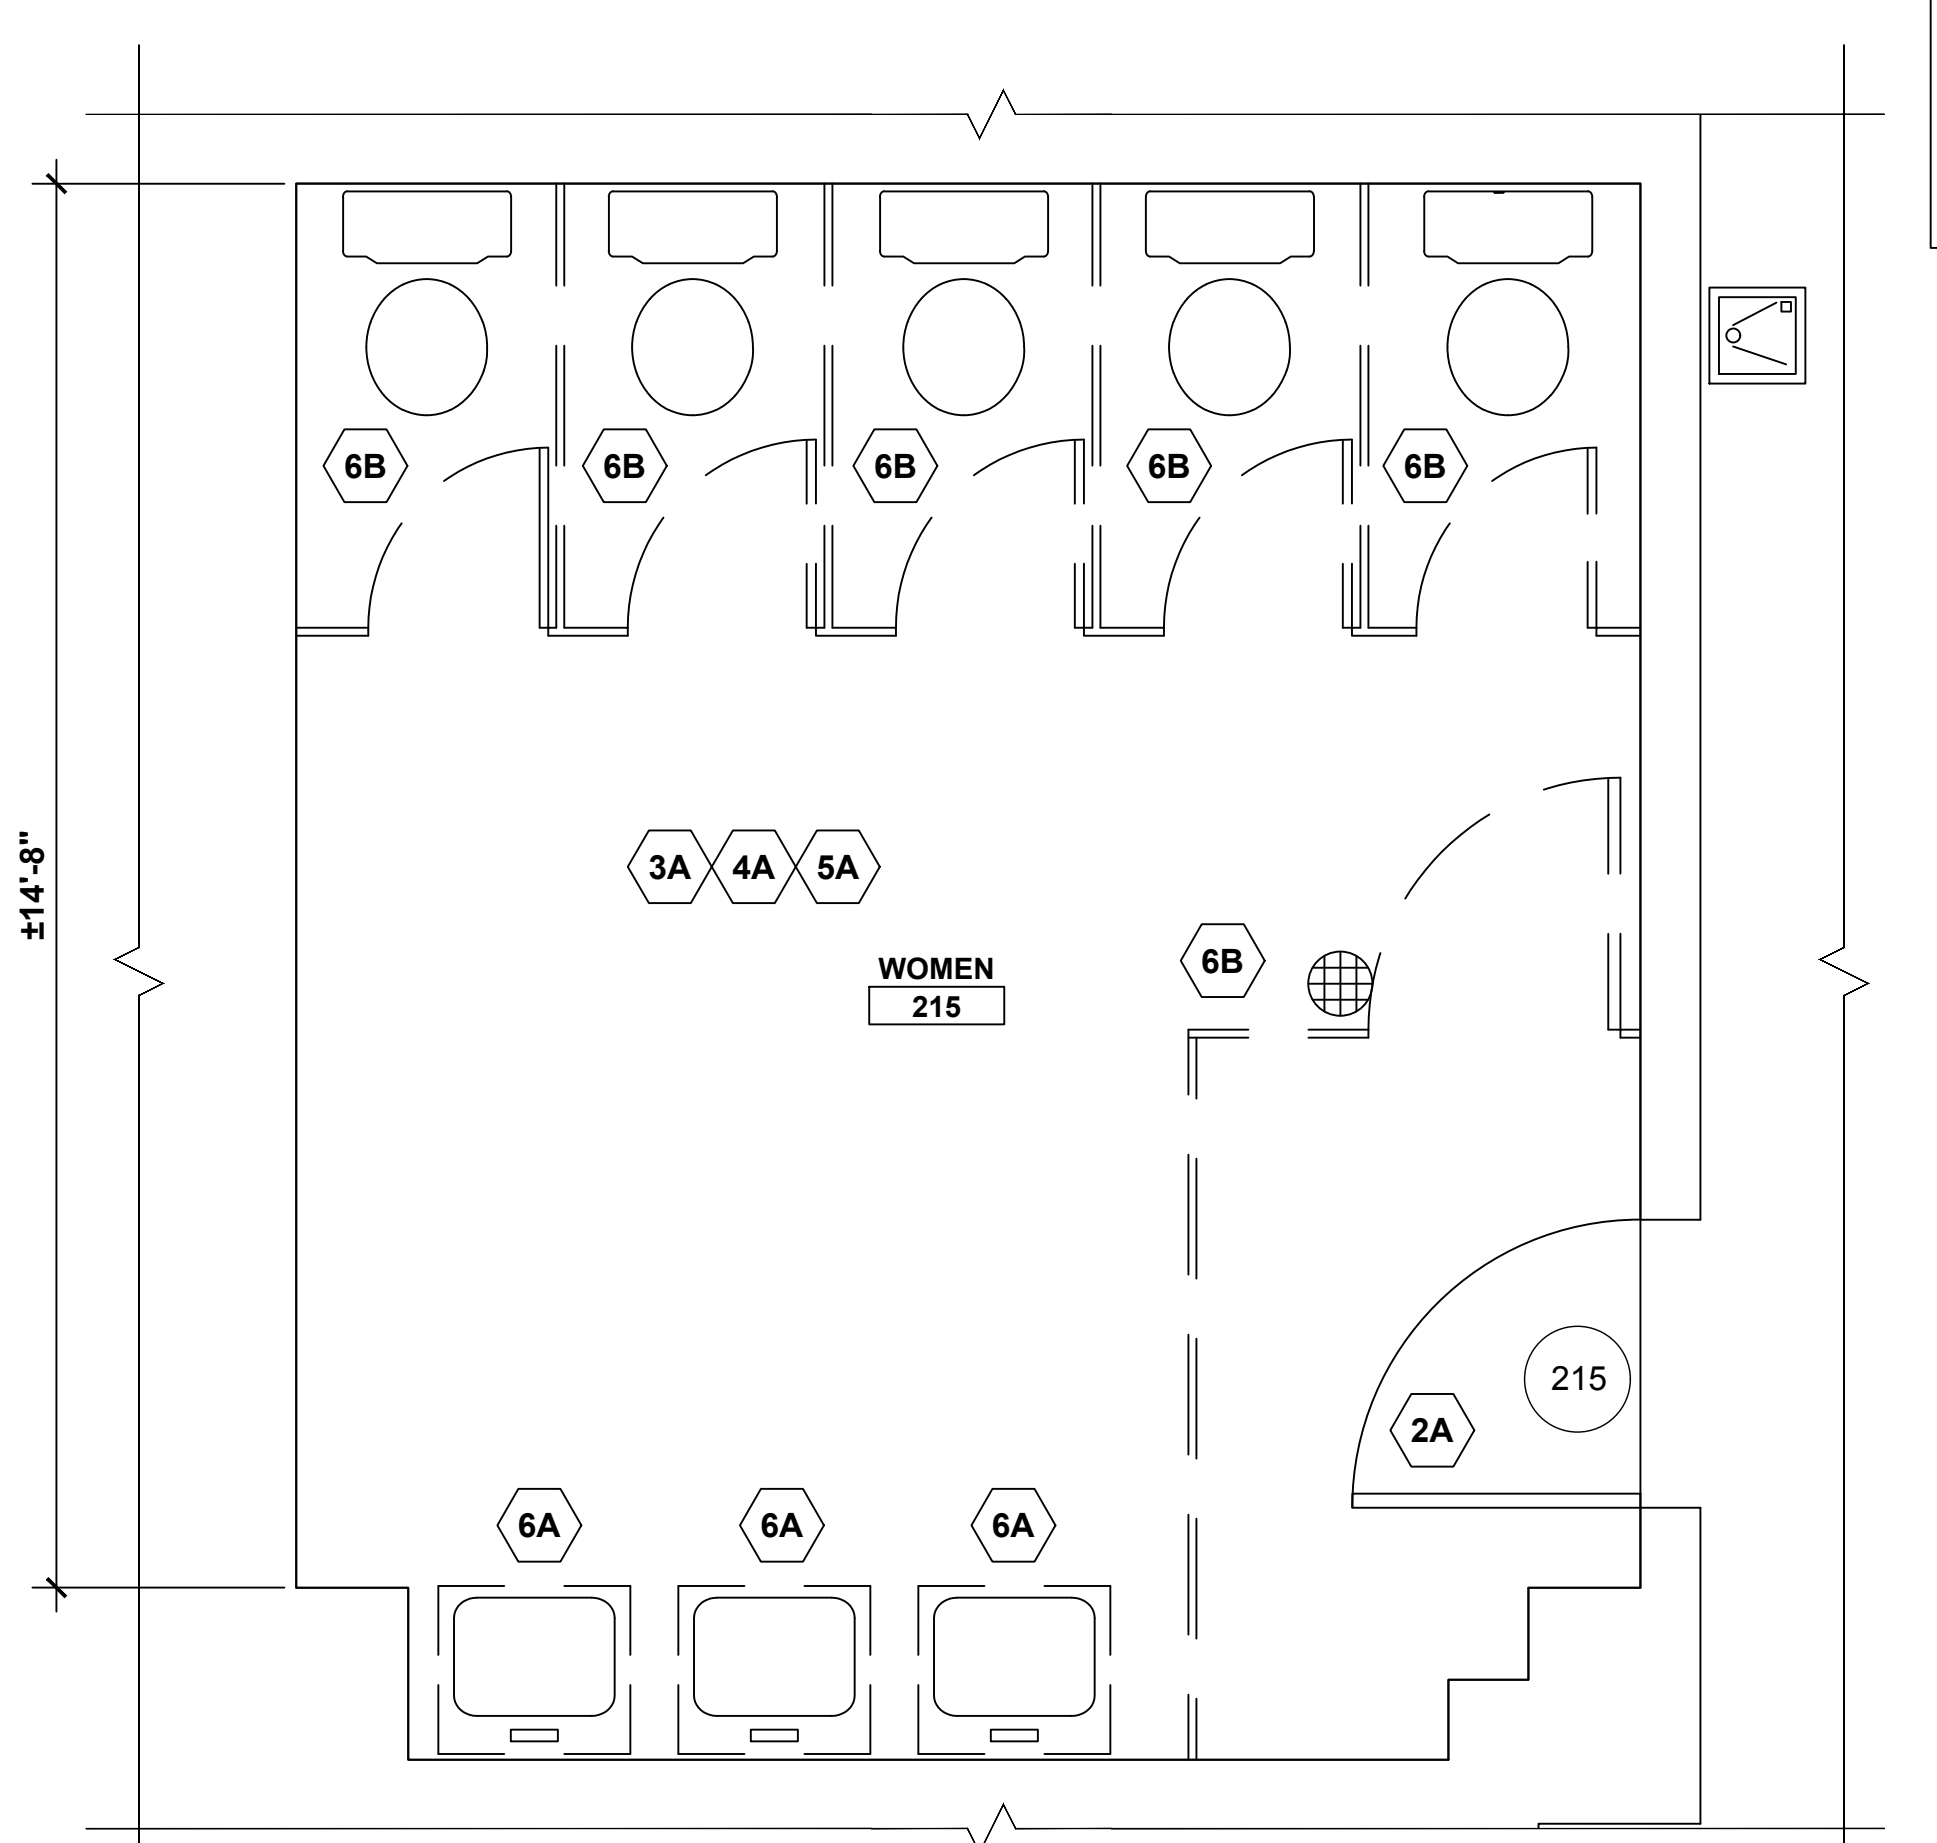


1 WOMEN'S TOILET ROOM 215 DEMO PLAN


GENERAL DEMO NOTE:
REMOVE PORTIONS OF CHASE WALL AS REQUIRED FOR REMOVAL AND INSTALLATION OF FIXTURES. COORDINATE WITH MEP DWGS.

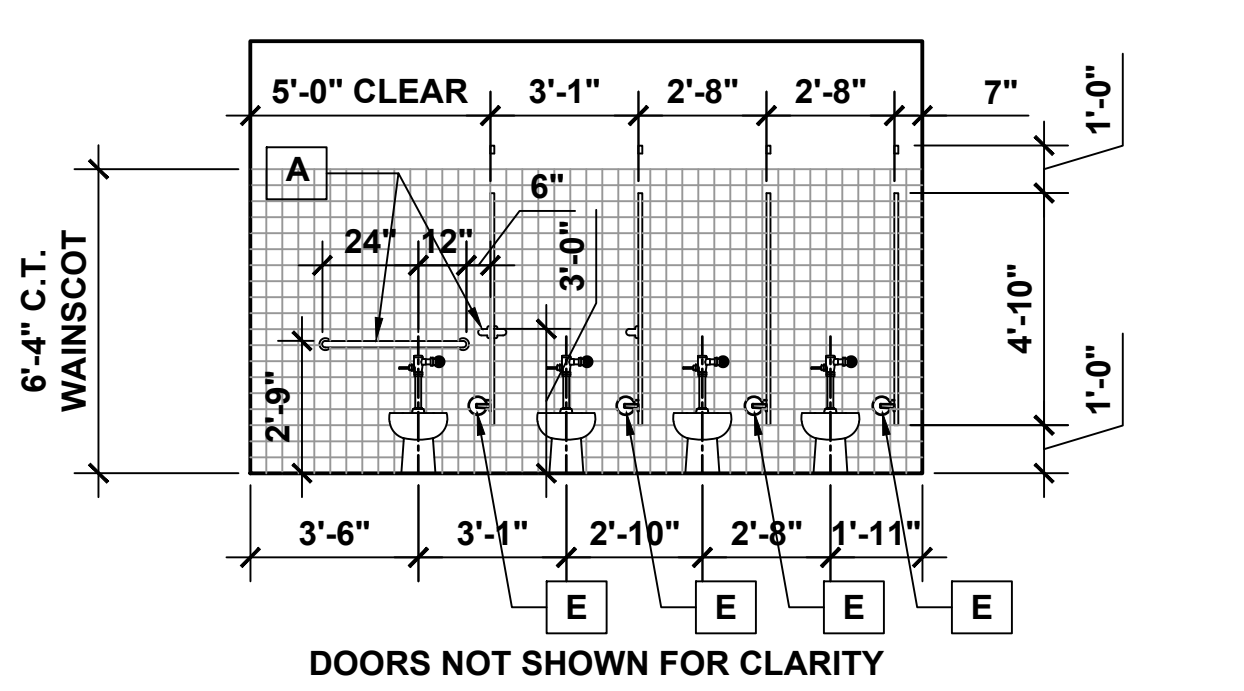


3 WOMEN'S TOILET ROOM 215 NORTH ELEVATION

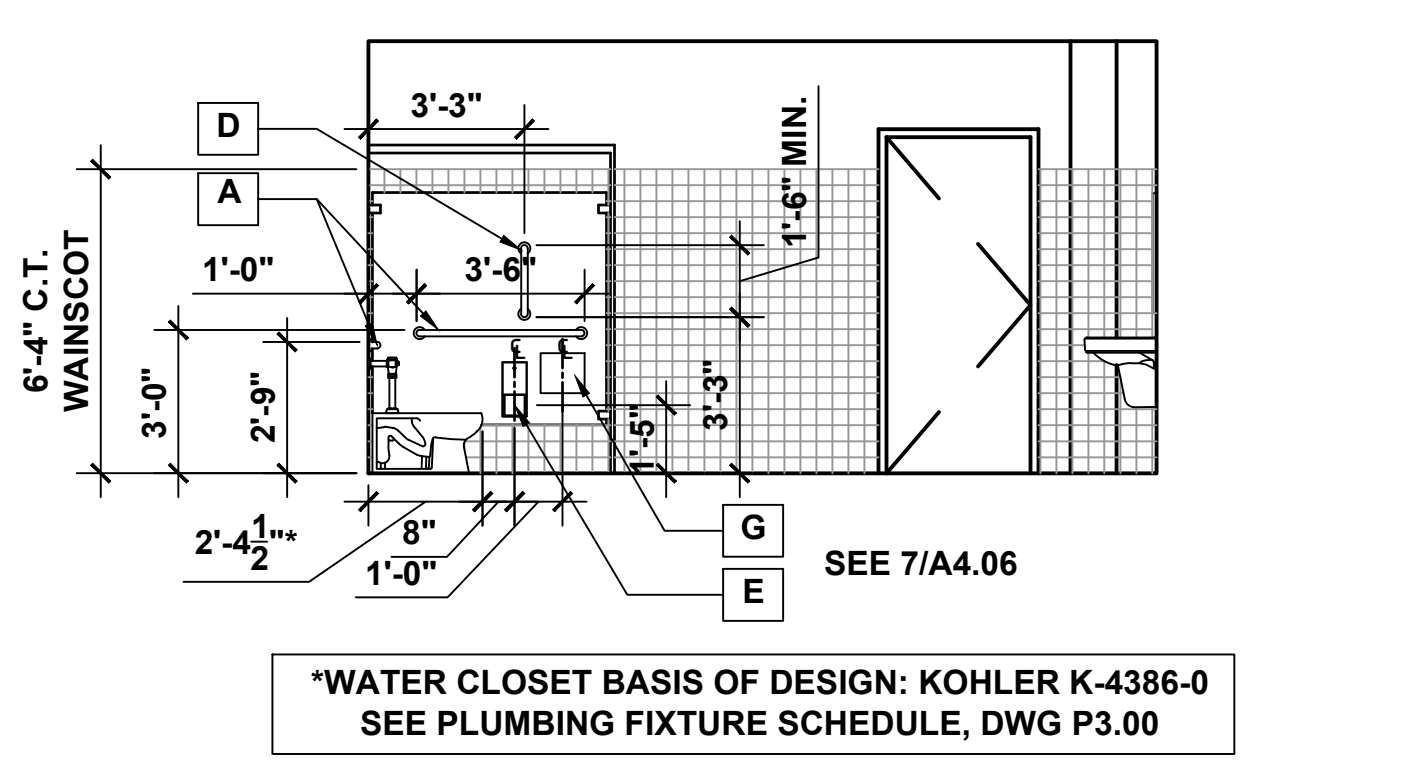


4 WOMEN'S TOILET ROOM 215 EAST ELEVATION

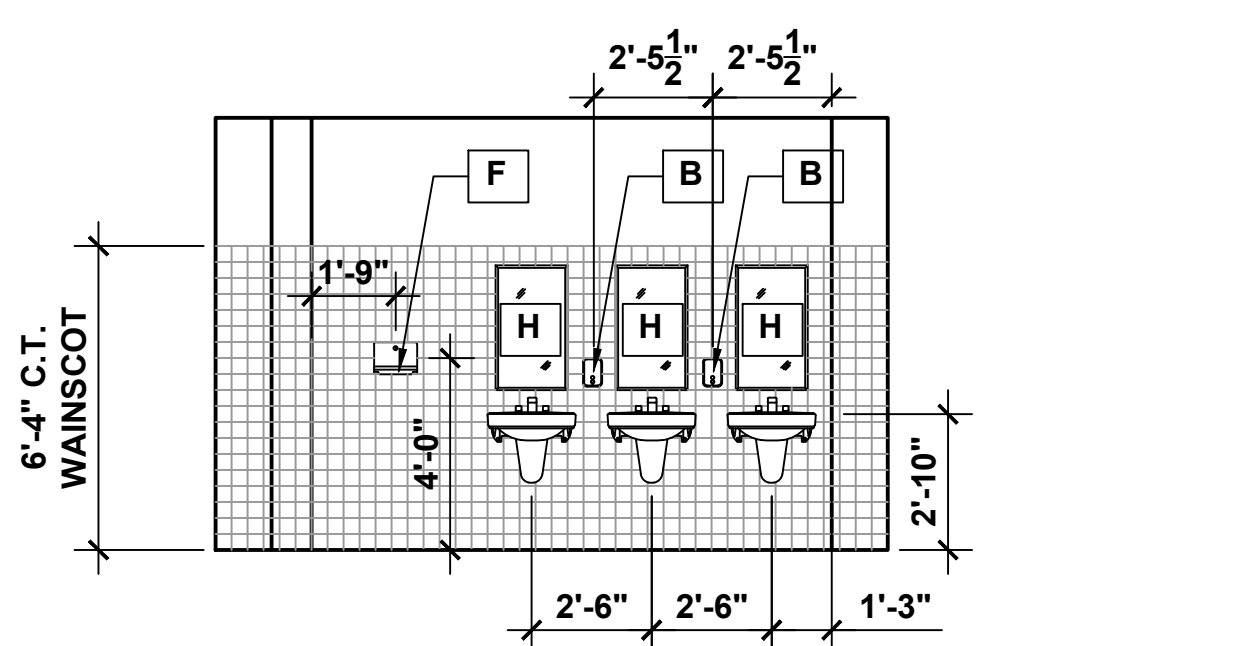

5 WOMEN'S TOILET ROOM 215 SOUTH ELEVATION

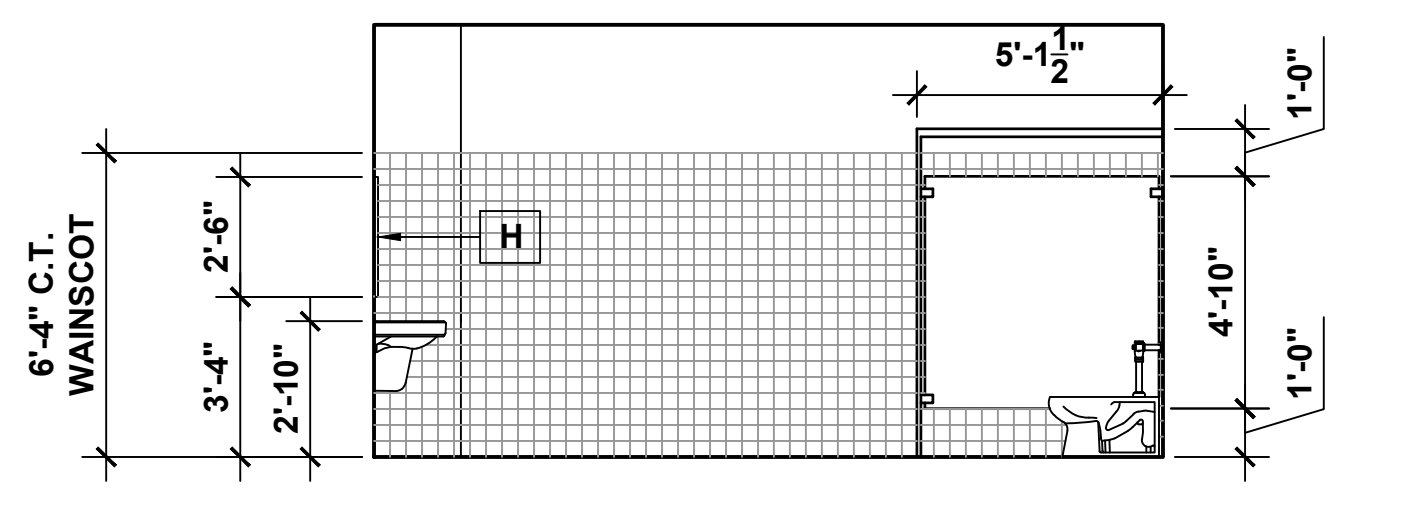

6 WOMEN'S TOILET ROOM 215 WEST ELEVATION

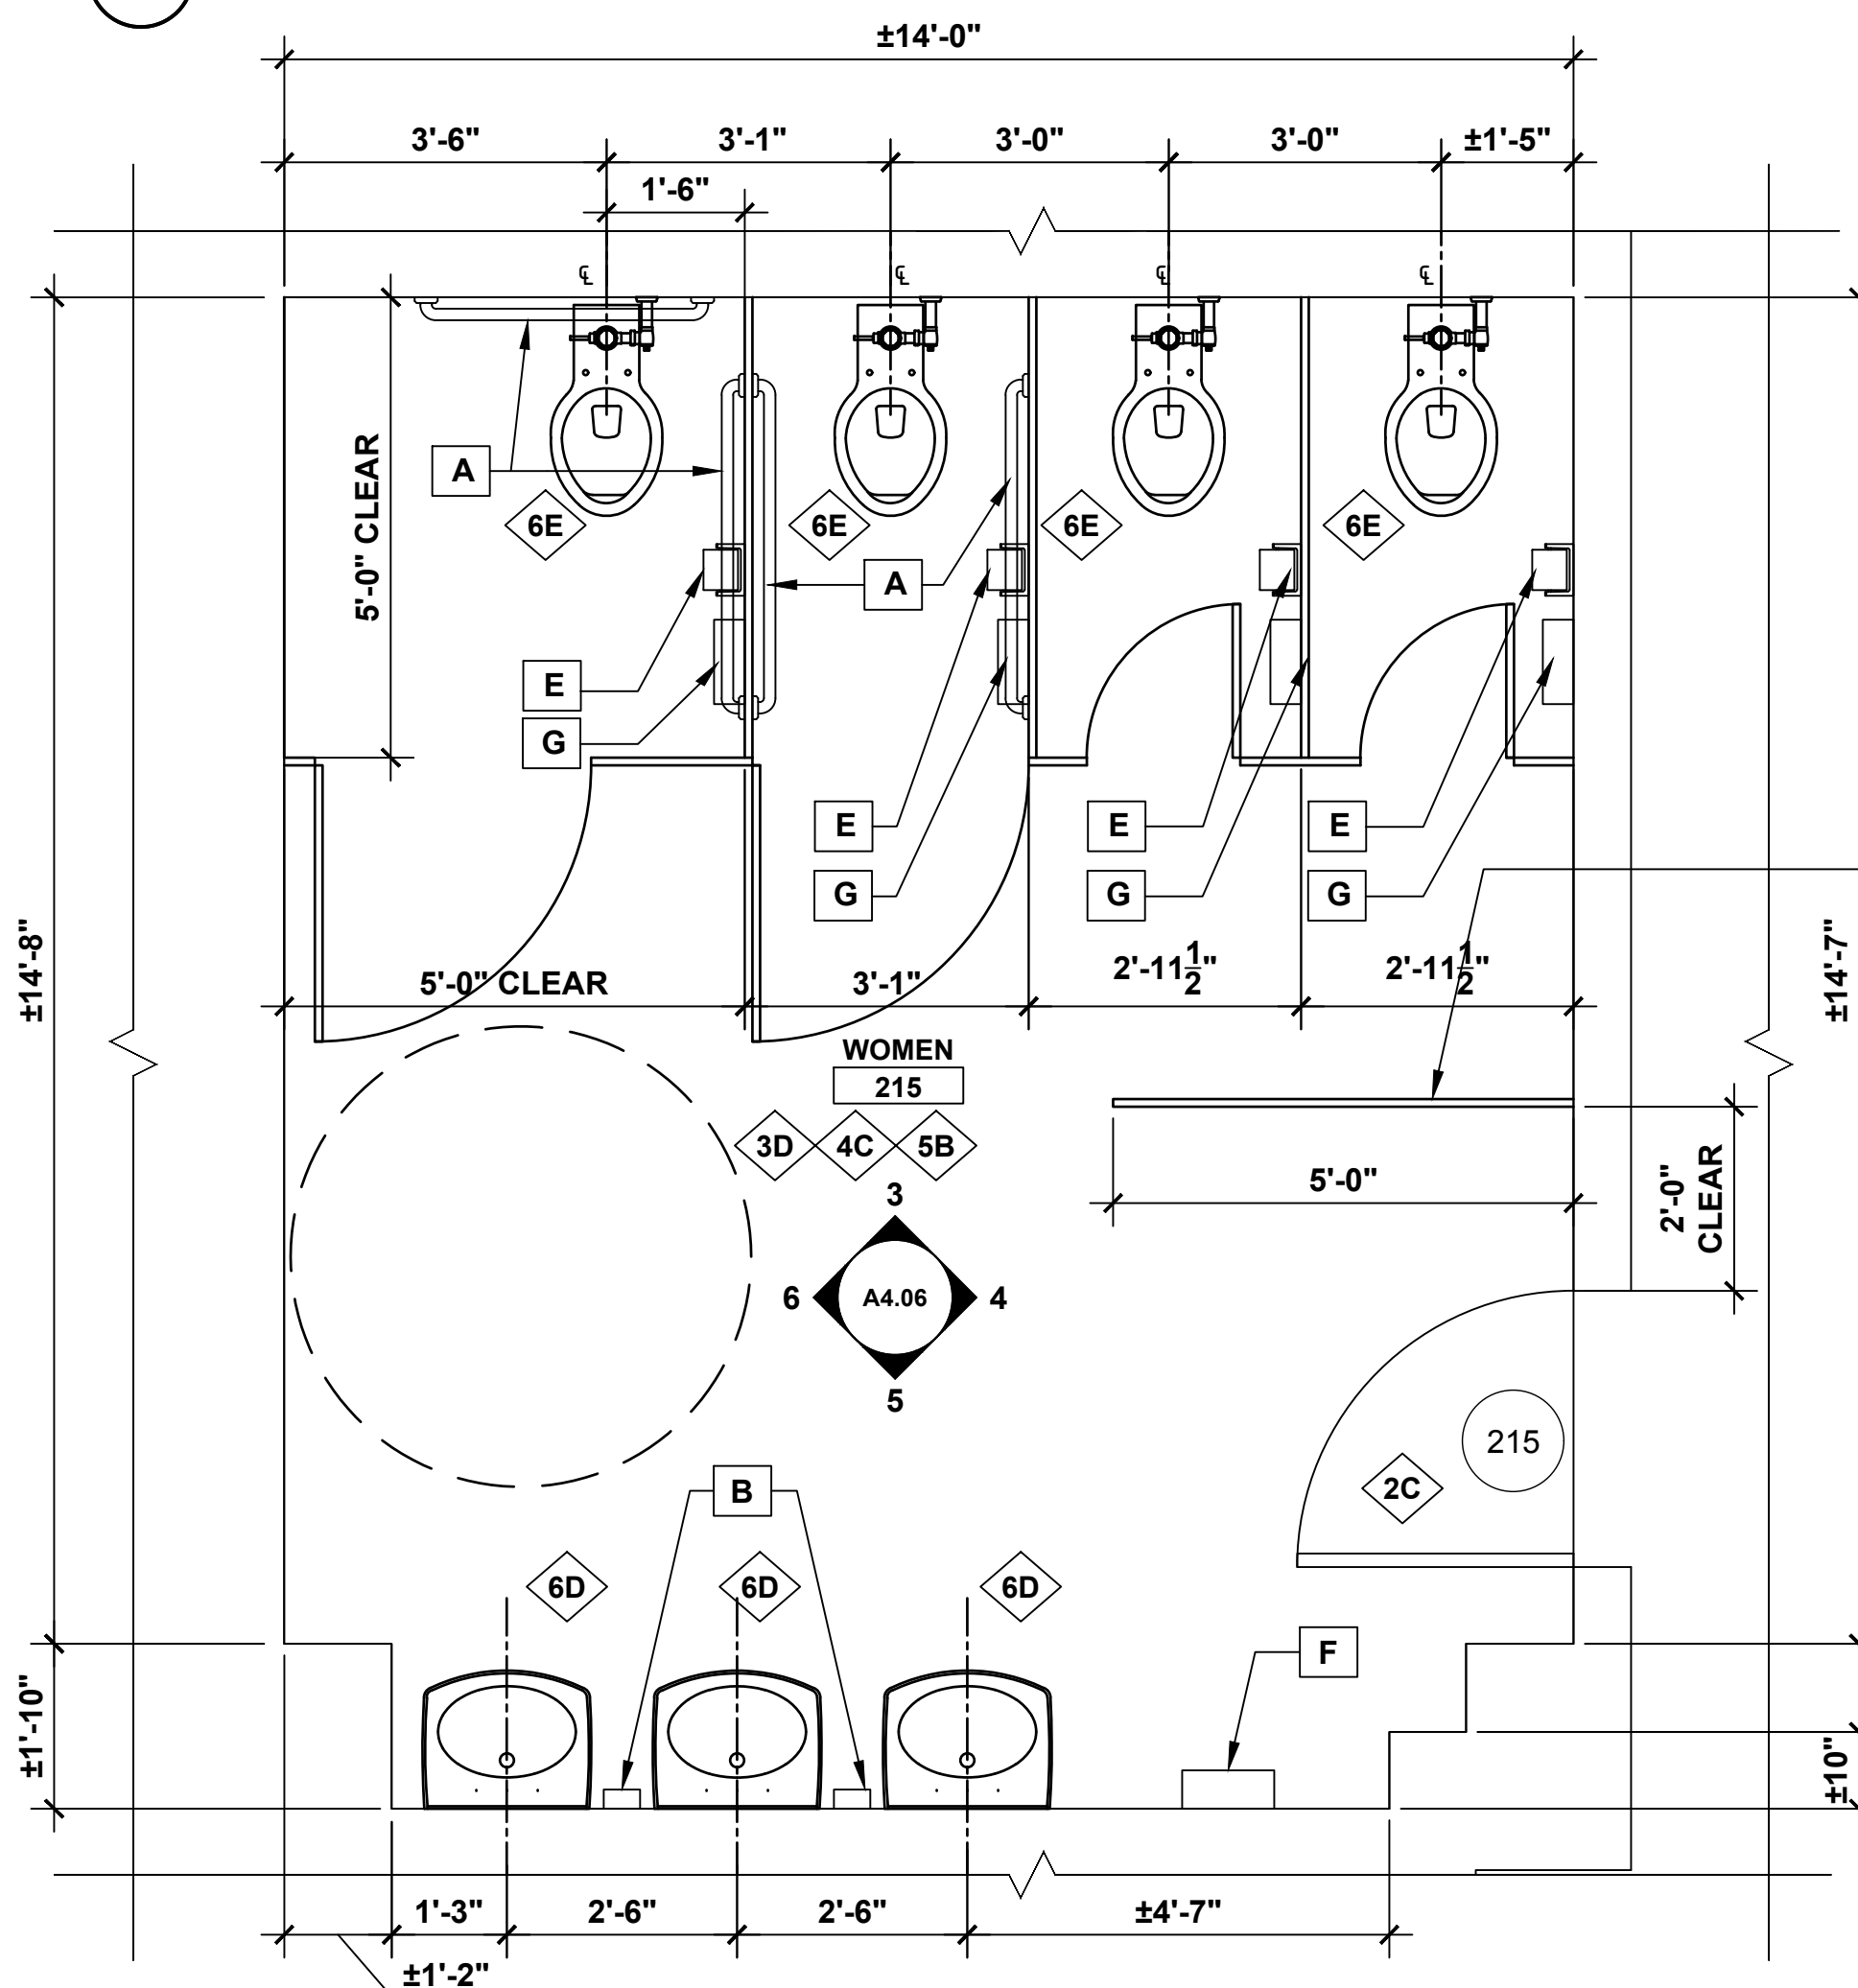


2 WOMEN'S TOILET ROOM 215 NEW WORK PLAN


GENERAL NEW WORK NOTE:
INFILL PORTIONS OF CHASE WALL AS REQUIRED FOR INSTALLATION OF FIXTURES. COORDINATE WITH MEP DWGS.

*LAVATORY BASIS OF DESIGN:
KOHLER 2035-4
SEE PLUMBING FIXTURE SCHEDULE, DWG P3.00

- TOILET ACCESSORY KEYNOTES**
- A GRAB BARS- 36" & 42" LENGTHS MOUNTING HEIGHTS AT 33" AND 36" TO TOP OF GRIPPING SURFACE
 - B WALL MOUNTED SOAP DISPENSER MOUNTING HEIGHT - 42" TO CENTER OF NOZZLE, 48" AFF TO CONTROLS MAX. - OWNER SUPPLIED, INSTALLED BY CONTRACTOR
 - C TRASH RECEPTACLE FREE STANDING - BY OWNER
 - D VERTICAL GRAB BAR MOUNTING HEIGHT - 39" TO BOTTOM OF GRAB BAR
 - E TOILET PAPER DISPENSER MOUNTING HEIGHT - 17" TO OUTLET OF DISPENSER AFF - 29" TO TOP OF DISPENSER MAX. - OWNER SUPPLIED, INSTALLED BY CONTRACTOR
 - F PAPER TOWEL DISPENSER MOUNTING HEIGHT-48" AT CENTER OF DISPENSED AREA;48" AFF TO CONTROLS MAX. - OWNER SUPPLIED, INSTALLED BY CONTRACTOR
 - G SANITARY NAPKIN RECEPTACLE MOUNTING HEIGHT - 29" AT TOP OF RECEPTACLE - OWNER SUPPLIED, INSTALLED BY CONTRACTOR
 - H LAVATORY MIRROR - SIZE: 18"x30" MOUNTING HEIGHT - 40" TO BOTTOM OF MIRROR

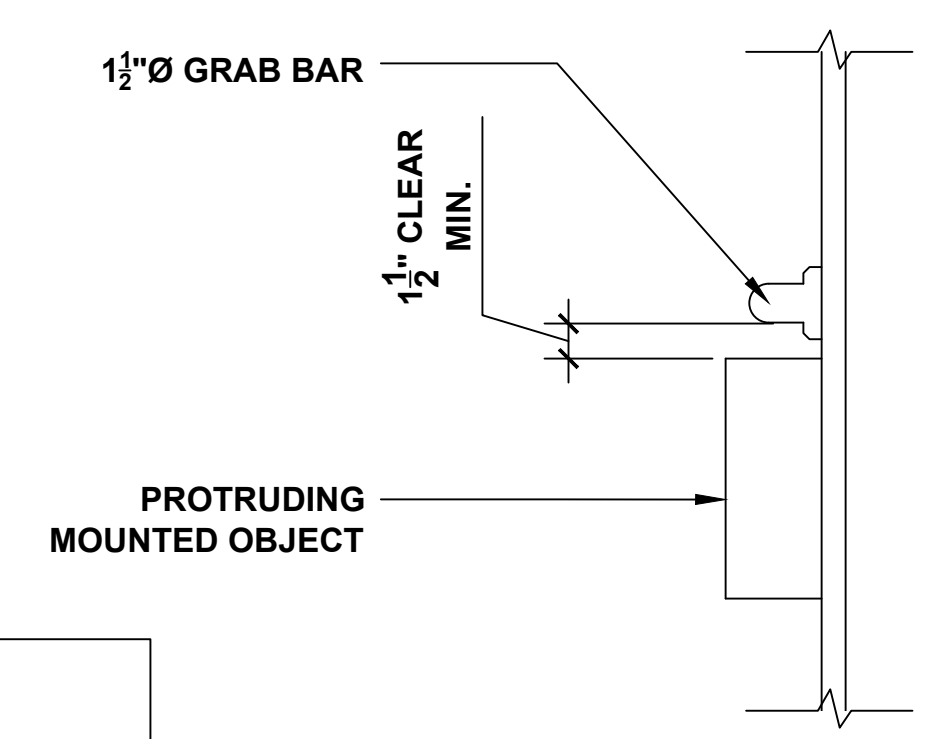

7 DETAIL AT GRAB BARS

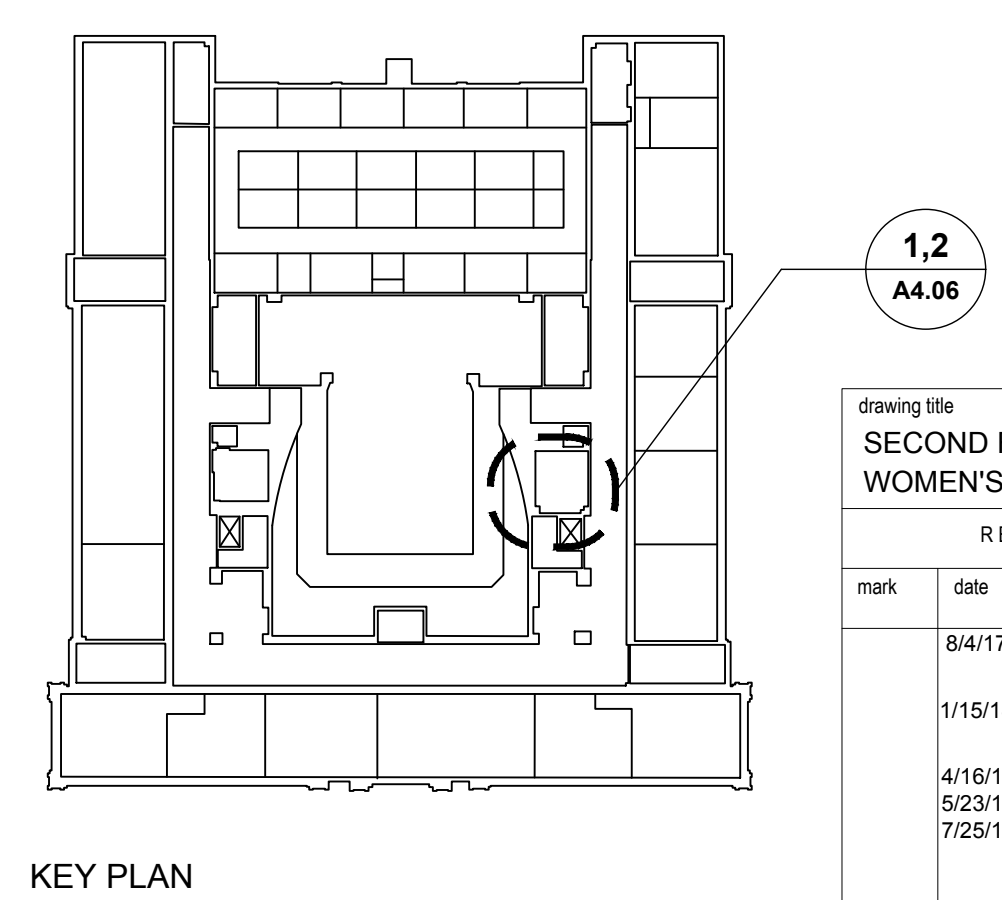




KEY PLAN

- DEMOLITION KEY NOTES**
- 1A REMOVE MASONRY WALL.
 - 1B REMOVE STUD AND GYP BD WALL.
 - 2A REMOVE DOOR AND FRAME.
 - 2B REMOVE DOOR. EXISTING FRAME TO REMAIN.
 - 3A REMOVE C.T. FLOOR.
 - 3B REMOVE VCT FLOOR.
 - 3C REMOVE CARPET.
 - 4A REMOVE C.T. WAINSCOT AND BASE.
 - 4B REMOVE VINYL BASE
 - 5A REMOVE ACT CEILING.
 - 6A REMOVE LAV.
 - 6B REMOVE TOILET & TOILET PARTITION.
 - 6C REMOVE URINAL AND URINAL SCREEN.

- NEW WORK KEY NOTES**
- 1C PROVIDE MASONRY WALL.
 - 1D PROVIDE 1 HOUR RATED WALL, 3/8" METAL STUDS WITH 5/8" TYPE 'X' GYP. BOARD BOTH SIDES
 - 1E PROVIDE 5/8" MOISTURE RESISTANT GYP BD ON EXISTING STUDS.
 - 1F PROVIDE 3 3/8" METAL STUDS WITH 5/8" TYPE 'X' GYP. BOARD ONE SIDE
 - 1G PROVIDE 3/8" METAL STUDS WITH 5/8" TYPE 'X' GYP. BOARD BOTH SIDES
 - 2C PROVIDE WOOD DOOR AND HM FRAME.
 - 2D PROVIDE WOOD DOOR IN EXISTING HM FRAME.
 - 3D PROVIDE CT FLOOR AND CT BASE.
 - 3E PROVIDE VCT AND RESILIENT BASE.
 - 3F PROVIDE CARPET AND RESILIENT BASE.
 - 3G EXISTING FLOORING TO REMAIN. (PROTECT DURING RENOVATION)
 - 4C PROVIDE CT WAINSCOT AND BASE/ PAINT ABOVE
 - 4D PREP AND PAINT WALLS
 - 4E PROVIDE HORIZONTAL WINDOW BLINDS
 - 5B PROVIDE ACT CEILING.
 - 5C REMOVE & REINSTALL ACT CEILING AFTER MEP WORK IS COMPLETED.
 - 5D PROVIDE GYPSUM BOARD CEILING/SOFFIT AND PAINT
 - 5E PAINT EXISTING CEILING
 - 6D PROVIDE LAV
 - 6E PROVIDE TOILET & PARTITION
 - 6F PROVIDE URINAL & SCREEN
 - 7A REMOVE TACK BOARDS. INSTALL PROVIDED OR EXISTING BOARDS AFTER ALL CORRIDOR WORK HAS BEEN COMPLETED. COORDINATE LOCATIONS WITH OWNER.
 - 7B REMOVE BULLETIN BOARD. INSTALL PROVIDED OR EXISTING BOARDS AFTER ALL CORRIDOR WORK HAS BEEN COMPLETED. COORDINATE LOCATIONS WITH OWNER.
 - 7C EXISTING DISPLAY CASES TO REMAIN IN PLACE. PAINT INTERIOR TO MATCH CORRIDOR COLOR. PAINT TRIM TO MATCH DOOR TRIM COLOR.

| drawing title | | STATE OF CONNECTICUT | |
|------------------------------------|---------|---------------------------------------|--|
| SECOND FLOOR - WOMEN'S TOILET ROOM | | DEPARTMENT OF ADMINISTRATIVE SERVICES | |
| REVISIONS | | | |
| mark | date | description | |
| | 8/4/17 | SCHEMATIC DESIGN SUBMISSION | |
| | 1/15/18 | DESIGN DEVELOPMENT SUBMISSION | |
| | 4/16/18 | CONSTRUCTION DOCUMENTS | |
| | 5/23/18 | | |
| | 7/25/18 | | |



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| drawing prepared by | date |
| AMES & WHITAKER ARCHITECTS | 07/25/18 |
| 31 LIBERTY STREET | scale |
| SOUTHINGTON, CT | AS NOTED |
| project | drawn by |
| WESTERN CT STATE UNIVERSITY | SP/ICA |
| WHITE HALL | approved by |
| 2ND AND 3RD FLOOR RENOVATIONS | AL |
| DANBURY, CONNECTICUT | drawing no. |
| CAD no. | project no. |
| | BI-RD-299 |
| | A4.06 |

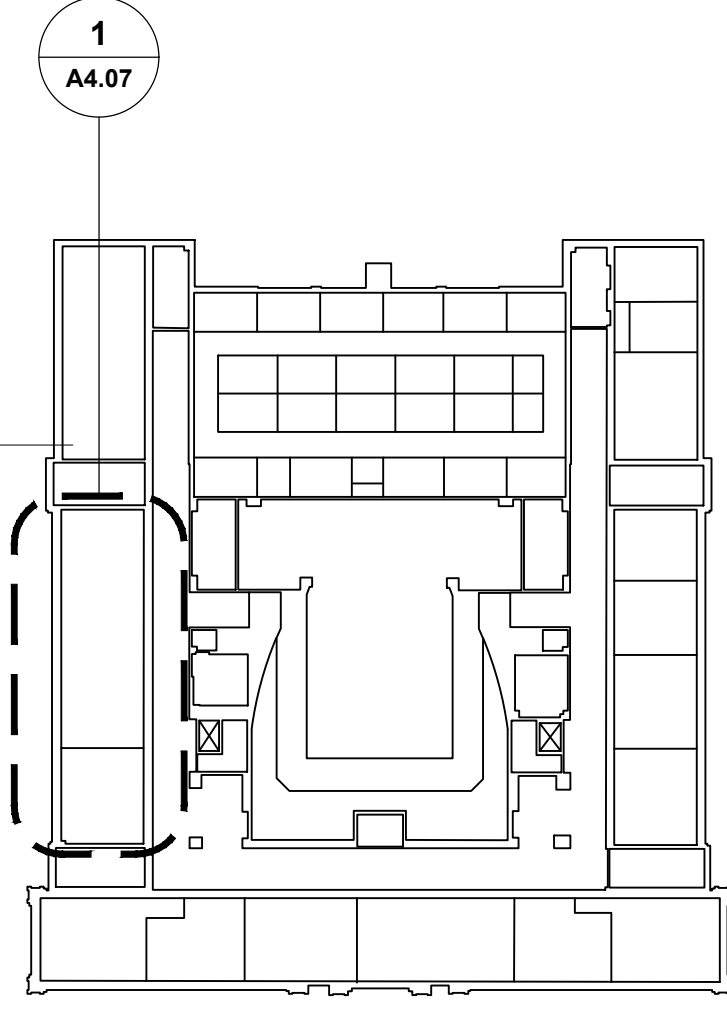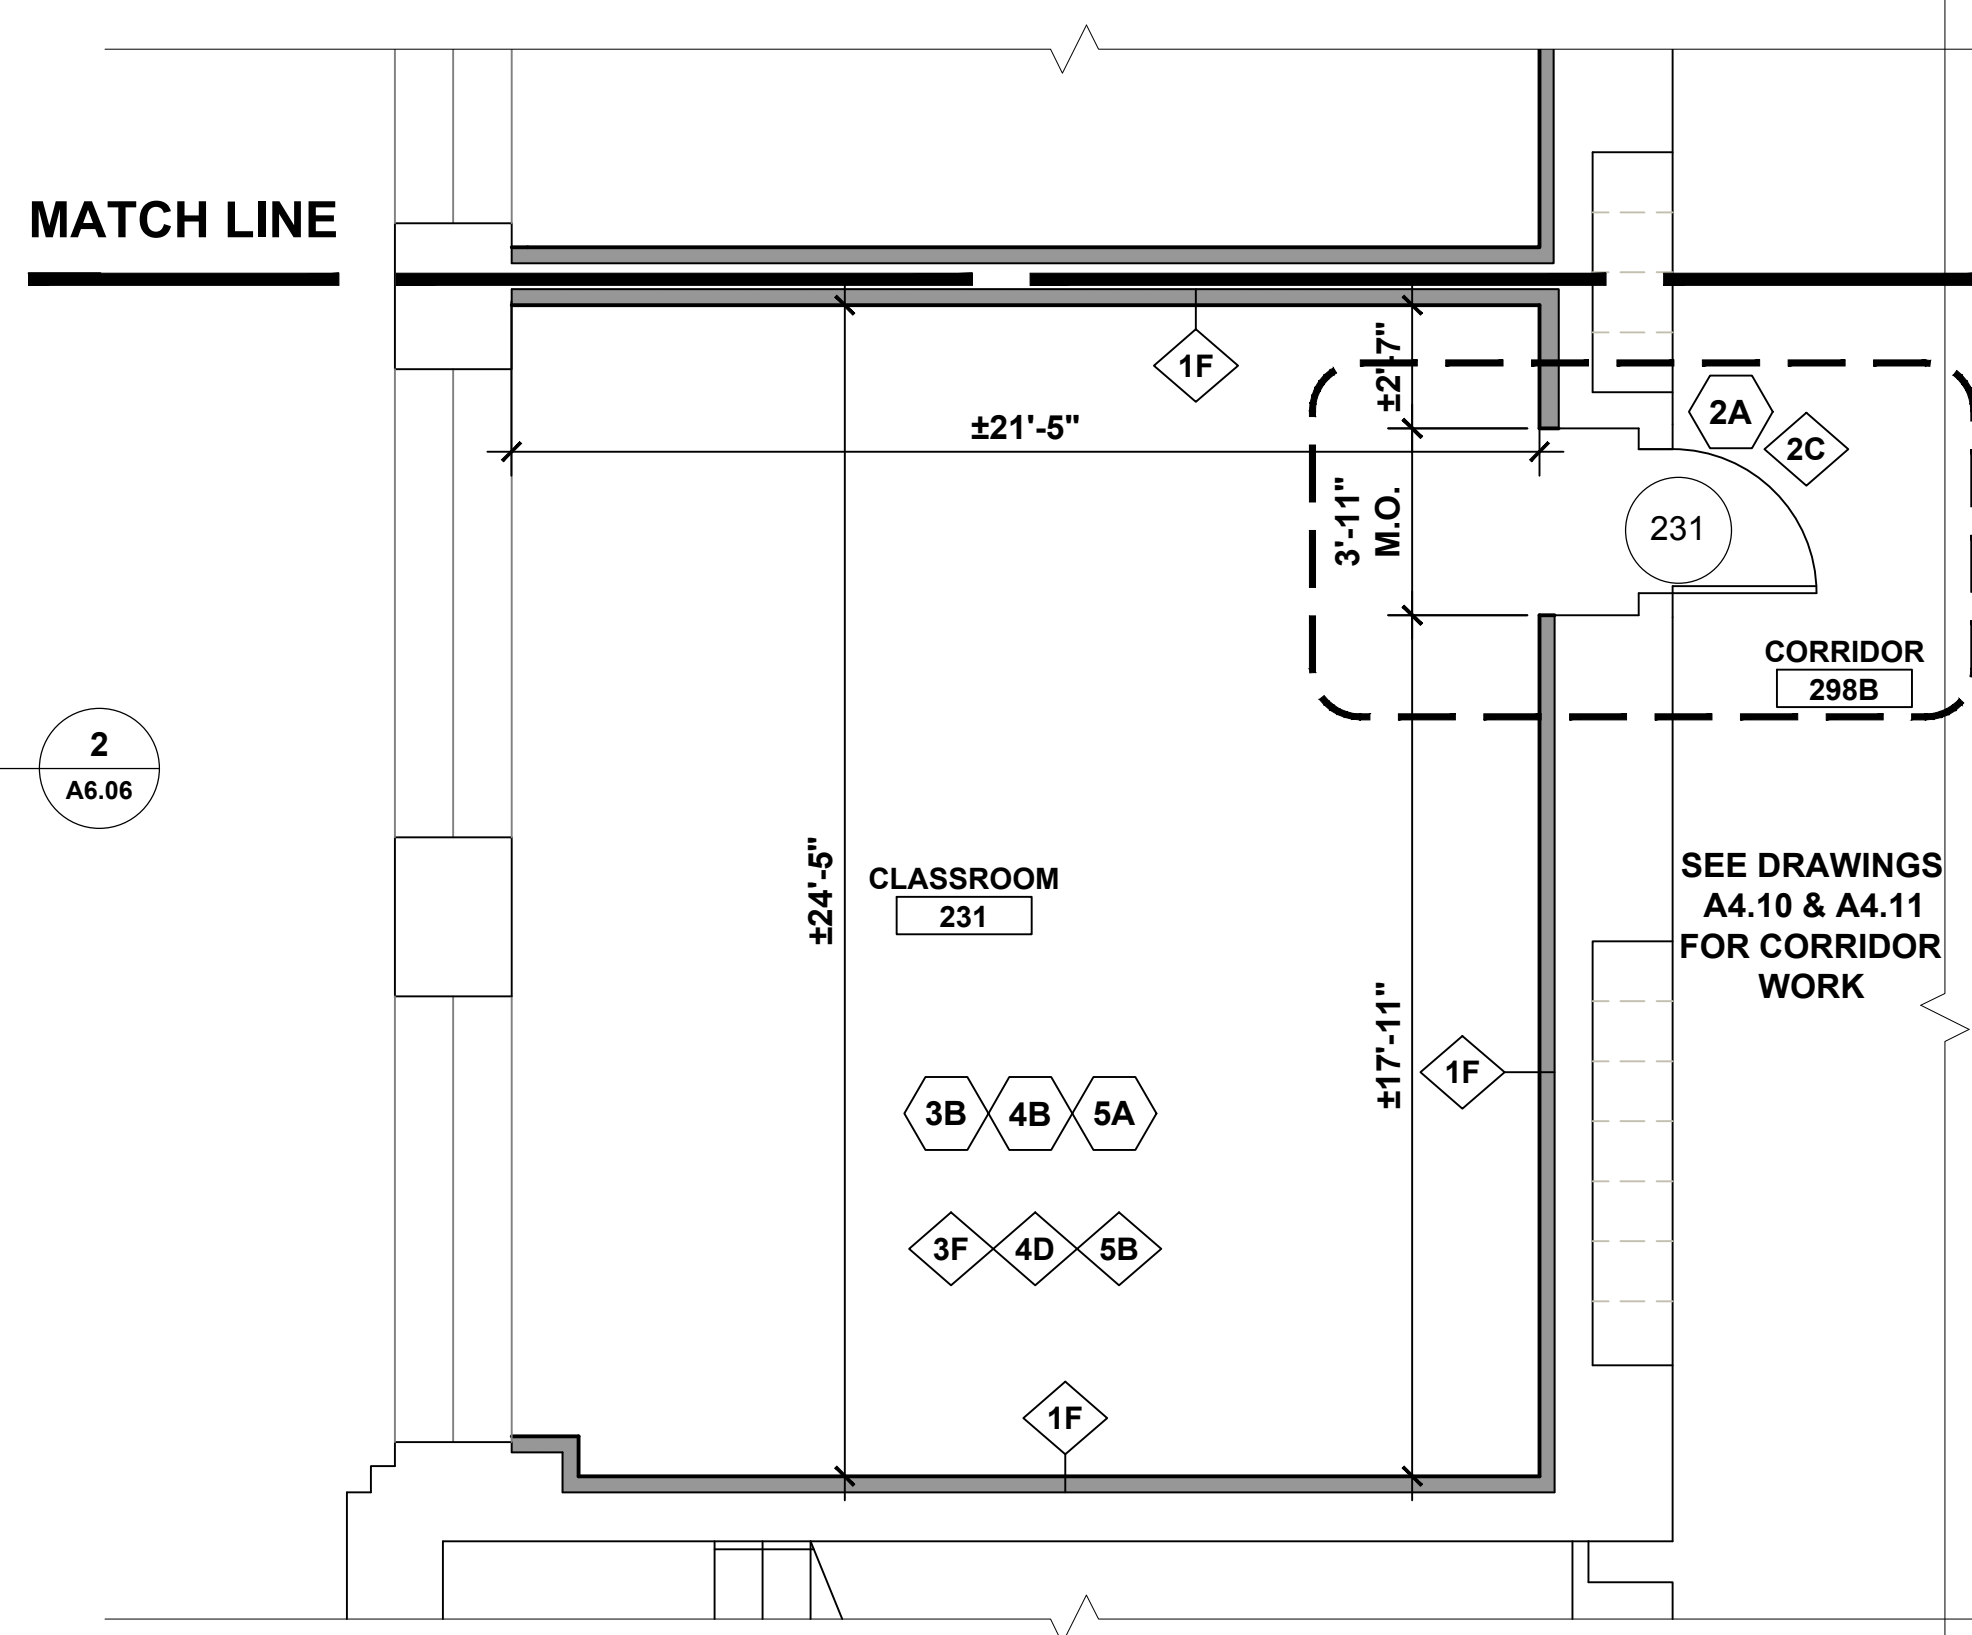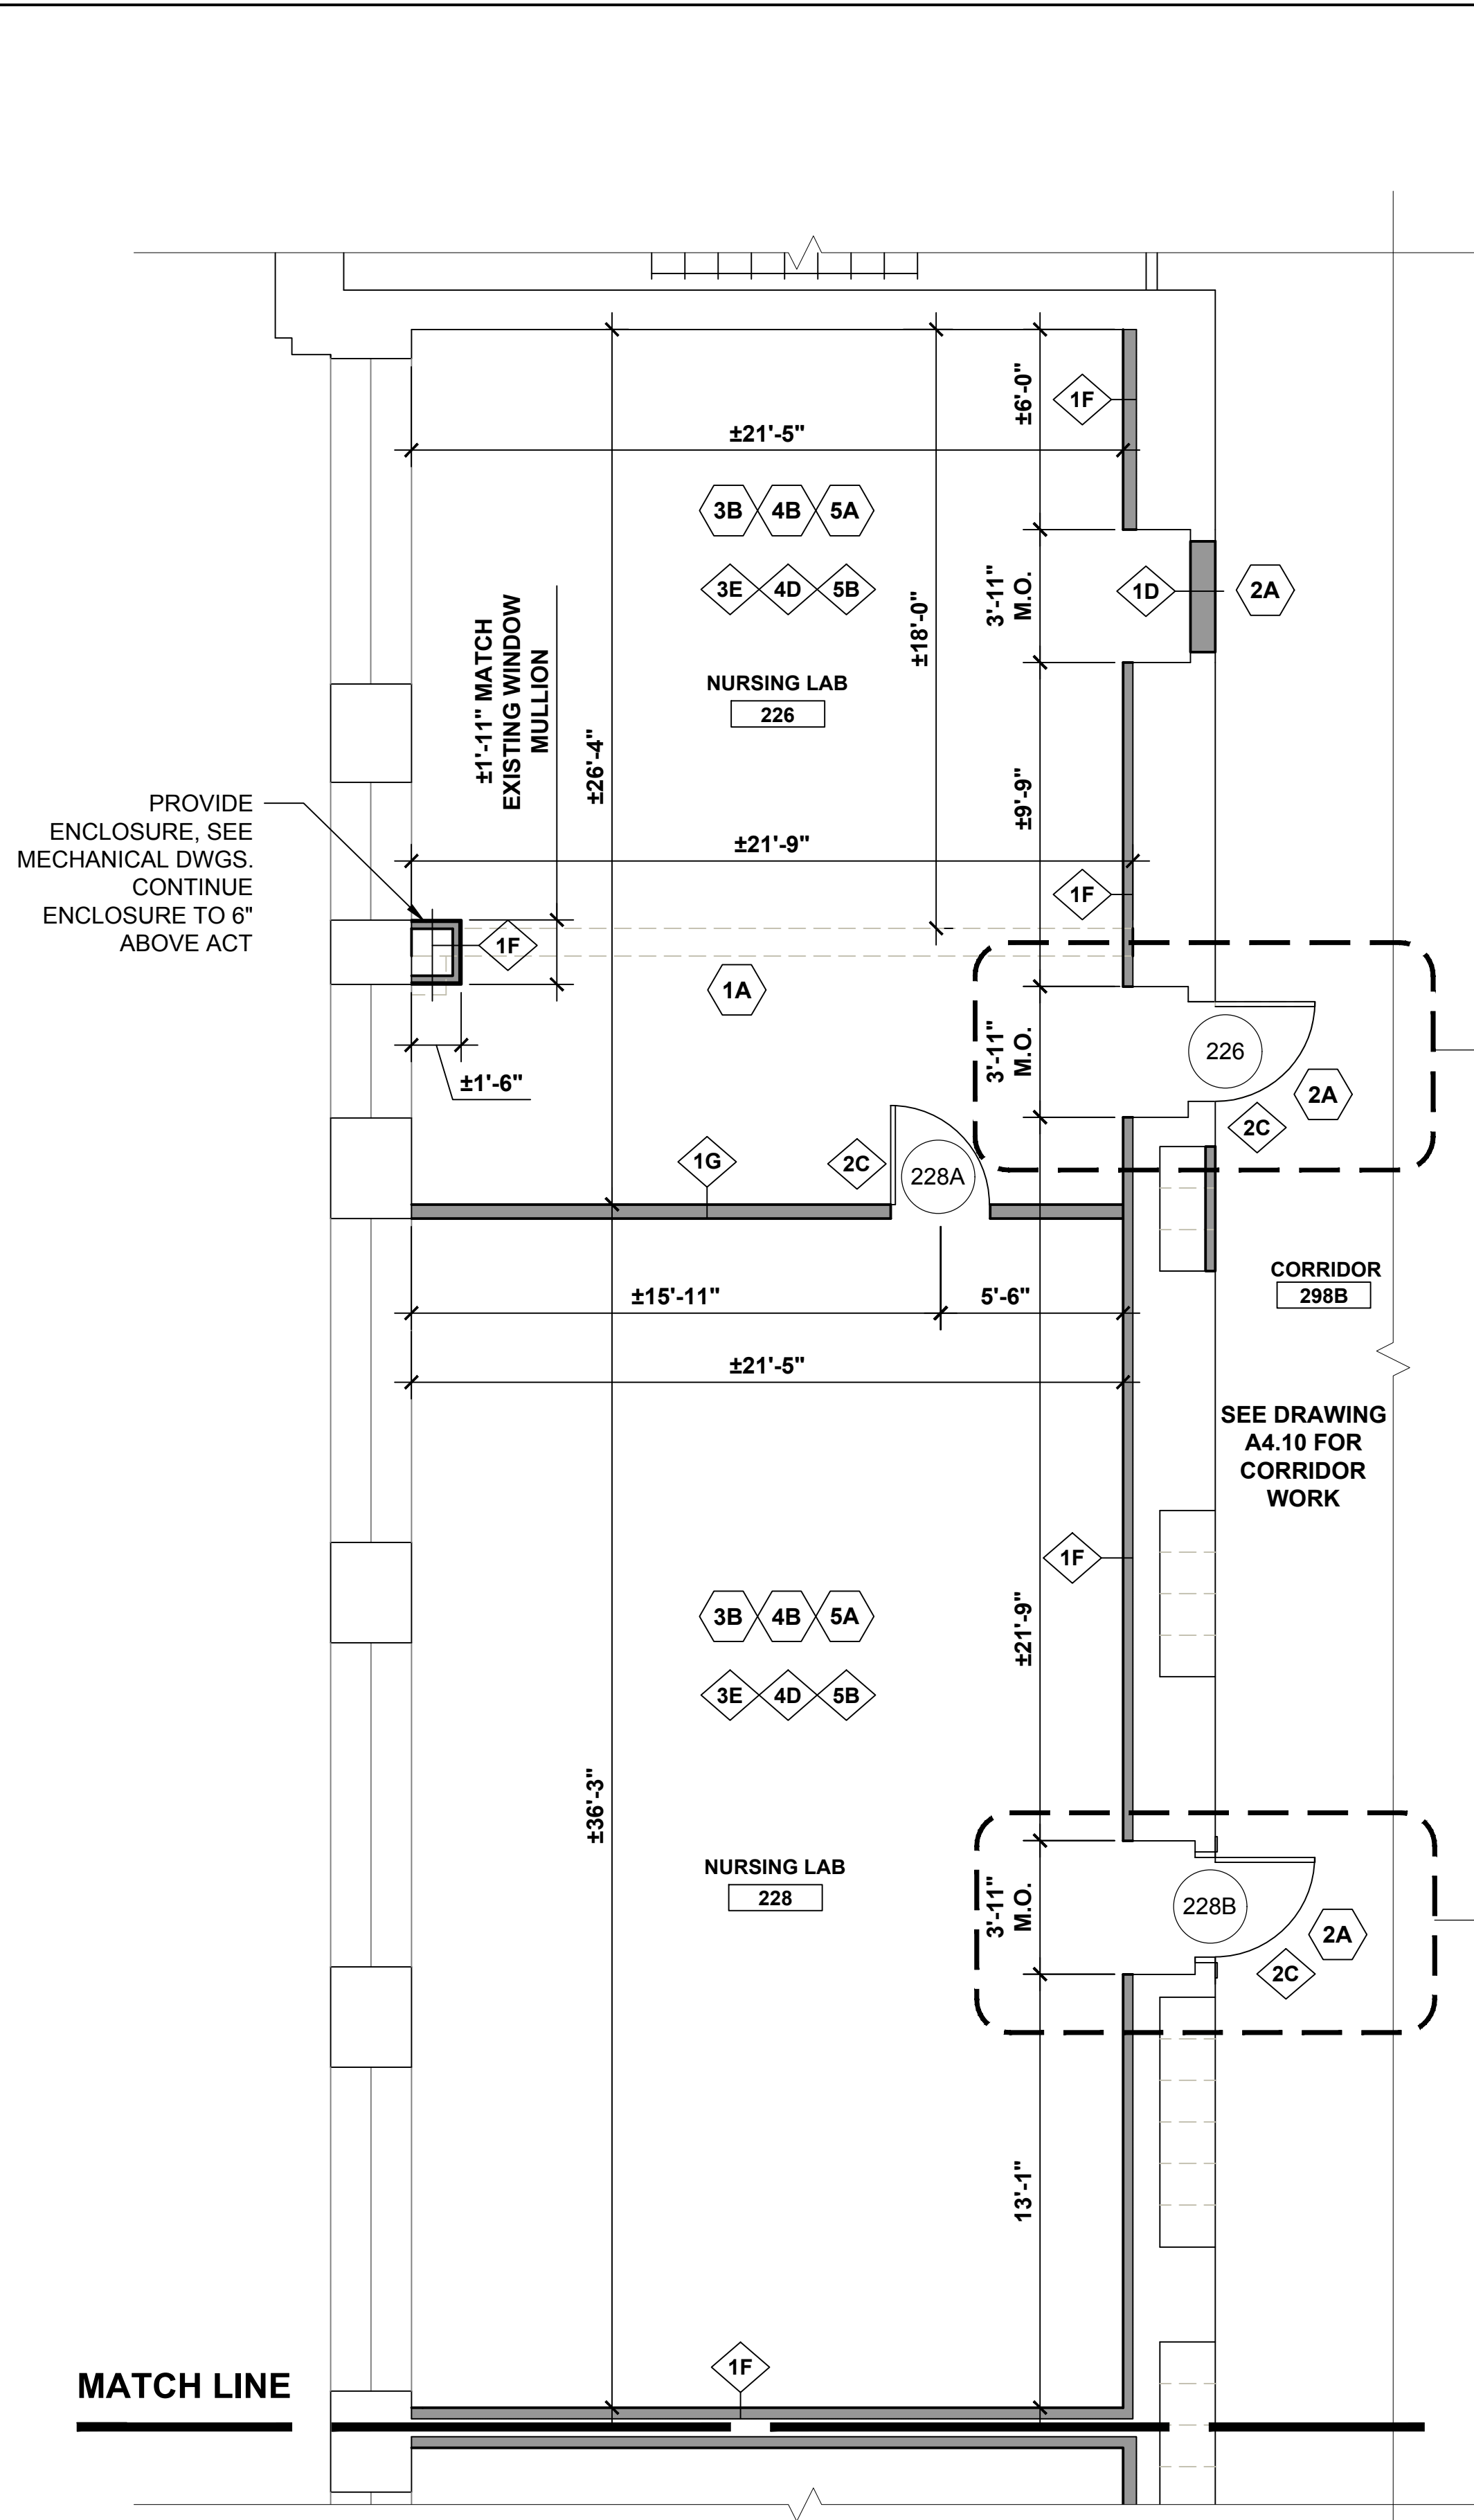




- DEMOLITION KEY NOTES**
- 1A REMOVE MASONRY WALL.
 - 1B REMOVE STUD AND GYP BD WALL.
 - 2A REMOVE DOOR AND FRAME.
 - 2B REMOVE DOOR, EXISTING FRAME TO REMAIN.
 - 3A REMOVE C.T. FLOOR.
 - 3B REMOVE VCT FLOOR.
 - 3C REMOVE CARPET.
 - 4A REMOVE C.T. WAINSCOT AND BASE.
 - 4B REMOVE VINYL BASE
 - 5A REMOVE ACT CEILING.
 - 6A REMOVE LAV.
 - 6B REMOVE TOILET & TOILET PARTITION.
 - 6C REMOVE URINAL AND URINAL SCREEN.

- NEW WORK KEY NOTES**
- 1C PROVIDE MASONRY WALL.
 - 1D PROVIDE 1 HOUR RATED WALL, 3/8" METAL STUDS WITH 5/8" TYPE 'X' GYP. BOARD BOTH SIDES
 - 1E PROVIDE 5/8" MOISTURE RESISTANT GYP BD ON EXISTING STUDS.
 - 1F PROVIDE 3 5/8" METAL STUDS WITH 5/8" TYPE 'X' GYP. BOARD ONE SIDE
 - 1G PROVIDE 3/8" METAL STUDS WITH 5/8" TYPE 'X' GYP. BOARD BOTH SIDES
 - 2C PROVIDE WOOD DOOR AND HM FRAME.
 - 2D PROVIDE WOOD DOOR IN EXISTING HM FRAME.
 - 3D PROVIDE CT FLOOR AND CT BASE.
 - 3E PROVIDE VCT AND RESILIENT BASE.
 - 3F PROVIDE CARPET AND RESILIENT BASE.
 - 3G EXISTING FLOORING TO REMAIN. (PROTECT DURING RENOVATION)
 - 4C PROVIDE CT WAINSCOT AND BASE/ PAINT ABOVE
 - 4D PREP AND PAINT WALLS
 - 4E PROVIDE HORIZONTAL WINDOW BLINDS
 - 5B PROVIDE ACT CEILING.
 - 5C REMOVE & REINSTALL ACT CEILING AFTER MEP WORK IS COMPLETED.
 - 5D PROVIDE GYPSUM BOARD CEILING/SOFFIT AND PAINT
 - 5E PAINT EXISTING CEILING
 - 6D PROVIDE LAV
 - 6E PROVIDE TOILET & PARTITION
 - 6F PROVIDE URINAL & SCREEN
 - 7A REMOVE TACK BOARDS. INSTALL PROVIDED OR EXISTING BOARDS AFTER ALL CORRIDOR WORK HAS BEEN COMPLETED. COORDINATE LOCATIONS WITH OWNER.
 - 7B REMOVE BULLETIN BOARD. INSTALL PROVIDED OR EXISTING BOARDS AFTER ALL CORRIDOR WORK HAS BEEN COMPLETED. COORDINATE LOCATIONS WITH OWNER.
 - 7C EXISTING DISPLAY CASES TO REMAIN IN PLACE. PAINT INTERIOR TO MATCH CORRIDOR COLOR. PAINT TRIM TO MATCH DOOR TRIM COLOR.

1 WEST CENTER PARTIAL PLAN

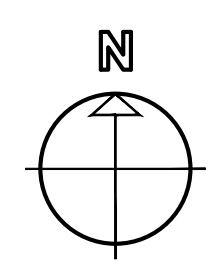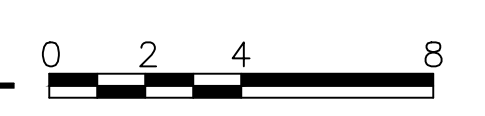



| drawing title | | | STATE OF CONNECTICUT | | | |
|--------------------------------------|---------|-------------------------------|--|--|----------|--|
| 2ND FLOOR - WEST CENTER PARTIAL PLAN | | | DEPARTMENT OF ADMINISTRATIVE SERVICES | | | |
| REVISIONS | | | | | | |
| mark | date | description | drawing prepared by | date | scale | |
| | 8/4/17 | SCHEMATIC DESIGN SUBMISSION | AMES & WHITAKER ARCHITECTS 31 LIBERTY STREET SOUTHINGTON, CT | 07/25/18 | AS NOTED | |
| | 1/15/18 | DESIGN DEVELOPMENT SUBMISSION | | | | |
| | 4/16/18 | CONSTRUCTION DOCUMENTS | | | | |
| | | | project | WESTERN CT STATE UNIVERSITY WHITE HALL 2ND AND 3RD FLOOR RENOVATIONS DANBURY, CONNECTICUT | | |
| | | | drawn by | SP/CA | | |
| | | | approved by | AL | | |
| | | | drawing no. | A4.07 | | |
| | | | CAD no. | project no. BI-RD-299 | | |

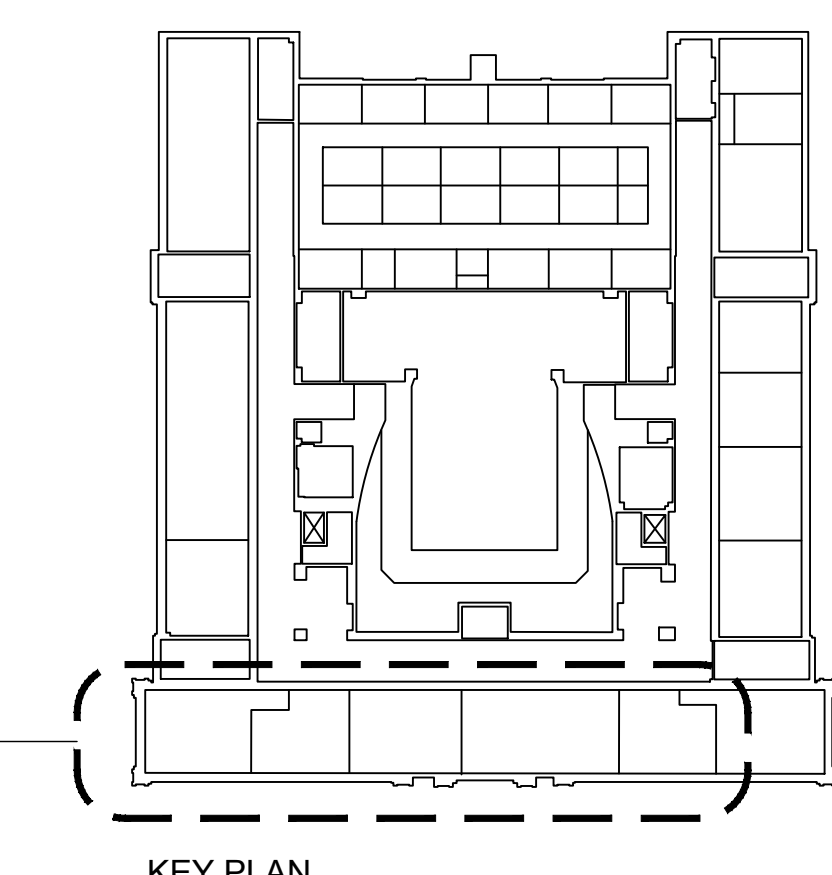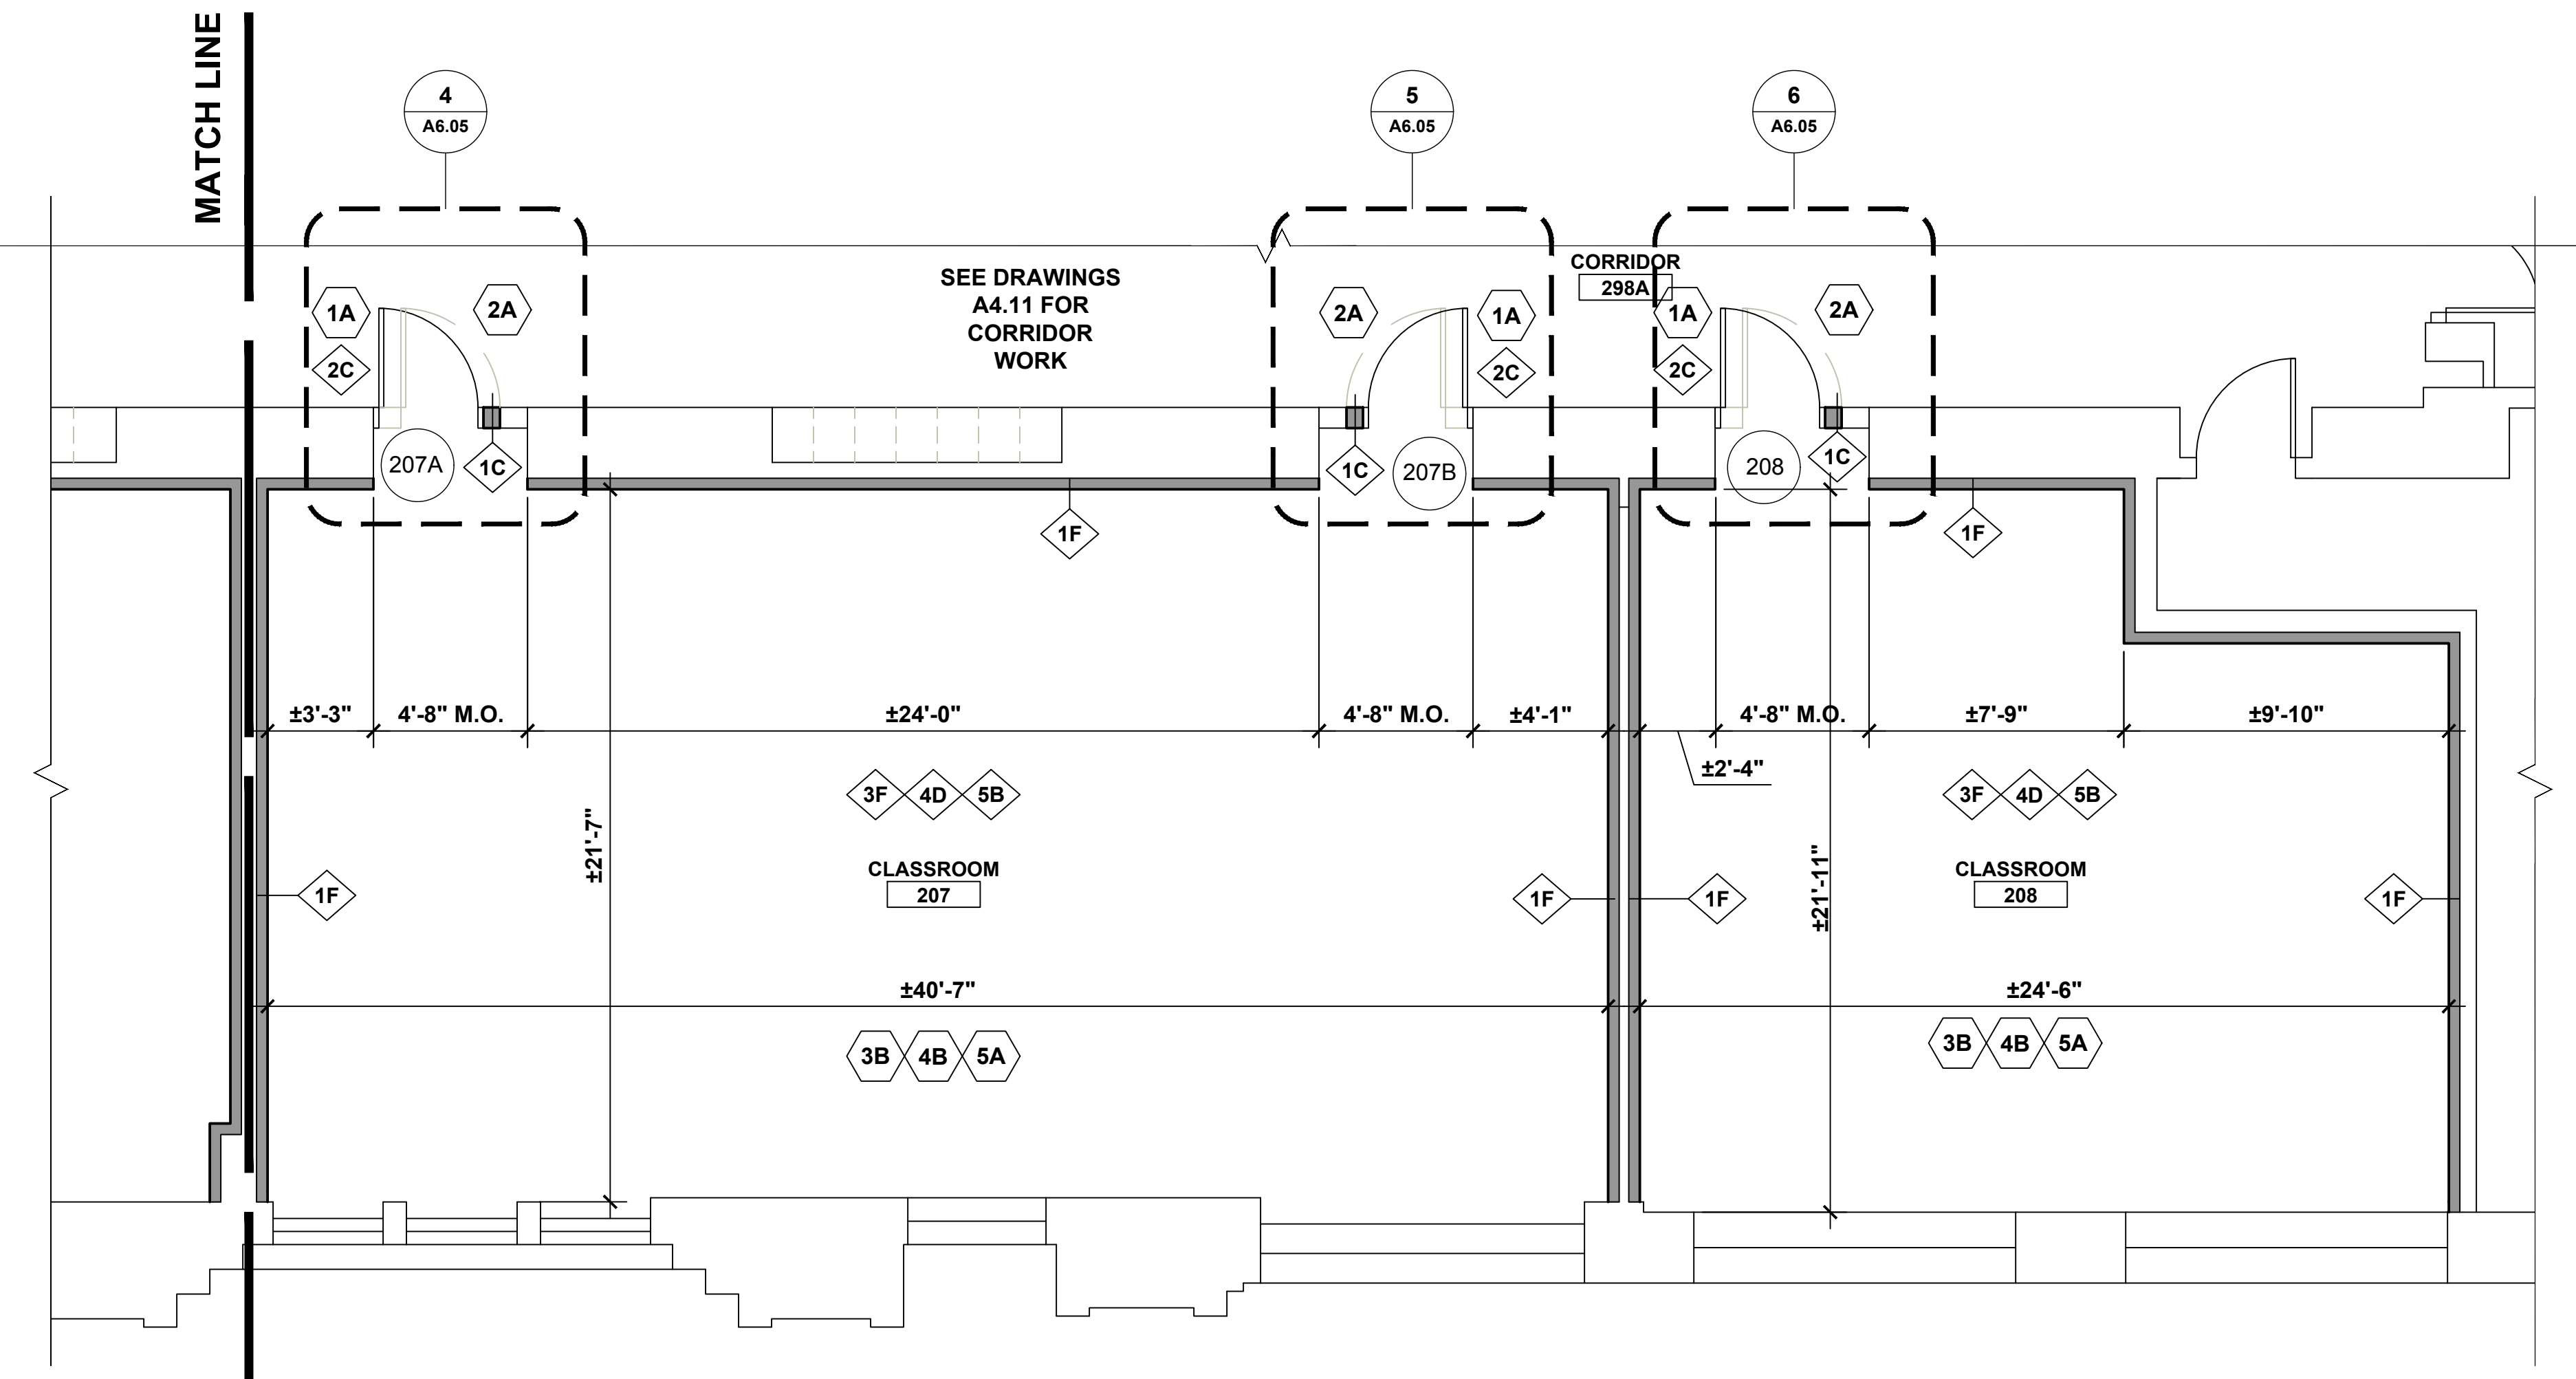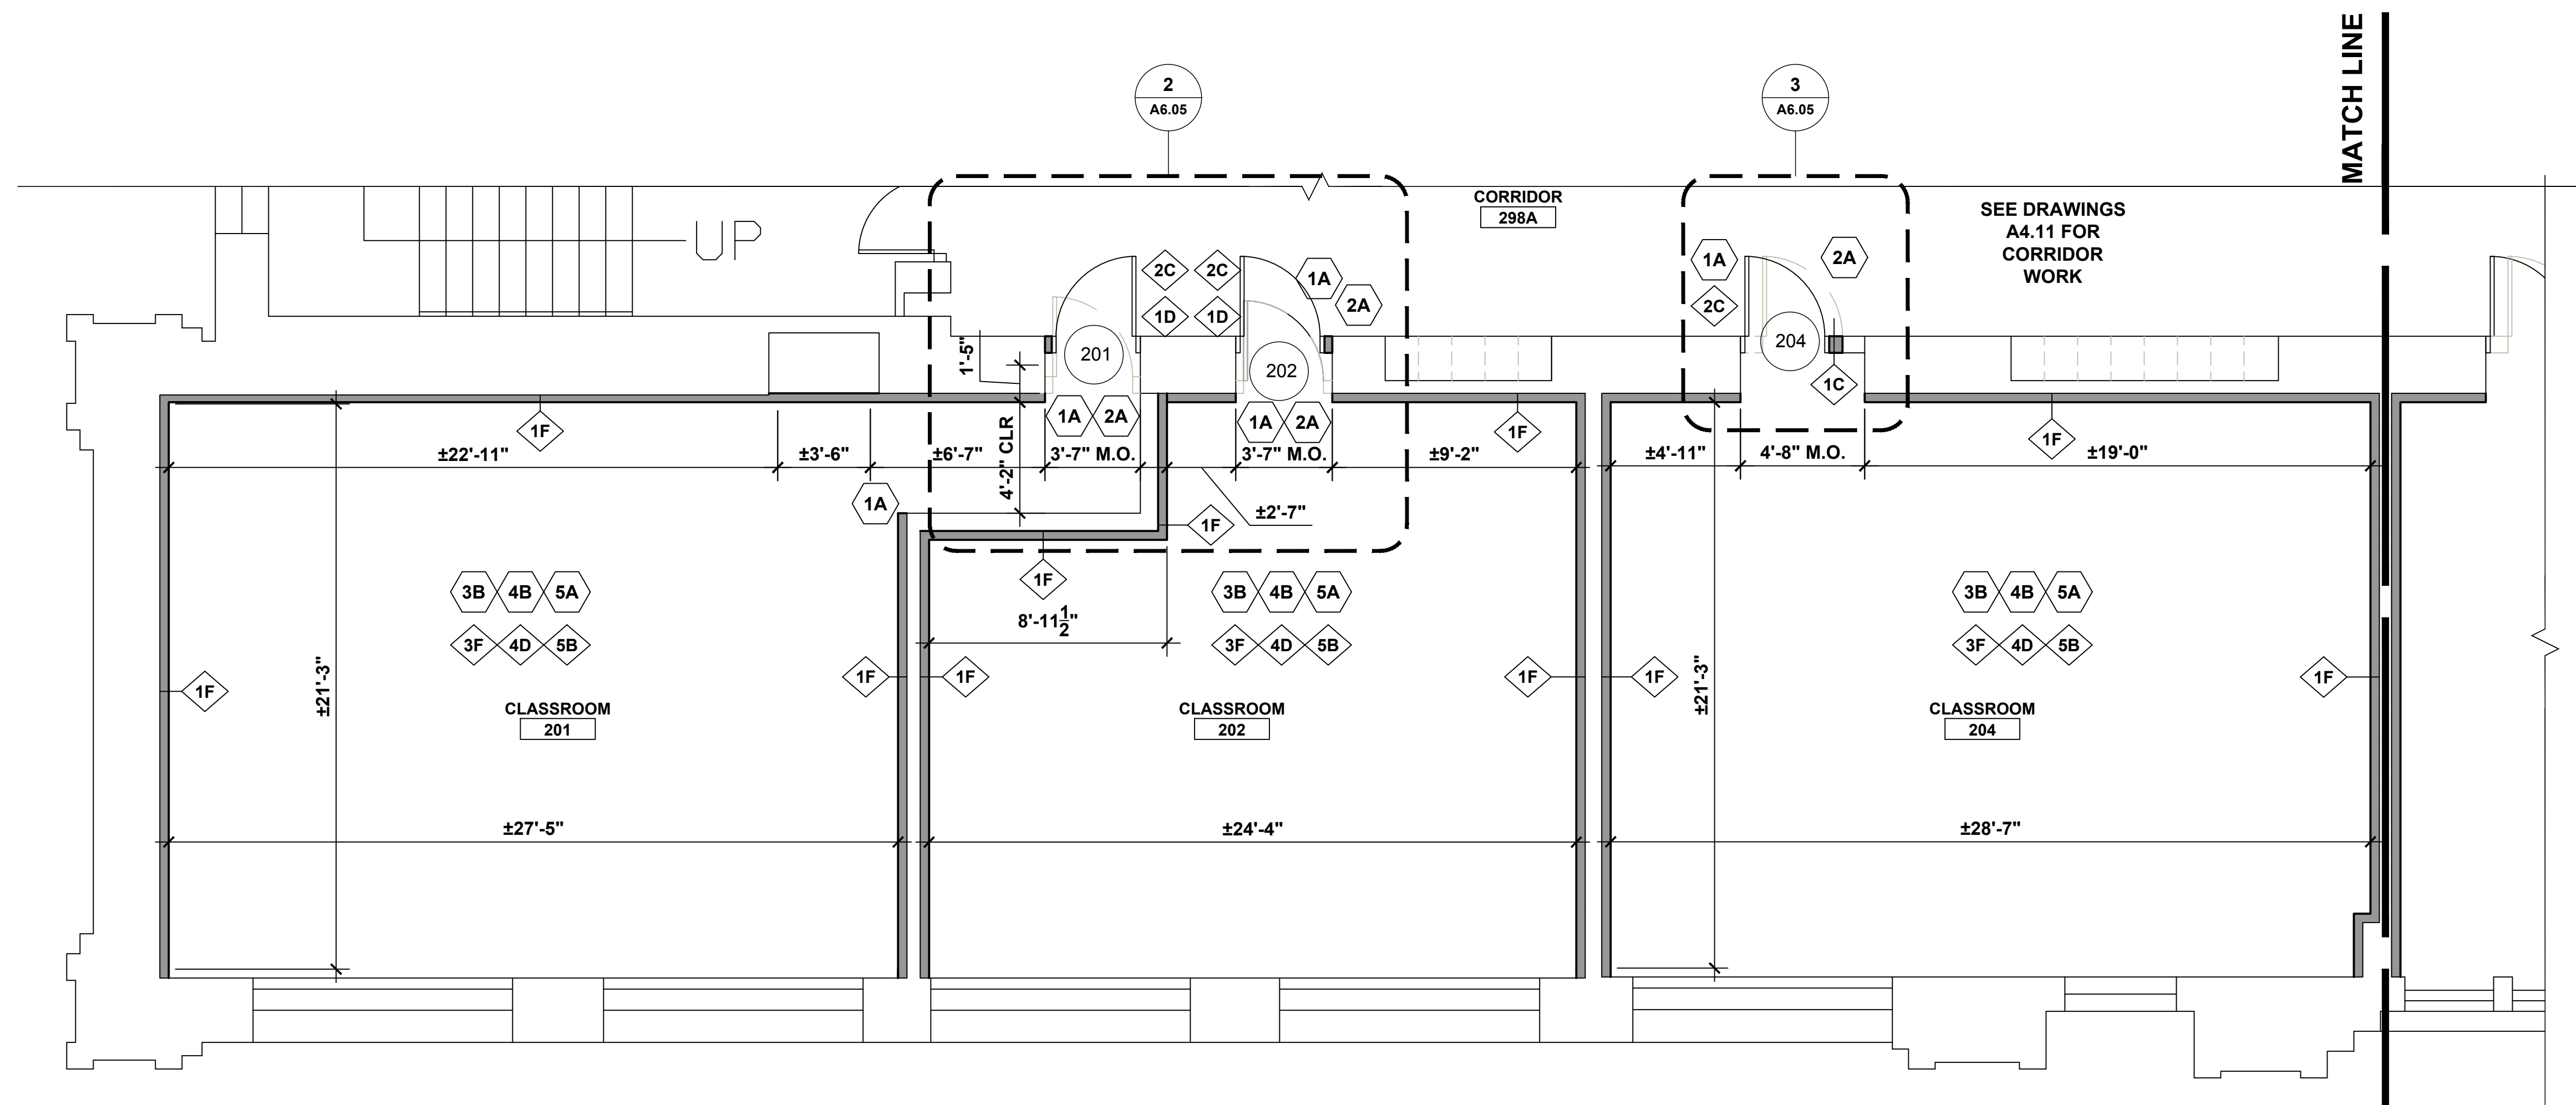

- DEMOLITION KEY NOTES**
- 1A REMOVE MASONRY WALL.
 - 1B REMOVE STUD AND GYP BD WALL.
 - 2A REMOVE DOOR AND FRAME.
 - 2B REMOVE DOOR. EXISTING FRAME TO REMAIN.
 - 3A REMOVE C.T. FLOOR.
 - 3B REMOVE VCT FLOOR.
 - 3C REMOVE CARPET.
 - 4A REMOVE C.T. WAINSCOT AND BASE.
 - 4B REMOVE VINYL BASE
 - 5A REMOVE ACT CEILING.
 - 6A REMOVE LAV.
 - 6B REMOVE TOILET & TOILET PARTITION.
 - 6C REMOVE URINAL AND URINAL SCREEN.

- NEW WORK KEY NOTES**
- 1C PROVIDE MASONRY WALL.
 - 1D PROVIDE 1 HOUR RATED WALL, 3/8" METAL STUDS WITH 5/8" TYPE 'X' GYP. BOARD BOTH SIDES
 - 1E PROVIDE 5/8" MOISTURE RESISTANT GYP BD ON EXISTING STUDS.
 - 1F PROVIDE 3/8" METAL STUDS WITH 5/8" TYPE 'X' GYP. BOARD ONE SIDE
 - 1G PROVIDE 3/8" METAL STUDS WITH 5/8" TYPE 'X' GYP. BOARD BOTH SIDES
 - 2C PROVIDE WOOD DOOR AND HM FRAME.
 - 2D PROVIDE WOOD DOOR IN EXISTING HM FRAME.
 - 3D PROVIDE CT FLOOR AND CT BASE.
 - 3E PROVIDE VCT AND RESILIENT BASE.
 - 3F PROVIDE CARPET AND RESILIENT BASE.
 - 3G EXISTING FLOORING TO REMAIN. (PROTECT DURING RENOVATION)
 - 4C PROVIDE CT WAINSCOT AND BASE/ PAINT ABOVE
 - 4D PREP AND PAINT WALLS
 - 4E PROVIDE HORIZONTAL WINDOW BLINDS
 - 5B PROVIDE ACT CEILING.
 - 5C REMOVE & REINSTALL ACT CEILING AFTER MEP WORK IS COMPLETED.
 - 5D PROVIDE GYPSUM BOARD CEILING/SOFFIT AND PAINT
 - 5E PAINT EXISTING CEILING
 - 6D PROVIDE LAV
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 - 6F PROVIDE URINAL & SCREEN
 - 7A REMOVE TACK BOARDS. INSTALL PROVIDED OR EXISTING BOARDS AFTER ALL CORRIDOR WORK HAS BEEN COMPLETED. COORDINATE LOCATIONS WITH OWNER.
 - 7B REMOVE BULLETIN BOARD. INSTALL PROVIDED OR EXISTING BOARDS AFTER ALL CORRIDOR WORK HAS BEEN COMPLETED. COORDINATE LOCATIONS WITH OWNER.
 - 7C EXISTING DISPLAY CASES TO REMAIN IN PLACE. PAINT INTERIOR TO MATCH CORRIDOR COLOR. PAINT TRIM TO MATCH DOOR TRIM COLOR.




1 **SOUTHWEST CORNER PARTIAL PLAN**

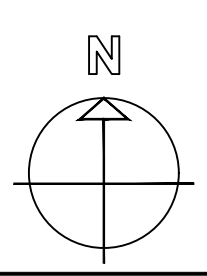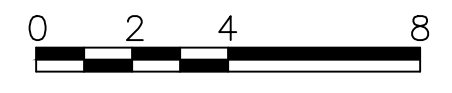

1 A4.08

KEY PLAN

| | | | | |
|---|---------|-------------------------------|--|-------------------|
| drawing title SECOND FLOOR - SOUTHWEST CORNER PARTIAL PLAN | | | STATE OF CONNECTICUT DEPARTMENT OF ADMINISTRATIVE SERVICES | |
| REVISIONS | | | drawing prepared by AMES & WHITAKER ARCHITECTS 31 LIBERTY STREET SOUTHINGTON, CT | |
| mark | date | description | date | scale |
| | 8/4/17 | SCHEMATIC DESIGN SUBMISSION | 07/25/18 | AS NOTED |
| | 1/15/18 | DESIGN DEVELOPMENT SUBMISSION | | |
| | 4/16/18 | CONSTRUCTION DOCUMENTS | | |
| | 5/23/18 | | | |
| | 7/25/18 | | | |
| project WESTERN CT STATE UNIVERSITY WHITE HALL 2ND AND 3RD FLOOR RENOVATIONS DANBURY, CONNECTICUT | | | drawn by CA/SP | approved by AL |
| CAD no. | | | project no. BI-RD-299 | A4.08 |

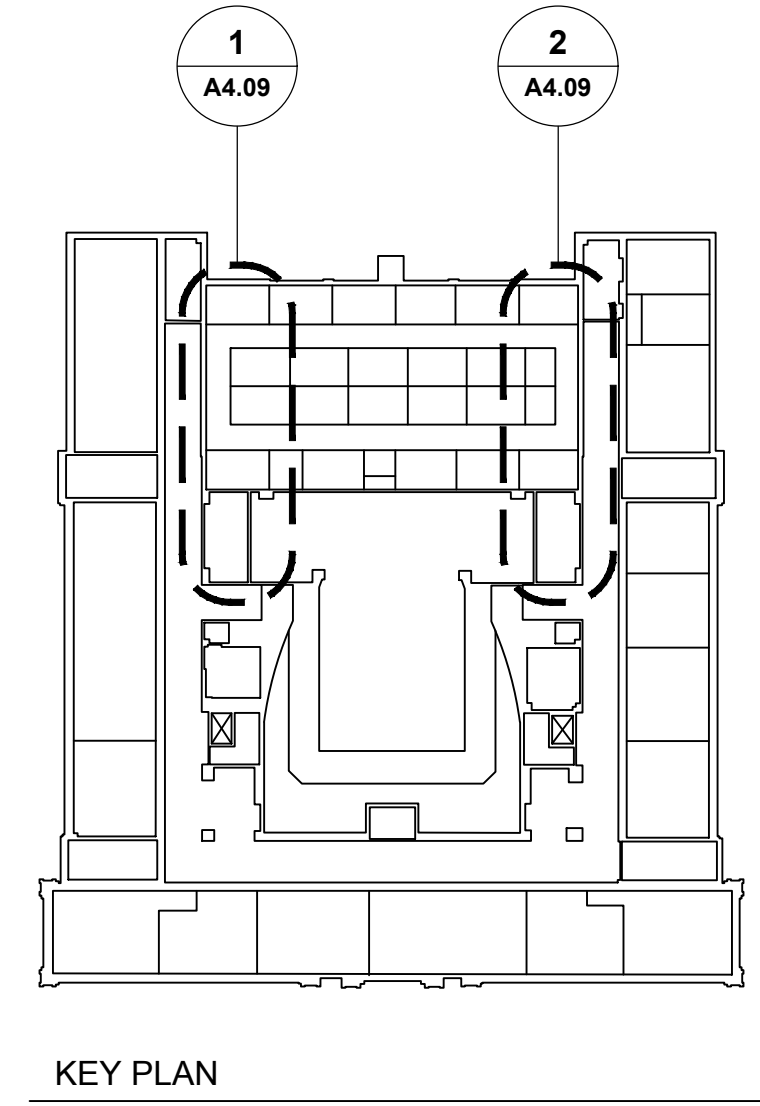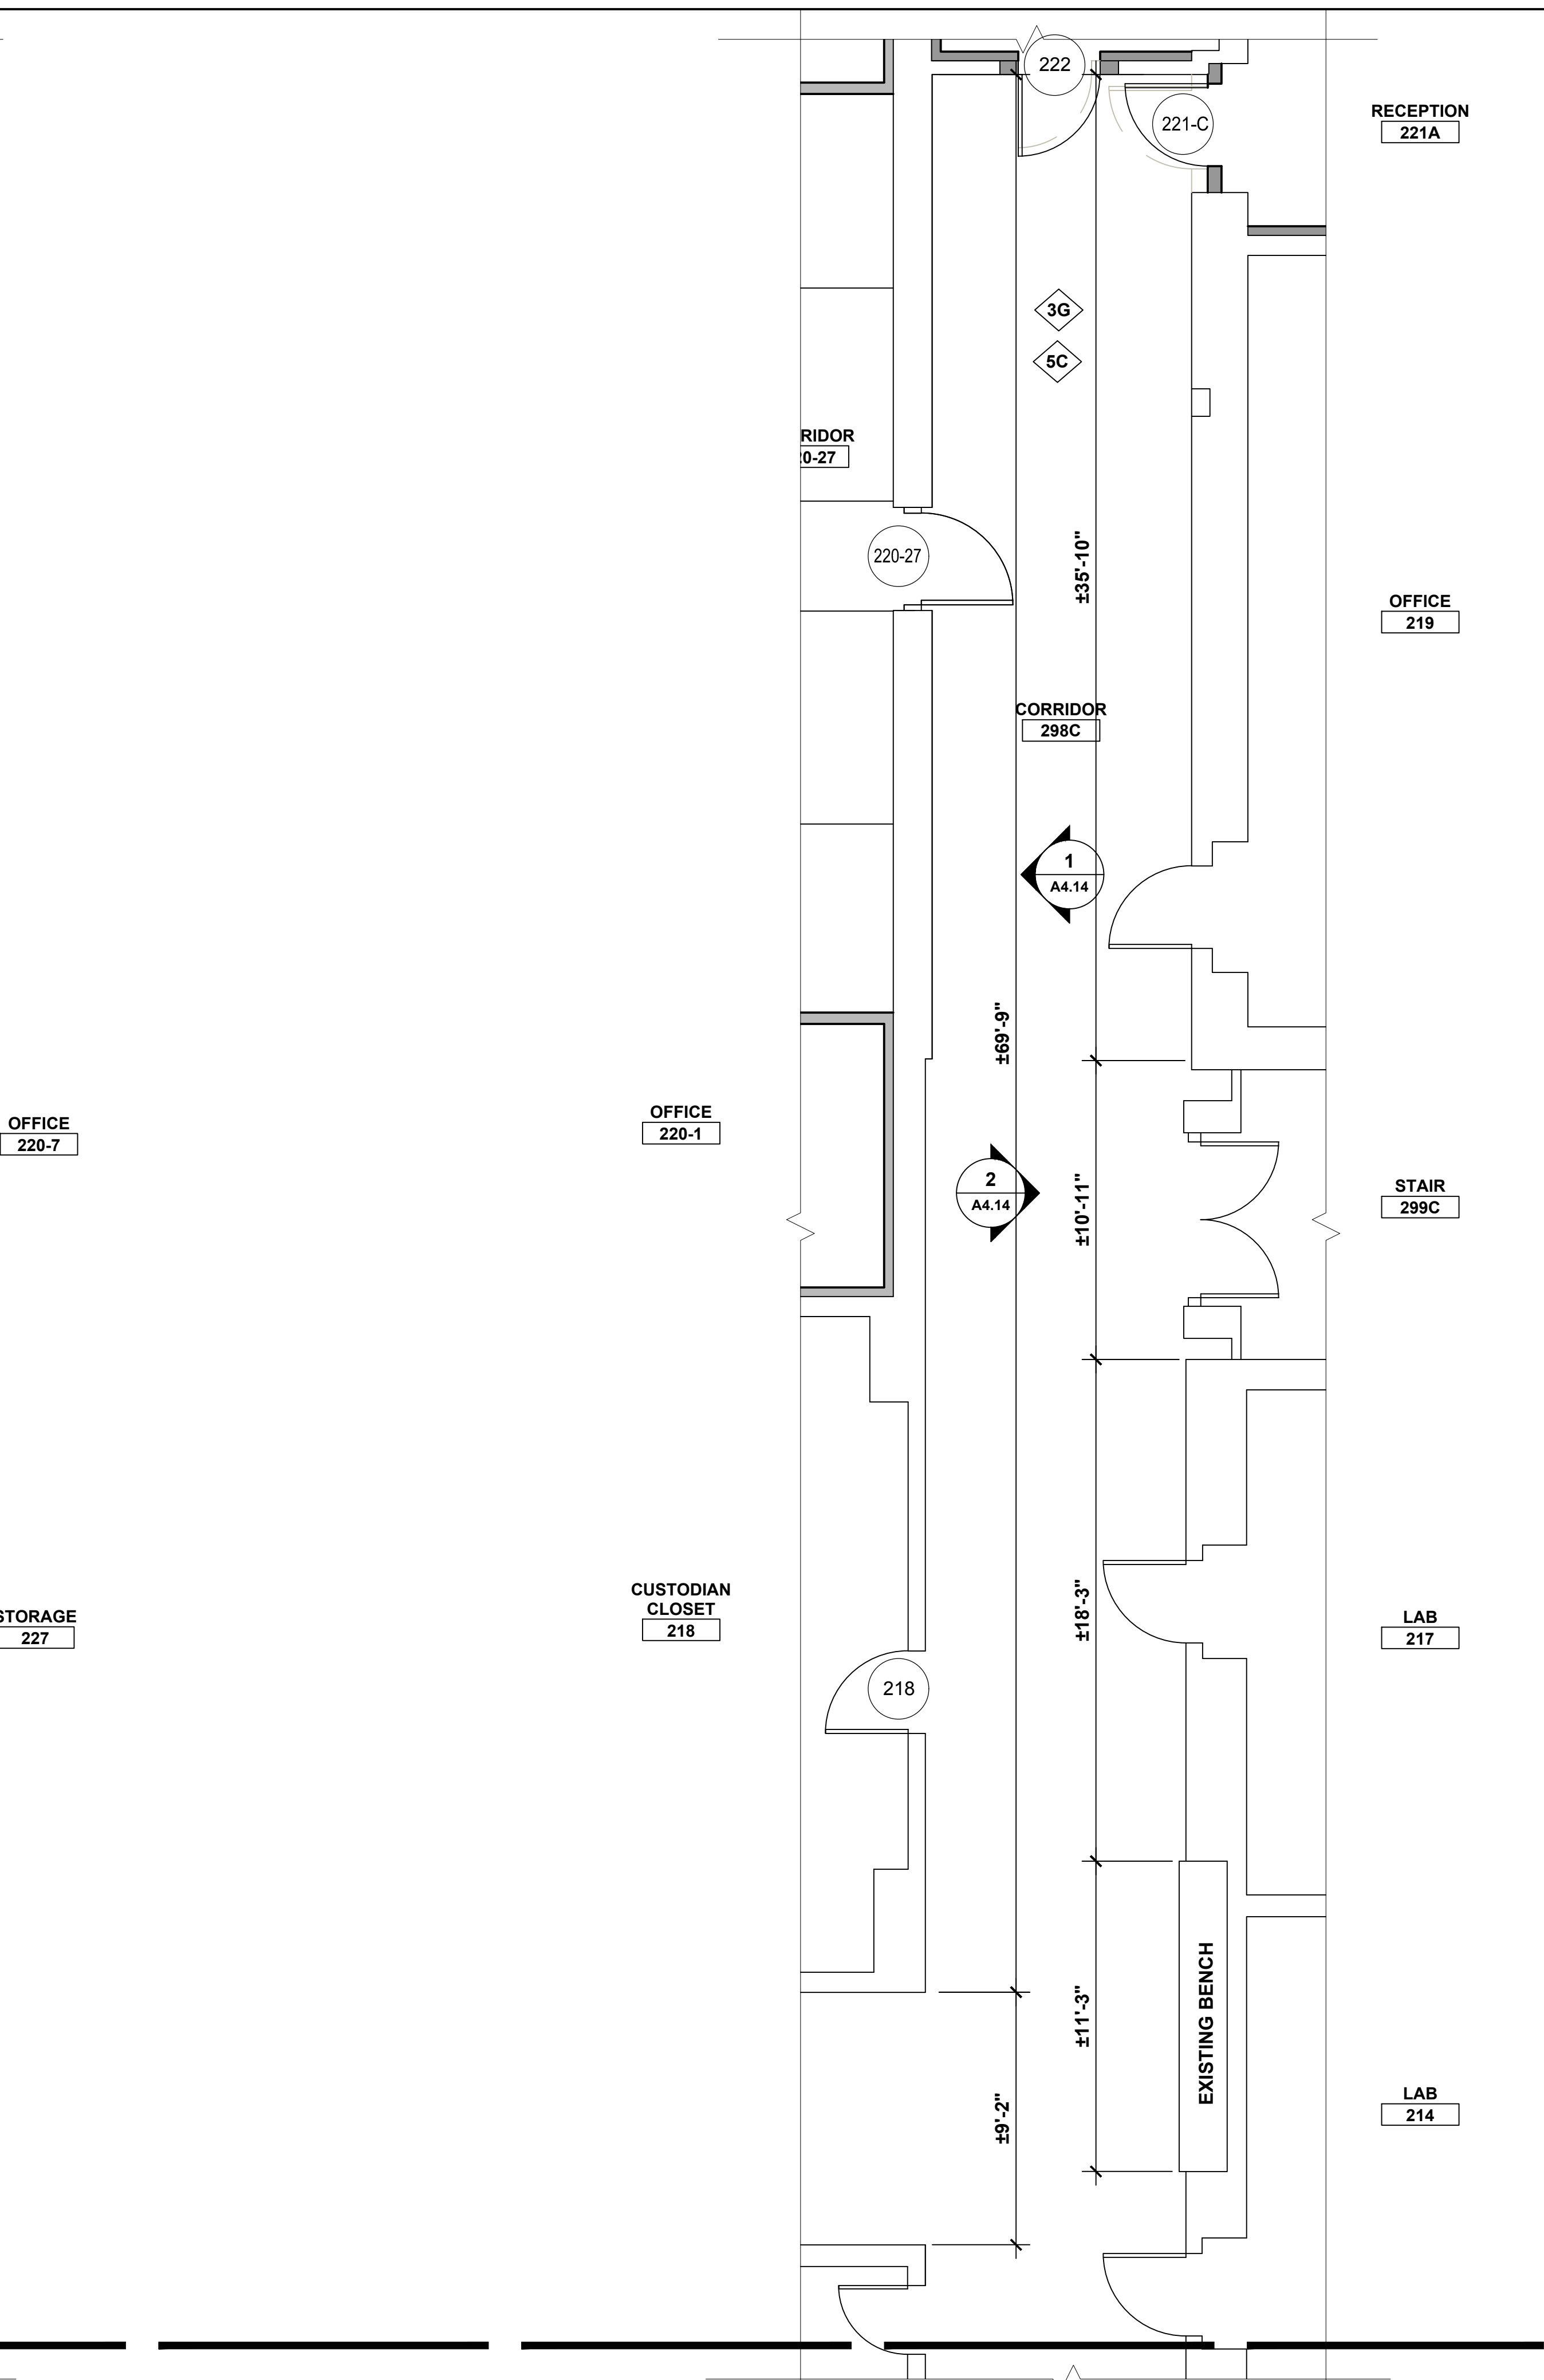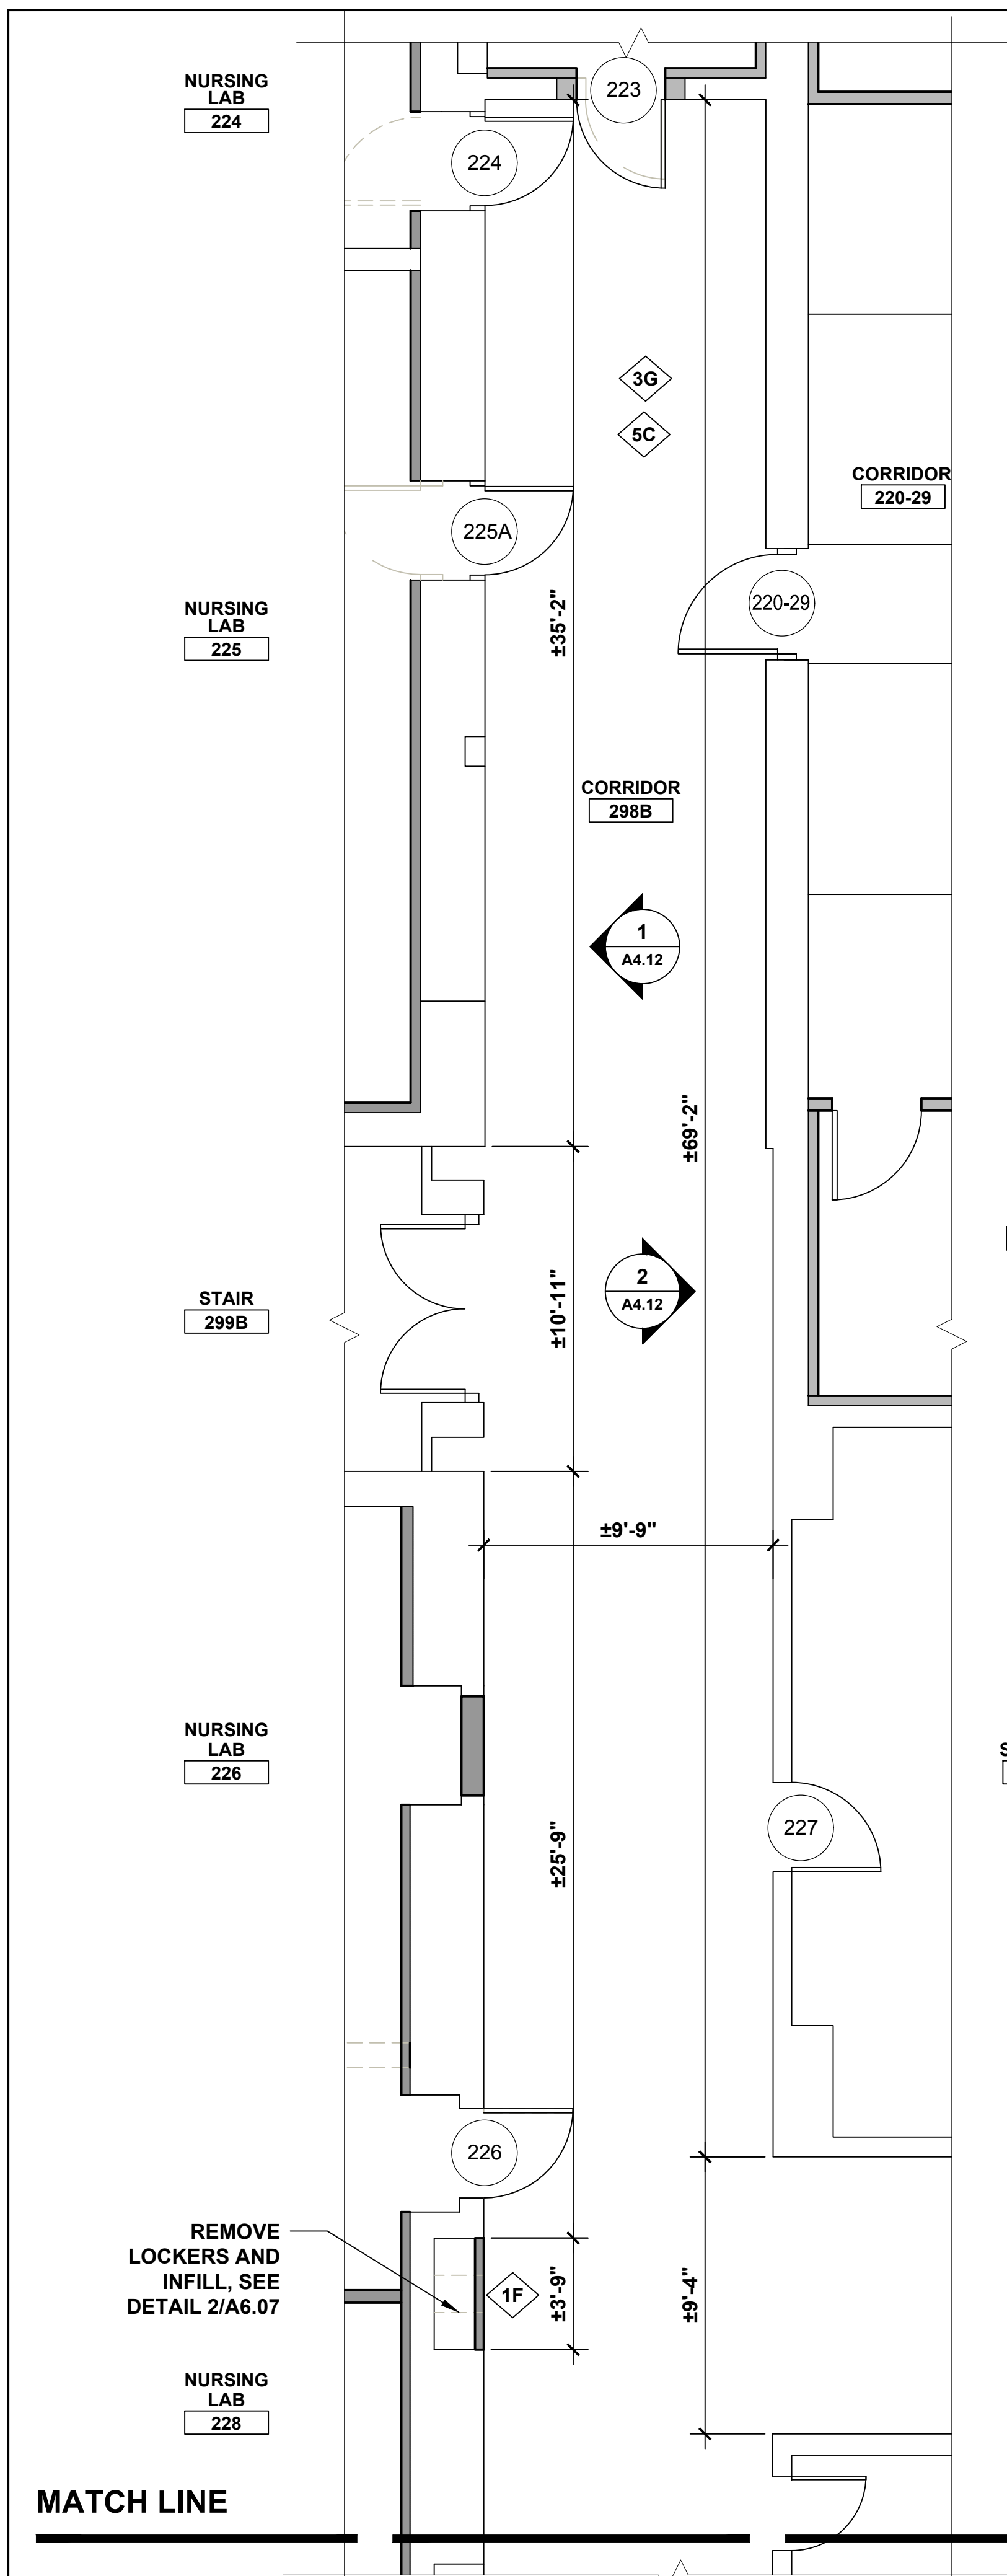


- DEMOLITION KEY NOTES**
- 1A REMOVE MASONRY WALL.
 - 1B REMOVE STUD AND GYP BD WALL.
 - 2A REMOVE DOOR AND FRAME.
 - 2B REMOVE DOOR. EXISTING FRAME TO REMAIN.
 - 3A REMOVE C.T. FLOOR.
 - 3B REMOVE VCT FLOOR.
 - 3C REMOVE CARPET.
 - 4A REMOVE C.T. WAINSCOT AND BASE.
 - 4B REMOVE VINYL BASE
 - 5A REMOVE ACT CEILING.
 - 6A REMOVE LAV.
 - 6B REMOVE TOILET & TOILET PARTITION.
 - 6C REMOVE URINAL AND URINAL SCREEN.



- NEW WORK KEY NOTES**
- 1C PROVIDE MASONRY WALL.
 - 1D PROVIDE 1 HOUR RATED WALL, 3/8" METAL STUDS WITH 5/8" TYPE 'X' GYP. BOARD BOTH SIDES
 - 1E PROVIDE 5/8" MOISTURE RESISTANT GYP BD ON EXISTING STUDS.
 - 1F PROVIDE 3 3/8" METAL STUDS WITH 5/8" TYPE 'X' GYP. BOARD ONE SIDE
 - 1G PROVIDE 3/8" METAL STUDS WITH 5/8" TYPE 'X' GYP. BOARD BOTH SIDES
 - 2C PROVIDE WOOD DOOR AND HM FRAME.
 - 2D PROVIDE WOOD DOOR IN EXISTING HM FRAME.
 - 3D PROVIDE CT FLOOR AND CT BASE.
 - 3E PROVIDE VCT AND RESILIENT BASE.
 - 3F PROVIDE CARPET AND RESILIENT BASE.
 - 3G EXISTING FLOORING TO REMAIN. (PROTECT DURING RENOVATION)
 - 4C PROVIDE CT WAINSCOT AND BASE/ PAINT ABOVE
 - 4D PREP AND PAINT WALLS
 - 4E PROVIDE HORIZONTAL WINDOW BLINDS
 - 5B PROVIDE ACT CEILING.
 - 5C REMOVE & REINSTALL ACT CEILING AFTER MEP WORK IS COMPLETED.
 - 5D PROVIDE GYPSUM BOARD CEILING/SOFFIT AND PAINT
 - 5E PAINT EXISTING CEILING
 - 6D PROVIDE LAV
 - 6E PROVIDE TOILET & PARTITION
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 - 7A REMOVE TACK BOARDS. INSTALL PROVIDED OR EXISTING BOARDS AFTER ALL CORRIDOR WORK HAS BEEN COMPLETED. COORDINATE LOCATIONS WITH OWNER.
 - 7B REMOVE BULLETIN BOARD. INSTALL PROVIDED OR EXISTING BOARDS AFTER ALL CORRIDOR WORK HAS BEEN COMPLETED. COORDINATE LOCATIONS WITH OWNER.
 - 7C EXISTING DISPLAY CASES TO REMAIN IN PLACE. PAINT INTERIOR TO MATCH CORRIDOR COLOR. PAINT TRIM TO MATCH DOOR TRIM COLOR.

| | | | |
|---|---------|---|-------------------------------|
| drawing title SECOND FLOOR - PARTIAL PLANS AT CORRIDOR | | STATE OF CONNECTICUT DEPARTMENT OF ADMINISTRATIVE SERVICES | |
| REVISIONS | | | |
| mark | date | description | date |
| | 8/4/17 | SCHEMATIC DESIGN SUBMISSION | 07/25/18 |
| | 1/15/18 | DESIGN DEVELOPMENT SUBMISSION | scale AS NOTED |
| | 4/16/18 | CONSTRUCTION DOCUMENTS | project |
| | 5/23/18 | | WESTERN CT STATE UNIVERSITY |
| | 7/25/18 | | WHITE HALL |
| | 1/21/19 | | 2ND AND 3RD FLOOR RENOVATIONS |
| | | | DANBURY, CONNECTICUT |
| drawing prepared by AMES & WHITAKER ARCHITECTS 31 LIBERTY STREET SOUTHINGTON, CT | | date 07/25/18 scale AS NOTED | |
| project WESTERN CT STATE UNIVERSITY WHITE HALL 2ND AND 3RD FLOOR RENOVATIONS DANBURY, CONNECTICUT | | drawing no. A4.09 | |
| CAD no. | | project no. BI-RD-299 | |

1 NORTHWEST CORNER PARTIAL PLAN @ CORRIDOR

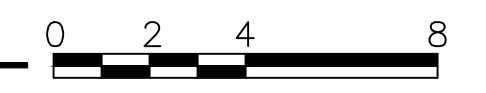

2 NORTHEAST CORNER PARTIAL PLAN @ CORRIDOR

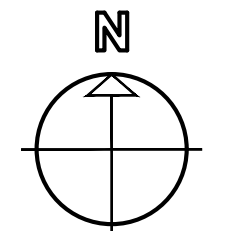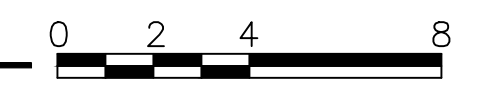

MATCH LINE

REMOVE LOCKERS AND PROVIDE BENCH, SEE DETAIL 1/A6.07

NURSING LAB 228

REMOVE LOCKERS AND PROVIDE BENCH, SEE DETAIL 1/A6.07

REMOVE LOCKERS AND PROVIDE BENCH, SEE DETAIL 1/A6.07

CLASSROOM 231

REMOVE LOCKERS AND PROVIDE BENCH, SEE DETAIL 1/A6.07

STAIR 299A

230

MEN 230

ELEVATOR

IDF DATA CLOSET 232

LOUNGE 233

3G

5C

1 A4.12

2 A4.12

2 A4.12

1 A4.10

2 A4.10

WOMEN 215

ELEVATOR

STORAGE 213

LOUNGE 211

3G

5C

1 A4.14

2 A4.14

1 A4.10

2 A4.10


LAB 212

LAB 210


STAIR 299D

EXISTING BENCH

EXISTING BENCH

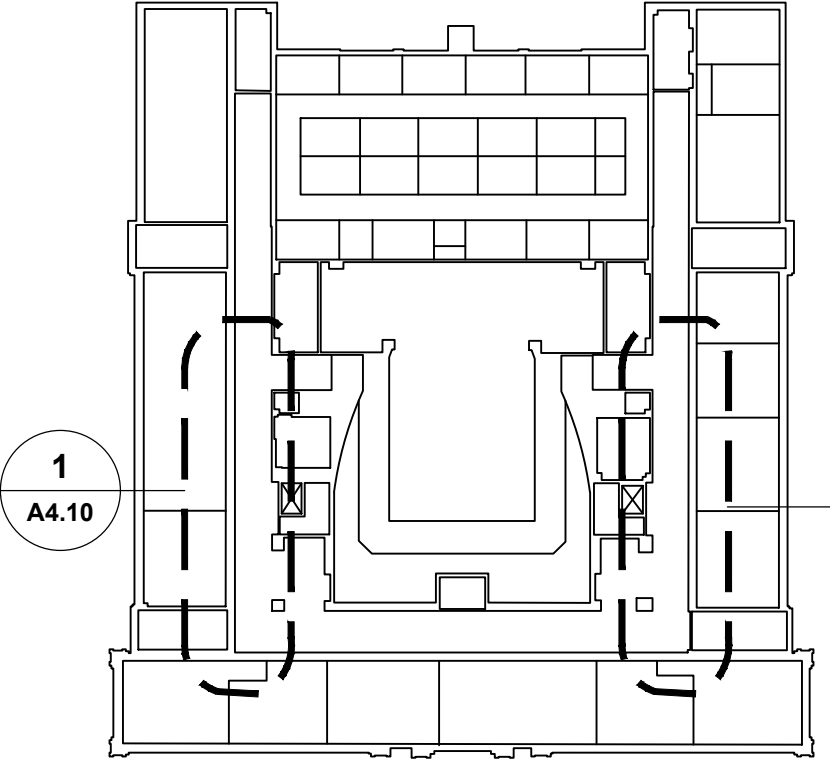

KEY PLAN

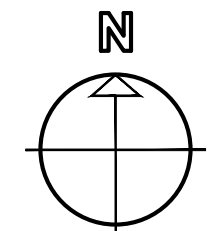


DEMOLITION KEY NOTES

- 1A REMOVE MASONRY WALL.
- 1B REMOVE STUD AND GYP BD WALL.
- 2A REMOVE DOOR AND FRAME.
- 2B REMOVE DOOR. EXISTING FRAME TO REMAIN.
- 3A REMOVE C.T. FLOOR.
- 3B REMOVE VCT FLOOR.
- 3C REMOVE CARPET.
- 4A REMOVE C.T. WAINSCOT AND BASE.
- 4B REMOVE VINYL BASE
- 5A REMOVE ACT CEILING.
- 6A REMOVE LAV.
- 6B REMOVE TOILET & TOILET PARTITION.
- 6C REMOVE URINAL AND URINAL SCREEN.

NEW WORK KEY NOTES

- 1C PROVIDE MASONRY WALL.
- 1D PROVIDE 1 HOUR RATED WALL, 3/8" METAL STUDS WITH 5/8" TYPE 'X' GYP. BOARD BOTH SIDES
- 1E PROVIDE 5/8" MOISTURE RESISTANT GYP BD ON EXISTING STUDS.
- 1F PROVIDE 3 3/8" METAL STUDS WITH 5/8" TYPE 'X' GYP. BOARD ONE SIDE
- 1G PROVIDE 3/8" METAL STUDS WITH 5/8" TYPE 'X' GYP. BOARD BOTH SIDES
- 2C PROVIDE WOOD DOOR AND HM FRAME.
- 2D PROVIDE WOOD DOOR IN EXISTING HM FRAME.
- 3D PROVIDE CT FLOOR AND CT BASE.
- 3E PROVIDE VCT AND RESILIENT BASE.
- 3F PROVIDE CARPET AND RESILIENT BASE.
- 3G EXISTING FLOORING TO REMAIN. (PROTECT DURING RENOVATION)
- 4C PROVIDE CT WAINSCOT AND BASE/ PAINT ABOVE
- 4D PREP AND PAINT WALLS
- 4E PROVIDE HORIZONTAL WINDOW BLINDS
- 5B PROVIDE ACT CEILING.
- 5C REMOVE & REINSTALL ACT CEILING AFTER MEP WORK IS COMPLETED.
- 5D PROVIDE GYPSUM BOARD CEILING/SOFFIT AND PAINT
- 5E PAINT EXISTING CEILING
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- 7A REMOVE TACK BOARDS. INSTALL PROVIDED OR EXISTING BOARDS AFTER ALL CORRIDOR WORK HAS BEEN COMPLETED. COORDINATE LOCATIONS WITH OWNER.
- 7B REMOVE BULLETIN BOARD. INSTALL PROVIDED OR EXISTING BOARDS AFTER ALL CORRIDOR WORK HAS BEEN COMPLETED. COORDINATE LOCATIONS WITH OWNER.
- 7C EXISTING DISPLAY CASES TO REMAIN IN PLACE. PAINT INTERIOR TO MATCH CORRIDOR COLOR. PAINT TRIM TO MATCH DOOR TRIM COLOR.

1 SOUTHWEST CORNER PARTIAL PLAN @ CORRIDOR



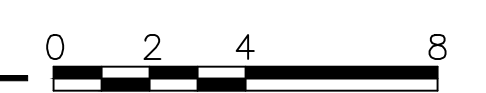


2 SOUTHEAST CORNER PARTIAL PLAN @ CORRIDOR



| drawing title | | STATE OF CONNECTICUT | |
|--|---------|---------------------------------------|--|
| SECOND FLOOR - PARTIAL PLANS AT CORRIDOR | | DEPARTMENT OF ADMINISTRATIVE SERVICES | |
| REVISIONS | | | |
| mark | date | description | |
| | 8/4/17 | SCHEMATIC DESIGN SUBMISSION | |
| | 1/15/18 | DESIGN DEVELOPMENT SUBMISSION | |
| | 4/16/18 | CONSTRUCTION DOCUMENTS | |
| | 5/23/18 | | |
| | 7/25/18 | | |
| | 1/21/19 | | |



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| drawing prepared by | | date | |
| AMES & WHITAKER ARCHITECTS | | 07/25/18 | |
| 31 LIBERTY STREET | | scale | |
| SOUTHINGTON, CT | | AS NOTED | |
| project | | drawn by | |
| WESTERN CT STATE UNIVERSITY | | CA/SP | |
| WHITE HALL | | approved by | |
| 2ND AND 3RD FLOOR RENOVATIONS | | AL | |
| DANBURY, CONNECTICUT | | drawing no. | |
| CAD no. | project no. | A4.10 | |
| | BI-RD-299 | | |

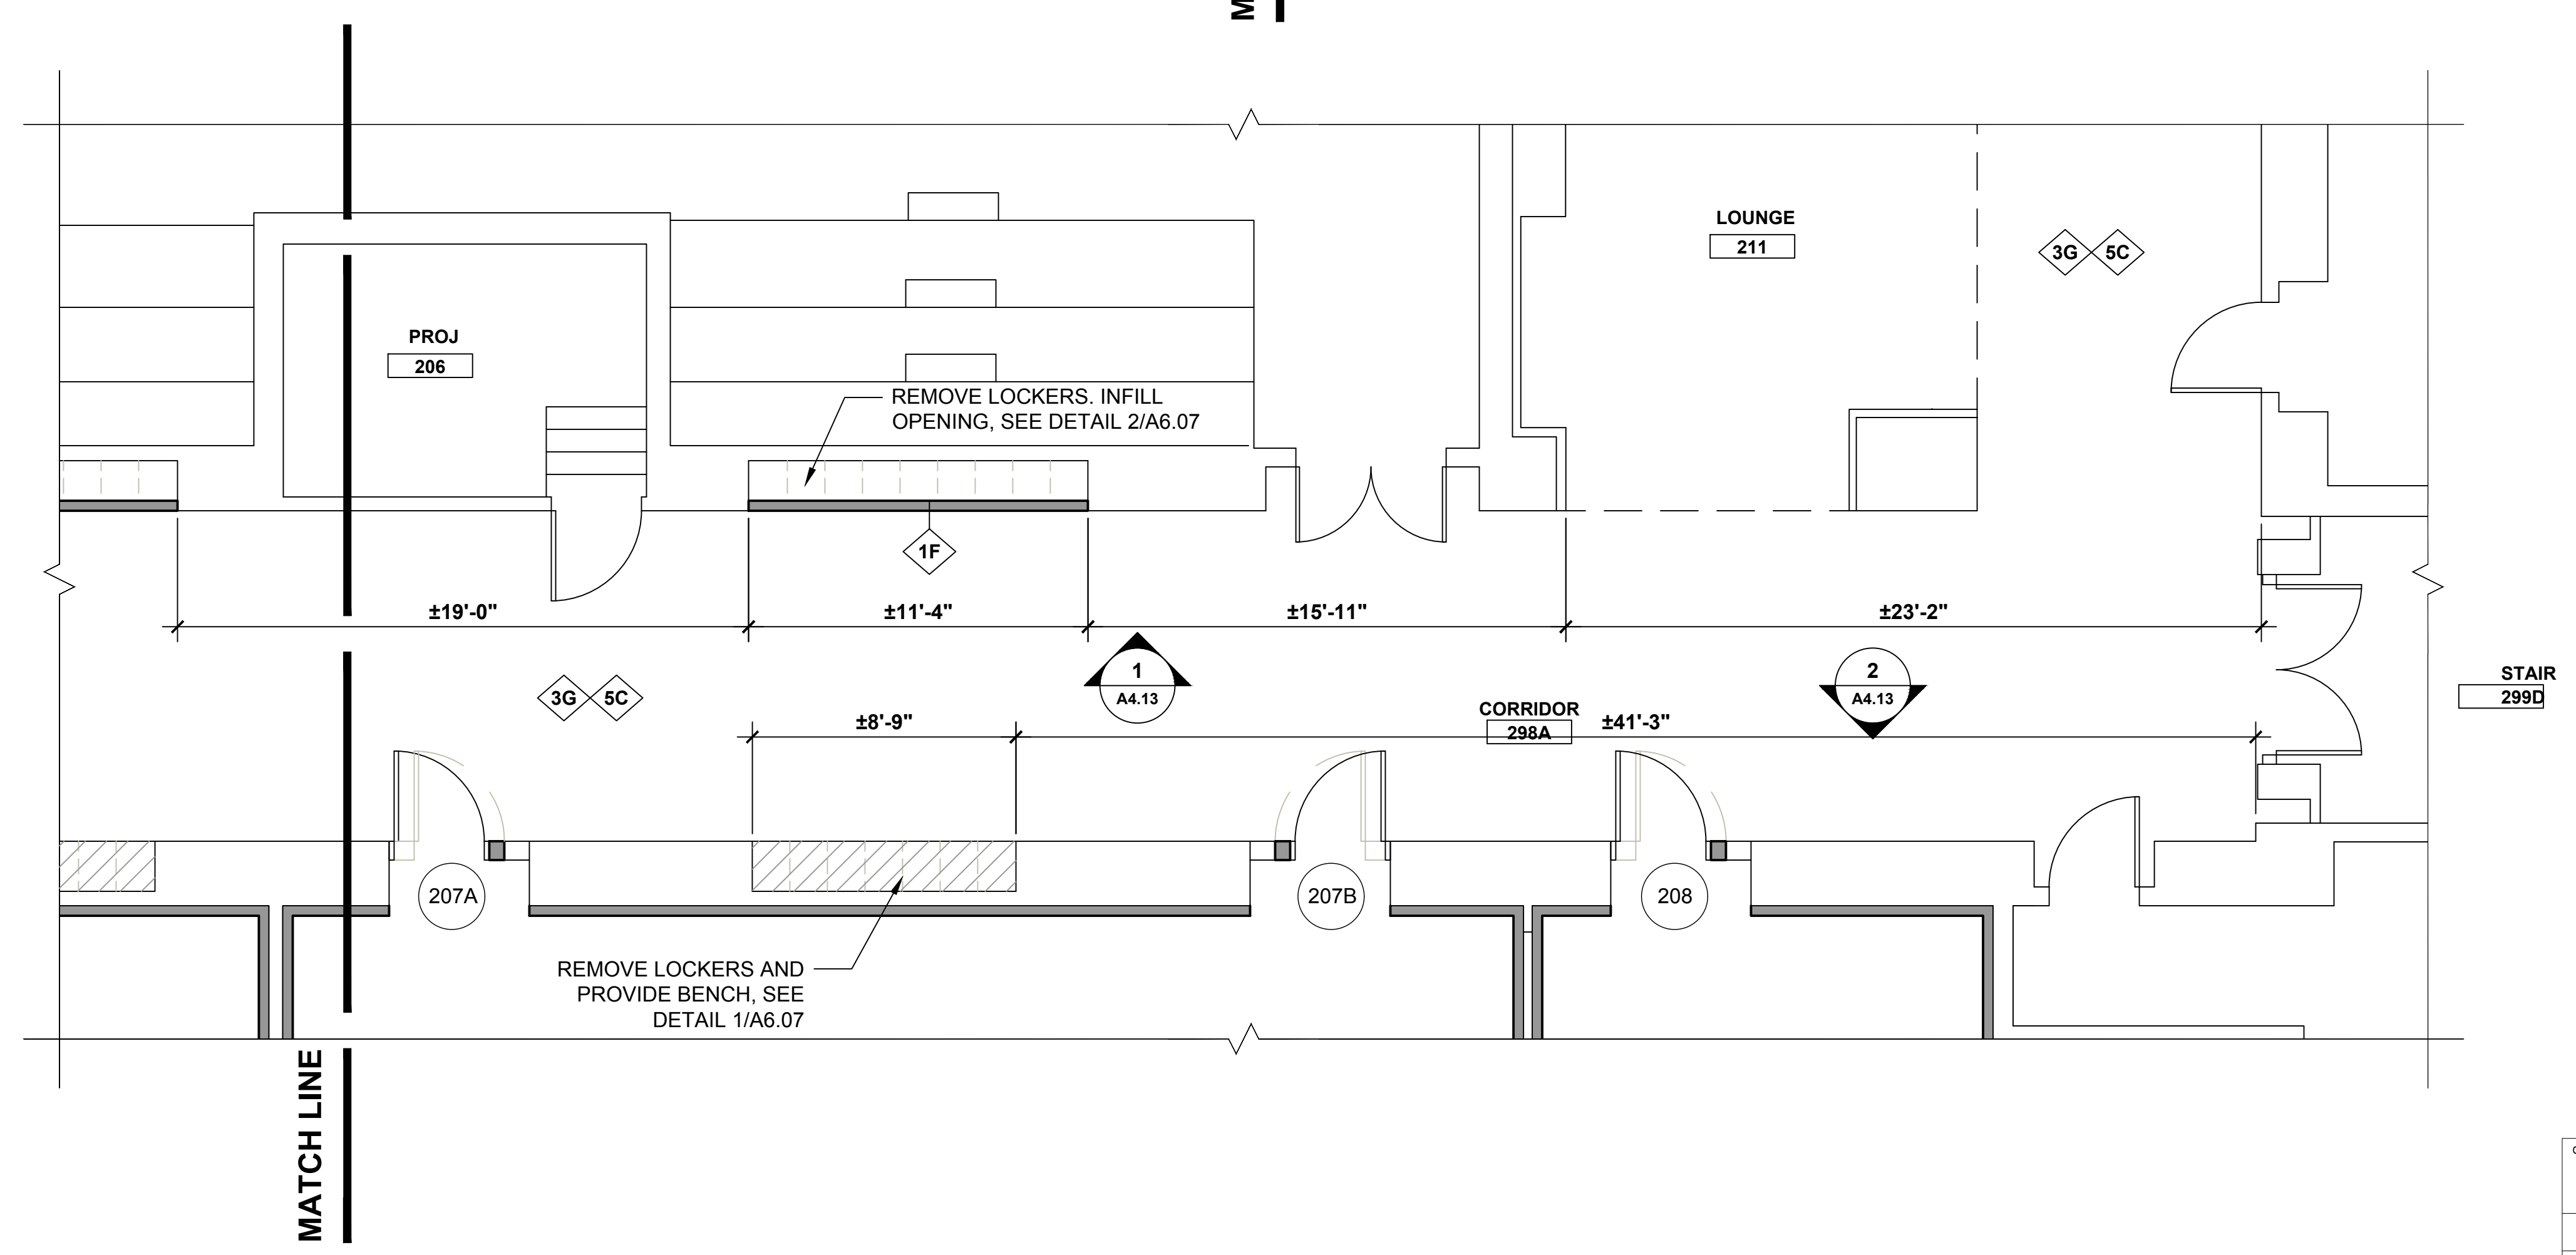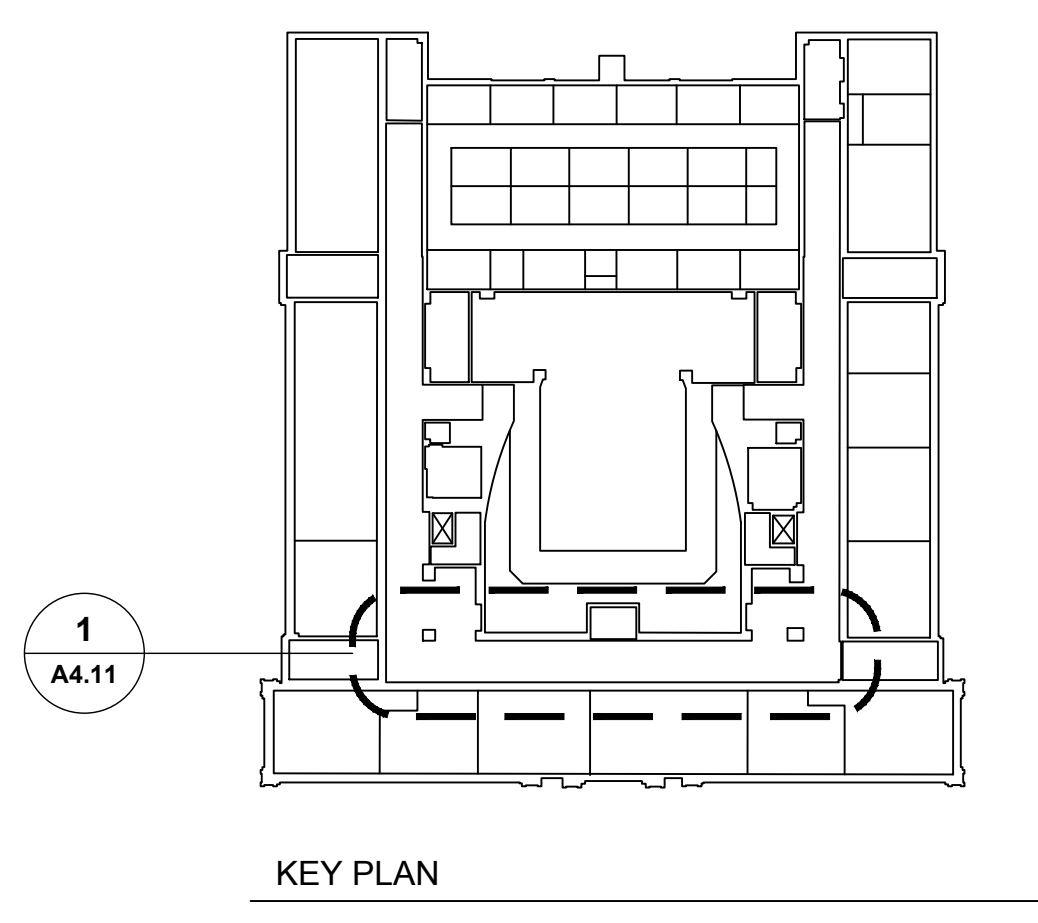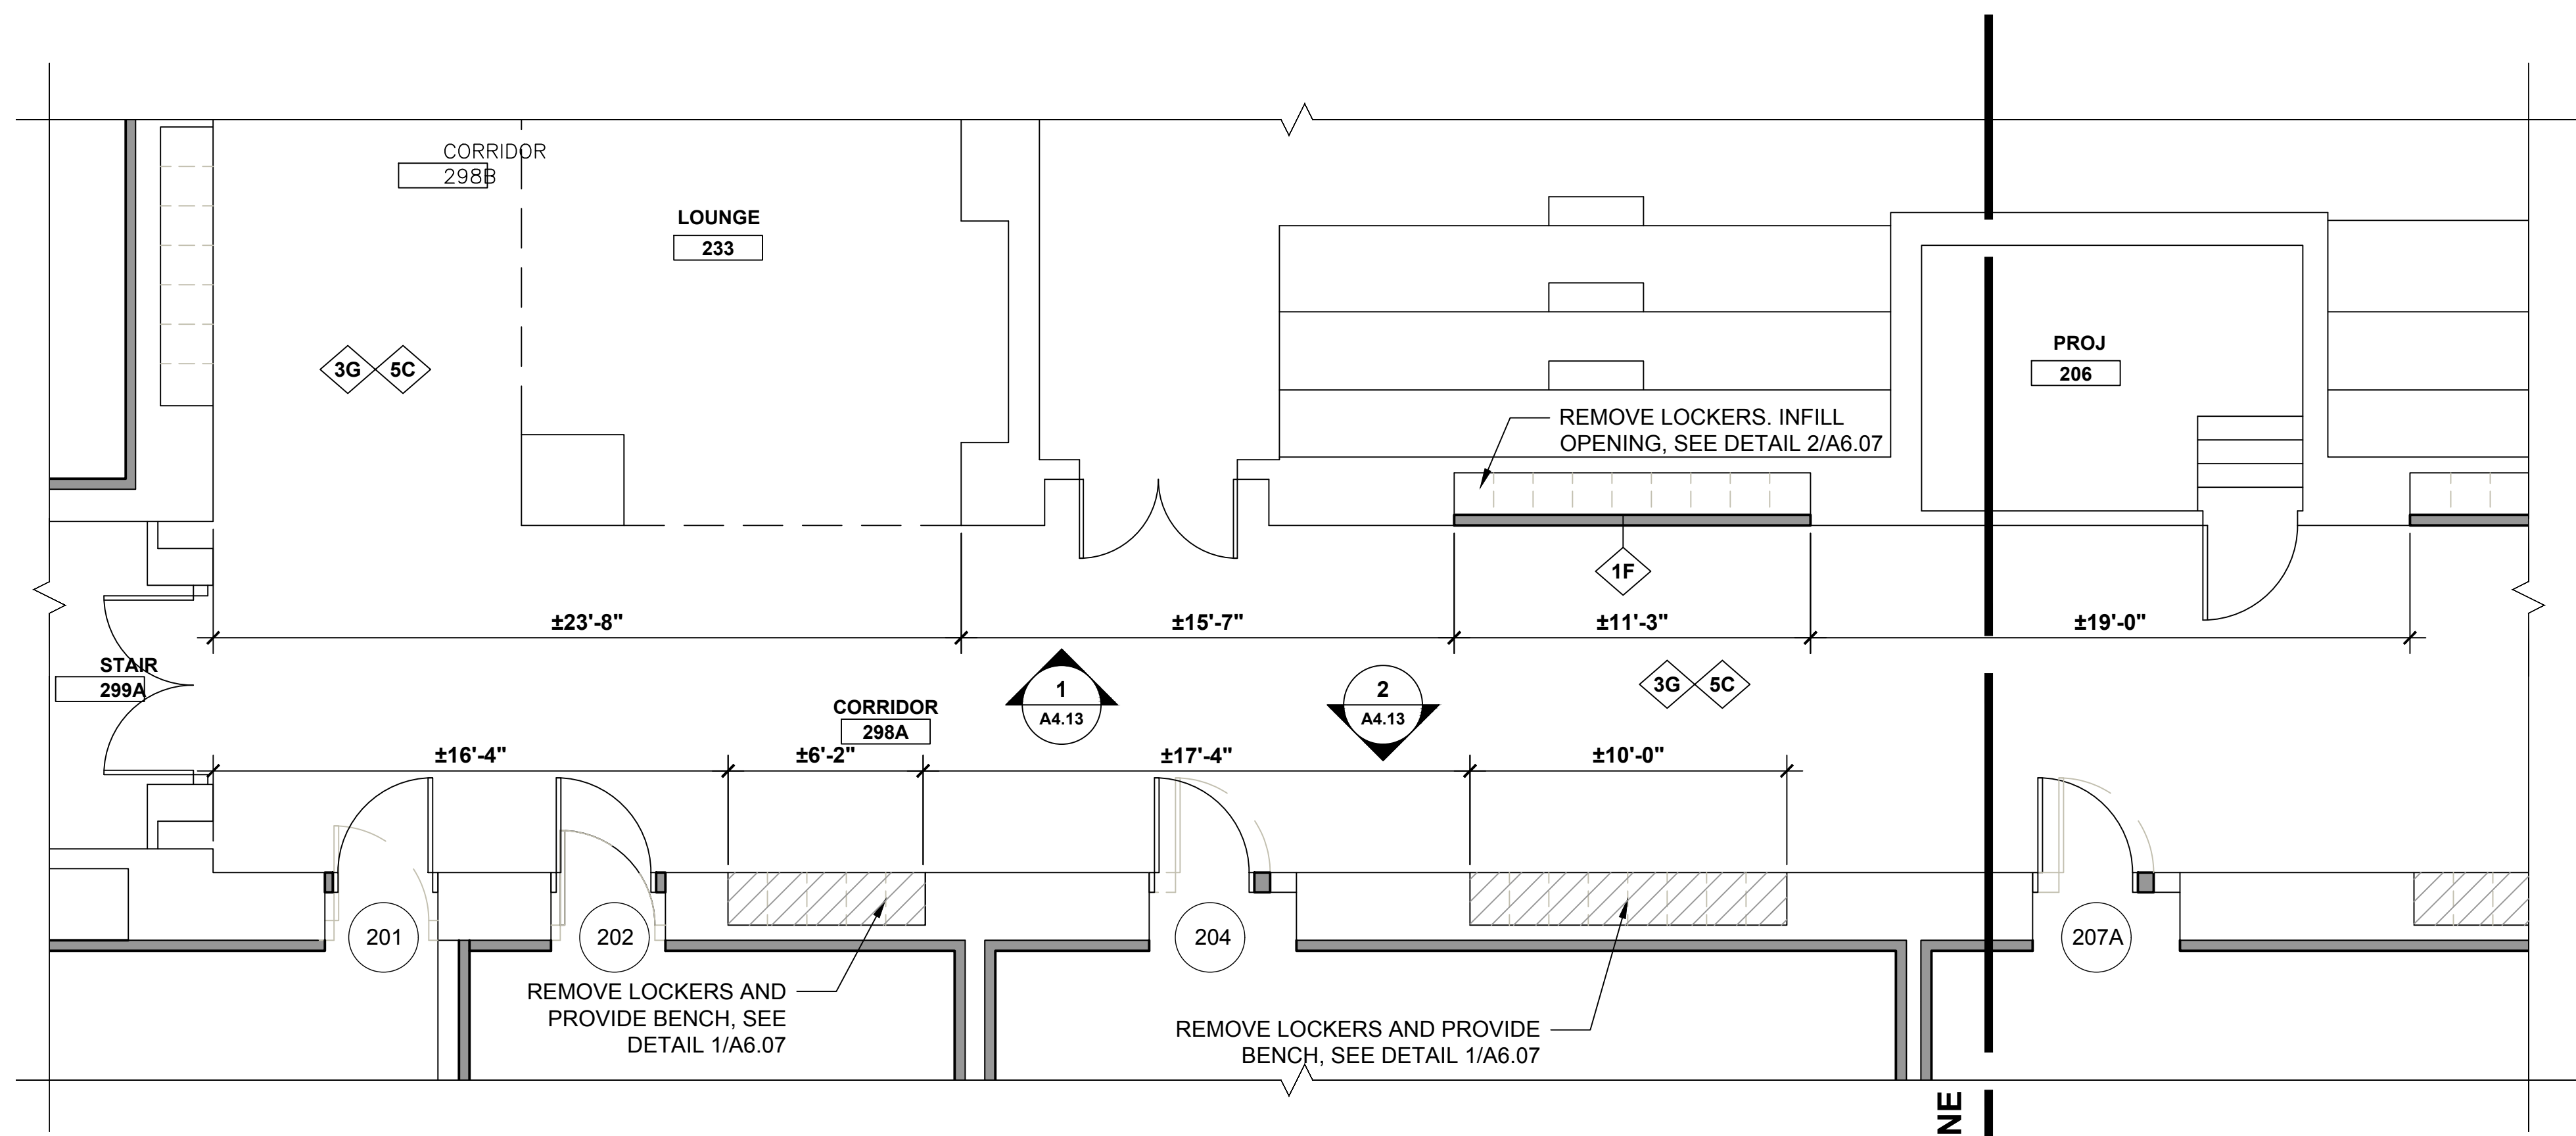


- DEMOLITION KEY NOTES**
- 1A REMOVE MASONRY WALL.
 - 1B REMOVE STUD AND GYP BD WALL.
 - 2A REMOVE DOOR AND FRAME.
 - 2B REMOVE DOOR. EXISTING FRAME TO REMAIN.
 - 3A REMOVE C.T. FLOOR.
 - 3B REMOVE VCT FLOOR.
 - 3C REMOVE CARPET.
 - 4A REMOVE C.T. WAINSCOT AND BASE.
 - 4B REMOVE VINYL BASE
 - 5A REMOVE ACT CEILING.
 - 6A REMOVE LAV.
 - 6B REMOVE TOILET & TOILET PARTITION.
 - 6C REMOVE URINAL AND URINAL SCREEN.

- NEW WORK KEY NOTES**
- 1C PROVIDE MASONRY WALL.
 - 1D PROVIDE 1 HOUR RATED WALL, 3/8" METAL STUDS WITH 5/8" TYPE 'X' GYP. BOARD BOTH SIDES
 - 1E PROVIDE 5/8" MOISTURE RESISTANT GYP BD ON EXISTING STUDS.
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 - 2D PROVIDE WOOD DOOR IN EXISTING HM FRAME.
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 - 3E PROVIDE VCT AND RESILIENT BASE.
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 - 4D PREP AND PAINT WALLS
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 - 5C REMOVE & REINSTALL ACT CEILING AFTER MEP WORK IS COMPLETED.
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 - 6F PROVIDE URINAL & SCREEN
 - 7A REMOVE TACK BOARDS. INSTALL PROVIDED OR EXISTING BOARDS AFTER ALL CORRIDOR WORK HAS BEEN COMPLETED. COORDINATE LOCATIONS WITH OWNER.
 - 7B REMOVE BULLETIN BOARD. INSTALL PROVIDED OR EXISTING BOARDS AFTER ALL CORRIDOR WORK HAS BEEN COMPLETED. COORDINATE LOCATIONS WITH OWNER.
 - 7C EXISTING DISPLAY CASES TO REMAIN IN PLACE. PAINT INTERIOR TO MATCH CORRIDOR COLOR. PAINT TRIM TO MATCH DOOR TRIM COLOR.


1 SOUTH WING PARTIAL PLAN AT CORRIDOR

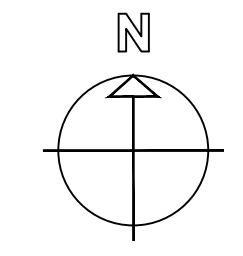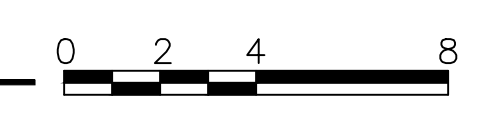


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| drawing title SECOND FLOOR - PARTIAL PLANS AT CORRIDOR | | | STATE OF CONNECTICUT DEPARTMENT OF ADMINISTRATIVE SERVICES | |
| REVISIONS | | | drawing prepared by AMES & WHITAKER ARCHITECTS | |
| mark | date | description | 31 LIBERTY STREET SOUTHINGTON, CT | date 07/25/18 scale AS NOTED |
| | 8/4/17 | SCHEMATIC DESIGN SUBMISSION | project WESTERN CT STATE UNIVERSITY WHITE HALL 2ND AND 3RD FLOOR RENOVATIONS DANBURY, CONNECTICUT | drawn by CA/SP approved by AL drawing no. A4.11 |
| | 1/15/18 | DESIGN DEVELOPMENT SUBMISSION | | |
| | 4/16/18 | CONSTRUCTION DOCUMENTS | | |
| | 5/23/18 7/25/18 | | | |
| CAD no. | | | project no. BI-RD-299 | |

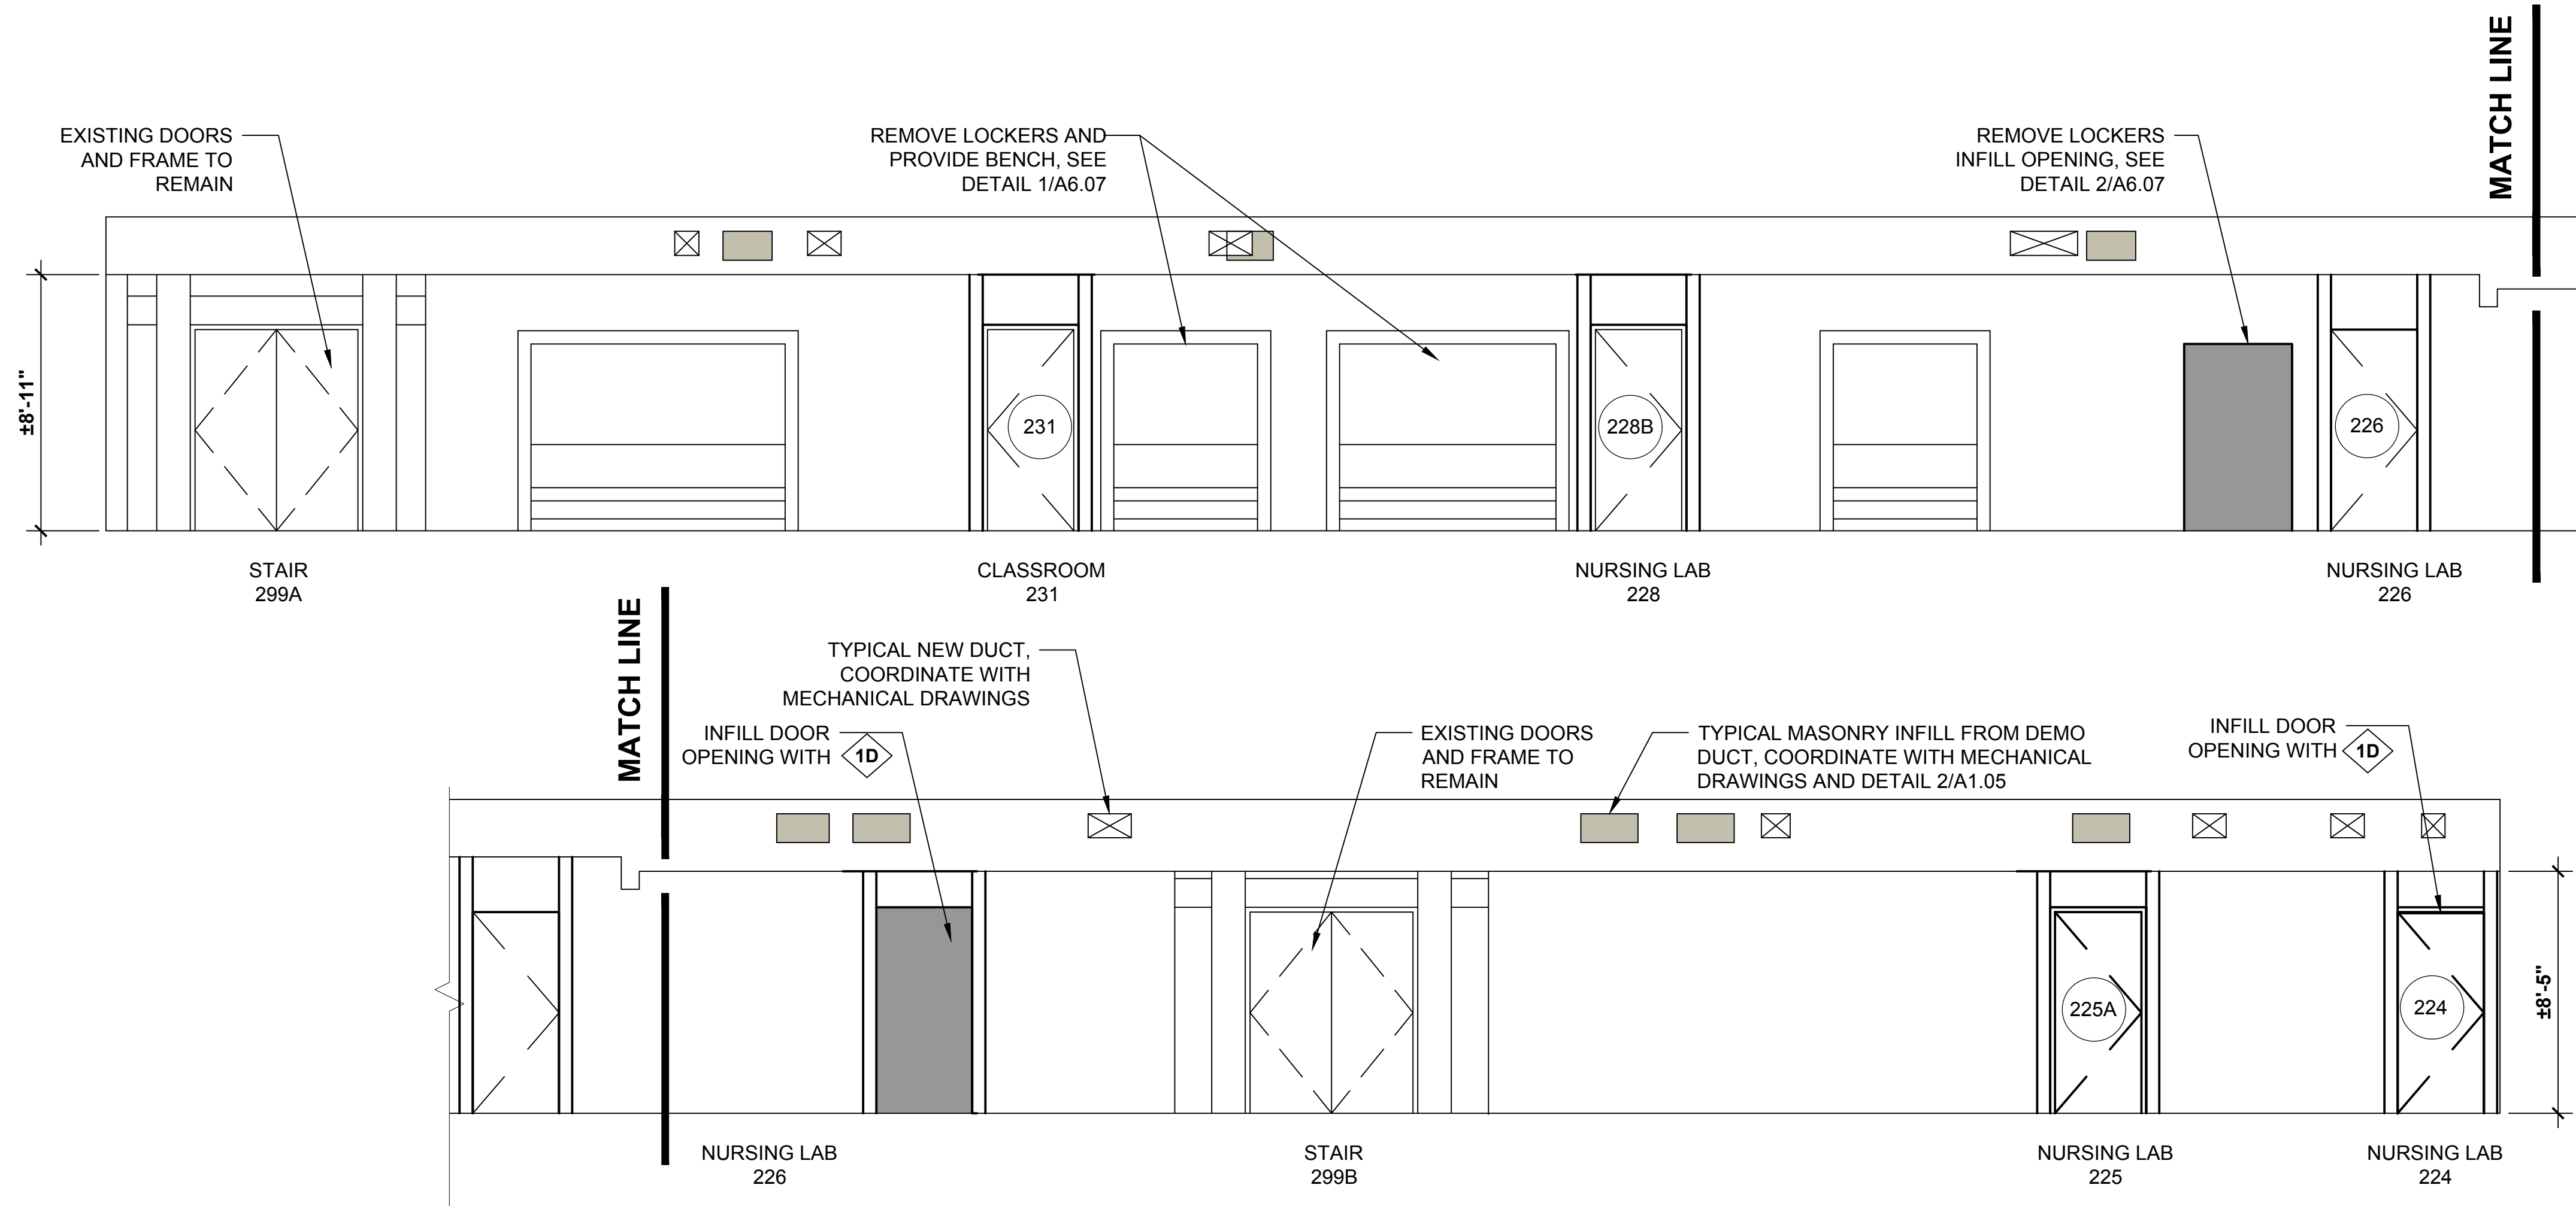

1 CORRIDOR INTERIOR ELEVATION

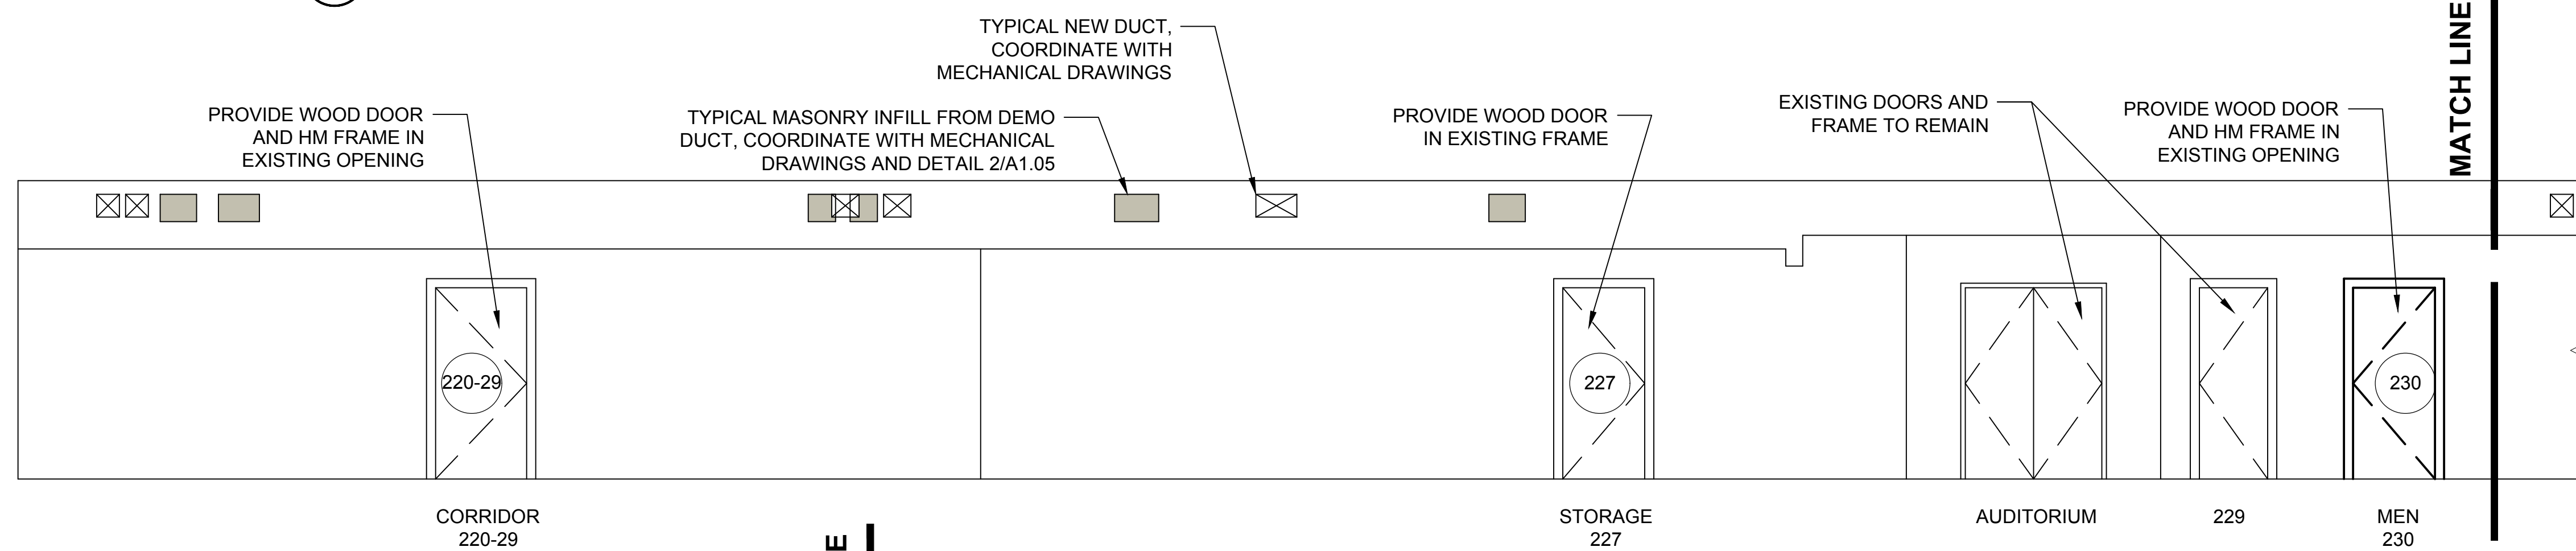


2 CORRIDOR INTERIOR ELEVATION

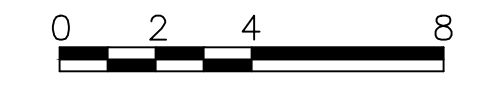


- TYPICAL CORRIDOR NOTES:**
- EXISTING FLOORING TO REMAIN. (PROTECT DURING RENOVATION)
 - PREP AND PAINT WALLS.
 - REMOVE AND REINSTALL ACT CEILING AFTER MEP WORK IS COMPLETED.


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| drawing title SECOND FLOOR - INTERIOR ELEVATIONS AT CORRIDOR | | | STATE OF CONNECTICUT DEPARTMENT OF ADMINISTRATIVE SERVICES | | |
| REVISIONS | | | drawing prepared by AMES & WHITAKER ARCHITECTS 31 LIBERTY STREET SOUTHINGTON, CT | | |
| mark | date | description | date | scale | AS NOTED |
| | 8/4/17 | SCHEMATIC DESIGN SUBMISSION | 07/25/18 | | |
| | 1/15/18 | DESIGN DEVELOPMENT SUBMISSION | | | |
| | 4/16/18 | CONSTRUCTION DOCUMENTS | | | |
| | 5/23/18 | | | | |
| | 7/25/18 | | | | |
| | 1/21/19 | | | | |
| project WESTERN CT STATE UNIVERSITY WHITE HALL 2ND AND 3RD FLOOR RENOVATIONS DANBURY, CONNECTICUT | | | drawn by CA/SP | approved by AL | drawing no. A4.12 |
| CAD no. | | | project no. BI-RD-299 | | |

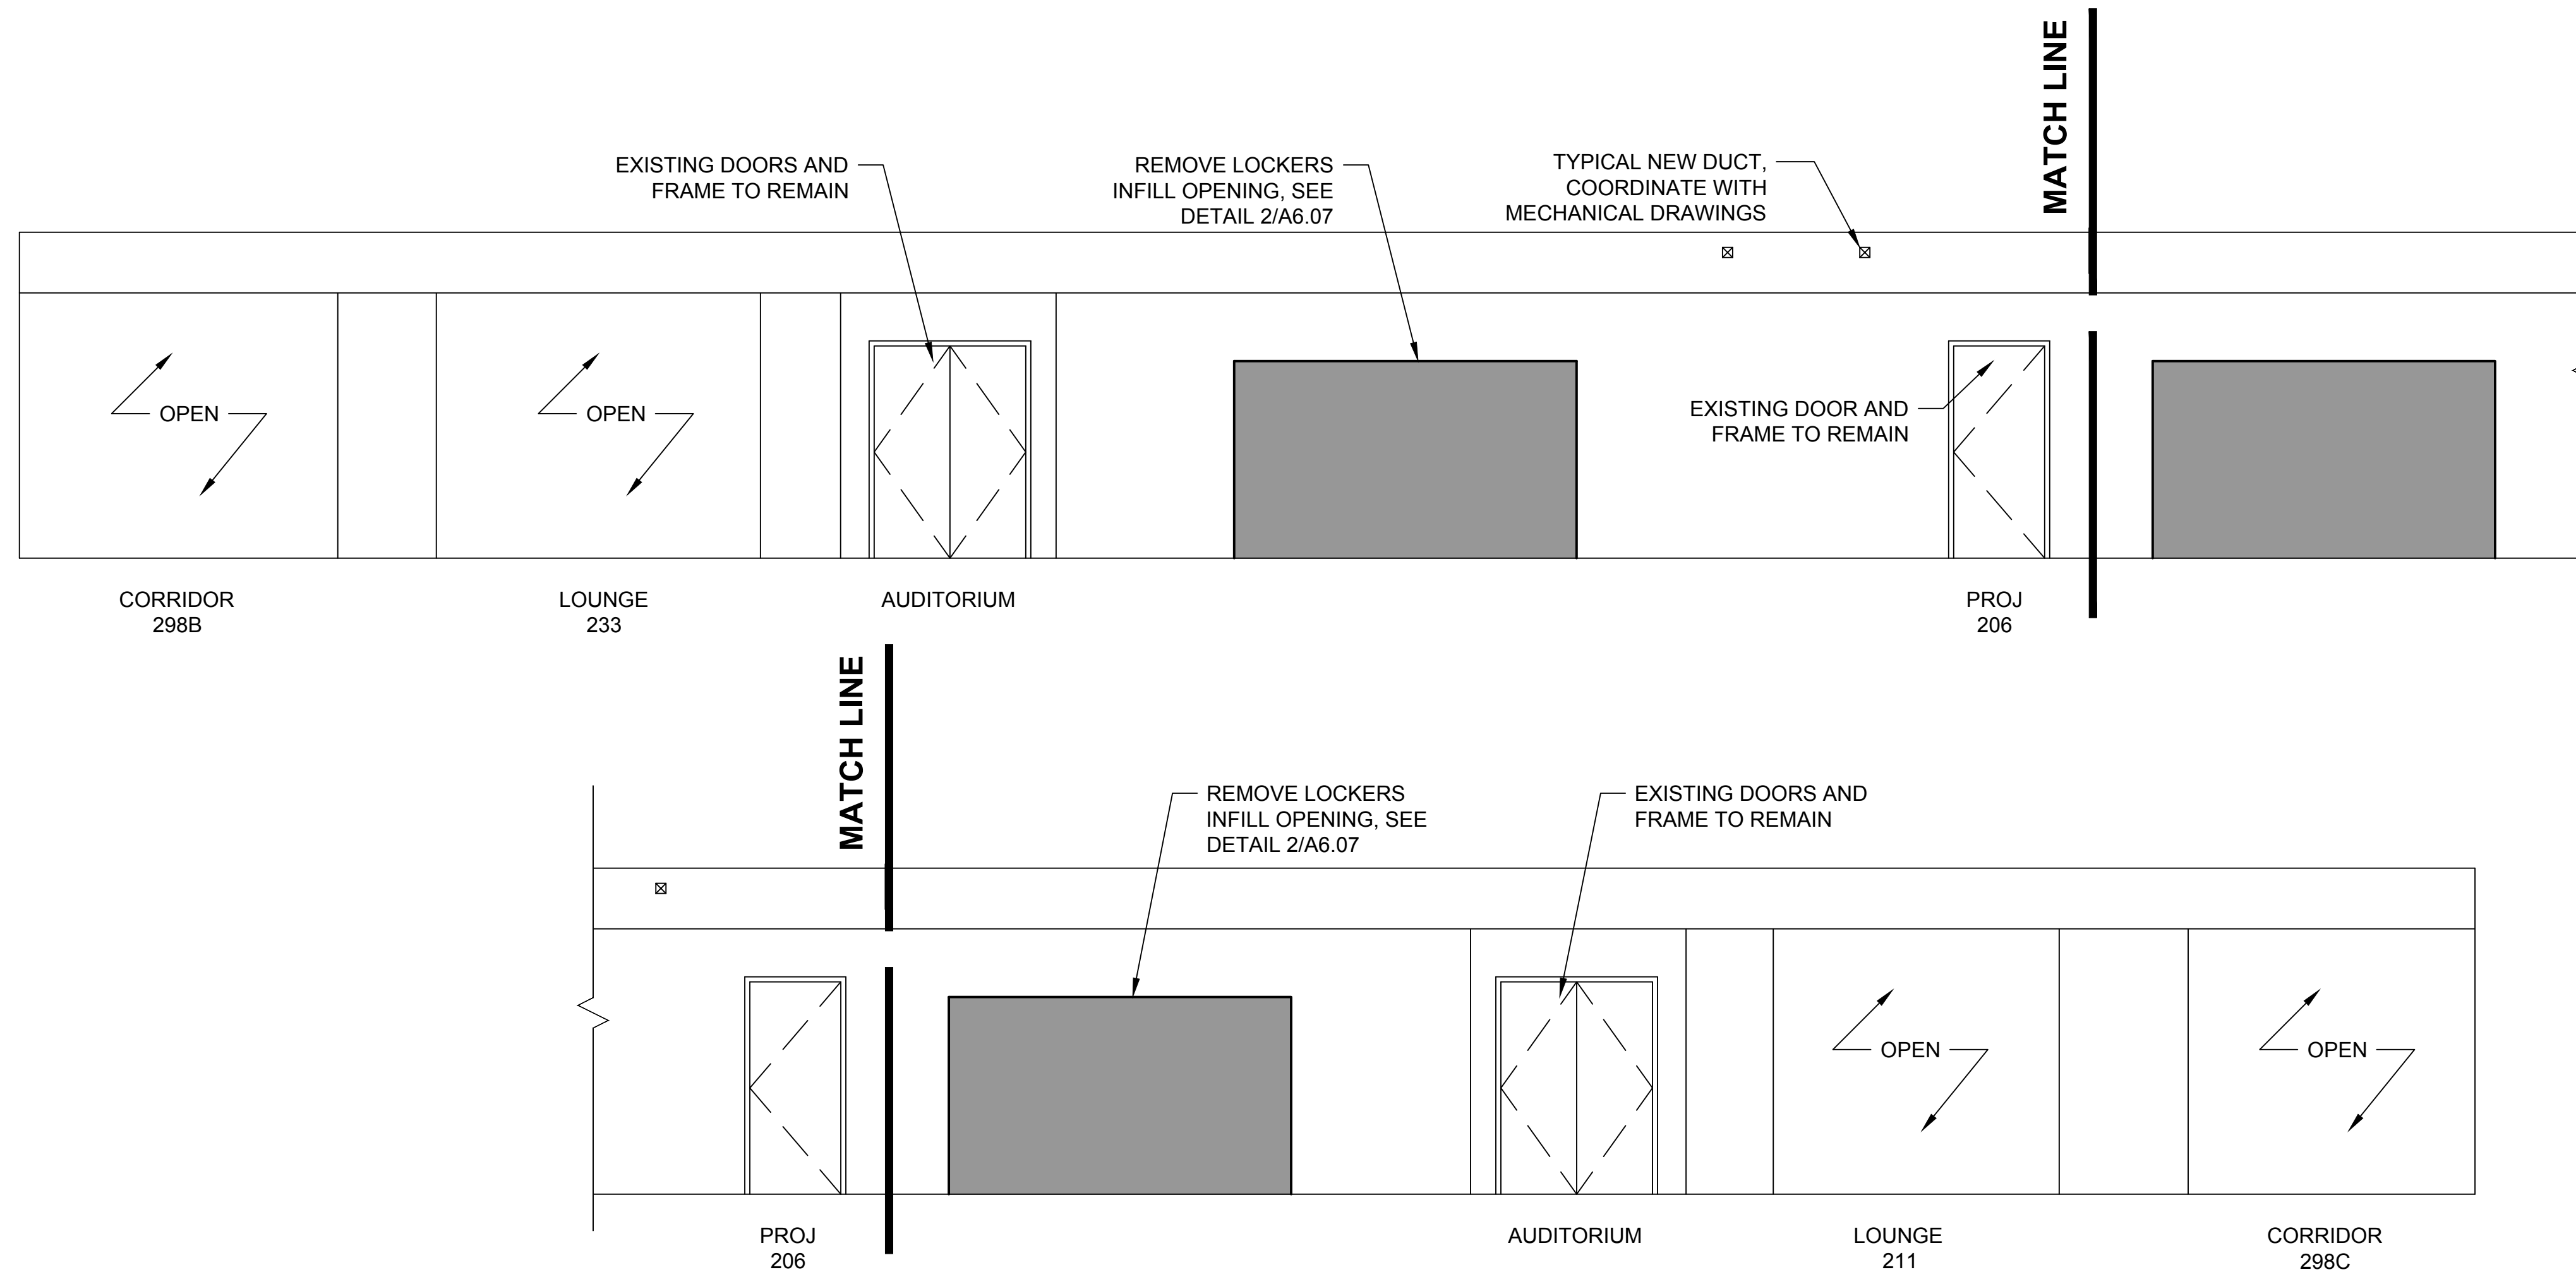

1 CORRIDOR INTERIOR ELEVATION


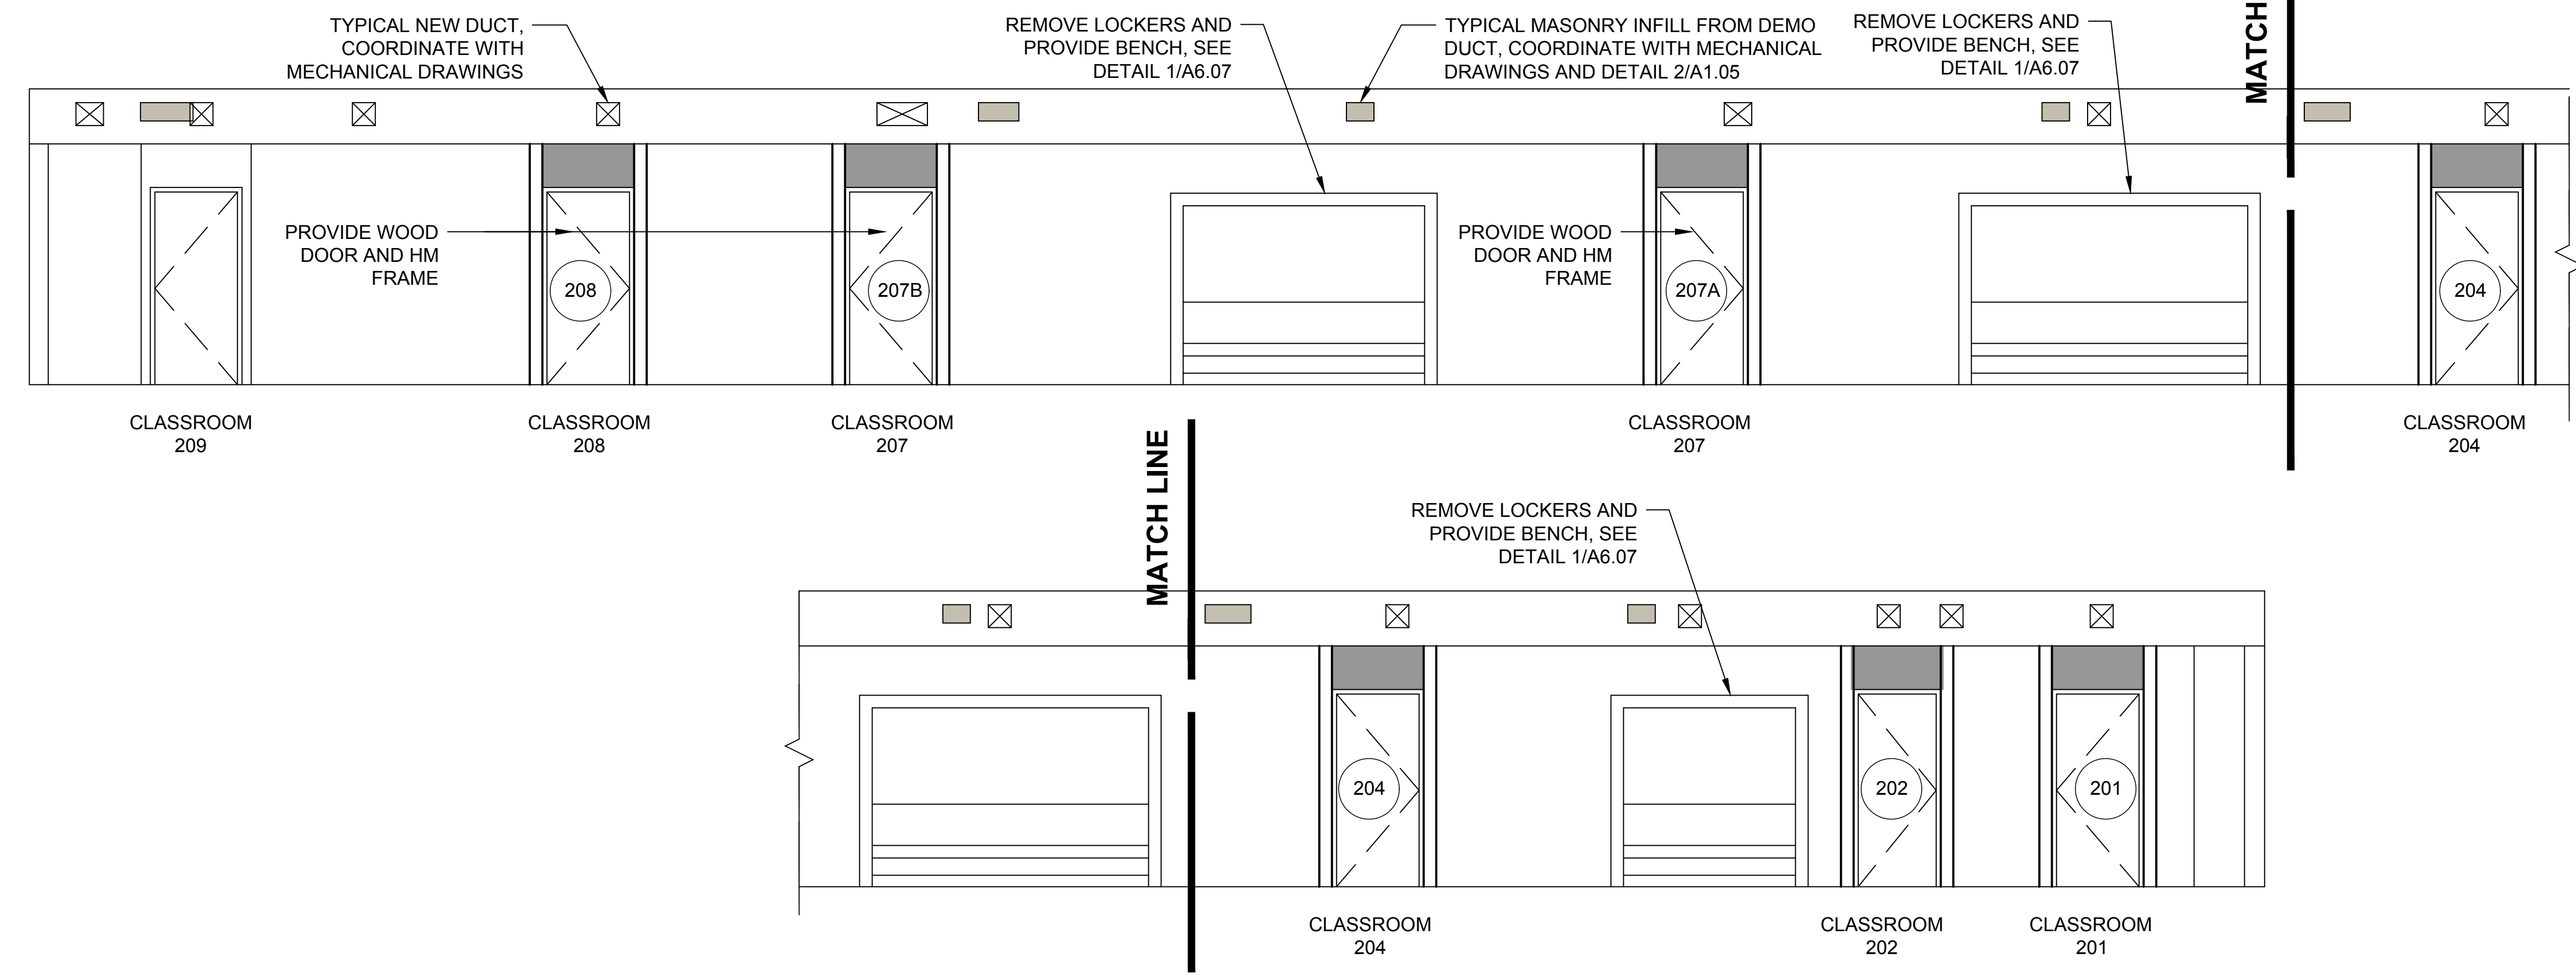


2 CORRIDOR INTERIOR ELEVATION


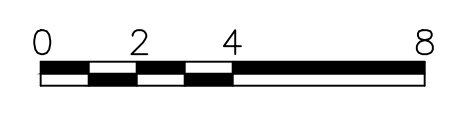


- TYPICAL CORRIDOR NOTES:**
- EXISTING FLOORING TO REMAIN. (PROTECT DURING RENOVATION)
 - PREP AND PAINT WALLS.
 - REMOVE AND REINSTALL ACT CEILING AFTER MEP WORK IS COMPLETED.

| | | | | | |
|---|---------|-------------------------------|--|-------------------|-----------------------------|
| drawing title SECOND FLOOR - INTERIOR ELEVATIONS AT CORRIDOR | | | STATE OF CONNECTICUT DEPARTMENT OF ADMINISTRATIVE SERVICES | | |
| REVISIONS | | | drawing prepared by AMES & WHITAKER ARCHITECTS 31 LIBERTY STREET SOUTHINGTON, CT | | |
| mark | date | description | date | scale | AS NOTED |
| | 8/4/17 | SCHEMATIC DESIGN SUBMISSION | 07/25/18 | | |
| | 1/15/18 | DESIGN DEVELOPMENT SUBMISSION | | | |
| | 4/16/18 | CONSTRUCTION DOCUMENTS | | | |
| | 5/23/18 | | | | |
| | 7/25/18 | | | | |
| project WESTERN CT STATE UNIVERSITY WHITE HALL 2ND AND 3RD FLOOR RENOVATIONS DANBURY, CONNECTICUT | | | drawn by CA/SP | approved by AL | drawing no. A4.13 |
| CAD no. | | | project no. BI-RD-299 | | |

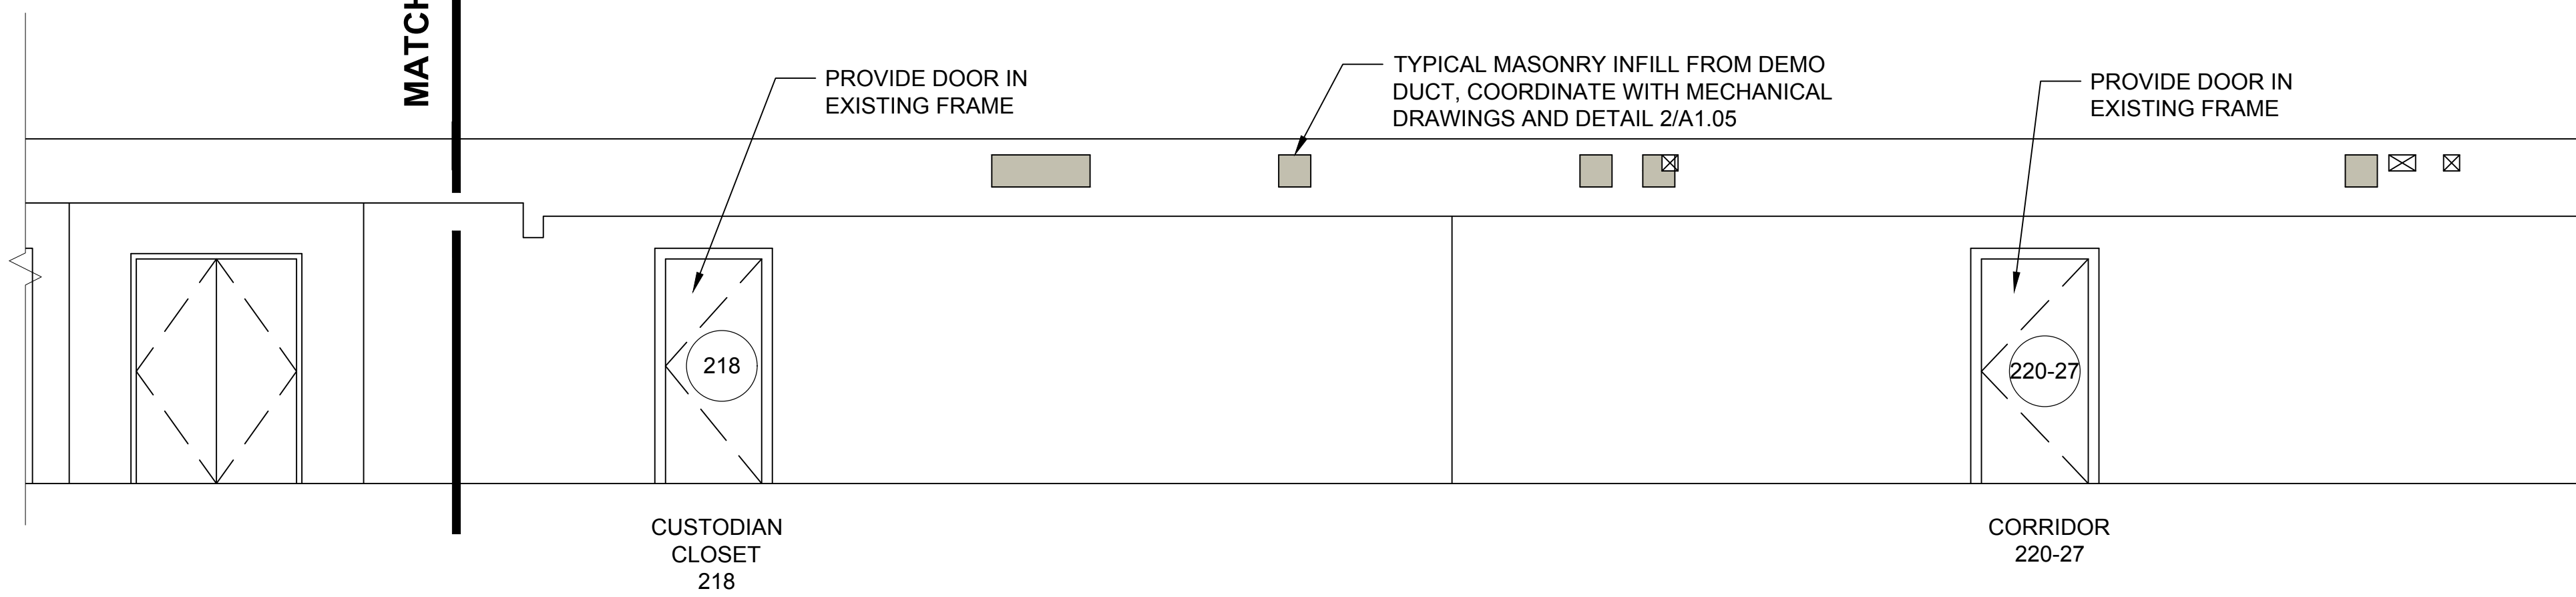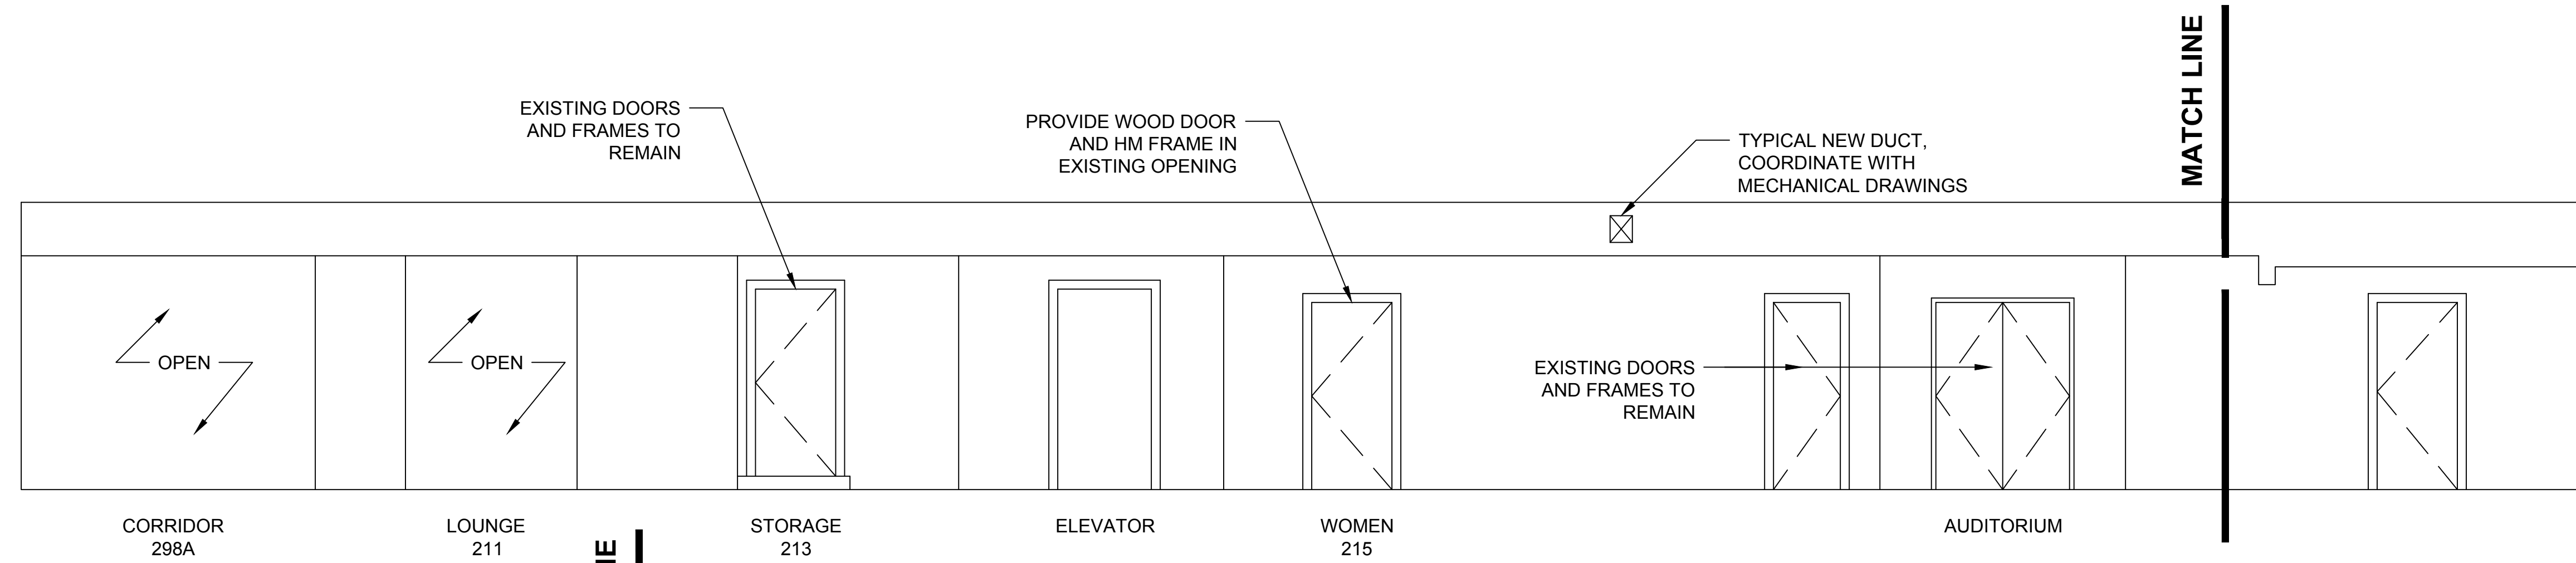

1 CORRIDOR INTERIOR ELEVATION

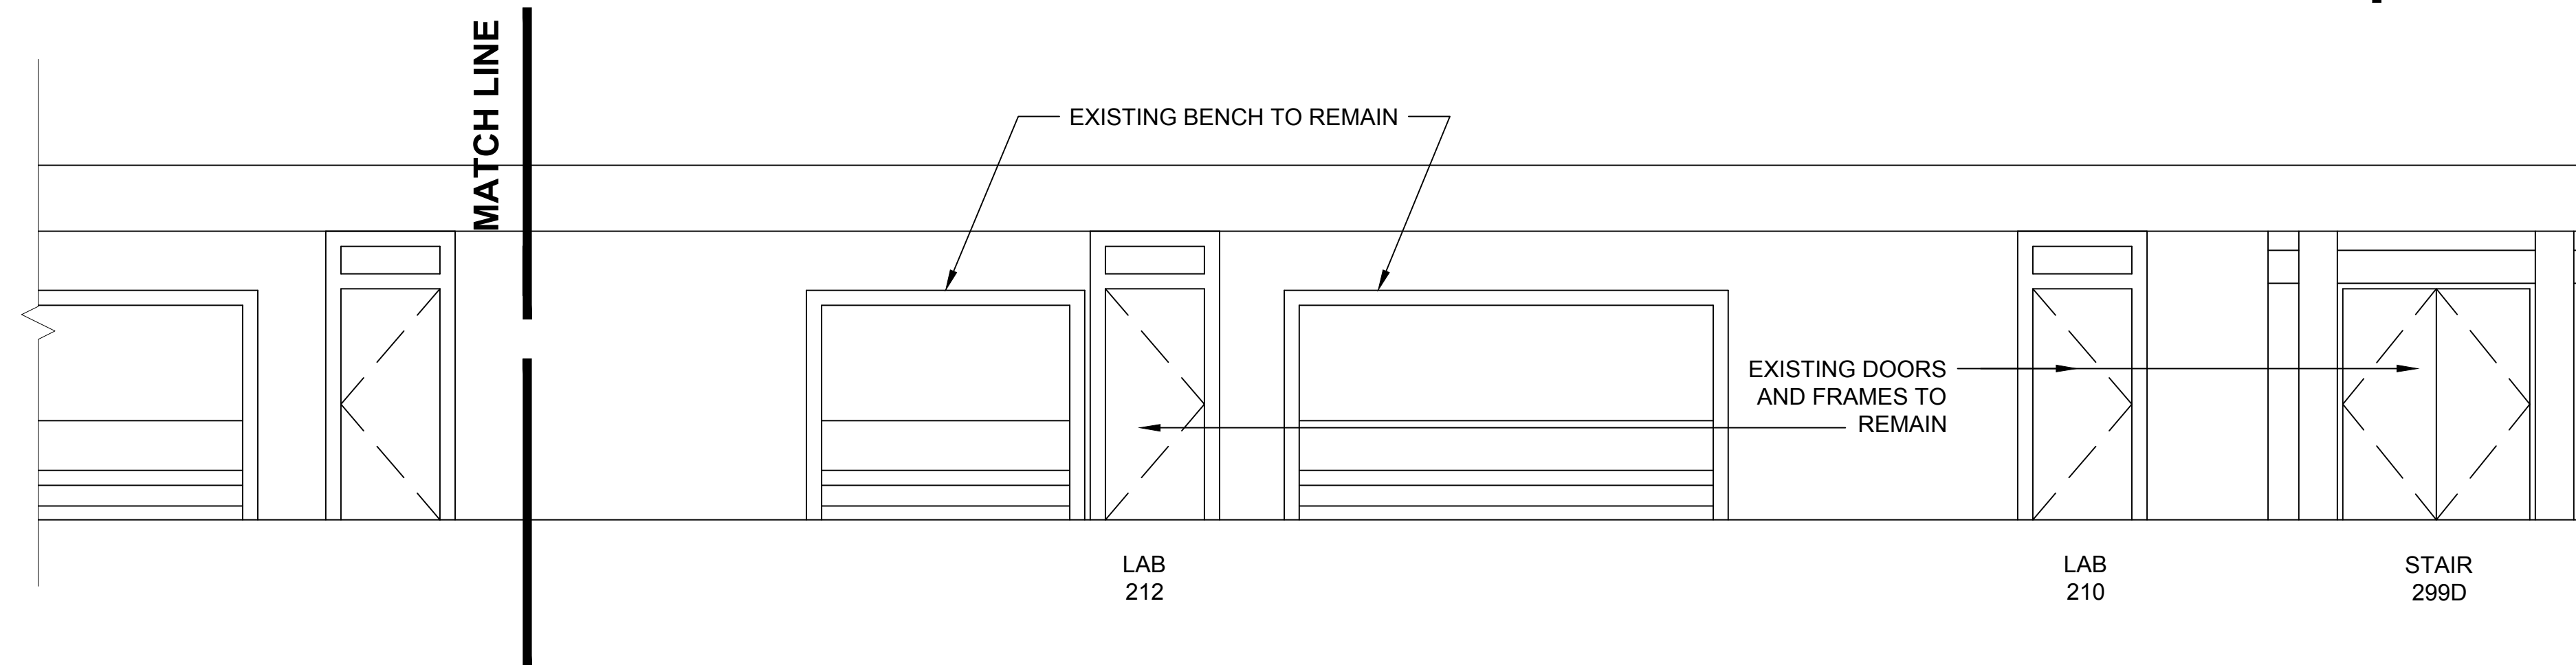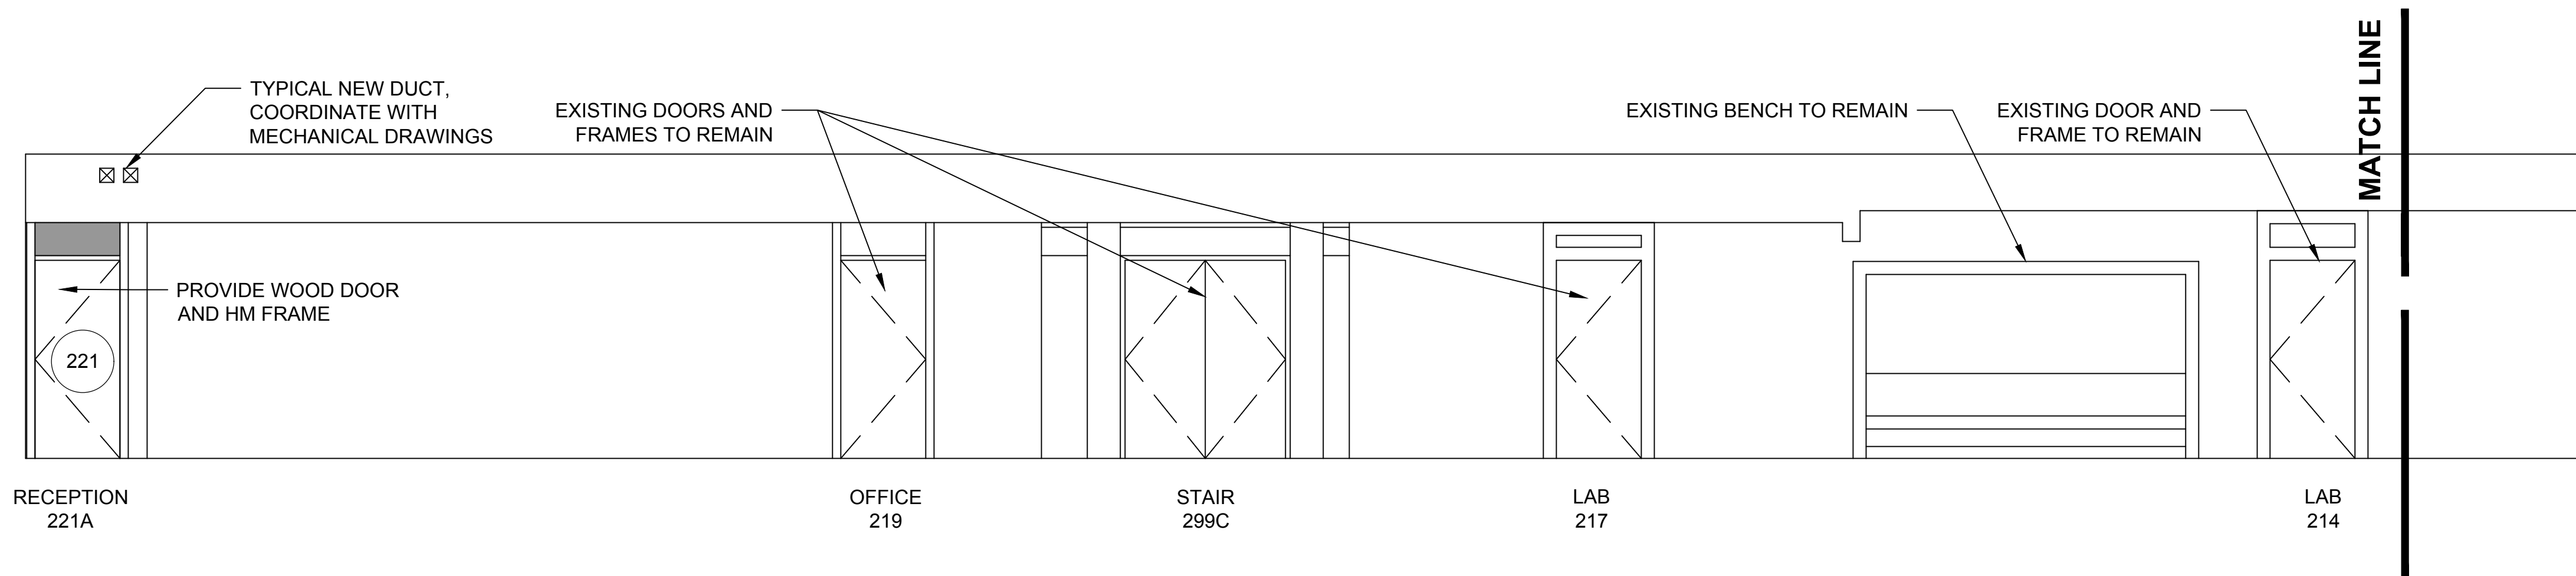


2 CORRIDOR INTERIOR ELEVATION




- TYPICAL CORRIDOR NOTES:**
- EXISTING FLOORING TO REMAIN. (PROTECT DURING RENOVATION)
 - PREP AND PAINT WALLS.
 - REMOVE AND REINSTALL ACT CEILING AFTER MEP WORK IS COMPLETED.


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| drawing title SECOND FLOOR - INTERIOR ELEVATIONS AT CORRIDOR | | | STATE OF CONNECTICUT DEPARTMENT OF ADMINISTRATIVE SERVICES | | |
| REVISIONS | | | drawing prepared by AMES & WHITAKER ARCHITECTS 31 LIBERTY STREET SOUTHINGTON, CT | | |
| mark | date | description | date | scale | AS NOTED |
| | 8/4/17 | SCHEMATIC DESIGN SUBMISSION | 07/25/18 | | |
| | 1/15/18 | DESIGN DEVELOPMENT SUBMISSION | | | |
| | 4/16/18 | CONSTRUCTION DOCUMENTS | | | |
| | 5/23/18 | | | | |
| | 7/25/18 | | | | |
| | 1/21/19 | | | | |
| project WESTERN CT STATE UNIVERSITY WHITE HALL 2ND AND 3RD FLOOR RENOVATIONS DANBURY, CONNECTICUT | | | drawn by CA/SP | approved by AL | drawing no. A4.14 |
| CAD no. | | | project no. BI-RD-299 | | |

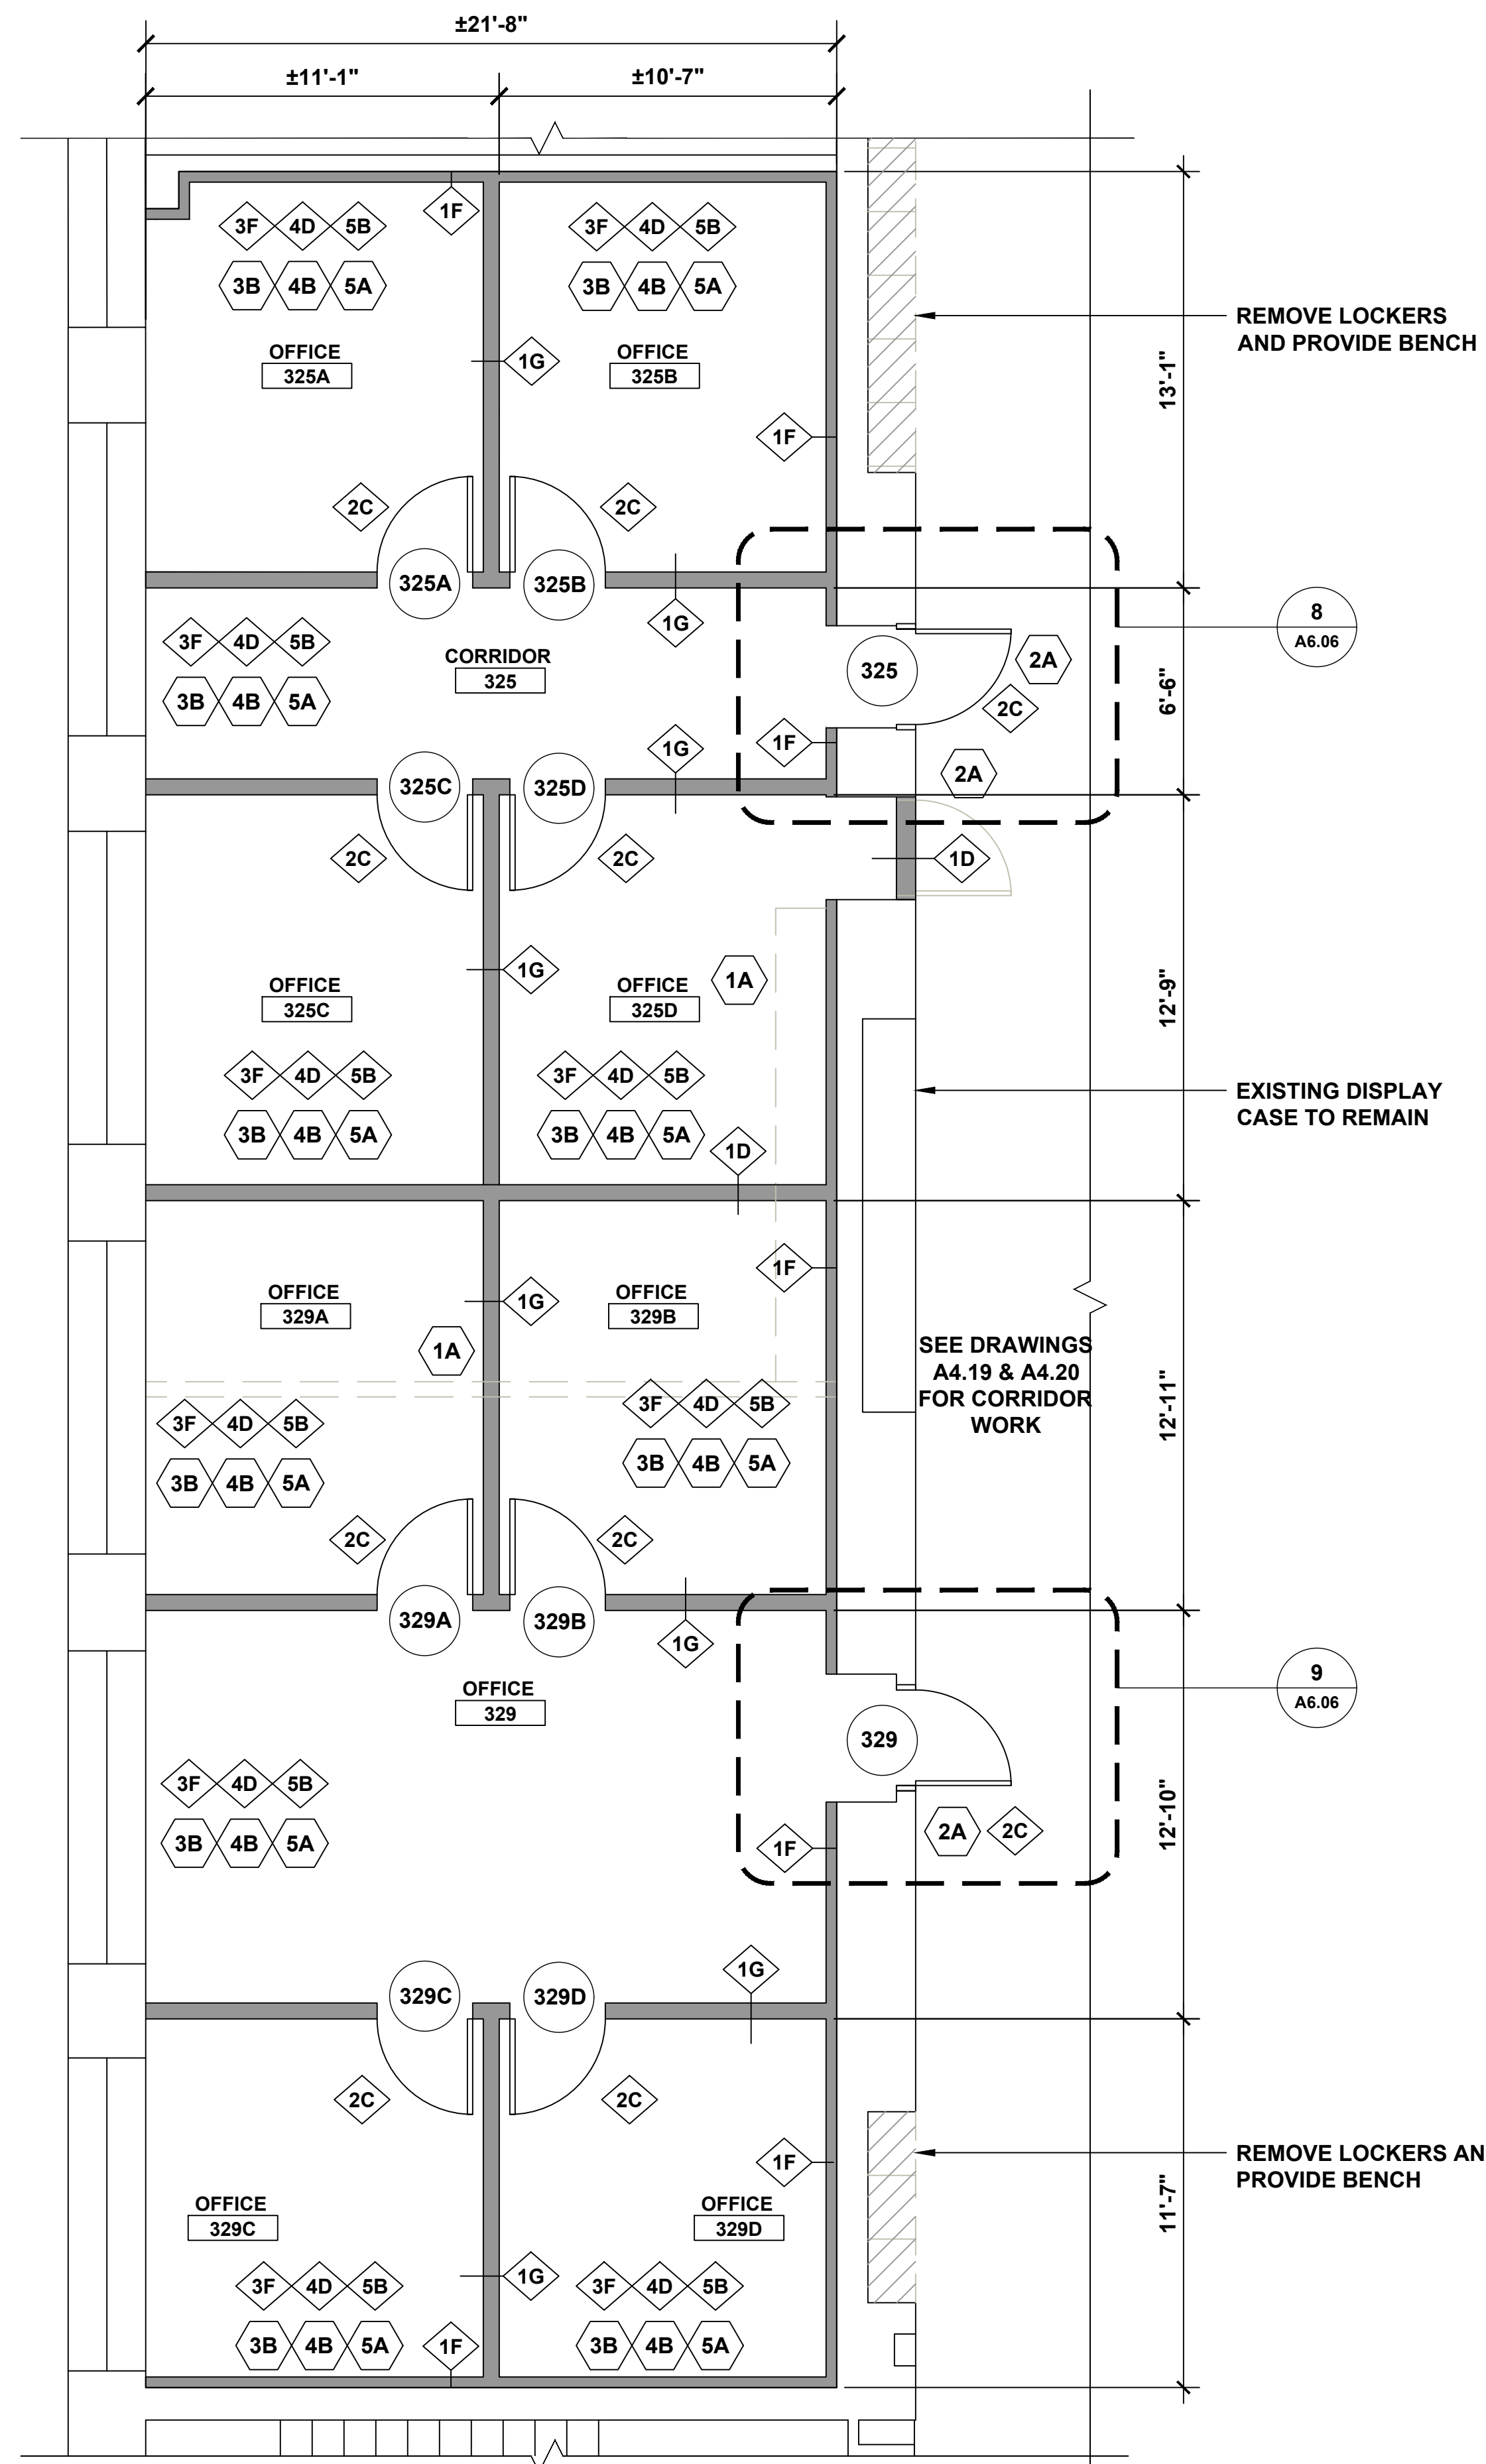

1 WEST PARTIAL PLAN

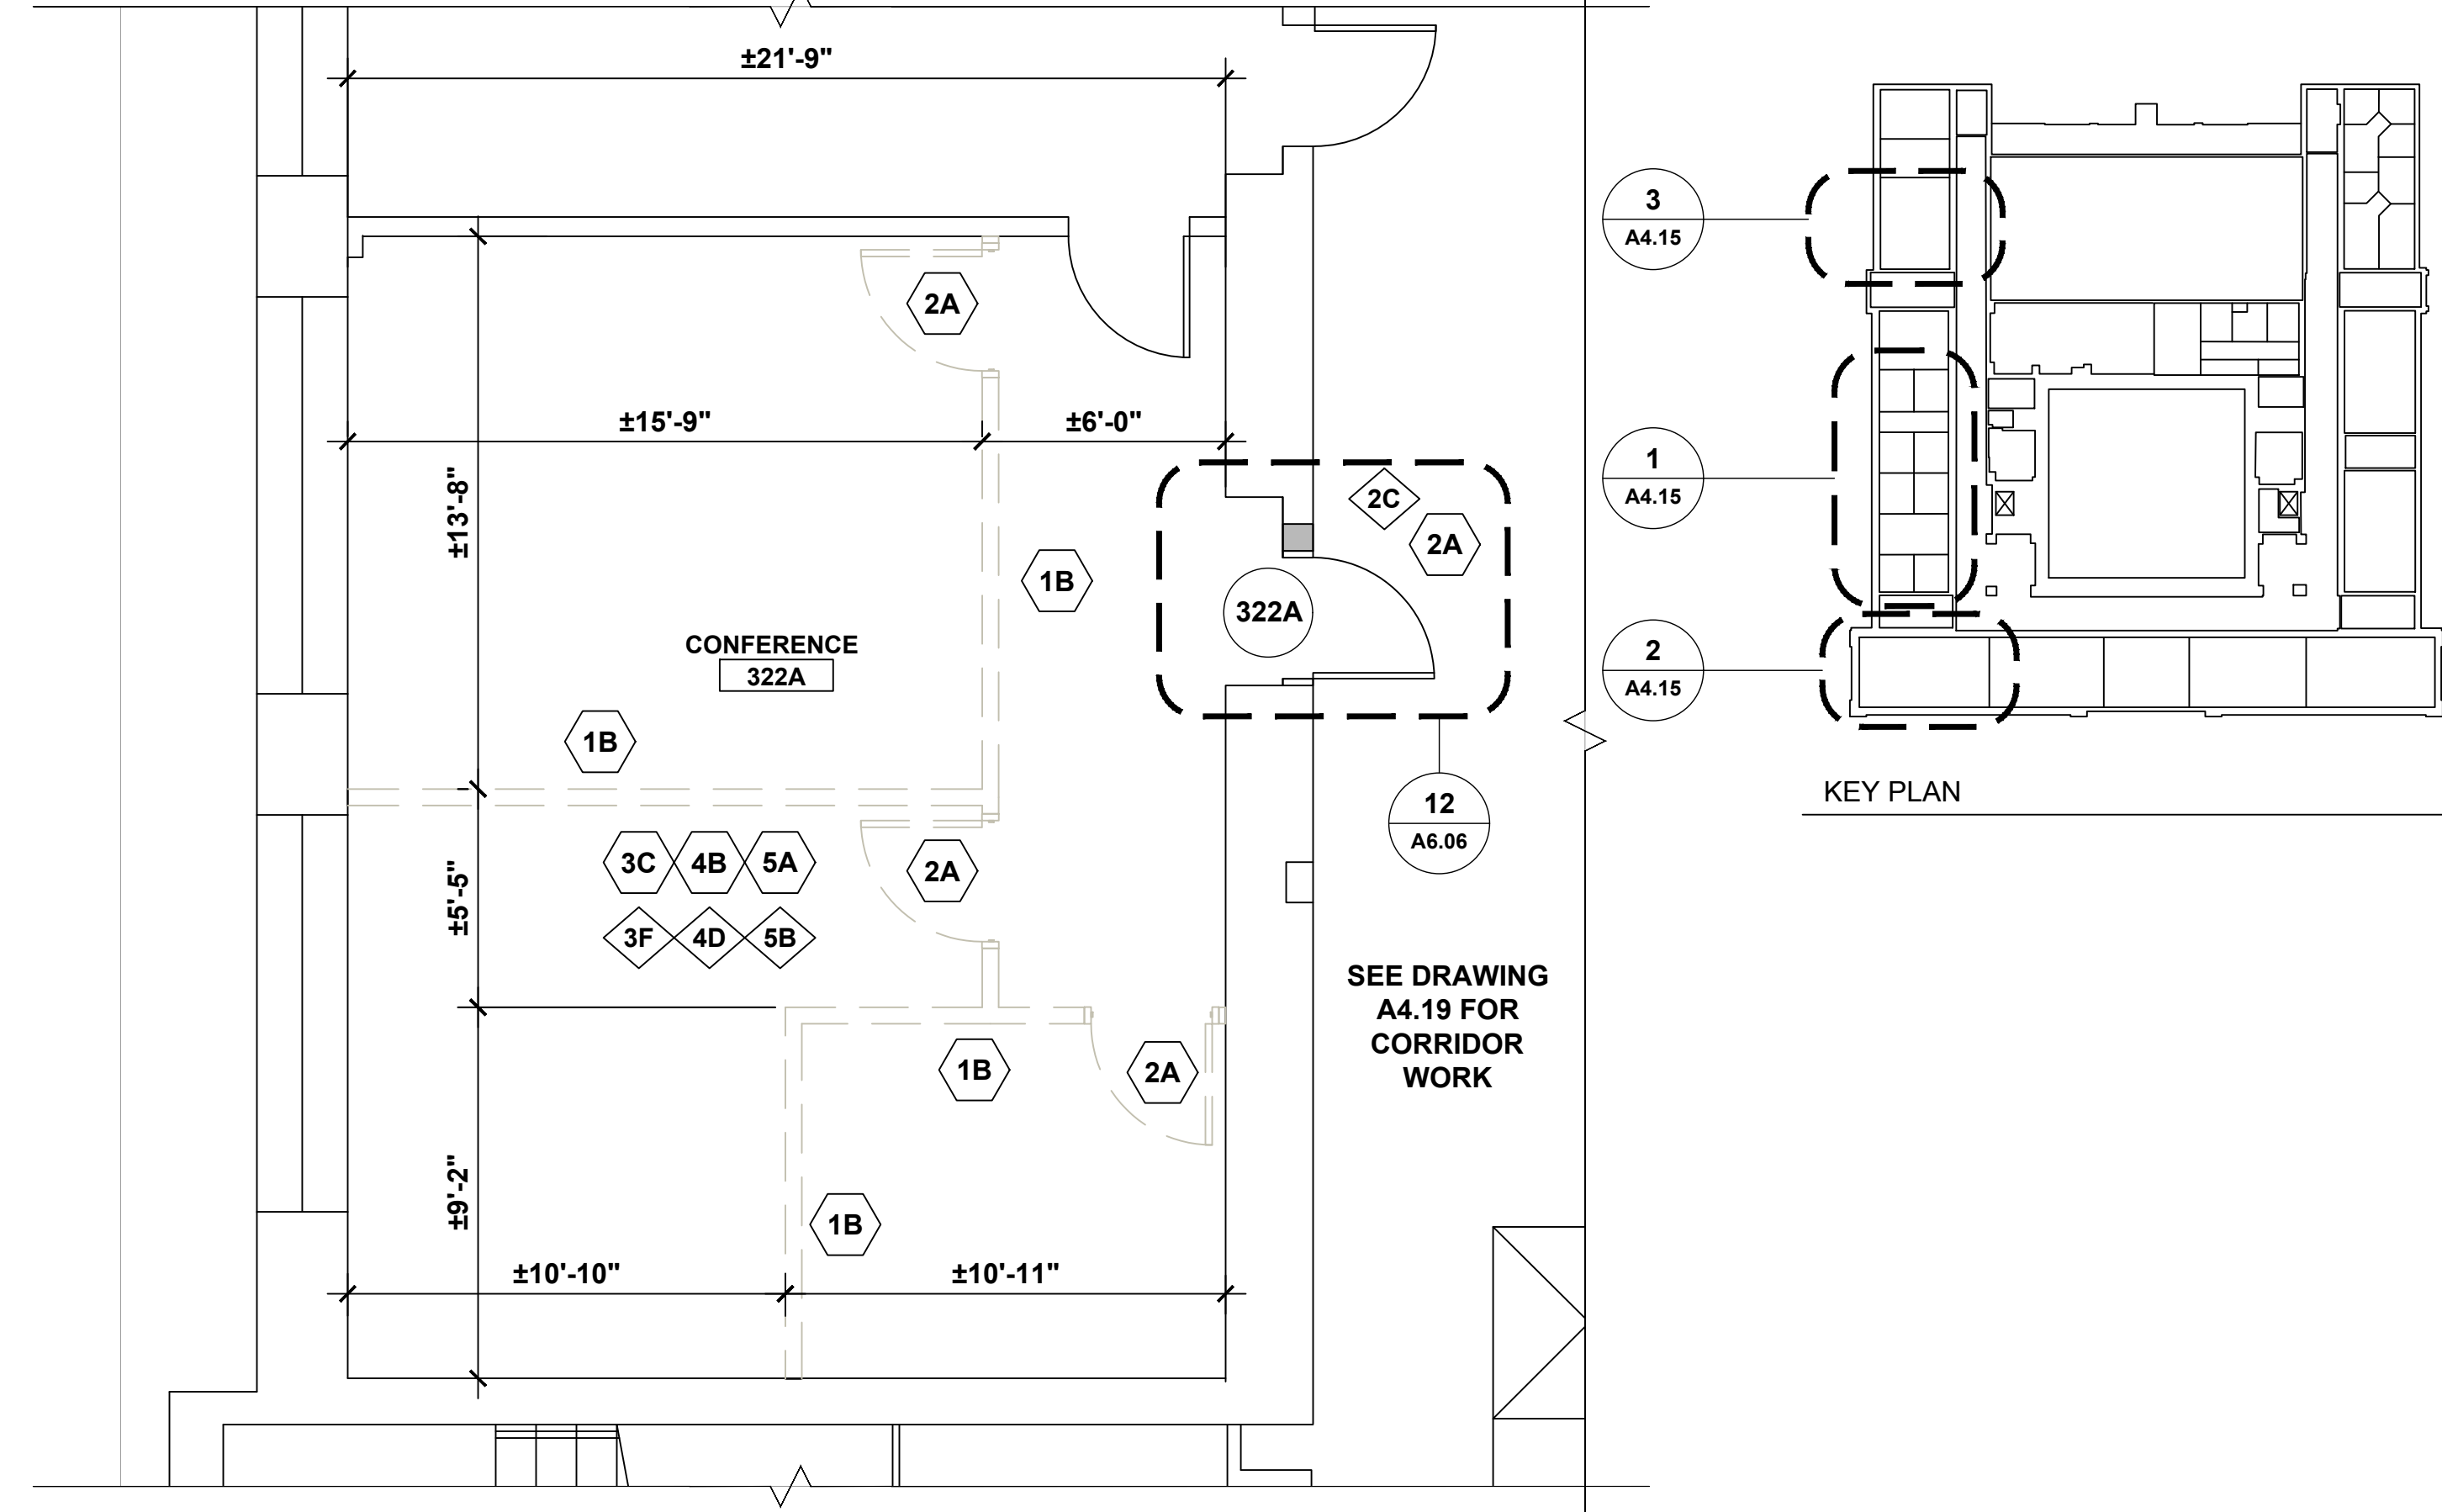

3 NORTHWEST CORNER CONFERENCE ROOM PLAN

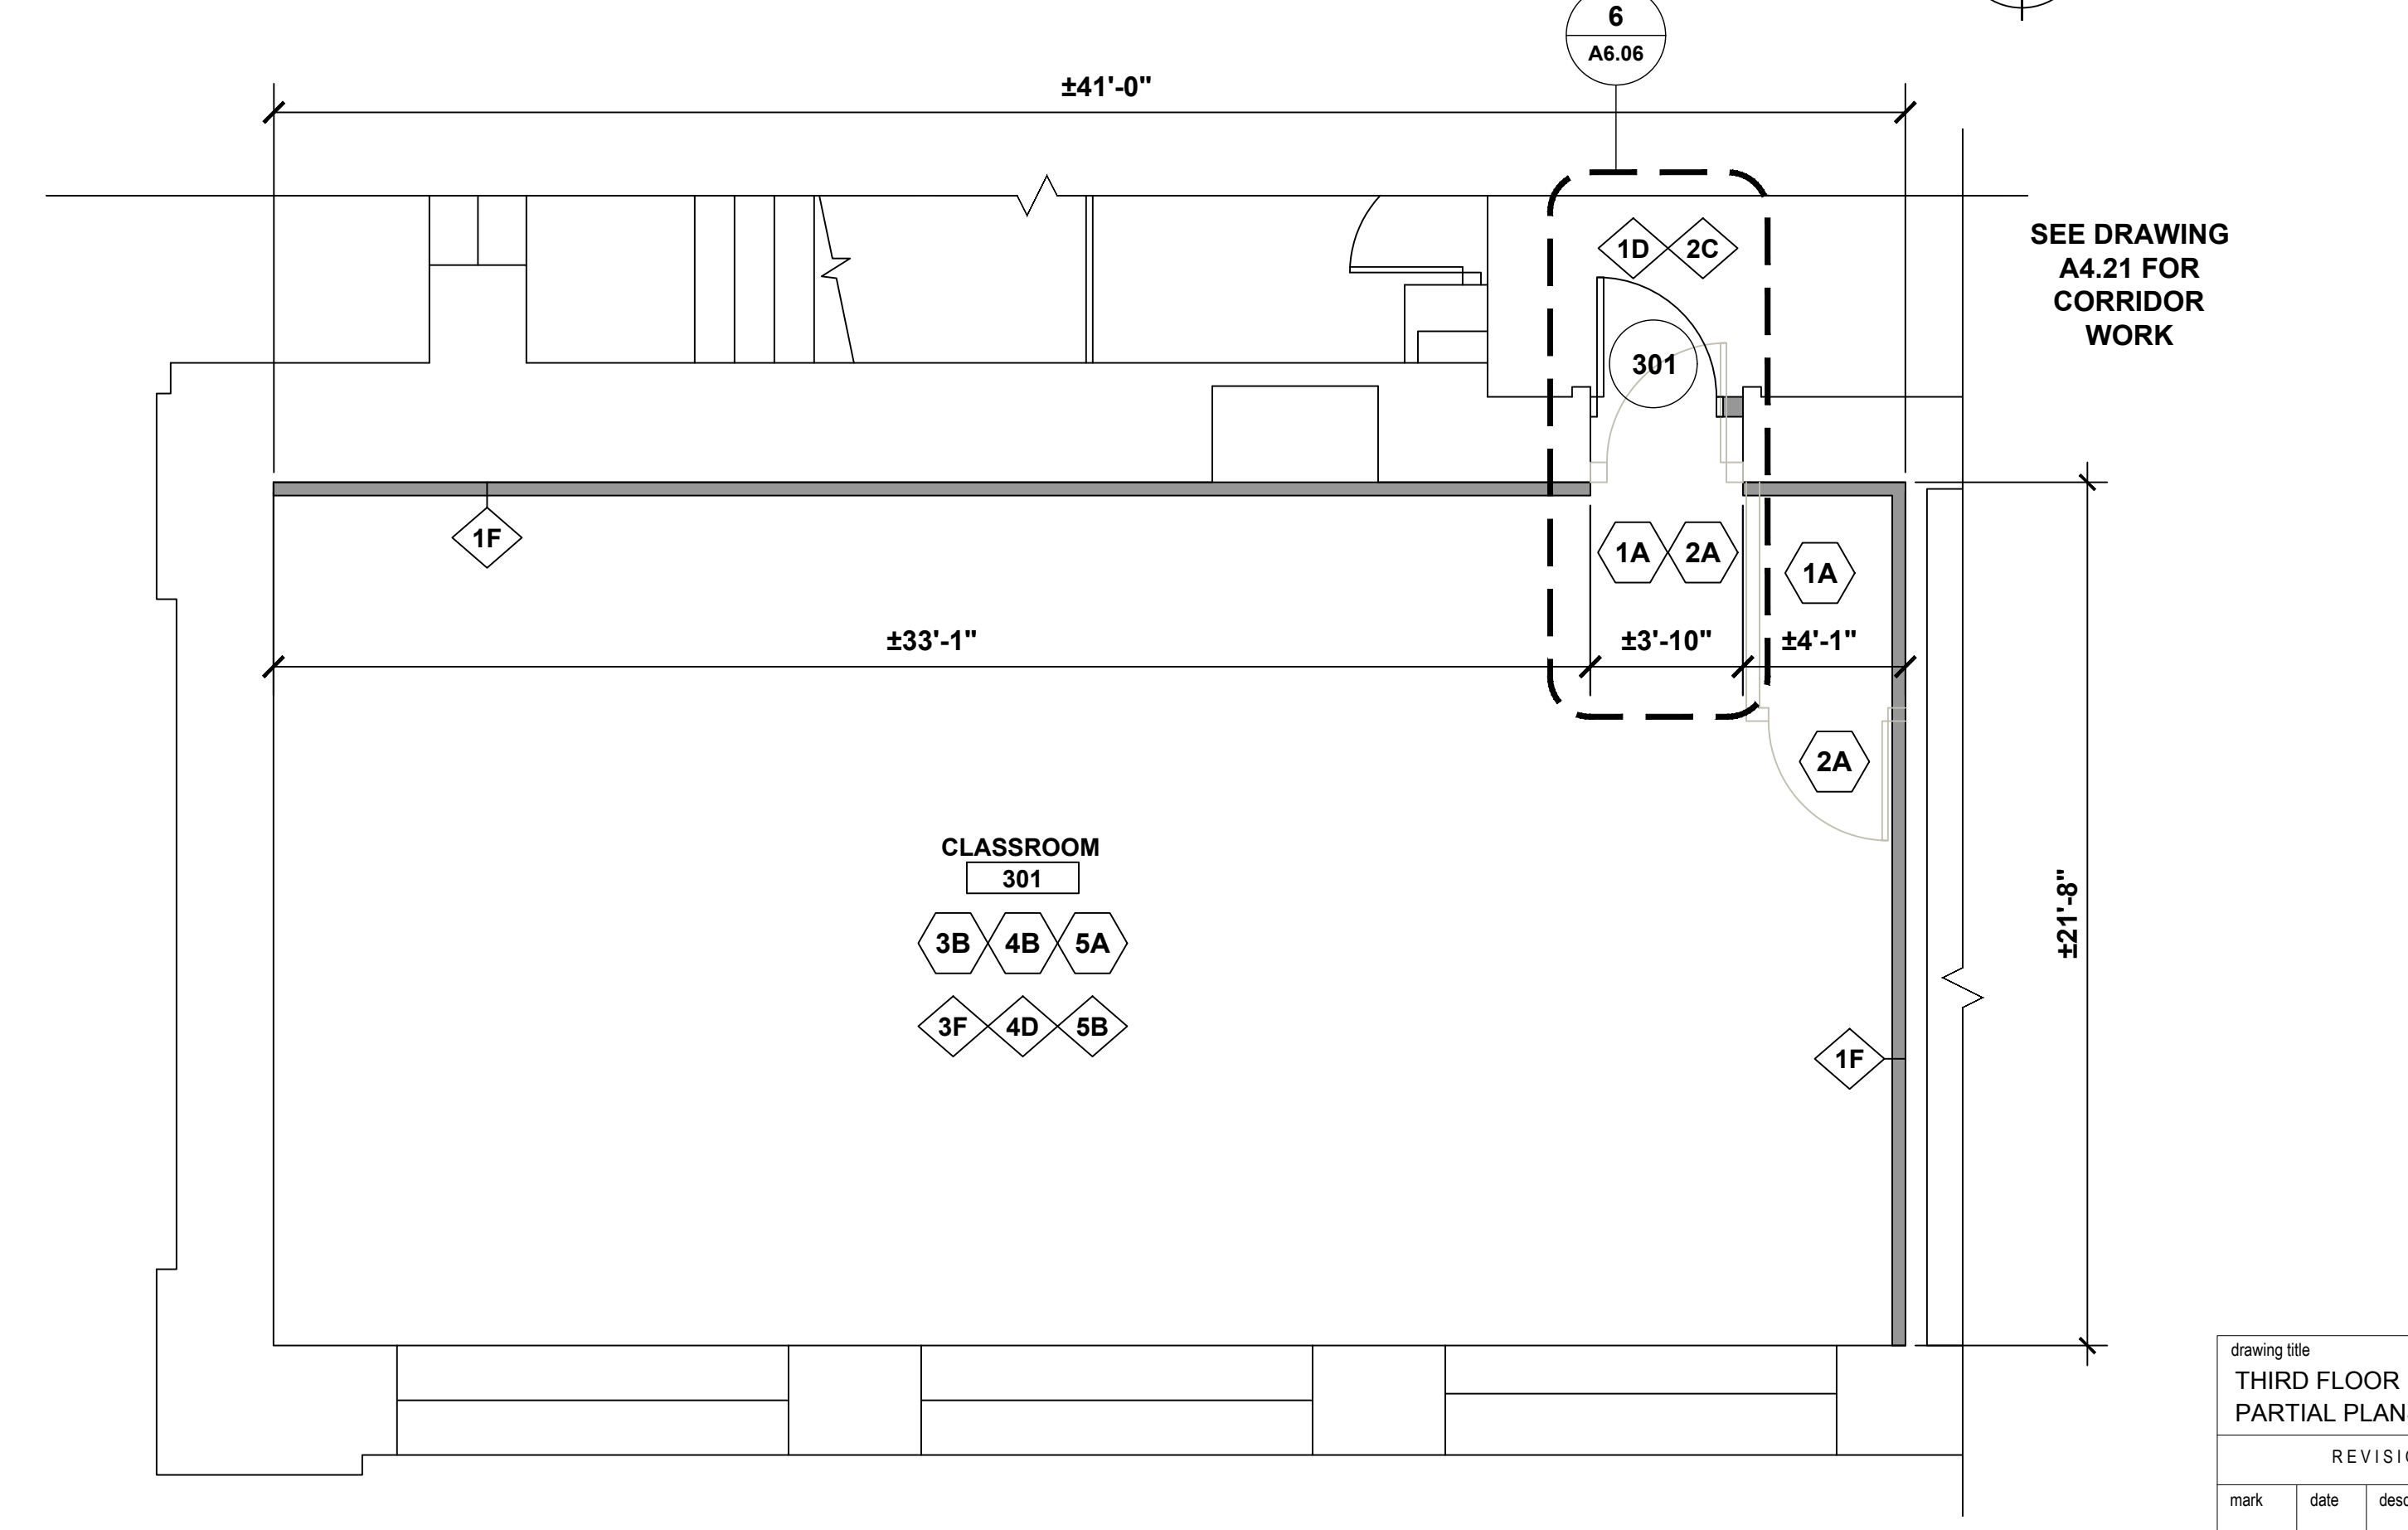


2 SOUTHWEST CORNER PARTIAL PLAN

- DEMOLITION KEY NOTES**
- 1A REMOVE MASONRY WALL.
 - 1B REMOVE STUD AND GYP BD WALL.
 - 2A REMOVE DOOR AND FRAME.
 - 2B REMOVE DOOR. EXISTING FRAME TO REMAIN.
 - 3A REMOVE C.T. FLOOR.
 - 3B REMOVE VCT FLOOR.
 - 3C REMOVE CARPET.
 - 4A REMOVE C.T. WAINSCOT AND BASE.
 - 4B REMOVE VINYL BASE
 - 5A REMOVE ACT CEILING.
 - 6A REMOVE LAV.
 - 6B REMOVE TOILET & TOILET PARTITION.
 - 6C REMOVE URINAL AND URINAL SCREEN.

- NEW WORK KEY NOTES**
- 1C PROVIDE MASONRY WALL.
 - 1D PROVIDE 1 HOUR RATED WALL, 3/8" METAL STUDS WITH 5/8" TYPE 'X' GYP. BOARD BOTH SIDES
 - 1E PROVIDE 5/8" MOISTURE RESISTANT GYP BD ON EXISTING STUDS.
 - 1F PROVIDE 3/8" METAL STUDS WITH 5/8" TYPE 'X' GYP. BOARD ONE SIDE
 - 1G PROVIDE 3/8" METAL STUDS WITH 5/8" TYPE 'X' GYP. BOARD BOTH SIDES
 - 2C PROVIDE WOOD DOOR AND HM FRAME.
 - 2D PROVIDE WOOD DOOR IN EXISTING HM FRAME.
 - 3D PROVIDE CT FLOOR AND CT BASE.
 - 3E PROVIDE VCT AND RESILIENT BASE.
 - 3F PROVIDE CARPET AND RESILIENT BASE.
 - 3G EXISTING FLOORING TO REMAIN. (PROTECT DURING RENOVATION)
 - 4C PROVIDE CT WAINSCOT AND BASE/ PAINT ABOVE
 - 4D PREP AND PAINT WALLS
 - 4E PROVIDE HORIZONTAL WINDOW BLINDS
 - 5B PROVIDE ACT CEILING.
 - 5C REMOVE & REINSTALL ACT CEILING AFTER MEP WORK IS COMPLETED.
 - 5D PROVIDE GYPSUM BOARD CEILING/SOFFIT AND PAINT
 - 5E PAINT EXISTING CEILING
 - 6D PROVIDE LAV
 - 6E PROVIDE TOILET & PARTITION
 - 6F PROVIDE URINAL & SCREEN
 - 7A REMOVE TACK BOARDS. INSTALL PROVIDED OR EXISTING BOARDS AFTER ALL CORRIDOR WORK HAS BEEN COMPLETED. COORDINATE LOCATIONS WITH OWNER.
 - 7B REMOVE BULLETIN BOARD. INSTALL PROVIDED OR EXISTING BOARDS AFTER ALL CORRIDOR WORK HAS BEEN COMPLETED. COORDINATE LOCATIONS WITH OWNER.
 - 7C EXISTING DISPLAY CASES TO REMAIN IN PLACE. PAINT INTERIOR TO MATCH CORRIDOR COLOR. PAINT TRIM TO MATCH DOOR TRIM COLOR.


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|---------------------------|---------|---------------------------------------|--|
| THIRD FLOOR PARTIAL PLANS | | DEPARTMENT OF ADMINISTRATIVE SERVICES | |
| REVISIONS | | | |
| mark | date | description | |
| | 8/4/17 | SCHEMATIC DESIGN SUBMISSION | |
| | 1/15/18 | DESIGN DEVELOPMENT SUBMISSION | |
| | 4/16/18 | CONSTRUCTION DOCUMENTS | |
| | 5/23/18 | | |
| | 7/25/18 | | |

| | |
|---|---|
| drawing prepared by AMES & WHITAKER ARCHITECTS 31 LIBERTY STREET SOUTHINGTON, CT | date 07/25/18 scale AS NOTED |
| project WESTERN CT STATE UNIVERSITY WHITE HALL 2ND AND 3RD FLOOR RENOVATIONS DANBURY, CONNECTICUT | drawn by SP/CA approved by AL drawing no. A4.15 |
| CAD no. | project no. BI-RD-299 |

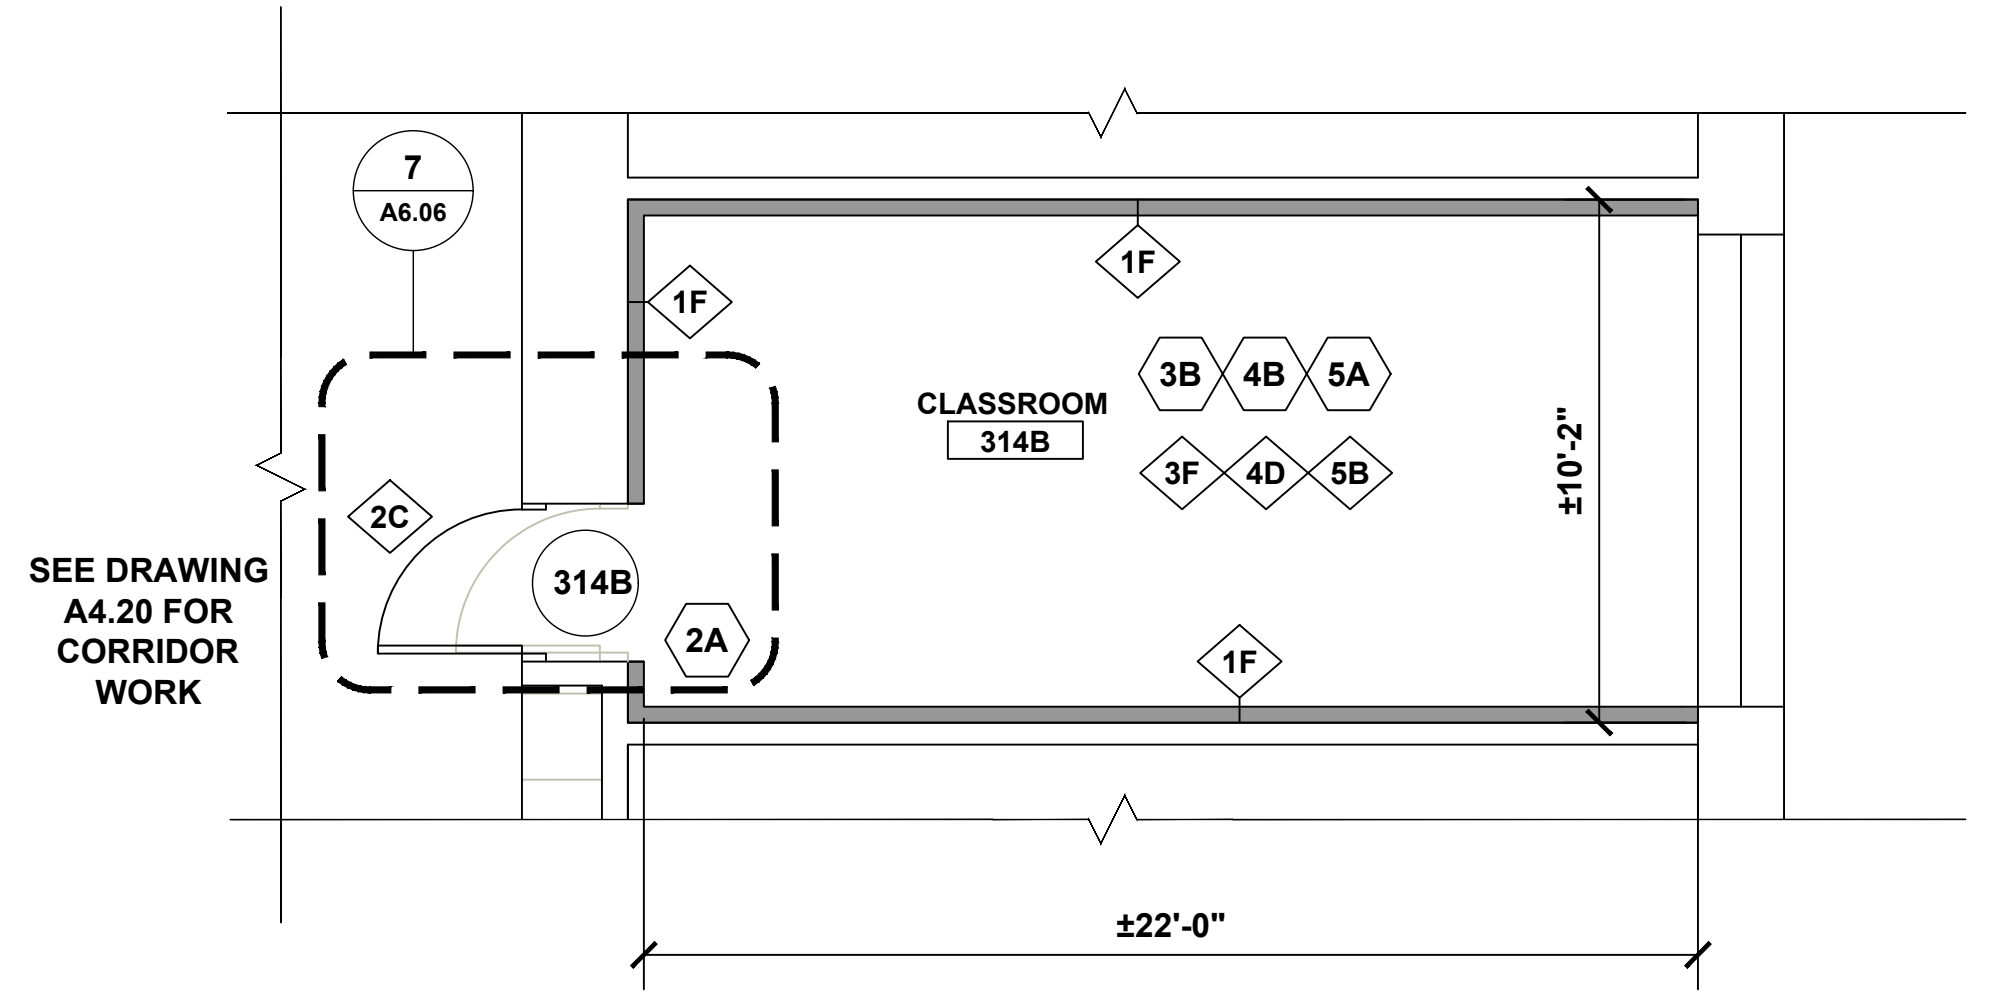

1 EAST CLASSROOM 314B PLAN


SEE DRAWING A4.19 FOR CORRIDOR WORK

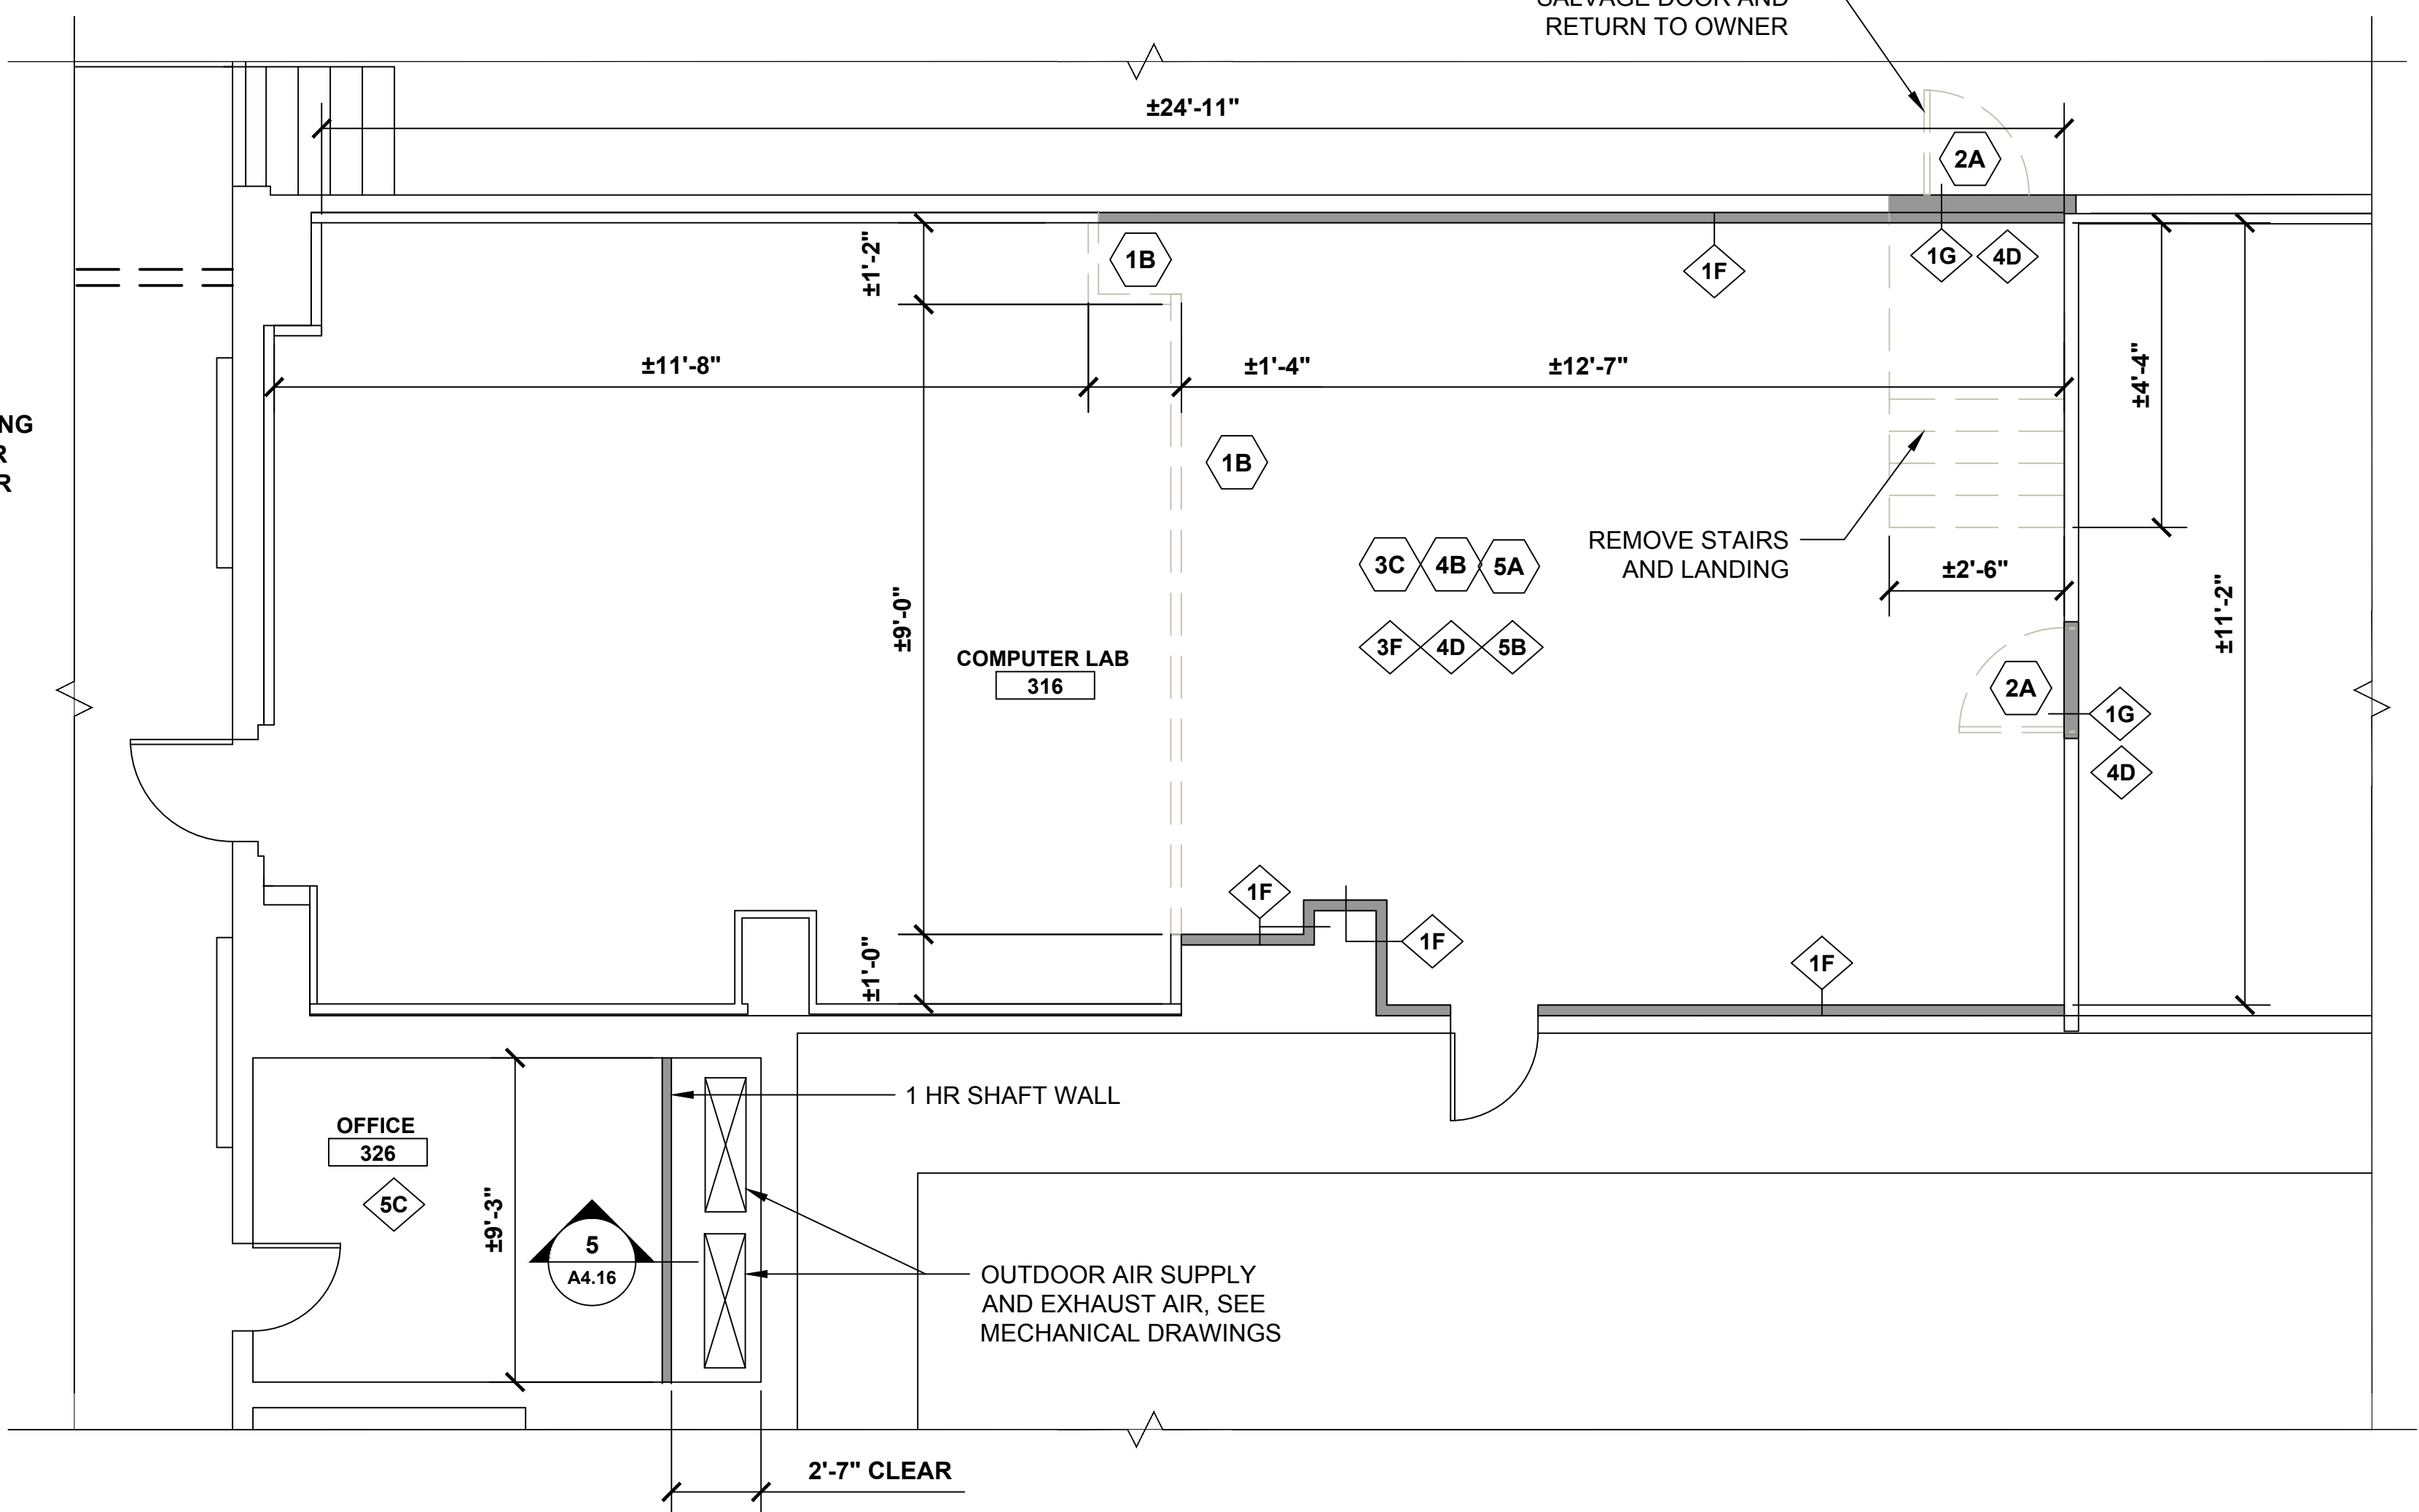


4 COMPUTER LAB 316 PLAN

- DEMOLITION KEY NOTES**
- 1A REMOVE MASONRY WALL.
 - 1B REMOVE STUD AND GYP BD WALL.
 - 2A REMOVE DOOR AND FRAME.
 - 2B REMOVE DOOR. EXISTING FRAME TO REMAIN.
 - 3A REMOVE C.T. FLOOR.
 - 3B REMOVE VCT FLOOR.
 - 3C REMOVE CARPET.
 - 4A REMOVE C.T. WAINSCOT AND BASE.
 - 4B REMOVE VINYL BASE
 - 5A REMOVE ACT CEILING.
 - 6A REMOVE LAV.
 - 6B REMOVE TOILET & TOILET PARTITION.
 - 6C REMOVE URINAL AND URINAL SCREEN.


- NEW WORK KEY NOTES**
- 1C PROVIDE MASONRY WALL.
 - 1D PROVIDE 1 HOUR RATED WALL, 3/8" METAL STUDS WITH 5/8" TYPE 'X' GYP. BOARD BOTH SIDES
 - 1E PROVIDE 5/8" MOISTURE RESISTANT GYP BD ON EXISTING STUDS.
 - 1F PROVIDE 3 3/8" METAL STUDS WITH 5/8" TYPE 'X' GYP. BOARD ONE SIDE
 - 1G PROVIDE 3/8" METAL STUDS WITH 5/8" TYPE 'X' GYP. BOARD BOTH SIDES
 - 2C PROVIDE WOOD DOOR AND HM FRAME.
 - 2D PROVIDE WOOD DOOR IN EXISTING HM FRAME.
 - 3D PROVIDE CT FLOOR AND CT BASE.
 - 3E PROVIDE VCT AND RESILIENT BASE.
 - 3F PROVIDE CARPET AND RESILIENT BASE.
 - 3G EXISTING FLOORING TO REMAIN. (PROTECT DURING RENOVATION)
 - 4C PROVIDE CT WAINSCOT AND BASE/ PAINT ABOVE
 - 4D PREP AND PAINT WALLS
 - 4E PROVIDE HORIZONTAL WINDOW BLINDS
 - 5B PROVIDE ACT CEILING.
 - 5C REMOVE & REINSTALL ACT CEILING AFTER MEP WORK IS COMPLETED.
 - 5D PROVIDE GYPSUM BOARD CEILING/SOFFIT AND PAINT
 - 5E PAINT EXISTING CEILING
 - 6D PROVIDE LAV
 - 6E PROVIDE TOILET & PARTITION
 - 6F PROVIDE URINAL & SCREEN
 - 7A REMOVE TACK BOARDS. INSTALL PROVIDED OR EXISTING BOARDS AFTER ALL CORRIDOR WORK HAS BEEN COMPLETED. COORDINATE LOCATIONS WITH OWNER.
 - 7B REMOVE BULLETIN BOARD. INSTALL PROVIDED OR EXISTING BOARDS AFTER ALL CORRIDOR WORK HAS BEEN COMPLETED. COORDINATE LOCATIONS WITH OWNER.
 - 7C EXISTING DISPLAY CASES TO REMAIN IN PLACE. PAINT INTERIOR TO MATCH CORRIDOR COLOR. PAINT TRIM TO MATCH DOOR TRIM COLOR.

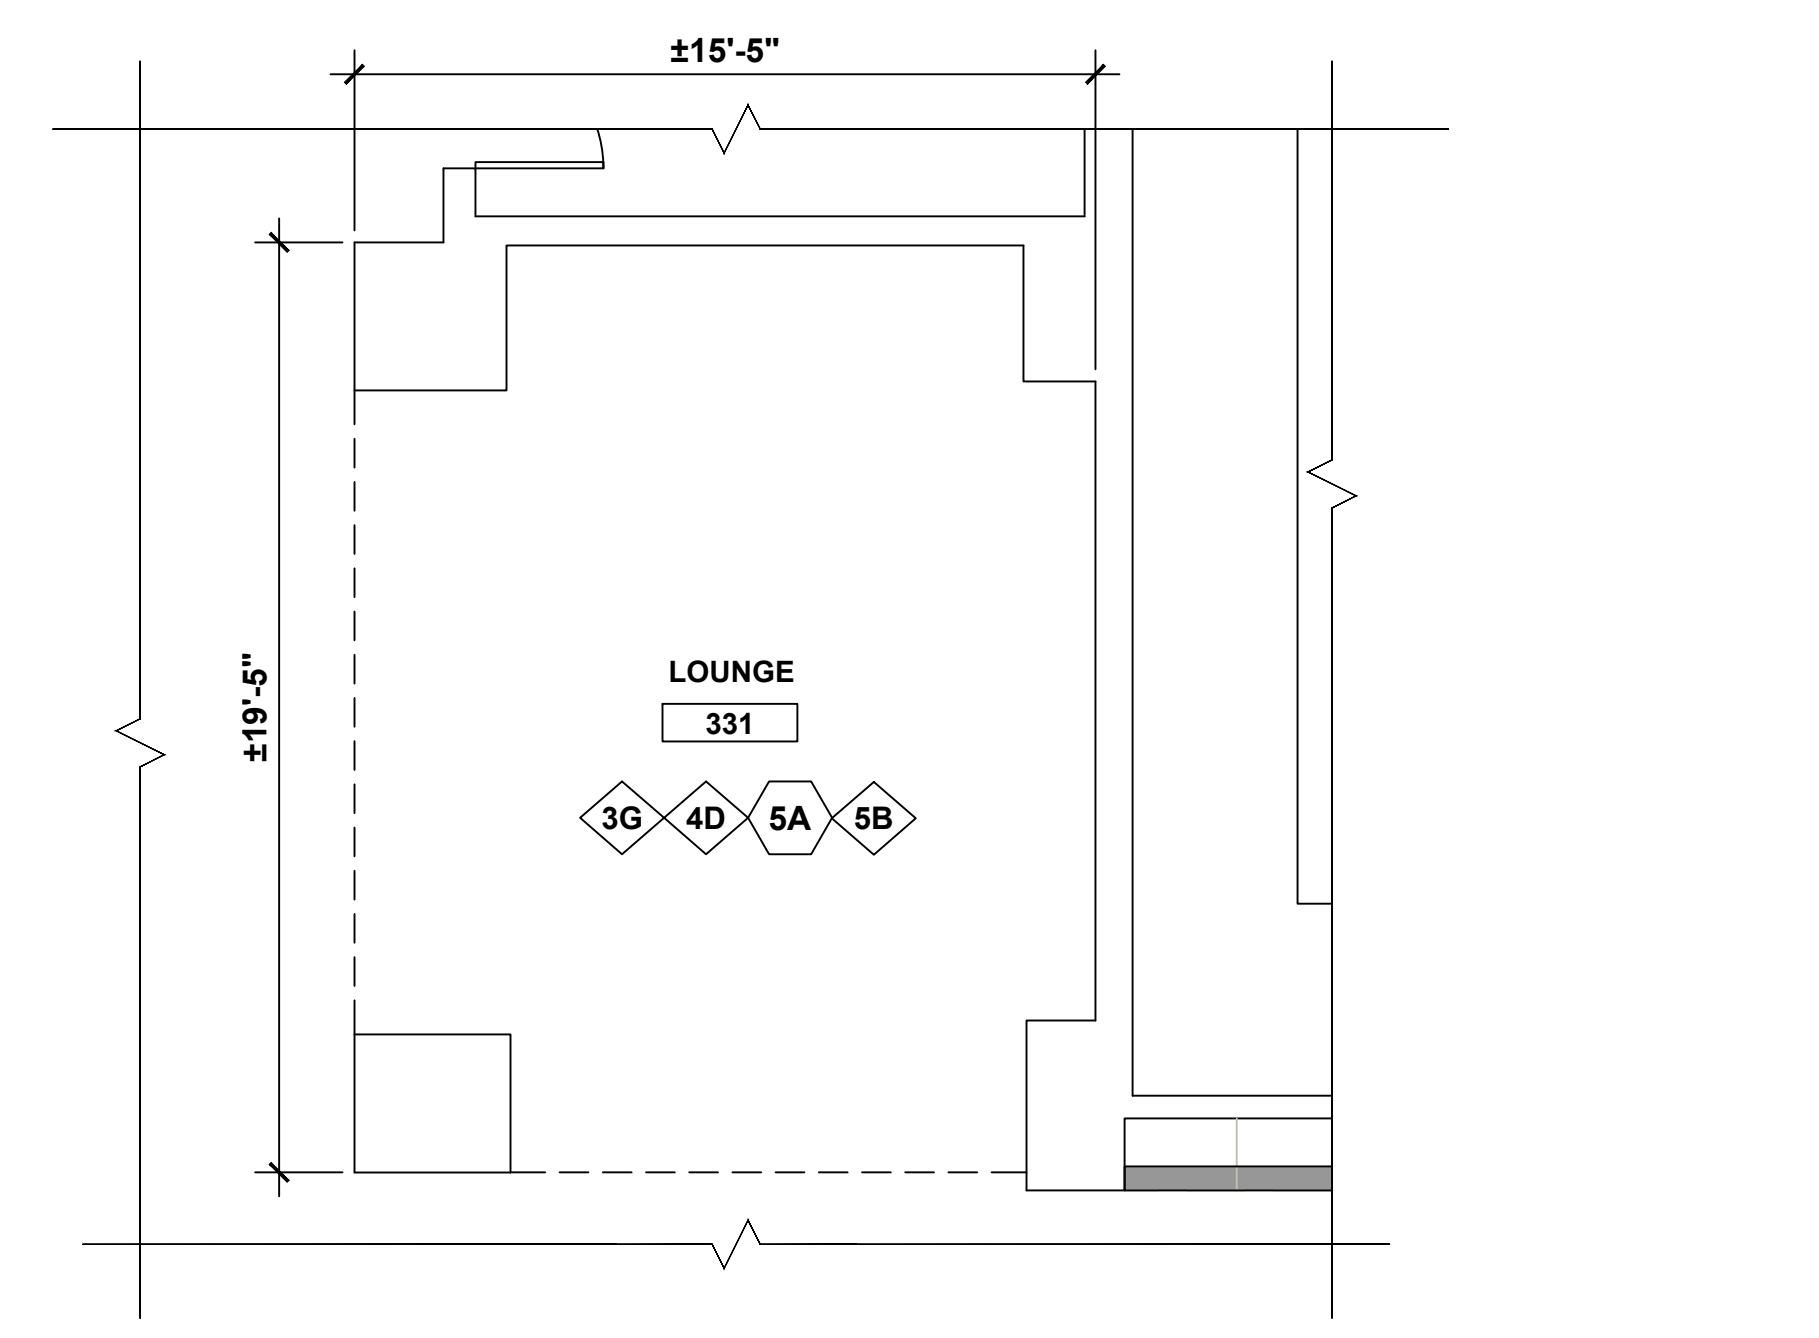


2 SOUTHWEST CORNER PLAN AT IDF DATA CLOSET

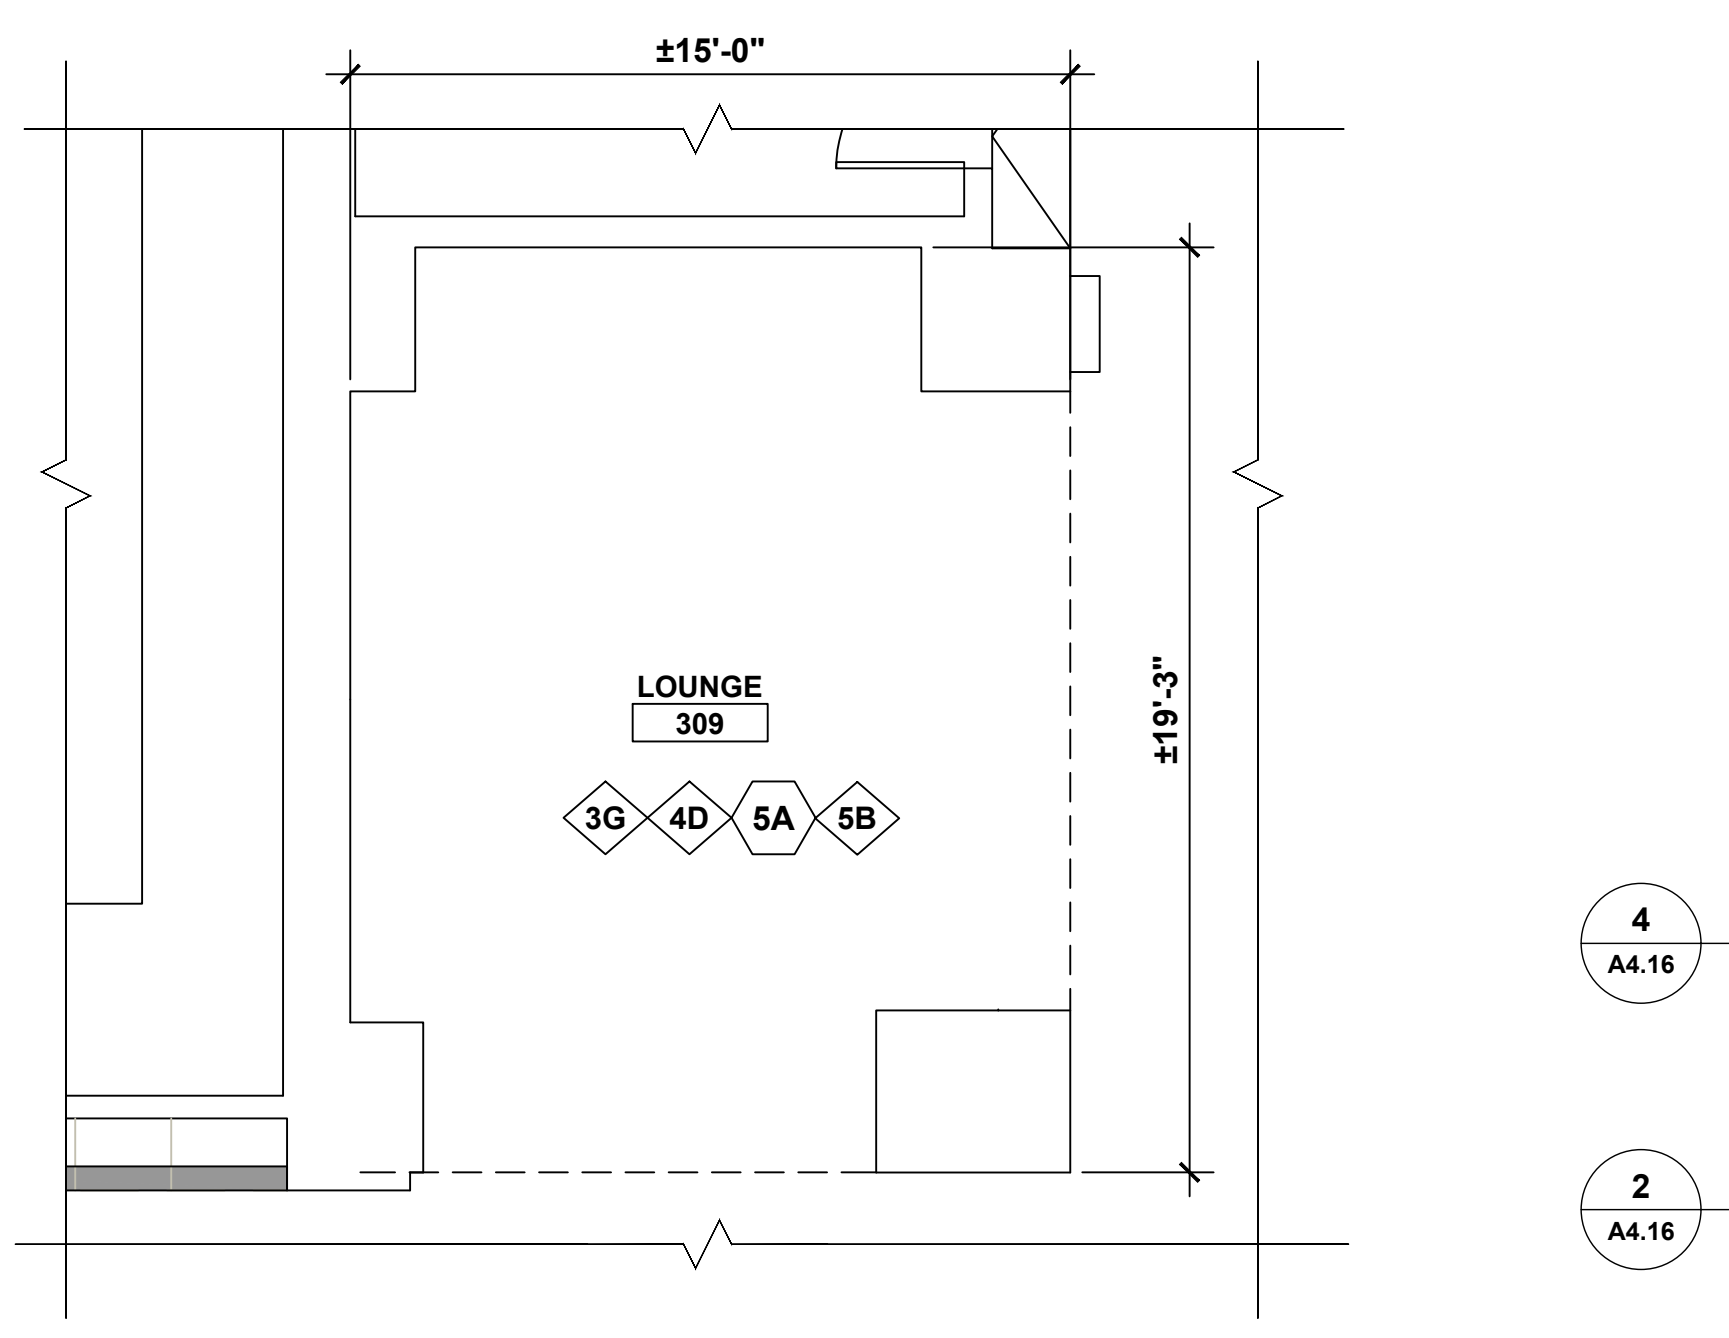

3 SOUTHEAST CORNER PARTIAL PLAN AT STORAGE ROOM

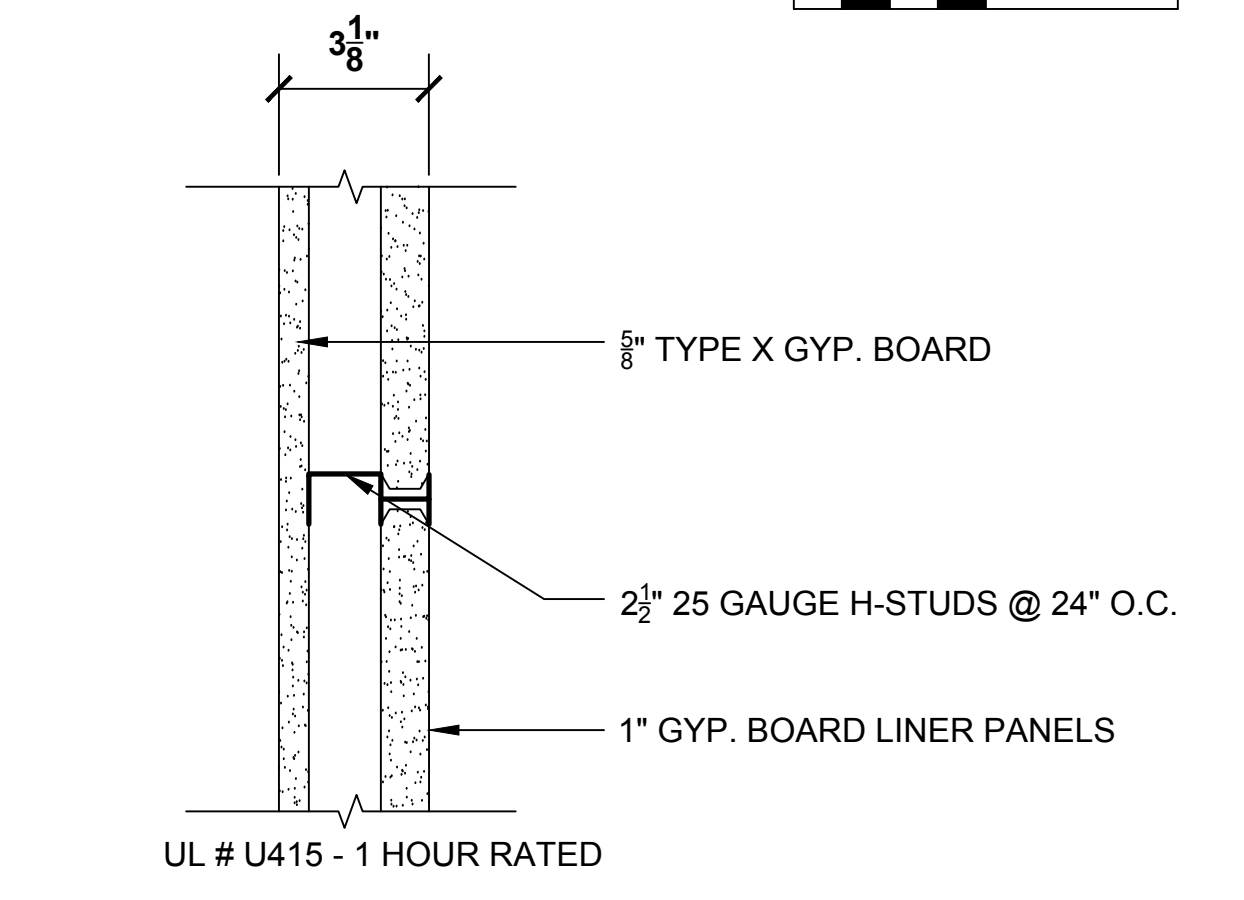


5 SHAFT WALL DETAIL

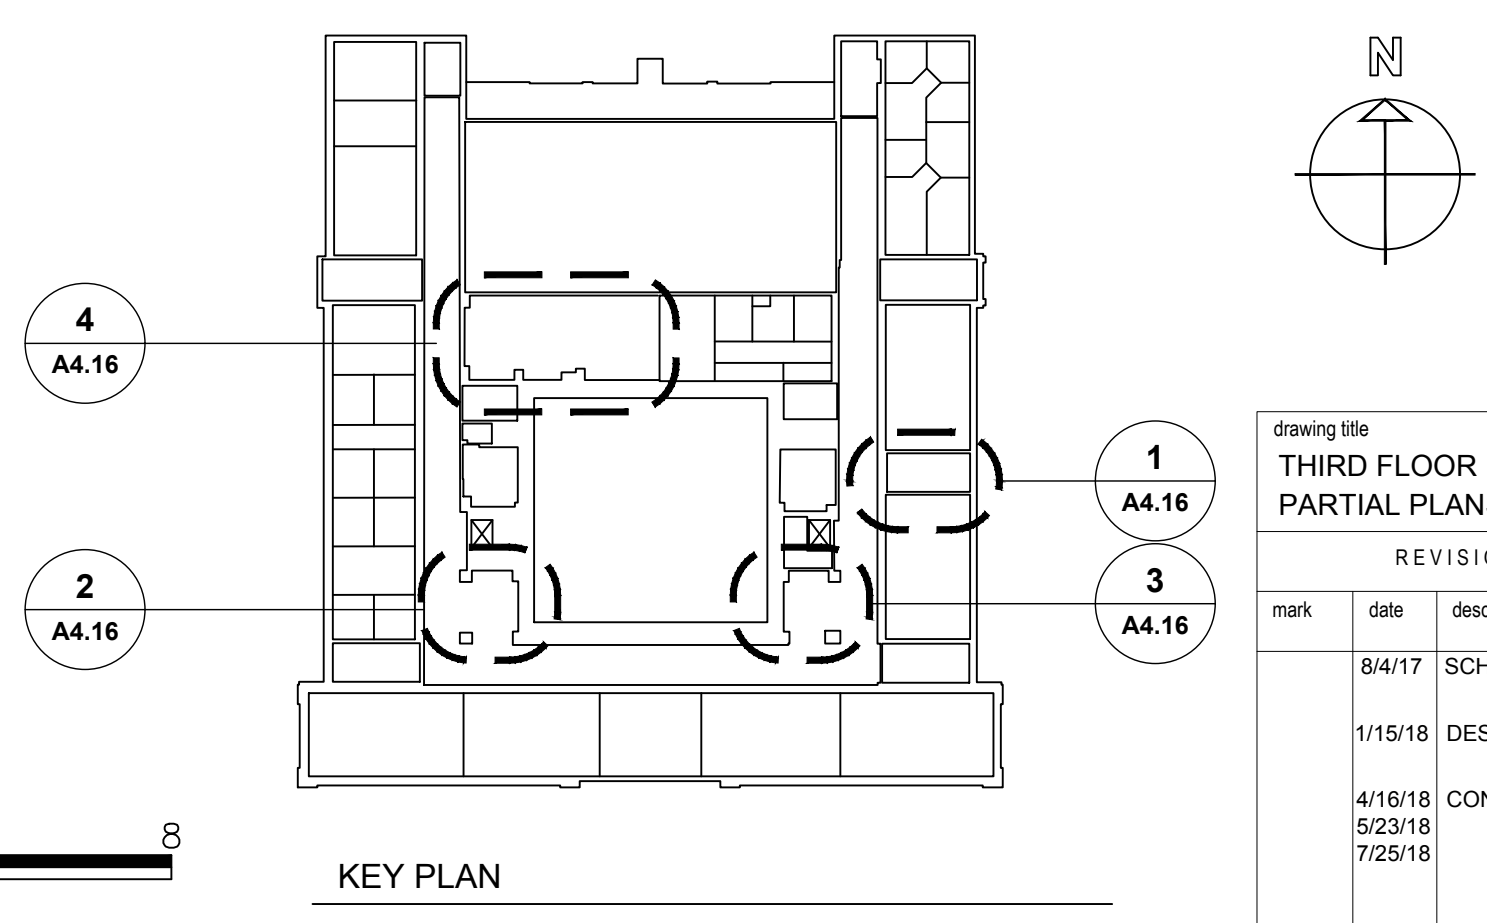


KEY PLAN

| | | | | |
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| drawing title THIRD FLOOR PARTIAL PLANS | | | STATE OF CONNECTICUT DEPARTMENT OF ADMINISTRATIVE SERVICES | |
| REVISIONS | | | drawing prepared by AMES & WHITAKER ARCHITECTS | |
| mark | date | description | 31 LIBERTY STREET SOUTHINGTON, CT | date 07/25/18 |
| | 8/4/17 | SCHEMATIC DESIGN SUBMISSION | | scale AS NOTED |
| | 1/15/18 | DESIGN DEVELOPMENT SUBMISSION | project WESTERN CT STATE UNIVERSITY WHITE HALL 2ND AND 3RD FLOOR RENOVATIONS DANBURY, CONNECTICUT | drawn by SP/CA |
| | 4/16/18 | CONSTRUCTION DOCUMENTS | | approved by AL |
| | 5/23/18 | | | drawing no. |
| | 7/25/18 | | | A4.16 |
| CAD no. | | | project no. BI-RD-299 | |

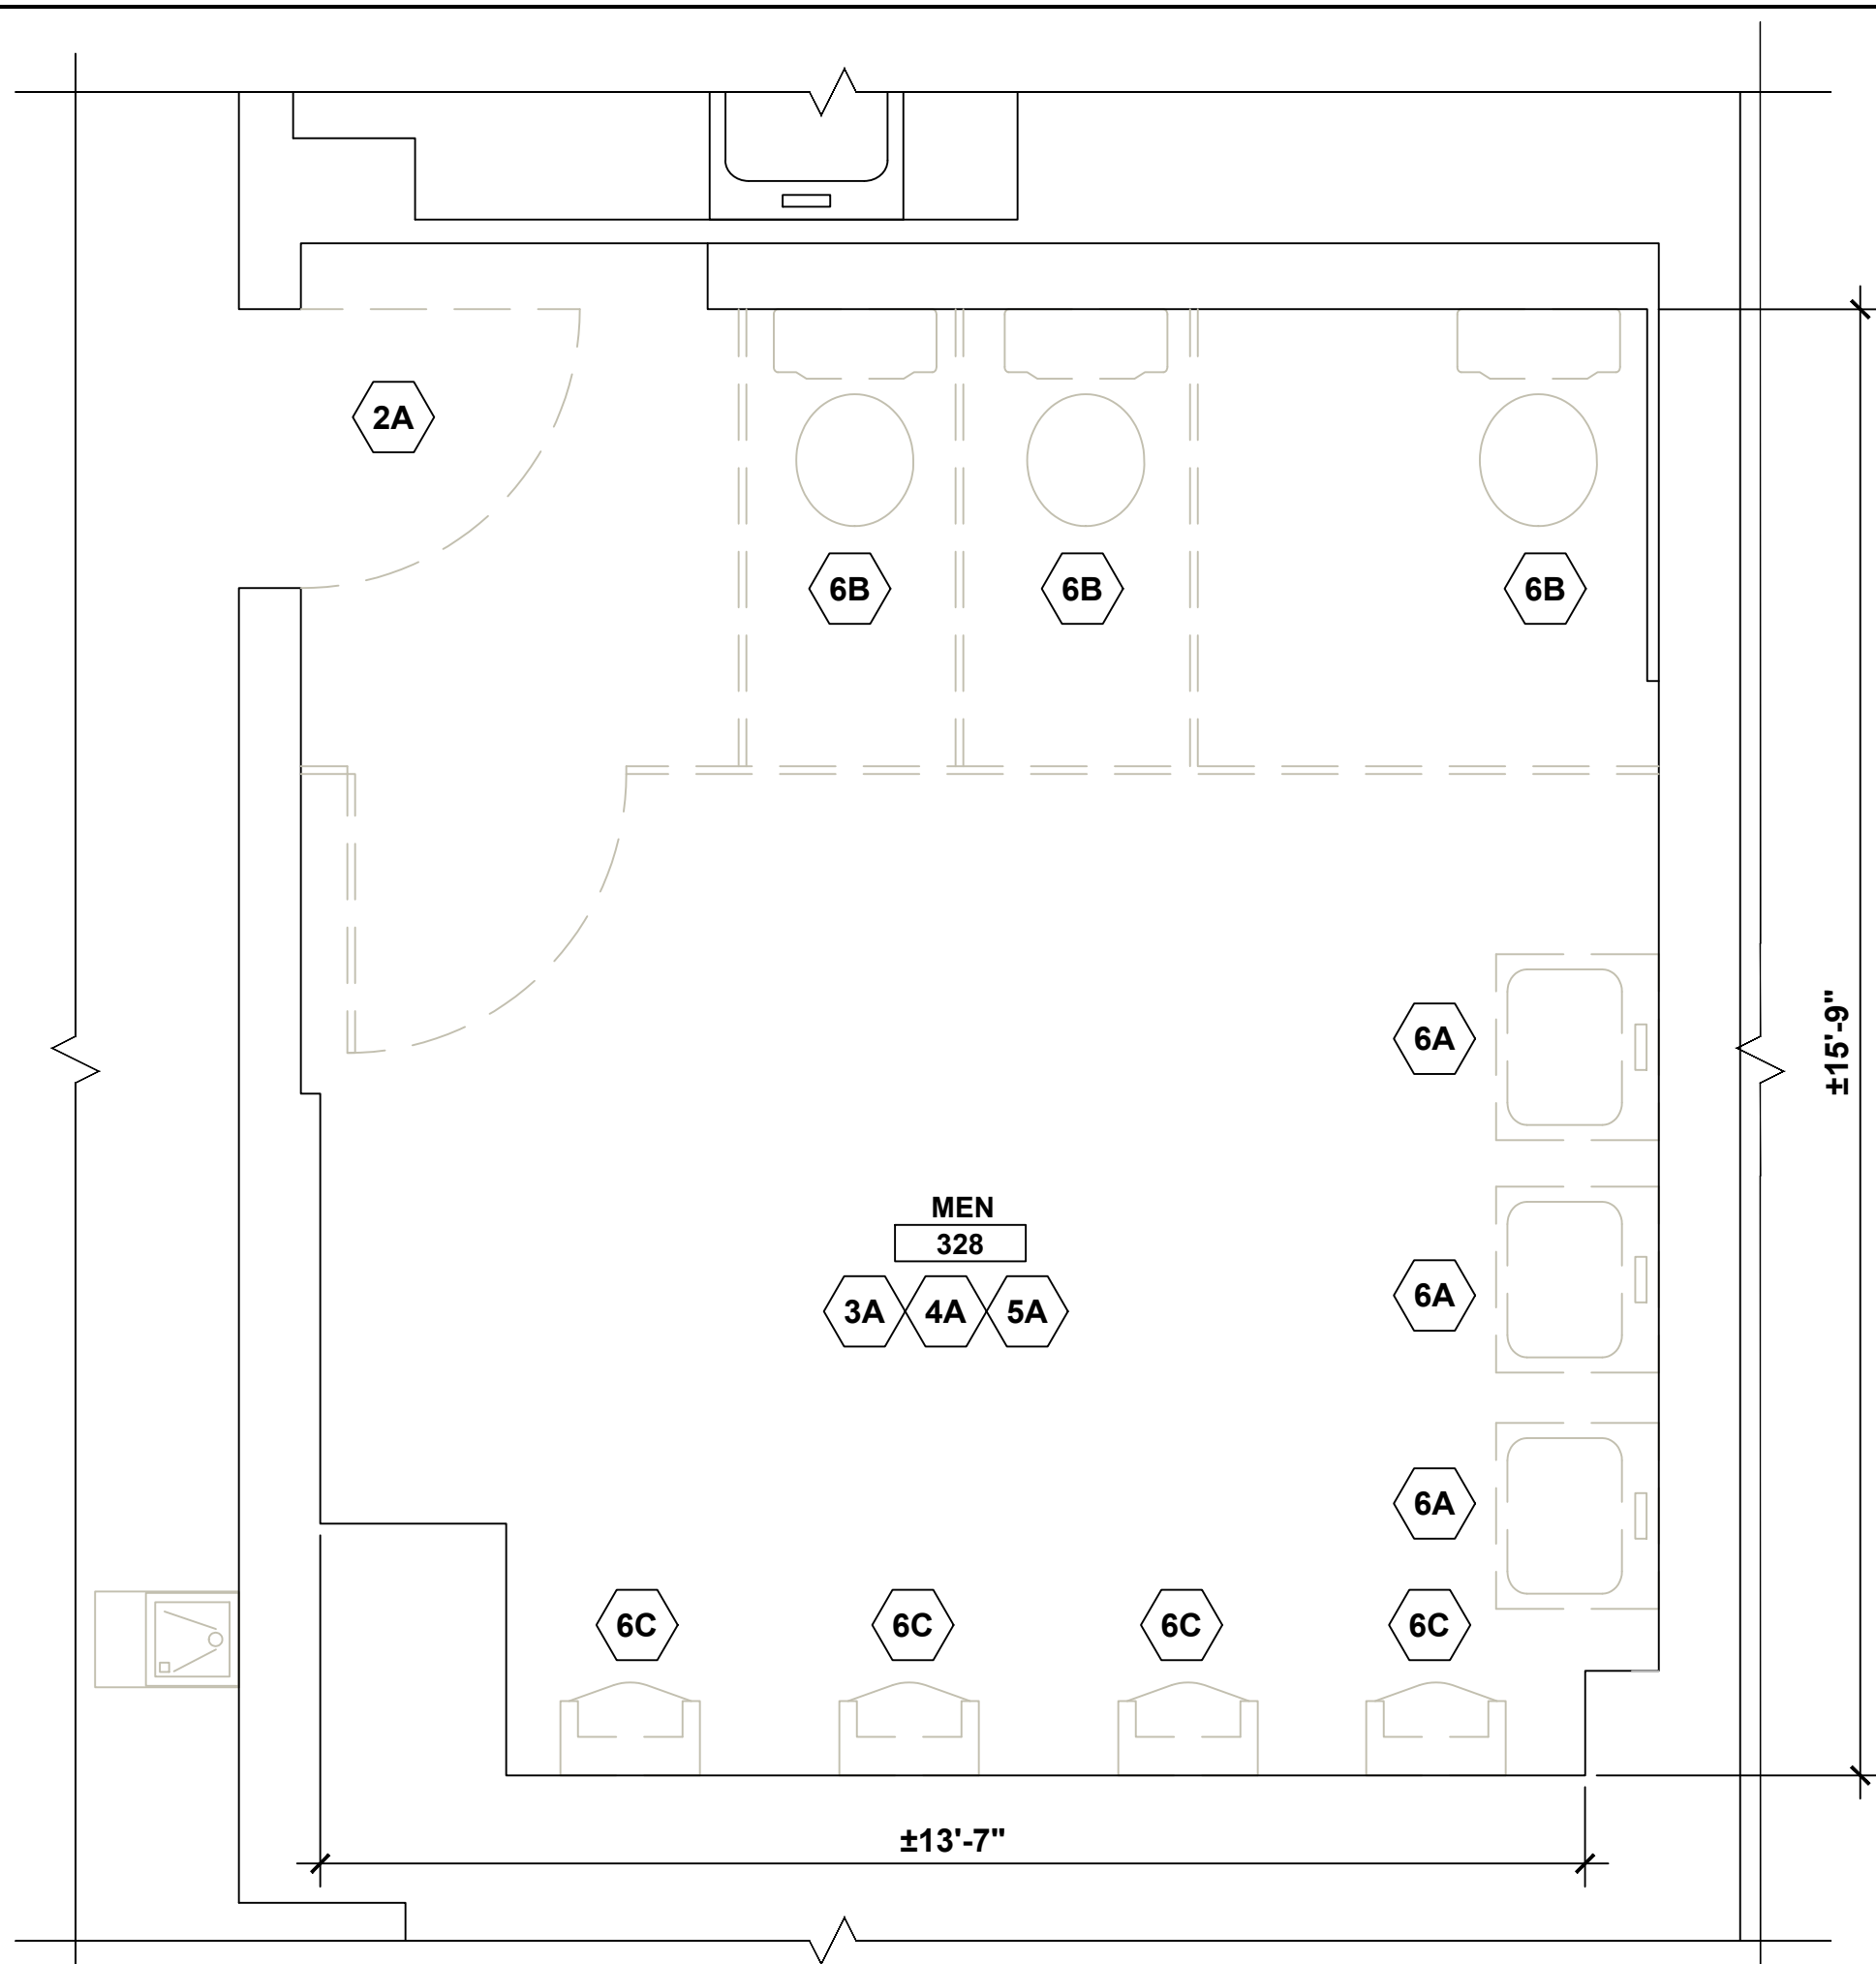


1 MEN'S TOILET ROOM 328 DEMO PLAN


GENERAL DEMO NOTE:
REMOVE PORTIONS OF CHASE WALL AS REQUIRED FOR REMOVAL AND INSTALLATION OF FIXTURES. COORDINATE WITH MEP DWGS.

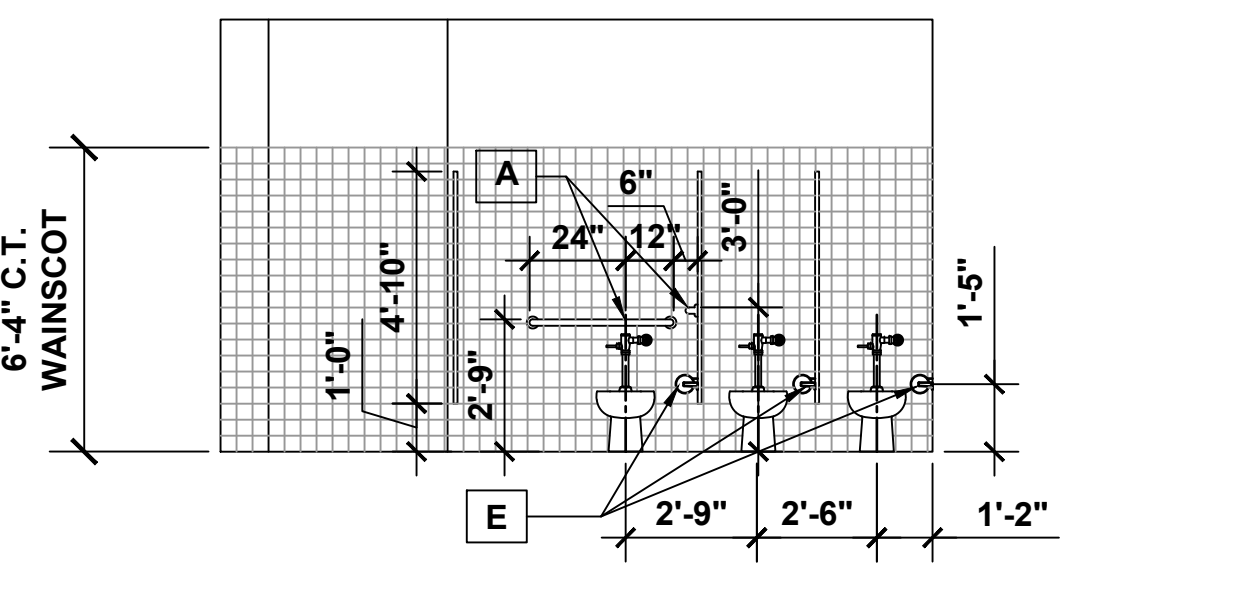


3 MEN'S TOILET ROOM 230 NORTH ELEVATION

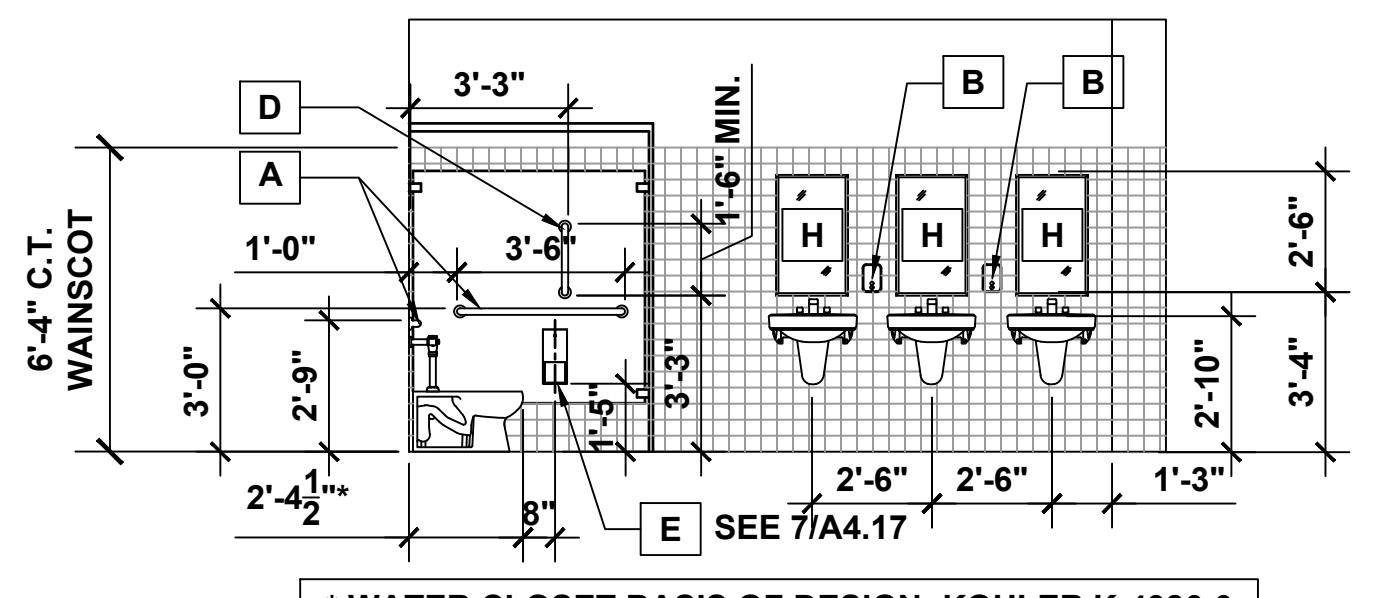


4 MEN'S TOILET ROOM 230 EAST ELEVATION

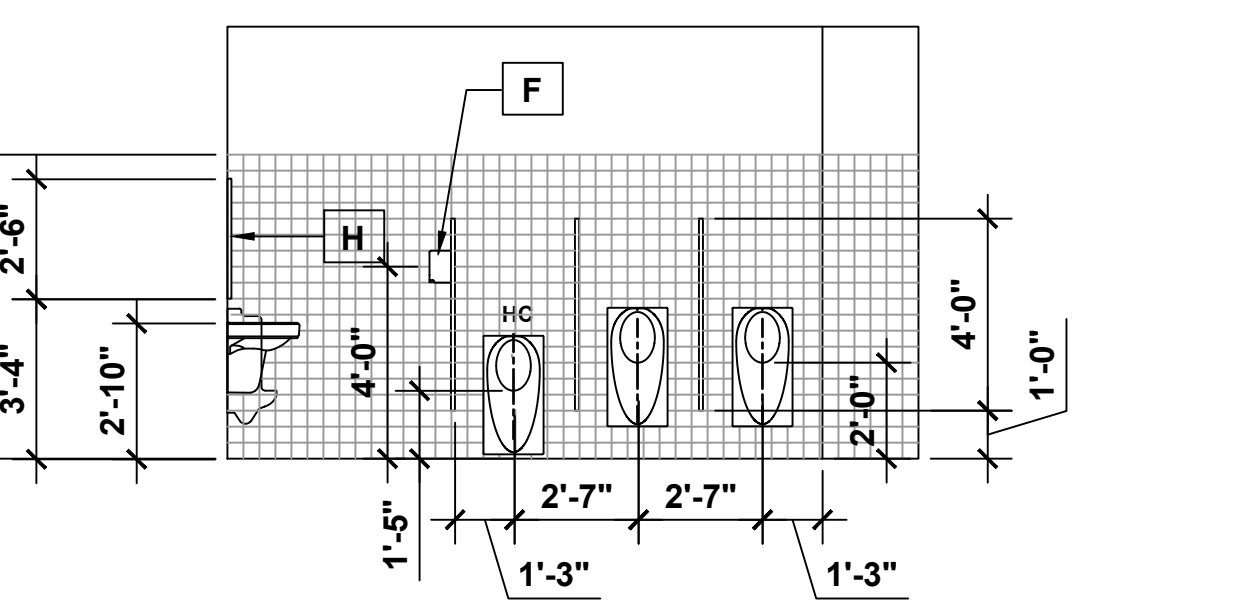

5 MEN'S TOILET ROOM 230 SOUTH ELEVATION

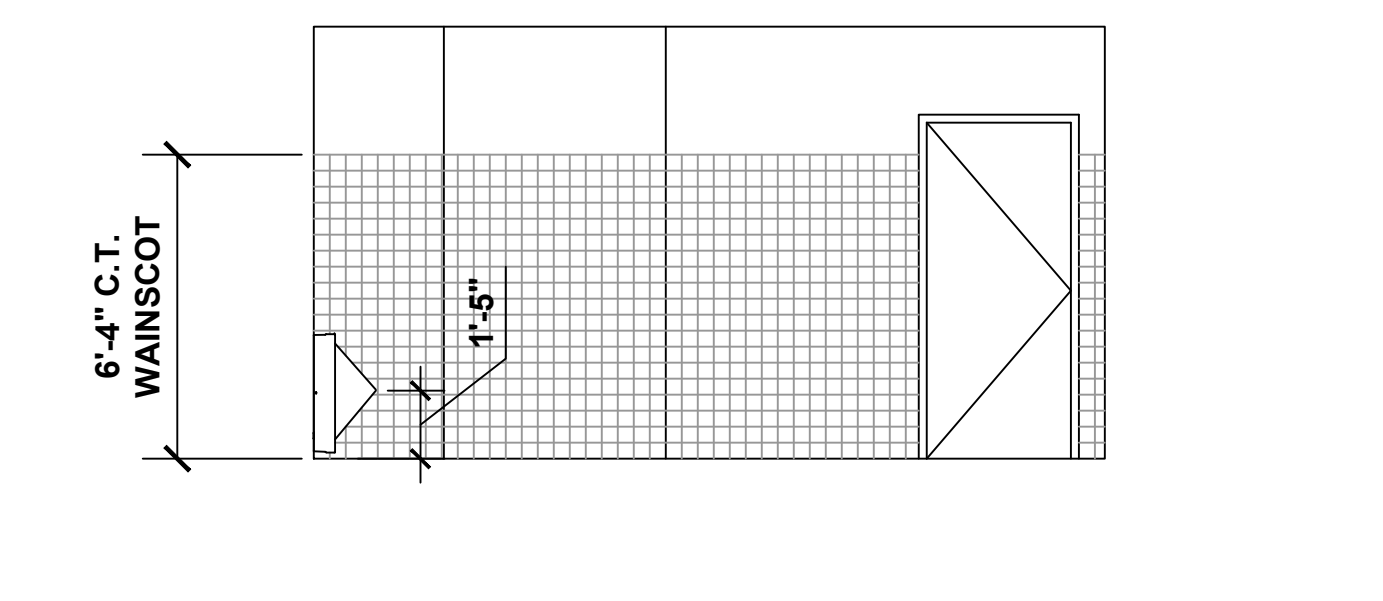

6 MEN'S TOILET ROOM 230 WEST ELEVATION

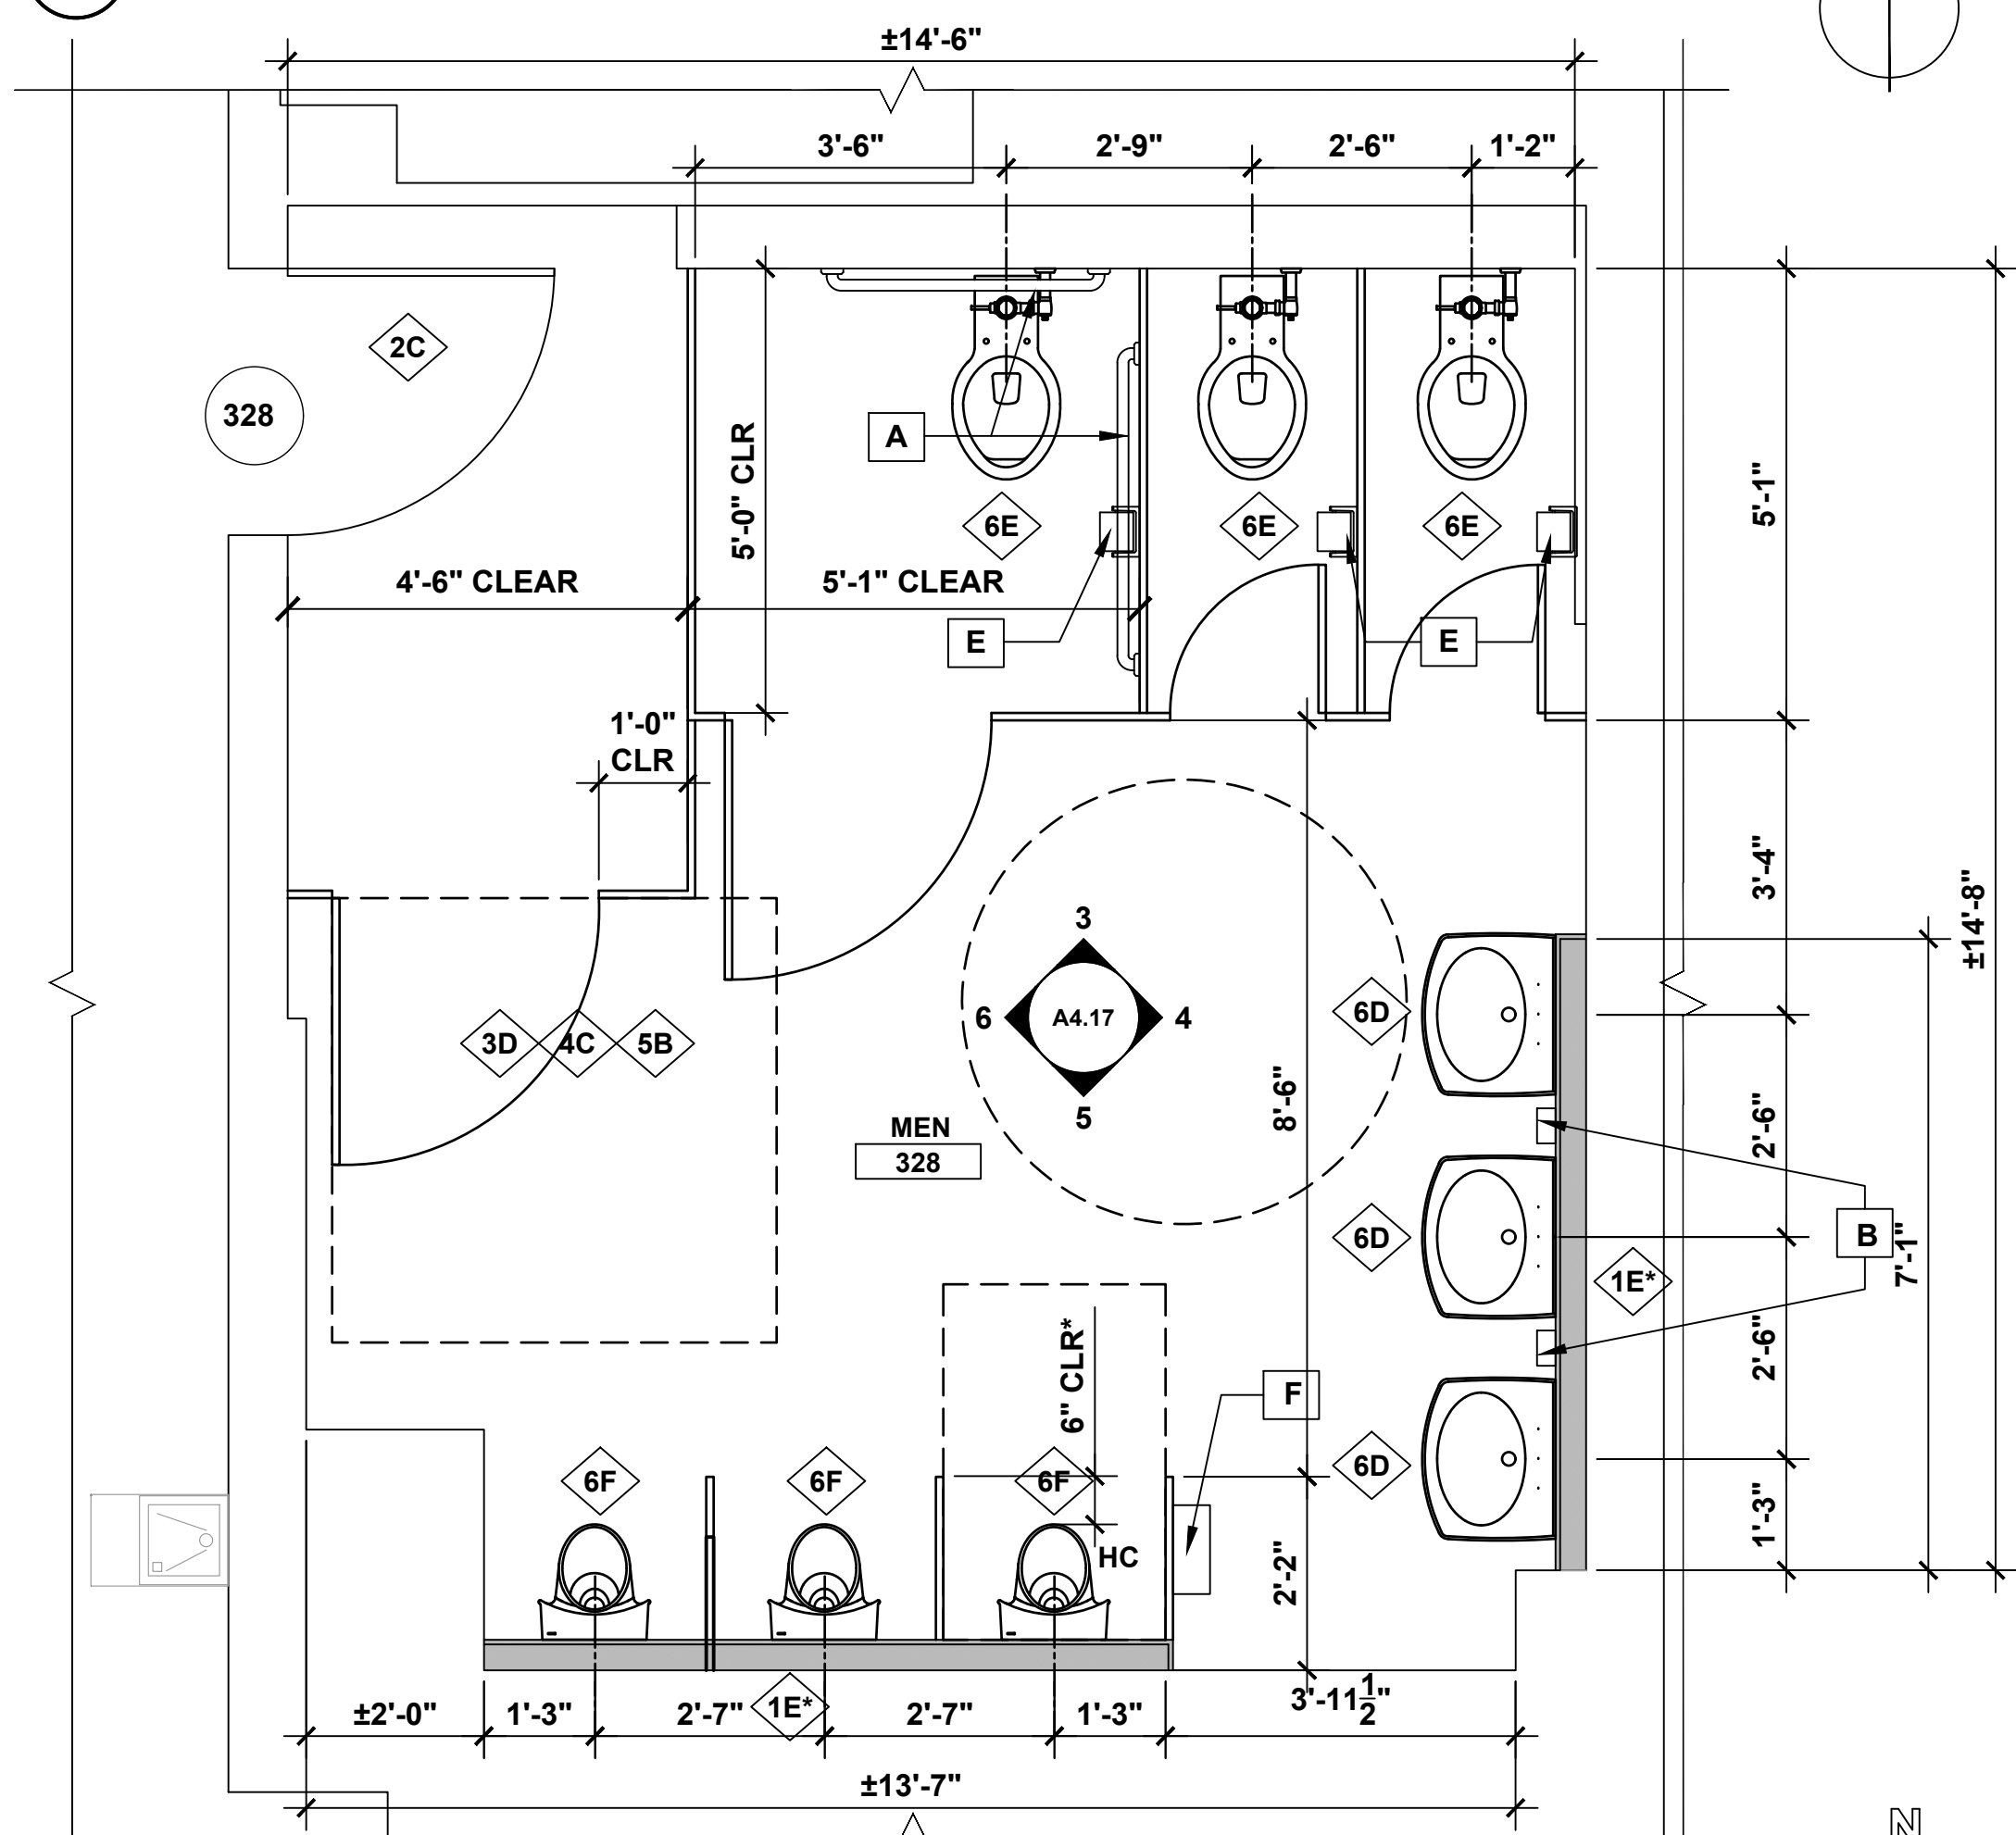


2 MEN'S TOILET ROOM 328 NEW WORK PLAN

GENERAL NEW WORK NOTE:
INFILL PORTIONS OF CHASE WALL AS REQUIRED FOR INSTALLATION OF FIXTURES. COORDINATE WITH MEP DWGS.

*LAVATORY BASIS OF DESIGN:
KOHLER 2035-4
SEE PLUMBING FIXTURE SCHEDULE, DWG P3.00


*URINAL BASIS OF DESIGN:
KOHLER K-4918-0
SEE PLUMBING FIXTURE SCHEDULE, DWG P3.00

- TOILET ACCESSORY KEYNOTES**
- A GRAB BARS - 36" & 42" LENGTHS MOUNTING HEIGHTS AT 33" AND 36" TO TOP OF GRIPPING SURFACE
 - B WALL MOUNTED SOAP DISPENSER MOUNTING HEIGHT - 42" TO CENTER OF NOZZLE, 48" AFF TO CONTROLS MAX. - OWNER SUPPLIED, INSTALLED BY CONTRACTOR
 - C TRASH RECEPTACLE FREE STANDING - BY OWNER
 - D VERTICAL GRAB BAR MOUNTING HEIGHT - 39" TO BOTTOM OF GRAB BAR
 - E TOILET PAPER DISPENSER MOUNTING HEIGHT - 17" TO OUTLET OF DISPENSER AFF - 29" TO TOP OF DISPENSER MAX. - OWNER SUPPLIED, INSTALLED BY CONTRACTOR
 - F PAPER TOWEL DISPENSER MOUNTING HEIGHT - 48" AT CENTER OF DISPENSED AREA; 48" AFF TO CONTROLS MAX. - OWNER SUPPLIED, INSTALLED BY CONTRACTOR
 - G SANITARY NAPKIN RECEPTACLE MOUNTING HEIGHT - 29" AT TOP OF RECEPTACLE - OWNER SUPPLIED, INSTALLED BY CONTRACTOR
 - H LAVATORY MIRROR - SIZE: 18"x30" MOUNTING HEIGHT - 40" TO BOTTOM OF MIRROR

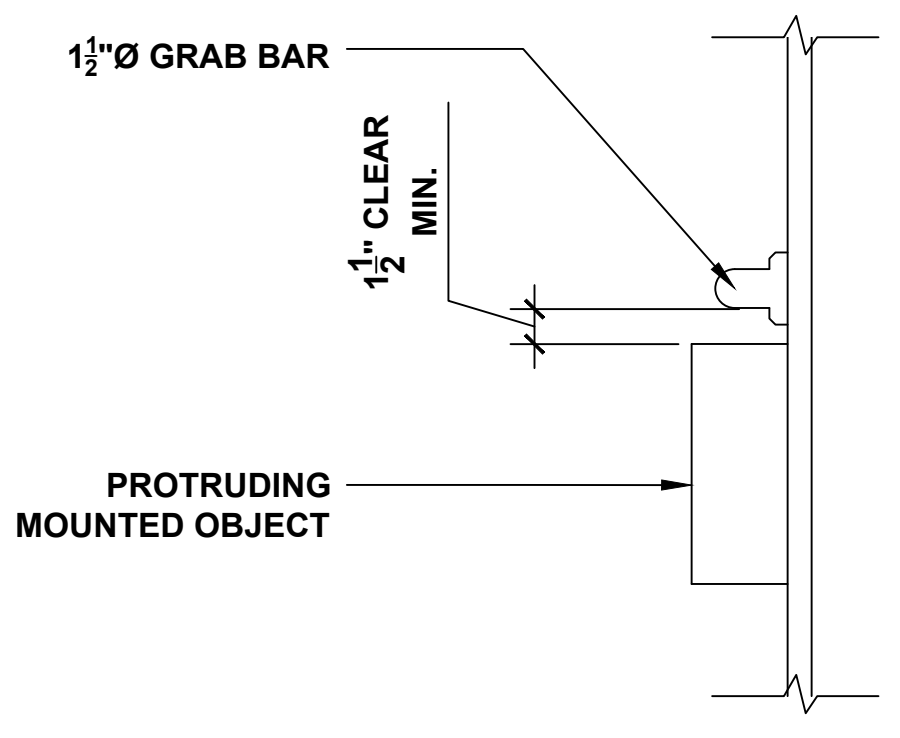

7 DETAIL AT GRAB BARS

NOTE:
SUPPLEMENTAL BID ITEM #1

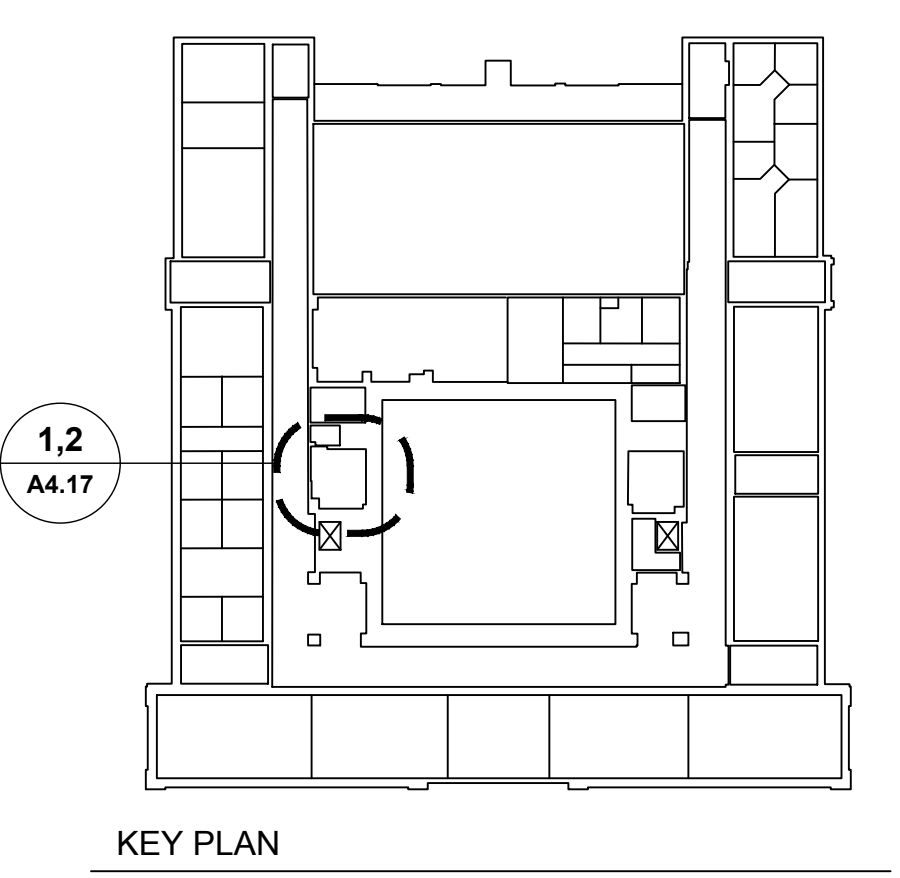


KEY PLAN

- DEMOLITION KEY NOTES**
- 1A REMOVE MASONRY WALL.
 - 1B REMOVE STUD AND GYP BD WALL.
 - 2A REMOVE DOOR AND FRAME.
 - 2B REMOVE DOOR, EXISTING FRAME TO REMAIN.
 - 3A REMOVE C.T. FLOOR.
 - 3B REMOVE VCT FLOOR.
 - 3C REMOVE CARPET.
 - 4A REMOVE C.T. WAINSCOT AND BASE.
 - 4B REMOVE VINYL BASE
 - 5A REMOVE ACT CEILING.
 - 6A REMOVE LAV.
 - 6B REMOVE TOILET & TOILET PARTITION.
 - 6C REMOVE URINAL AND URINAL SCREEN.


- NEW WORK KEY NOTES**
- 1C PROVIDE MASONRY WALL.
 - 1D PROVIDE 1 HOUR RATED WALL, 3/8" METAL STUDS WITH 5/8" TYPE 'X' GYP. BOARD BOTH SIDES
 - 1E PROVIDE 5/8" MOISTURE RESISTANT GYP BD ON EXISTING STUDS.
 - 1F PROVIDE 3/8" METAL STUDS WITH 5/8" TYPE 'X' GYP. BOARD ONE SIDE
 - 1G PROVIDE 3/8" METAL STUDS WITH 5/8" TYPE 'X' GYP. BOARD BOTH SIDES
 - 2C PROVIDE WOOD DOOR AND HM FRAME.
 - 2D PROVIDE WOOD DOOR IN EXISTING HM FRAME.
 - 3D PROVIDE CT FLOOR AND CT BASE.
 - 3E PROVIDE VCT AND RESILIENT BASE.
 - 3F PROVIDE CARPET AND RESILIENT BASE.
 - 3G EXISTING FLOORING TO REMAIN. (PROTECT DURING RENOVATION)
 - 4C PROVIDE CT WAINSCOT AND BASE/ PAINT ABOVE
 - 4D PREP AND PAINT WALLS
 - 4E PROVIDE HORIZONTAL WINDOW BLINDS
 - 5B PROVIDE ACT CEILING.
 - 5C REMOVE & REINSTALL ACT CEILING AFTER MEP WORK IS COMPLETED.
 - 5D PROVIDE GYPSUM BOARD CEILING/SOFFIT AND PAINT
 - 5E PAINT EXISTING CEILING
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 - 7A REMOVE TACK BOARDS. INSTALL PROVIDED OR EXISTING BOARDS AFTER ALL CORRIDOR WORK HAS BEEN COMPLETED. COORDINATE LOCATIONS WITH OWNER.
 - 7B REMOVE BULLETIN BOARD. INSTALL PROVIDED OR EXISTING BOARDS AFTER ALL CORRIDOR WORK HAS BEEN COMPLETED. COORDINATE LOCATIONS WITH OWNER.
 - 7C EXISTING DISPLAY CASES TO REMAIN IN PLACE. PAINT INTERIOR TO MATCH CORRIDOR COLOR. PAINT TRIM TO MATCH DOOR TRIM COLOR.

| drawing title | | | STATE OF CONNECTICUT | |
|-------------------------------------|---------|-------------------------------|--|----------------|
| THIRD FLOOR MEN'S TOILET ROOM PLANS | | | DEPARTMENT OF ADMINISTRATIVE SERVICES | |
| REVISIONS | | | | |
| mark | date | description | drawing prepared by | date |
| | 8/4/17 | SCHEMATIC DESIGN SUBMISSION | AMES & WHITAKER ARCHITECTS 31 LIBERTY STREET SOUTHINGTON, CT | 07/25/18 |
| | 1/15/18 | DESIGN DEVELOPMENT SUBMISSION | | scale AS NOTED |
| | 4/16/18 | CONSTRUCTION DOCUMENTS | | |
| | | | project | |
| | | | WESTERN CT STATE UNIVERSITY WHITE HALL 2ND AND 3RD FLOOR RENOVATIONS DANBURY, CONNECTICUT | approved by AL |
| | | | CAD no. | drawing no. |
| | | | project no. BI-RD-299 | A4.17 |

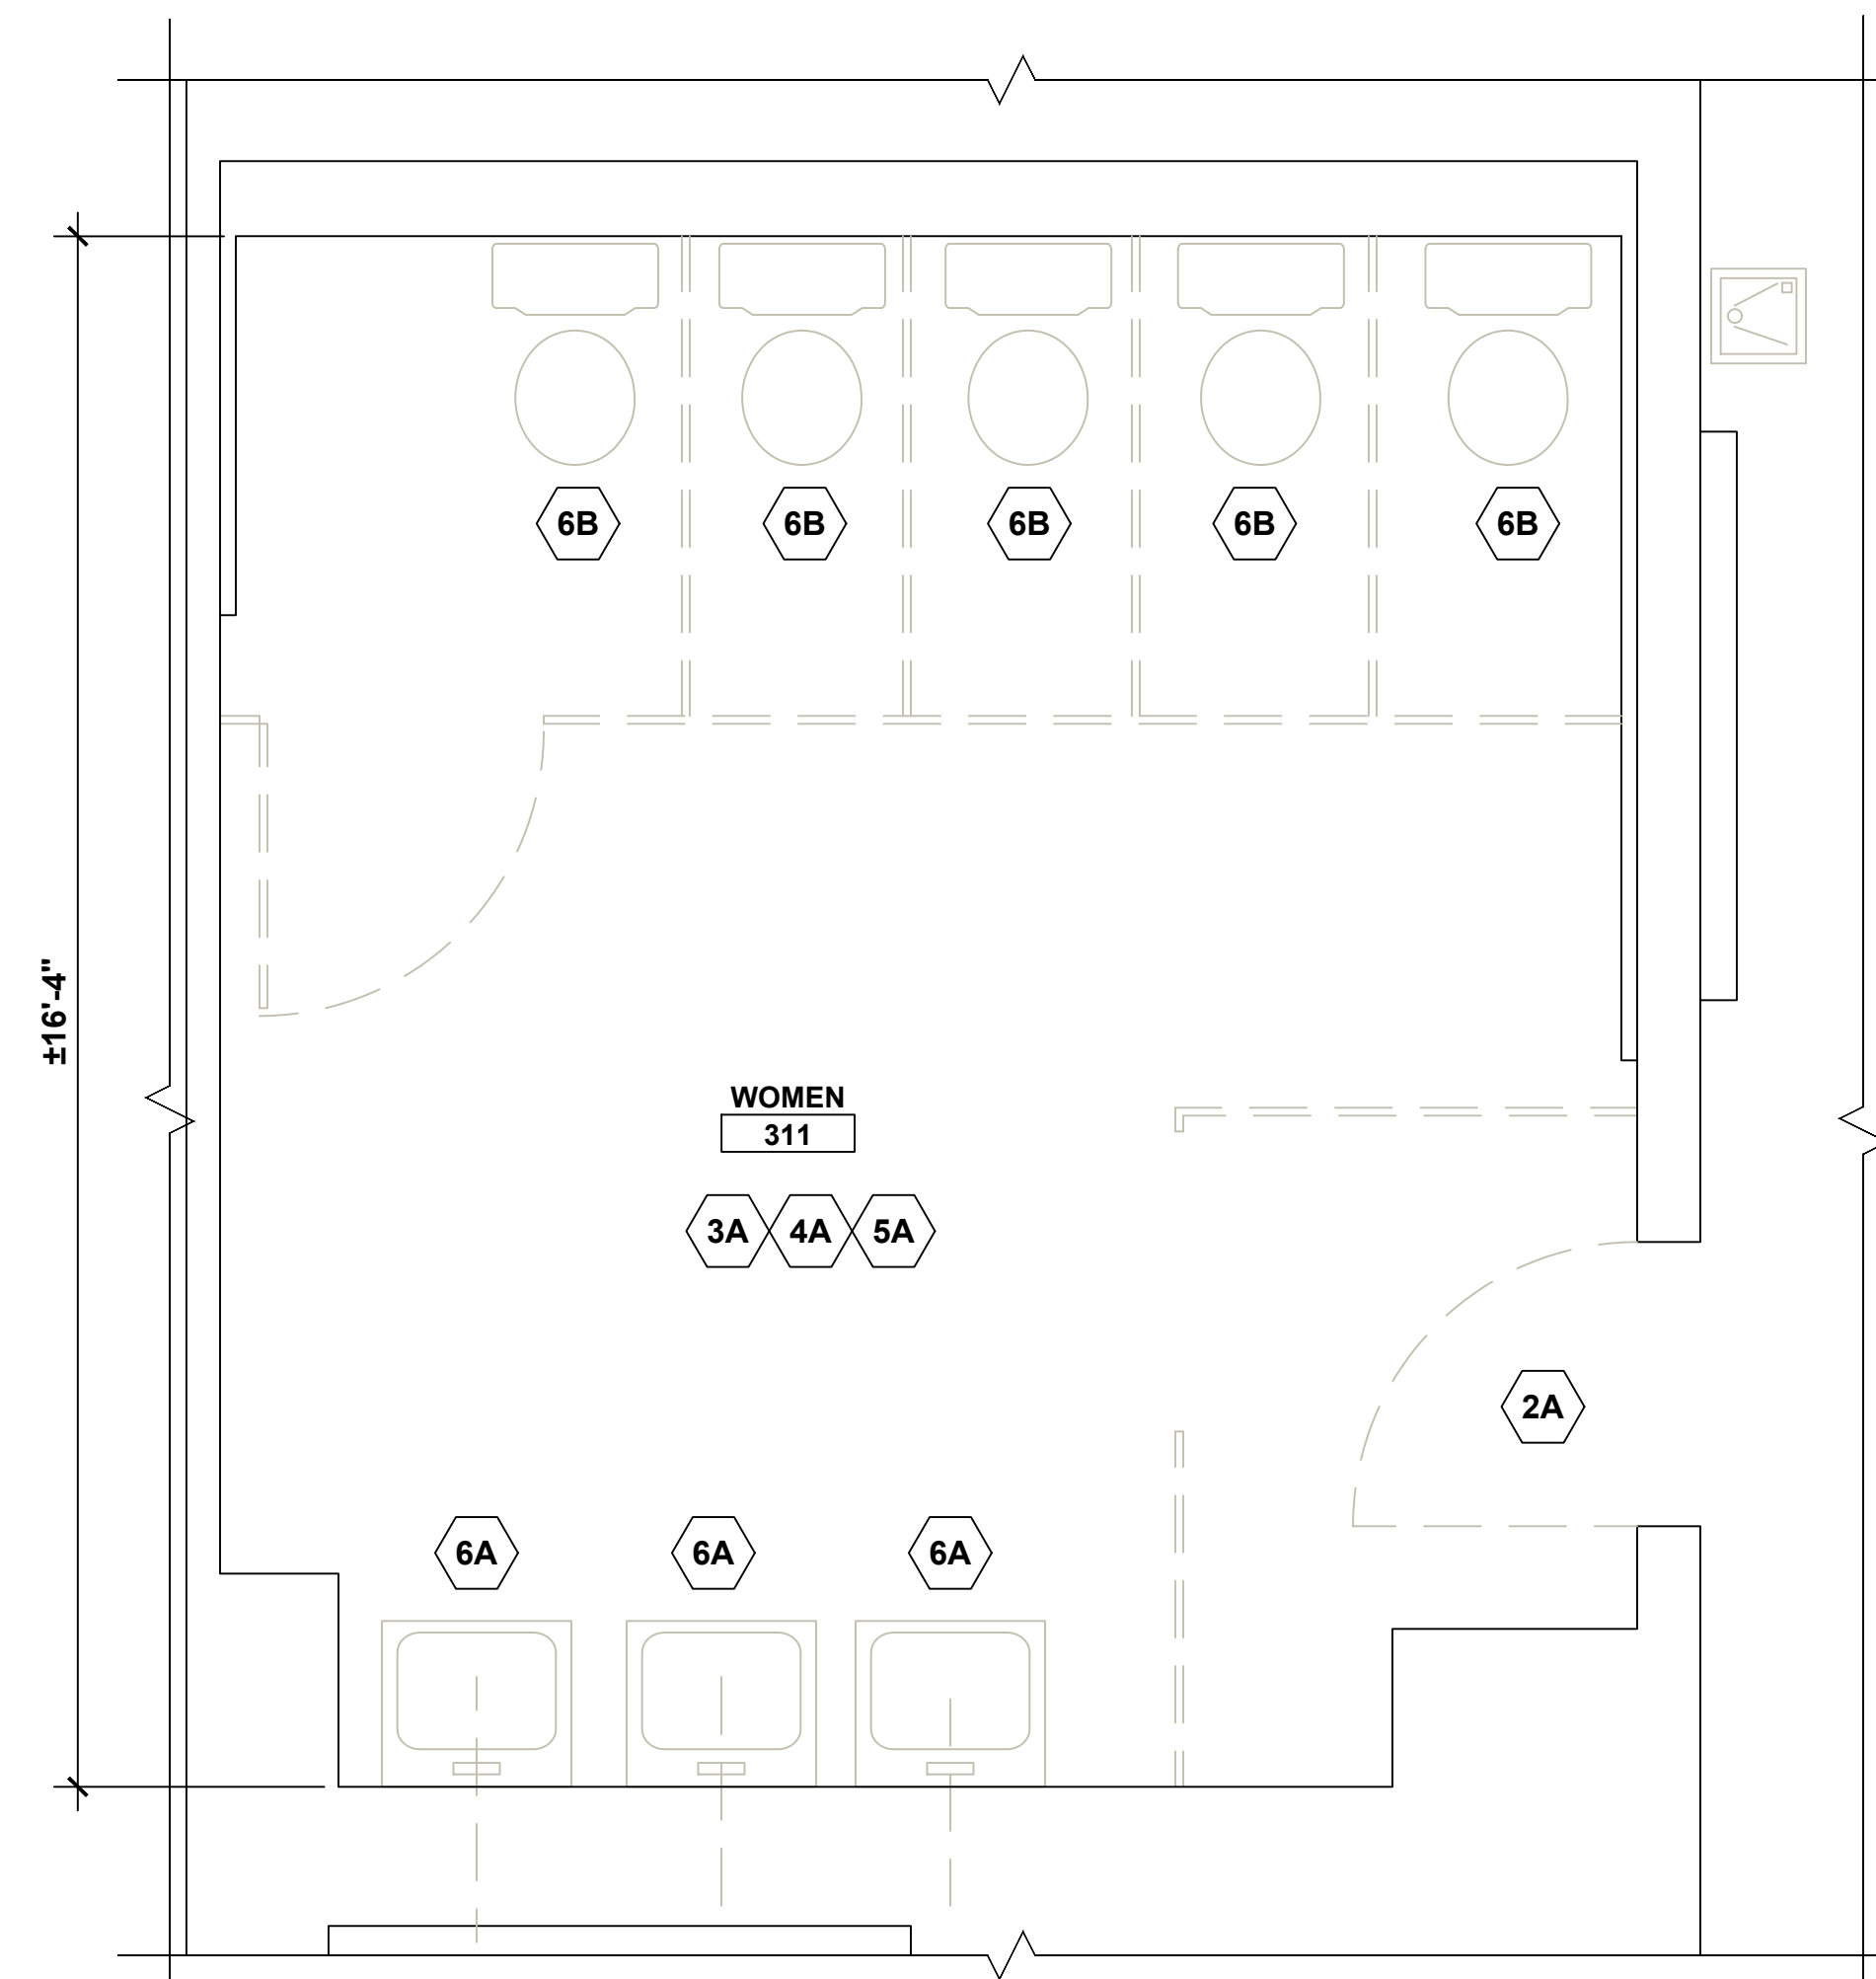


2 WOMEN'S TOILET ROOM 311 DEMO PLAN


GENERAL DEMO NOTE:
REMOVE PORTIONS OF CHASE WALL AS REQUIRED FOR REMOVAL AND INSTALLATION OF FIXTURES. COORDINATE WITH MEP DWGS.

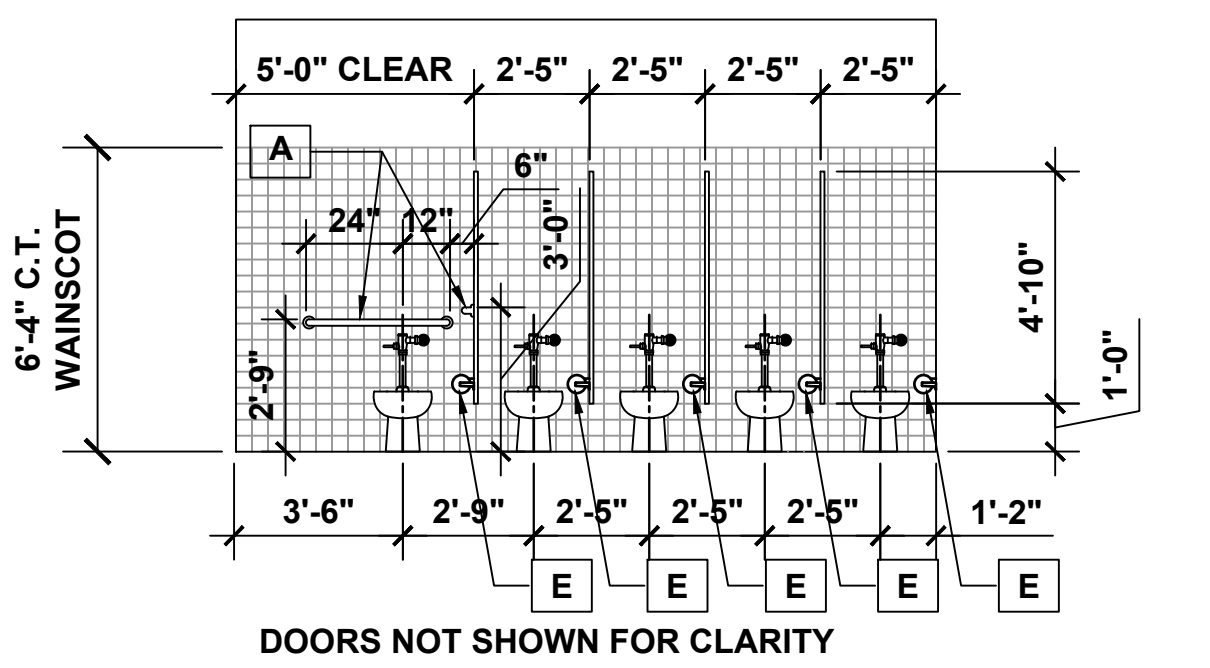


3 WOMEN'S TOILET ROOM 215 NORTH ELEVATION

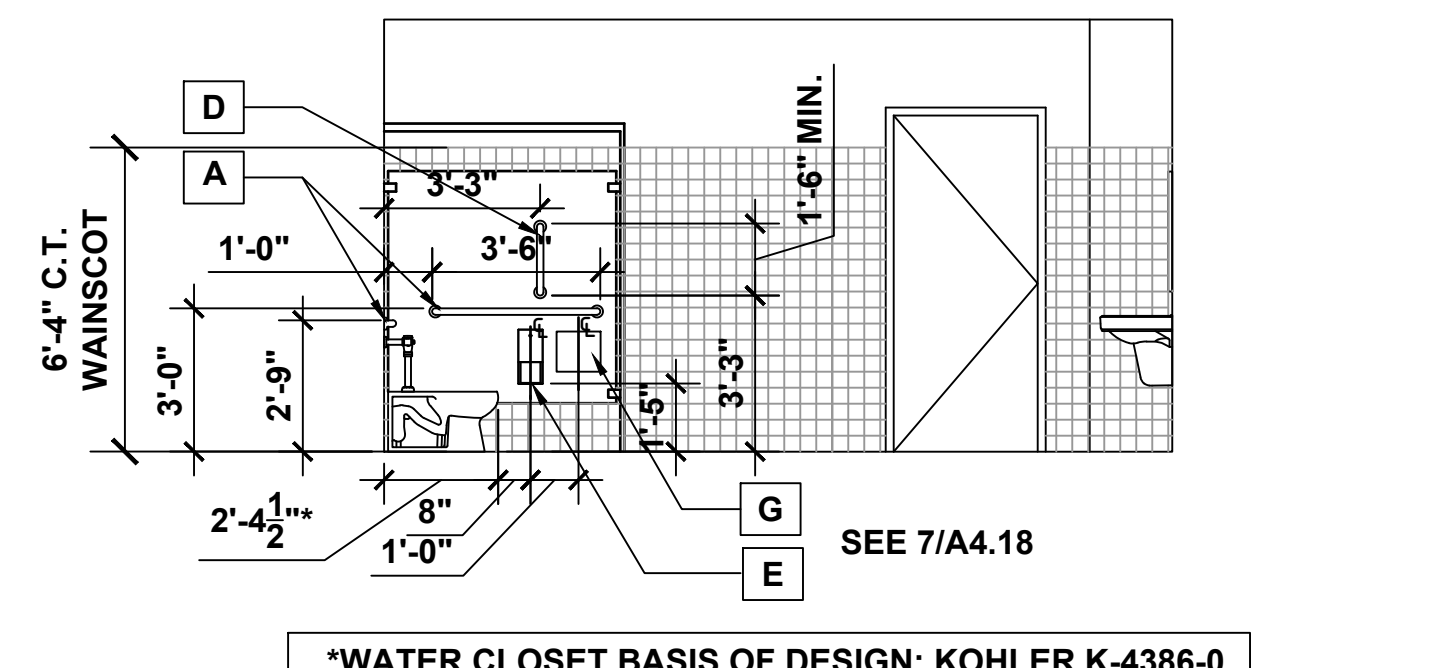


4 WOMEN'S TOILET ROOM 215 EAST ELEVATION

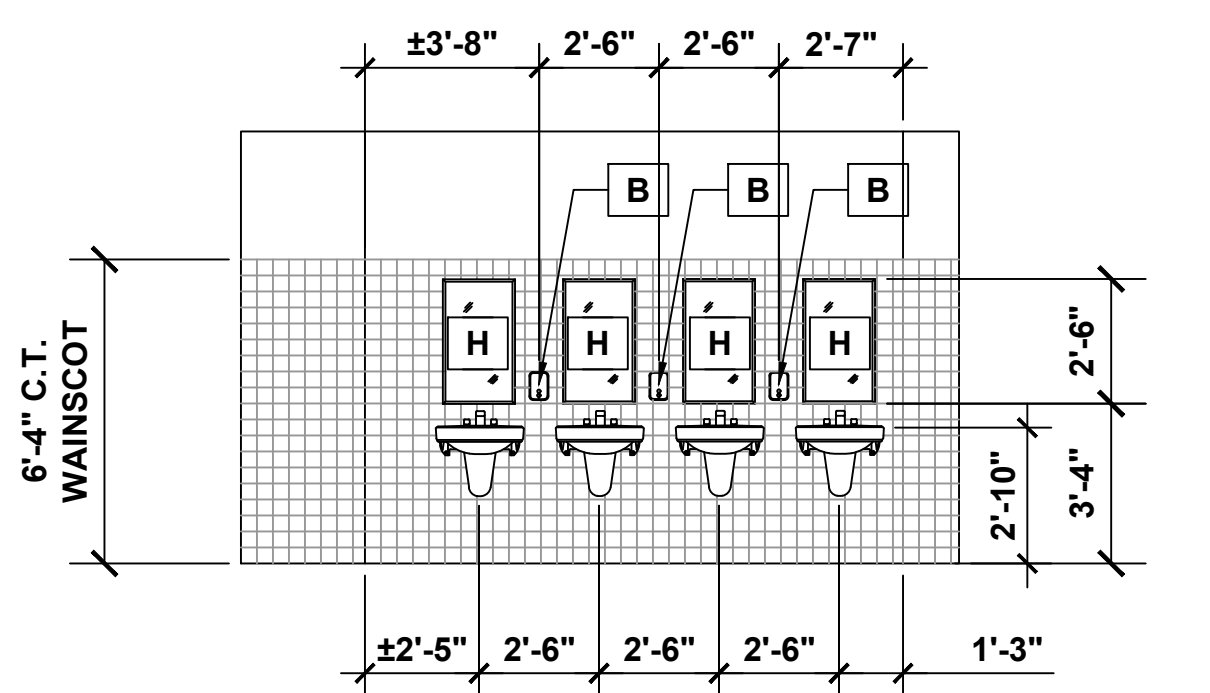

5 WOMEN'S TOILET ROOM 215 SOUTH ELEVATION

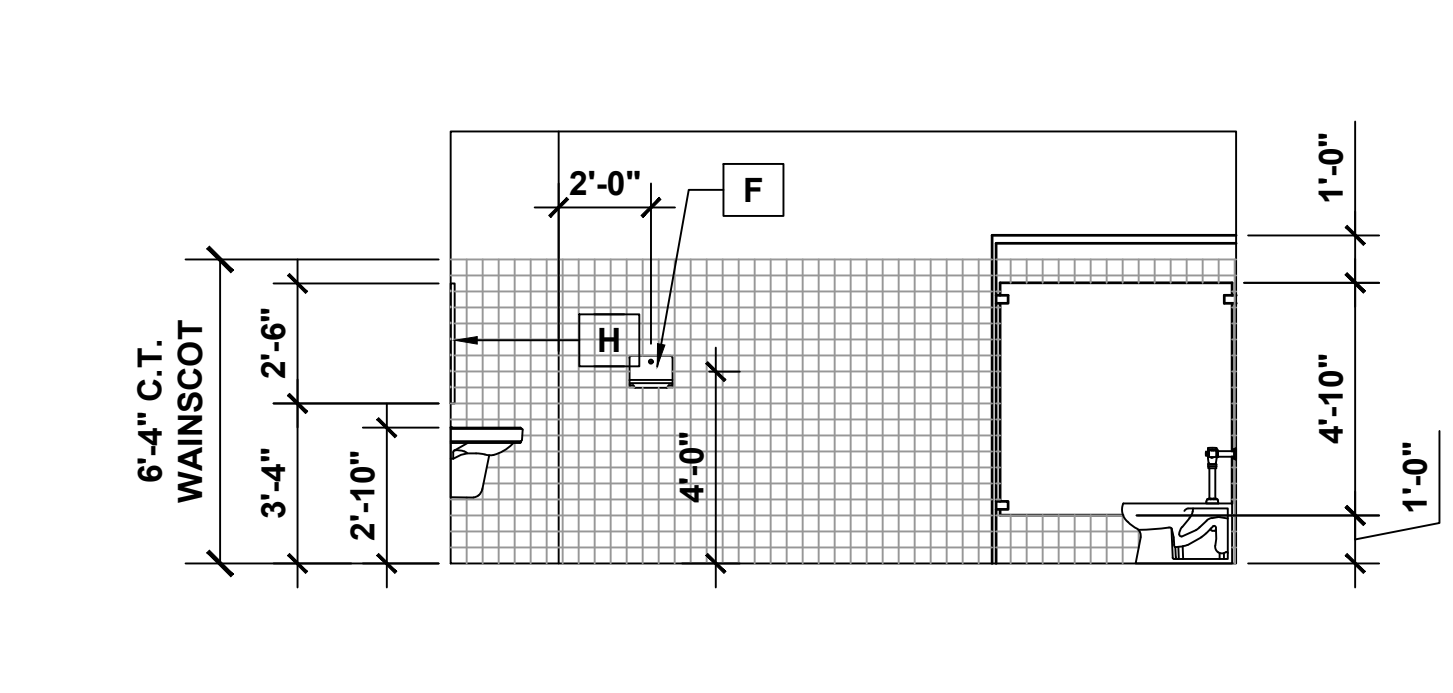

6 WOMEN'S TOILET ROOM 215 WEST ELEVATION

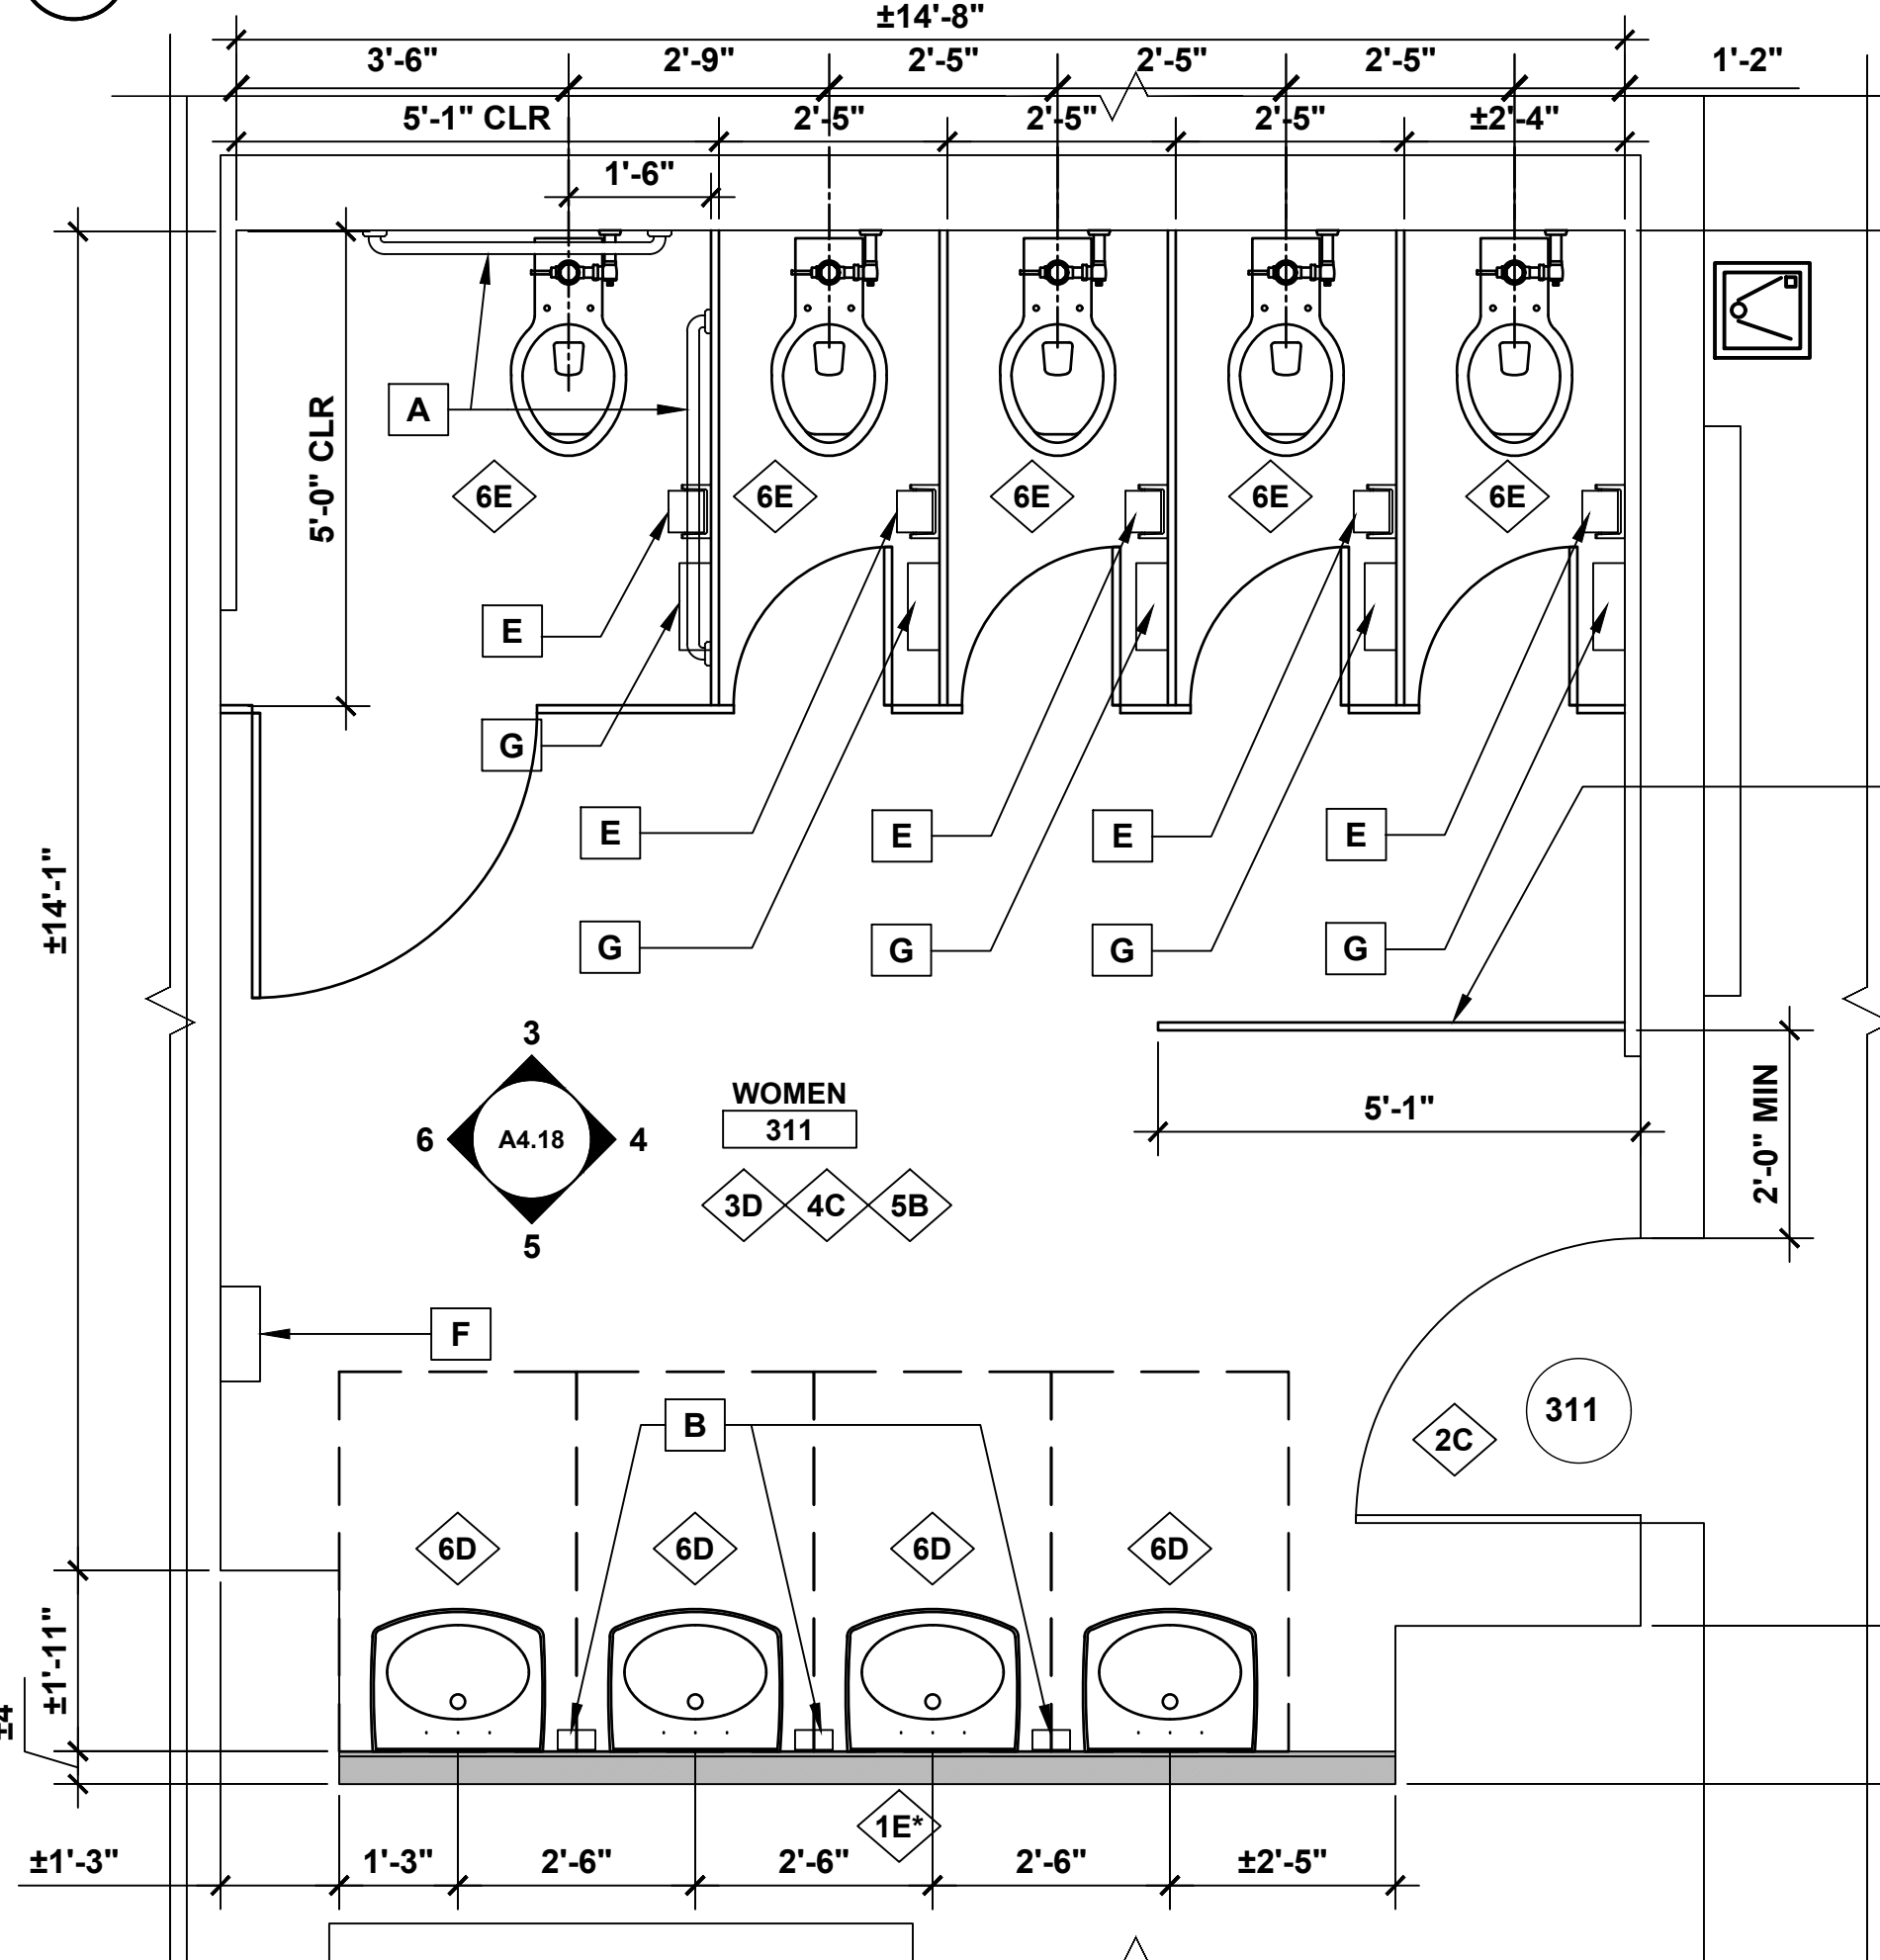


4 WOMEN'S TOILET ROOM 311 NEW WORK PLAN

GENERAL NEW WORK NOTE:
INFILL PORTIONS OF CHASE WALL AS REQUIRED FOR INSTALLATION OF FIXTURES. COORDINATE WITH MEP DWGS.

PROVIDE PRIVACY SCREEN


*LAVATORY BASIS OF DESIGN:
KOHLER 2035-4
SEE PLUMBING FIXTURE SCHEDULE, DWG P3.00

- TOILET ACCESSORY KEYNOTES**
- A GRAB BARS - 36" & 42" LENGTHS MOUNTING HEIGHTS AT 33" AND 36" TO TOP OF GRIPPING SURFACE
 - B WALL MOUNTED SOAP DISPENSER MOUNTING HEIGHT - 42" TO CENTER OF NOZZLE, 48" AFF TO CONTROLS MAX. - OWNER SUPPLIED, INSTALLED BY CONTRACTOR
 - C TRASH RECEPTACLE FREE STANDING - BY OWNER
 - D VERTICAL GRAB BAR MOUNTING HEIGHT - 39" TO BOTTOM OF GRAB BAR
 - E TOILET PAPER DISPENSER MOUNTING HEIGHT - 17" TO OUTLET OF DISPENSER AFF - 29" TO TOP OF DISPENSER MAX. - OWNER SUPPLIED, INSTALLED BY CONTRACTOR
 - F PAPER TOWEL DISPENSER MOUNTING HEIGHT - 48" AT CENTER OF DISPENSED AREA; 48" AFF TO CONTROLS MAX. - OWNER SUPPLIED, INSTALLED BY CONTRACTOR
 - G SANITARY NAPKIN RECEPTACLE MOUNTING HEIGHT - 29" AT TOP OF RECEPTACLE - OWNER SUPPLIED, INSTALLED BY CONTRACTOR
 - H LAVATORY MIRROR - SIZE: 18"x30" MOUNTING HEIGHT - 40" TO BOTTOM OF MIRROR

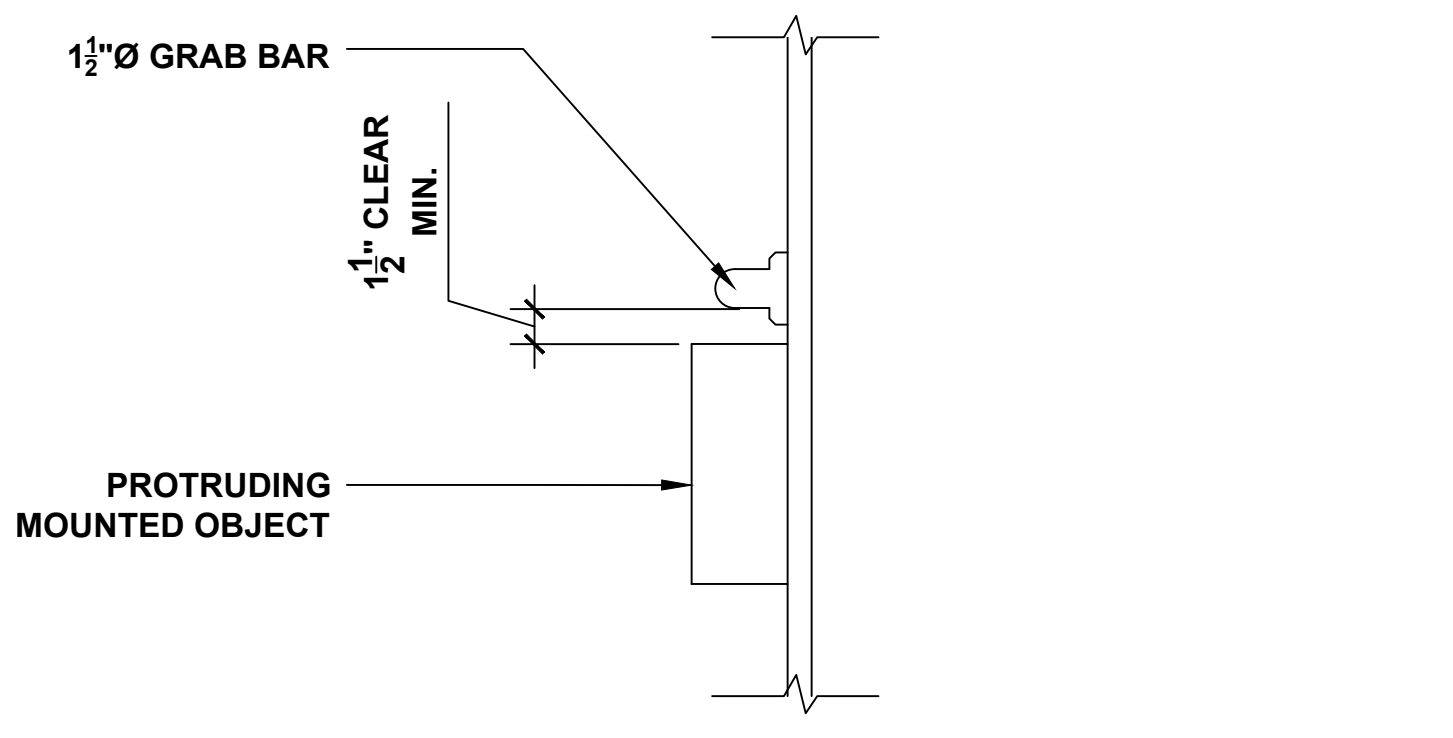

7 DETAIL AT GRAB BARS

NOTE:
SUPPLEMENTAL BID ITEM #1

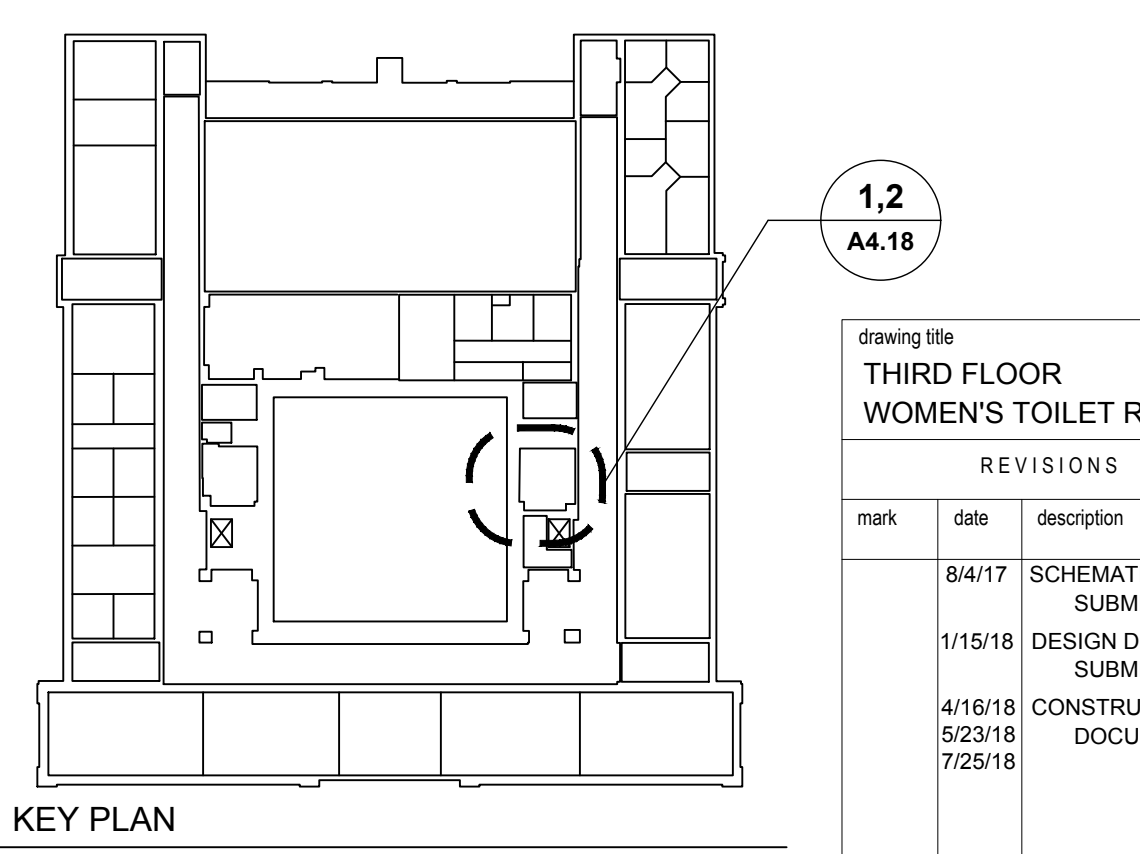





KEY PLAN

- DEMOLITION KEY NOTES**
- 1A REMOVE MASONRY WALL.
 - 1B REMOVE STUD AND GYP BD WALL.
 - 2A REMOVE DOOR AND FRAME.
 - 2B REMOVE DOOR, EXISTING FRAME TO REMAIN.
 - 3A REMOVE C.T. FLOOR.
 - 3B REMOVE VCT FLOOR.
 - 3C REMOVE CARPET.
 - 4A REMOVE C.T. WAINSCOT AND BASE.
 - 4B REMOVE VINYL BASE
 - 5A REMOVE ACT CEILING.
 - 6A REMOVE LAV.
 - 6B REMOVE TOILET & TOILET PARTITION.
 - 6C REMOVE URINAL AND URINAL SCREEN.

- NEW WORK KEY NOTES**
- 1C PROVIDE MASONRY WALL.
 - 1D PROVIDE 1 HOUR RATED WALL, 3/8" METAL STUDS WITH 5/8" TYPE 'X' GYP. BOARD BOTH SIDES
 - 1E PROVIDE 5/8" MOISTURE RESISTANT GYP BD ON EXISTING STUDS.
 - 1F PROVIDE 3/8" METAL STUDS WITH 5/8" TYPE 'X' GYP. BOARD ONE SIDE
 - 1G PROVIDE 3/8" METAL STUDS WITH 5/8" TYPE 'X' GYP. BOARD BOTH SIDES
 - 2C PROVIDE WOOD DOOR AND HM FRAME.
 - 2D PROVIDE WOOD DOOR IN EXISTING HM FRAME.
 - 3D PROVIDE CT FLOOR AND CT BASE.
 - 3E PROVIDE VCT AND RESILIENT BASE.
 - 3F PROVIDE CARPET AND RESILIENT BASE.
 - 3G EXISTING FLOORING TO REMAIN. (PROTECT DURING RENOVATION)
 - 4C PROVIDE CT WAINSCOT AND BASE/ PAINT ABOVE
 - 4D PREP AND PAINT WALLS
 - 4E PROVIDE HORIZONTAL WINDOW BLINDS
 - 5B PROVIDE ACT CEILING.
 - 5C REMOVE & REINSTALL ACT CEILING AFTER MEP WORK IS COMPLETED.
 - 5D PROVIDE GYPSUM BOARD CEILING/SOFFIT AND PAINT
 - 5E PAINT EXISTING CEILING
 - 6D PROVIDE LAV
 - 6E PROVIDE TOILET & PARTITION
 - 6F PROVIDE URINAL & SCREEN
 - 7A REMOVE TACK BOARDS. INSTALL PROVIDED OR EXISTING BOARDS AFTER ALL CORRIDOR WORK HAS BEEN COMPLETED. COORDINATE LOCATIONS WITH OWNER.
 - 7B REMOVE BULLETIN BOARD. INSTALL PROVIDED OR EXISTING BOARDS AFTER ALL CORRIDOR WORK HAS BEEN COMPLETED. COORDINATE LOCATIONS WITH OWNER.
 - 7C EXISTING DISPLAY CASES TO REMAIN IN PLACE. PAINT INTERIOR TO MATCH CORRIDOR COLOR. PAINT TRIM TO MATCH DOOR TRIM COLOR.

| drawing title | | THIRD FLOOR WOMEN'S TOILET ROOM PLANS | |
|---------------|---------|---------------------------------------|--|
| REVISIONS | | | |
| mark | date | description | |
| | 8/4/17 | SCHEMATIC DESIGN SUBMISSION | |
| | 1/15/18 | DESIGN DEVELOPMENT SUBMISSION | |
| | 4/16/18 | CONSTRUCTION DOCUMENTS | |
| | 5/23/18 | | |
| | 7/25/18 | | |

| STATE OF CONNECTICUT | | DEPARTMENT OF ADMINISTRATIVE SERVICES | |
|-------------------------------|--|---------------------------------------|--|
| drawing prepared by | | AMES & WHITAKER ARCHITECTS | |
| 31 LIBERTY STREET | | SOUTHINGTON, CT | |
| project | | WESTERN CT STATE UNIVERSITY | |
| 2ND AND 3RD FLOOR RENOVATIONS | | DANBURY, CONNECTICUT | |
| drawing no. | | A4.18 | |
| CAD no. | | project no. BI-RD-299 | |
| date | | 07/25/18 | |
| scale | | AS NOTED | |
| drawn by | | SP/CA | |
| approved by | | AL | |

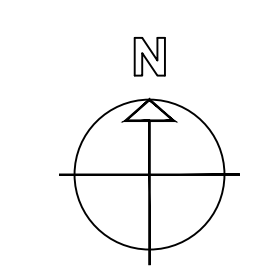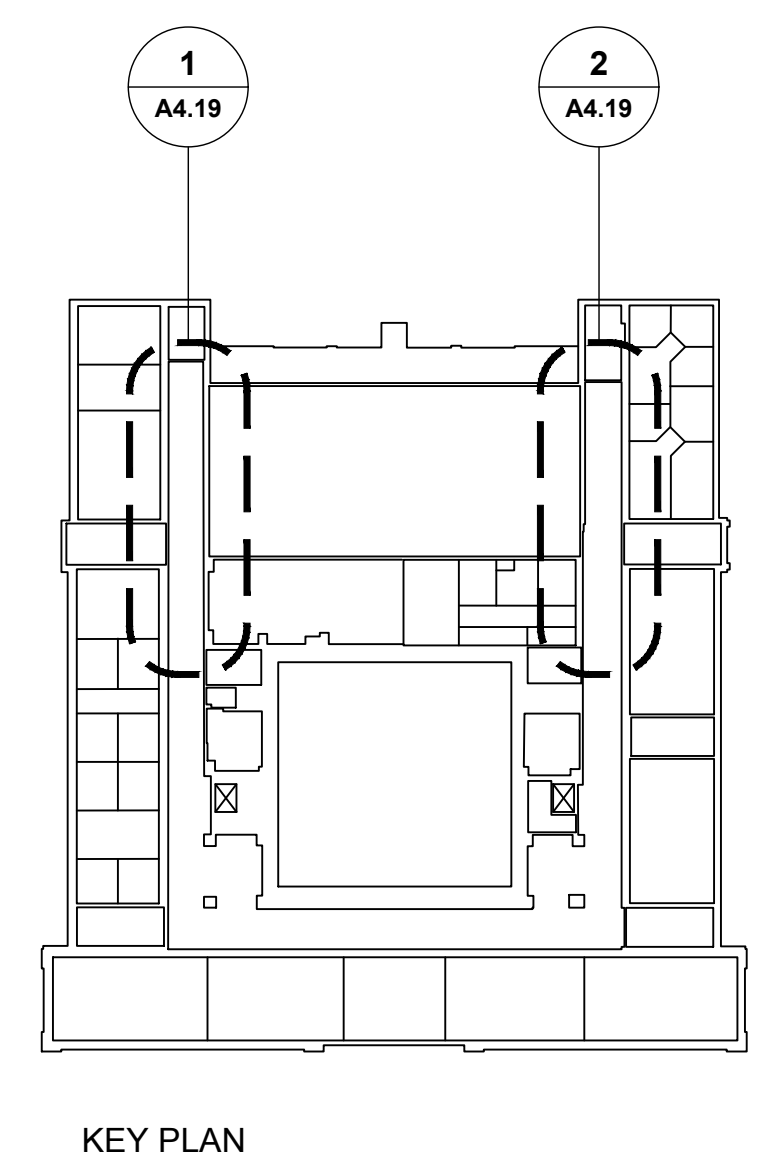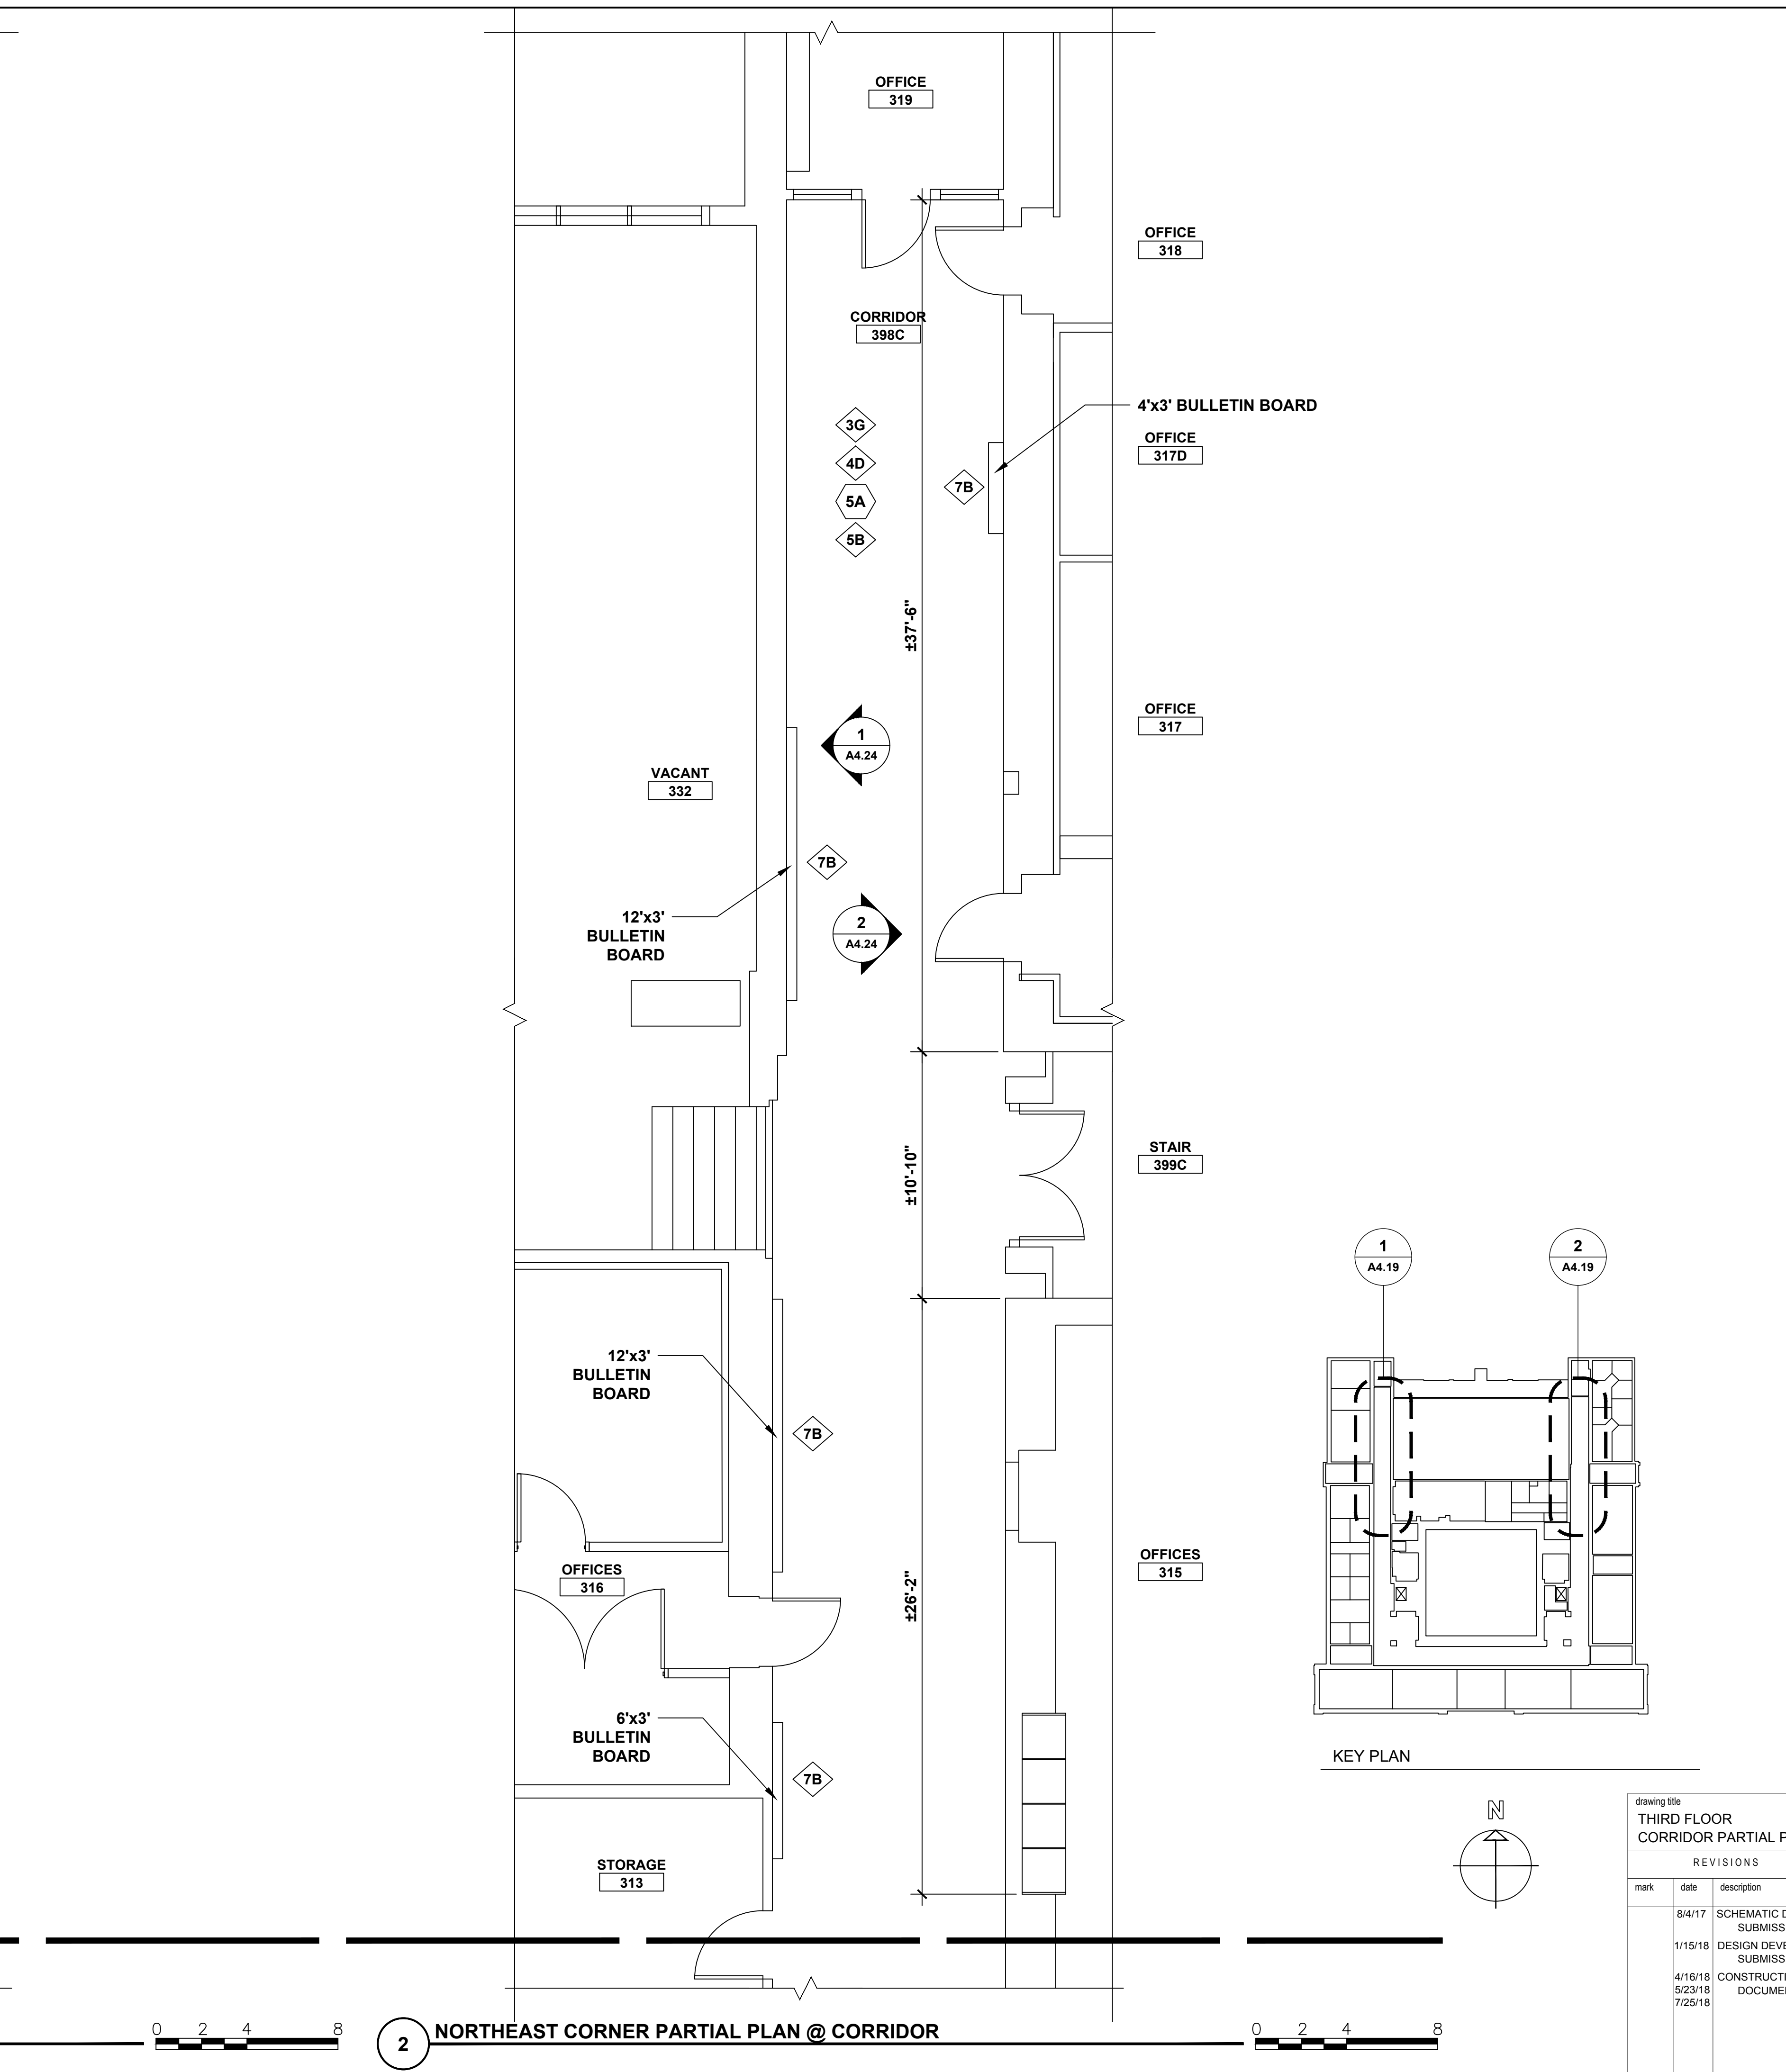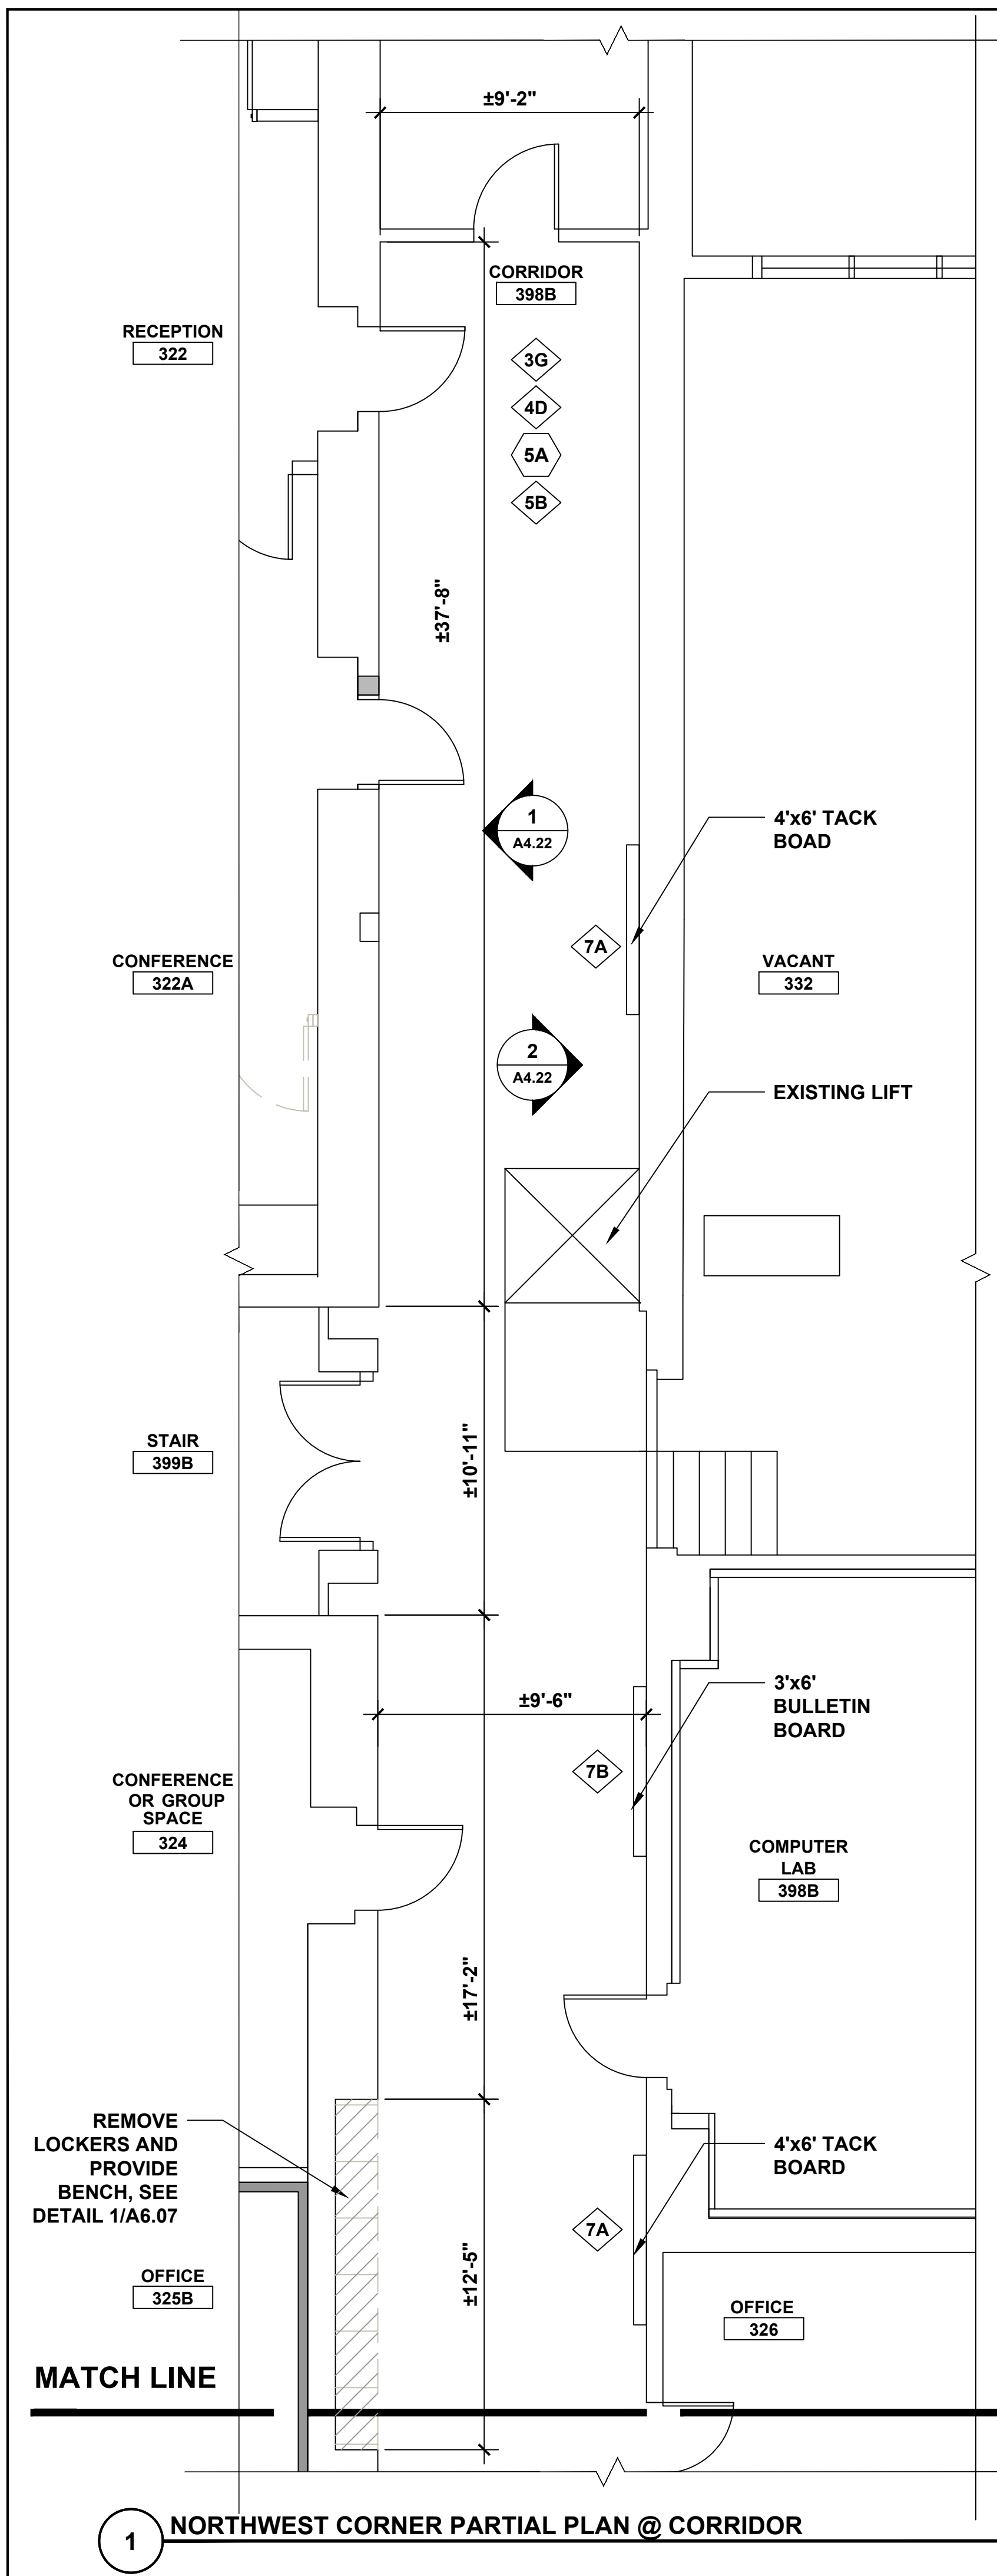


- DEMOLITION KEY NOTES**
- 1A REMOVE MASONRY WALL.
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 - 2B REMOVE DOOR. EXISTING FRAME TO REMAIN.
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 - 3B REMOVE VCT FLOOR.
 - 3C REMOVE CARPET.
 - 4A REMOVE C.T. WAINSCOT AND BASE.
 - 4B REMOVE VINYL BASE
 - 5A REMOVE ACT CEILING.
 - 6A REMOVE LAV.
 - 6B REMOVE TOILET & TOILET PARTITION.
 - 6C REMOVE URINAL AND URINAL SCREEN.

- NEW WORK KEY NOTES**
- 1C PROVIDE MASONRY WALL.
 - 1D PROVIDE 1 HOUR RATED WALL, 3/8" METAL STUDS WITH 5/8" TYPE 'X' GYP. BOARD BOTH SIDES
 - 1E PROVIDE 5/8" MOISTURE RESISTANT GYP BD ON EXISTING STUDS.
 - 1F PROVIDE 3/8" METAL STUDS WITH 5/8" TYPE 'X' GYP. BOARD ONE SIDE
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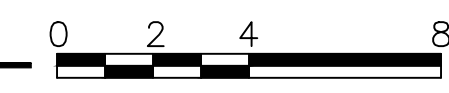
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| REVISIONS | | | |
| mark | date | description | |
| | 8/4/17 | SCHEMATIC DESIGN SUBMISSION | |
| | 1/15/18 | DESIGN DEVELOPMENT SUBMISSION | |
| | 4/16/18 | CONSTRUCTION DOCUMENTS | |
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| | 7/25/18 | | |


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| drawing prepared by | date |
| AMES & WHITAKER ARCHITECTS | 07/25/18 |
| 31 LIBERTY STREET | scale |
| SOUTHINGTON, CT | AS NOTED |
| project | drawn by |
| WESTERN CT STATE UNIVERSITY | SP/ICA |
| WHITE HALL | approved by |
| 2ND AND 3RD FLOOR RENOVATIONS | AL |
| DANBURY, CONNECTICUT | drawing no. |
| CAD no. | A4.19 |
| project no. | |
| BI-RD-299 | |

1 NORTHWEST CORNER PARTIAL PLAN @ CORRIDOR

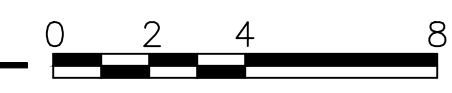

2 NORTHEAST CORNER PARTIAL PLAN @ CORRIDOR




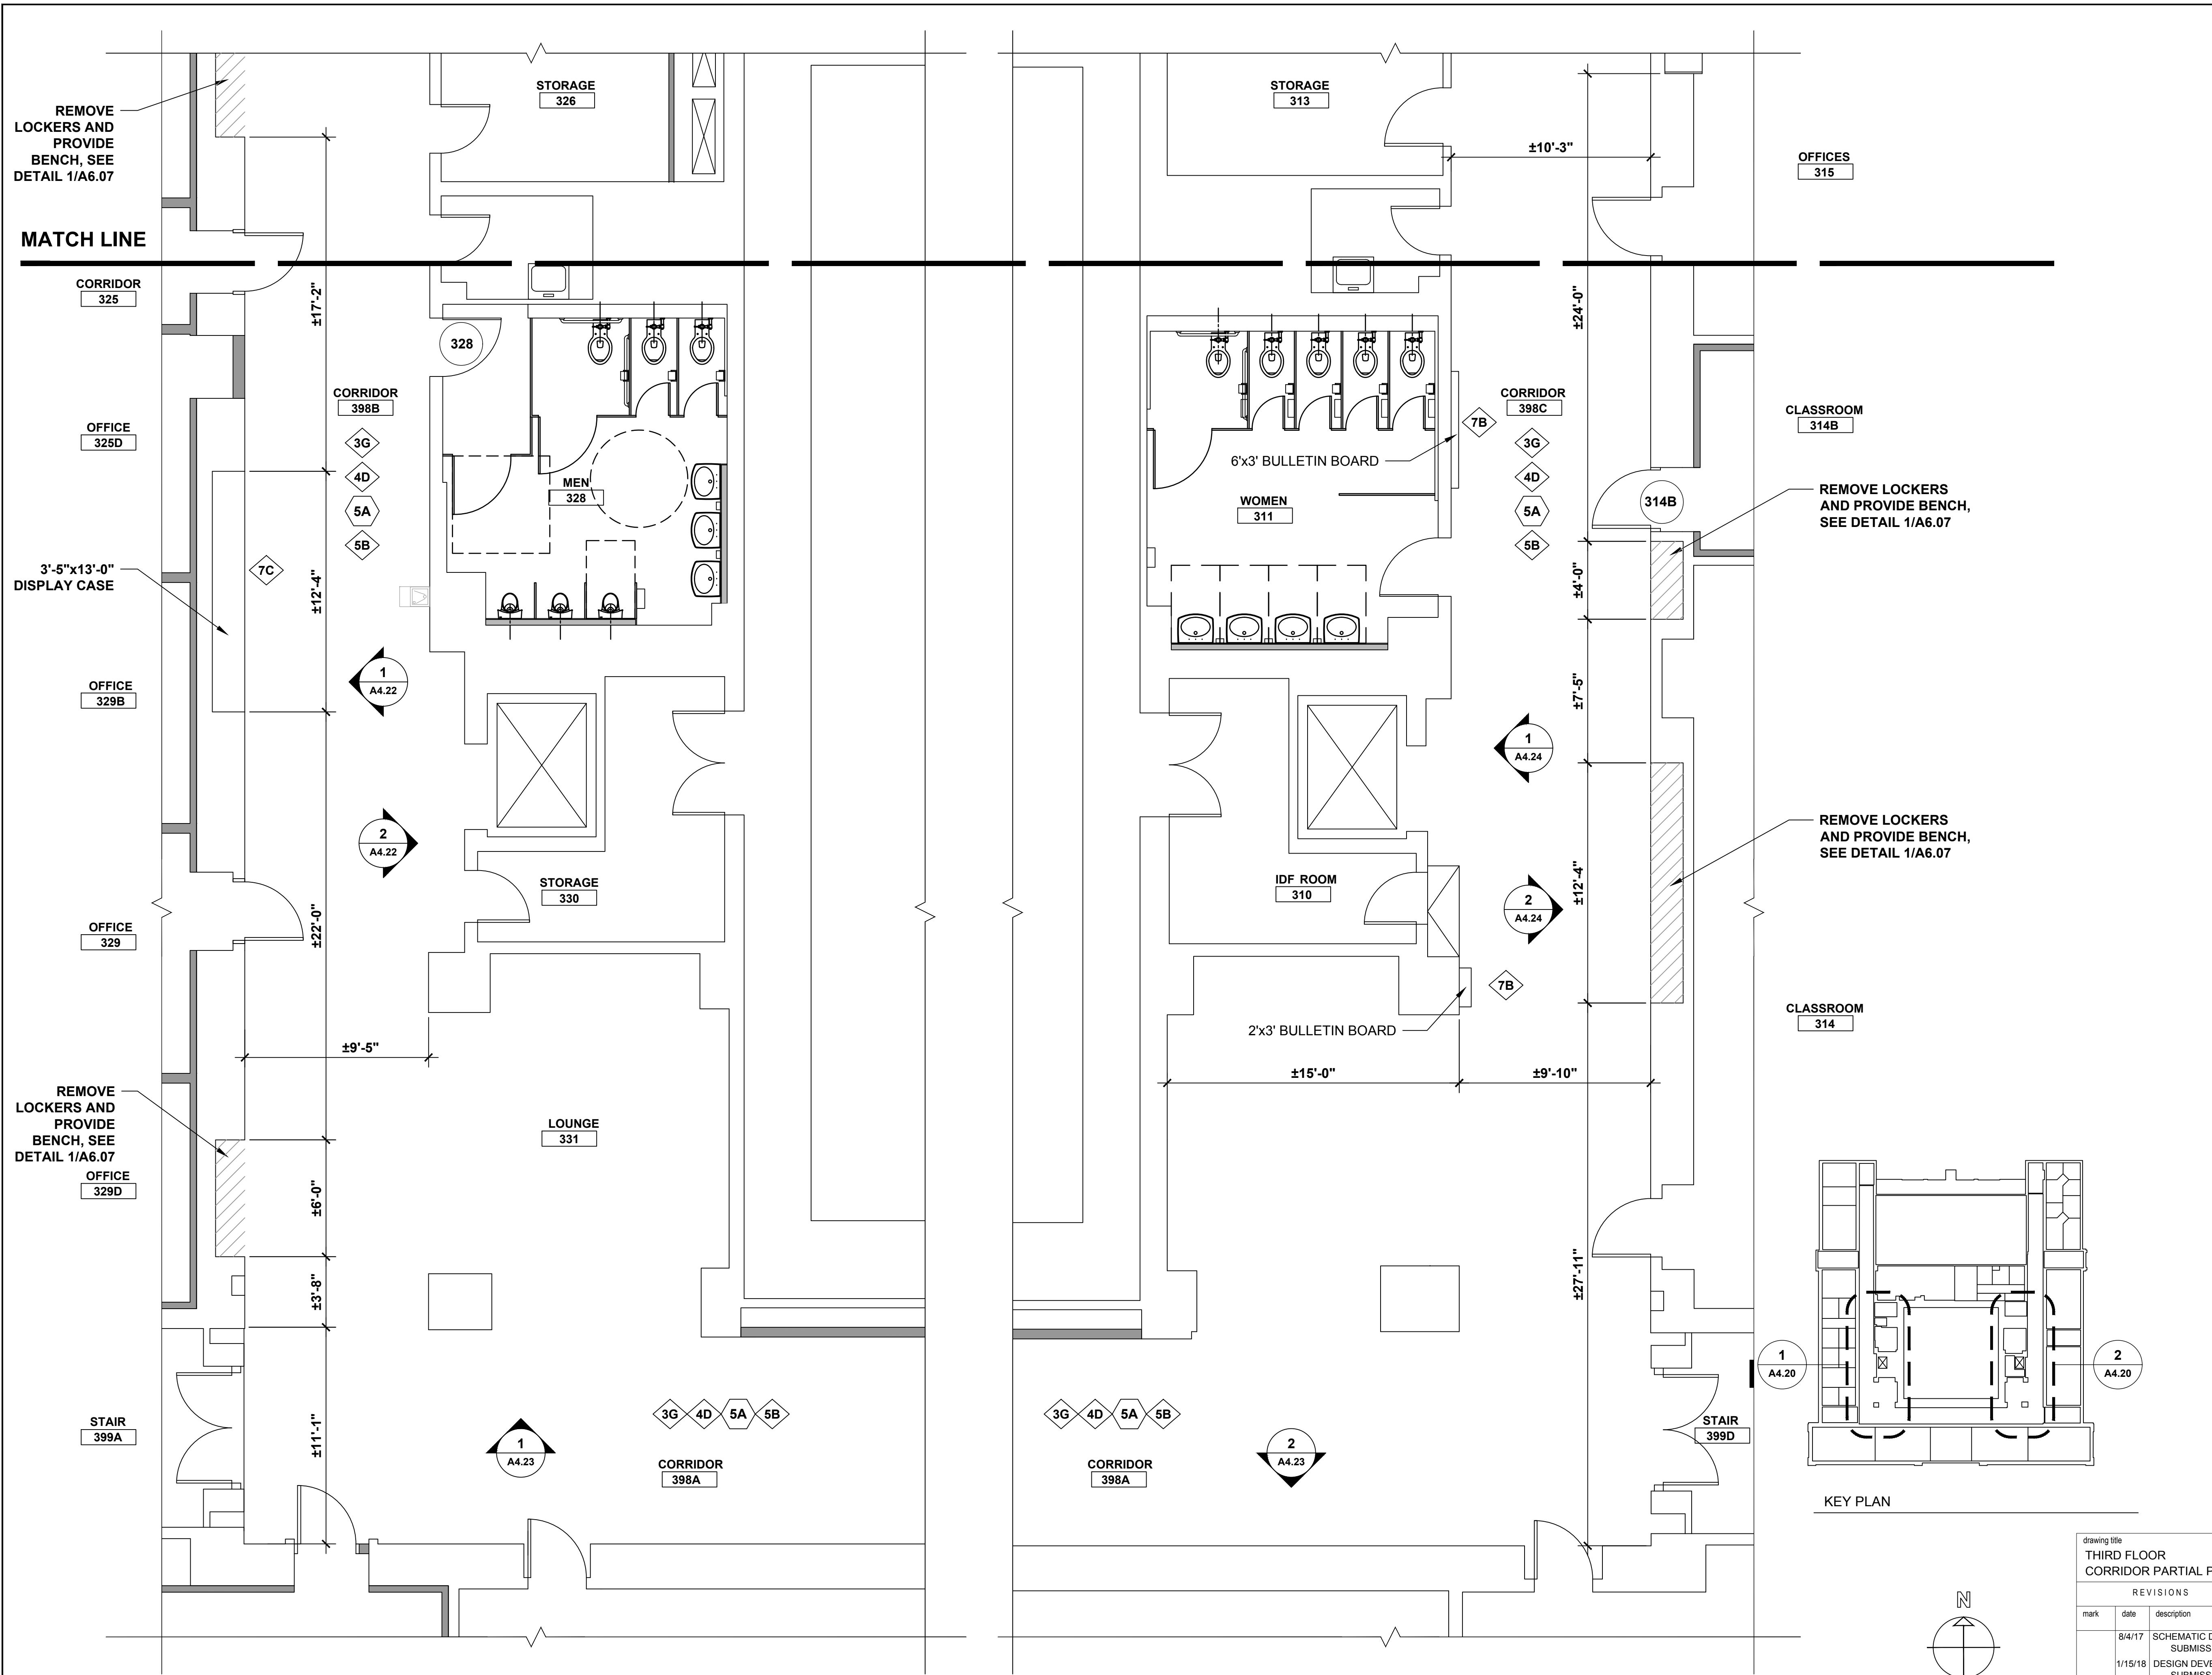


- DEMOLITION KEY NOTES**
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 - 3B REMOVE VCT FLOOR.
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 - 4B REMOVE VINYL BASE
 - 5A REMOVE ACT CEILING.
 - 6A REMOVE LAV.
 - 6B REMOVE TOILET & TOILET PARTITION.
 - 6C REMOVE URINAL AND URINAL SCREEN.

- NEW WORK KEY NOTES**
- 1C PROVIDE MASONRY WALL.
 - 1D PROVIDE 1 HOUR RATED WALL, 3/8" METAL STUDS WITH 5/8" TYPE 'X' GYP. BOARD BOTH SIDES
 - 1E PROVIDE 5/8" MOISTURE RESISTANT GYP BD ON EXISTING STUDS.
 - 1F PROVIDE 3/8" METAL STUDS WITH 5/8" TYPE 'X' GYP. BOARD ONE SIDE
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 - 3E PROVIDE VCT AND RESILIENT BASE.
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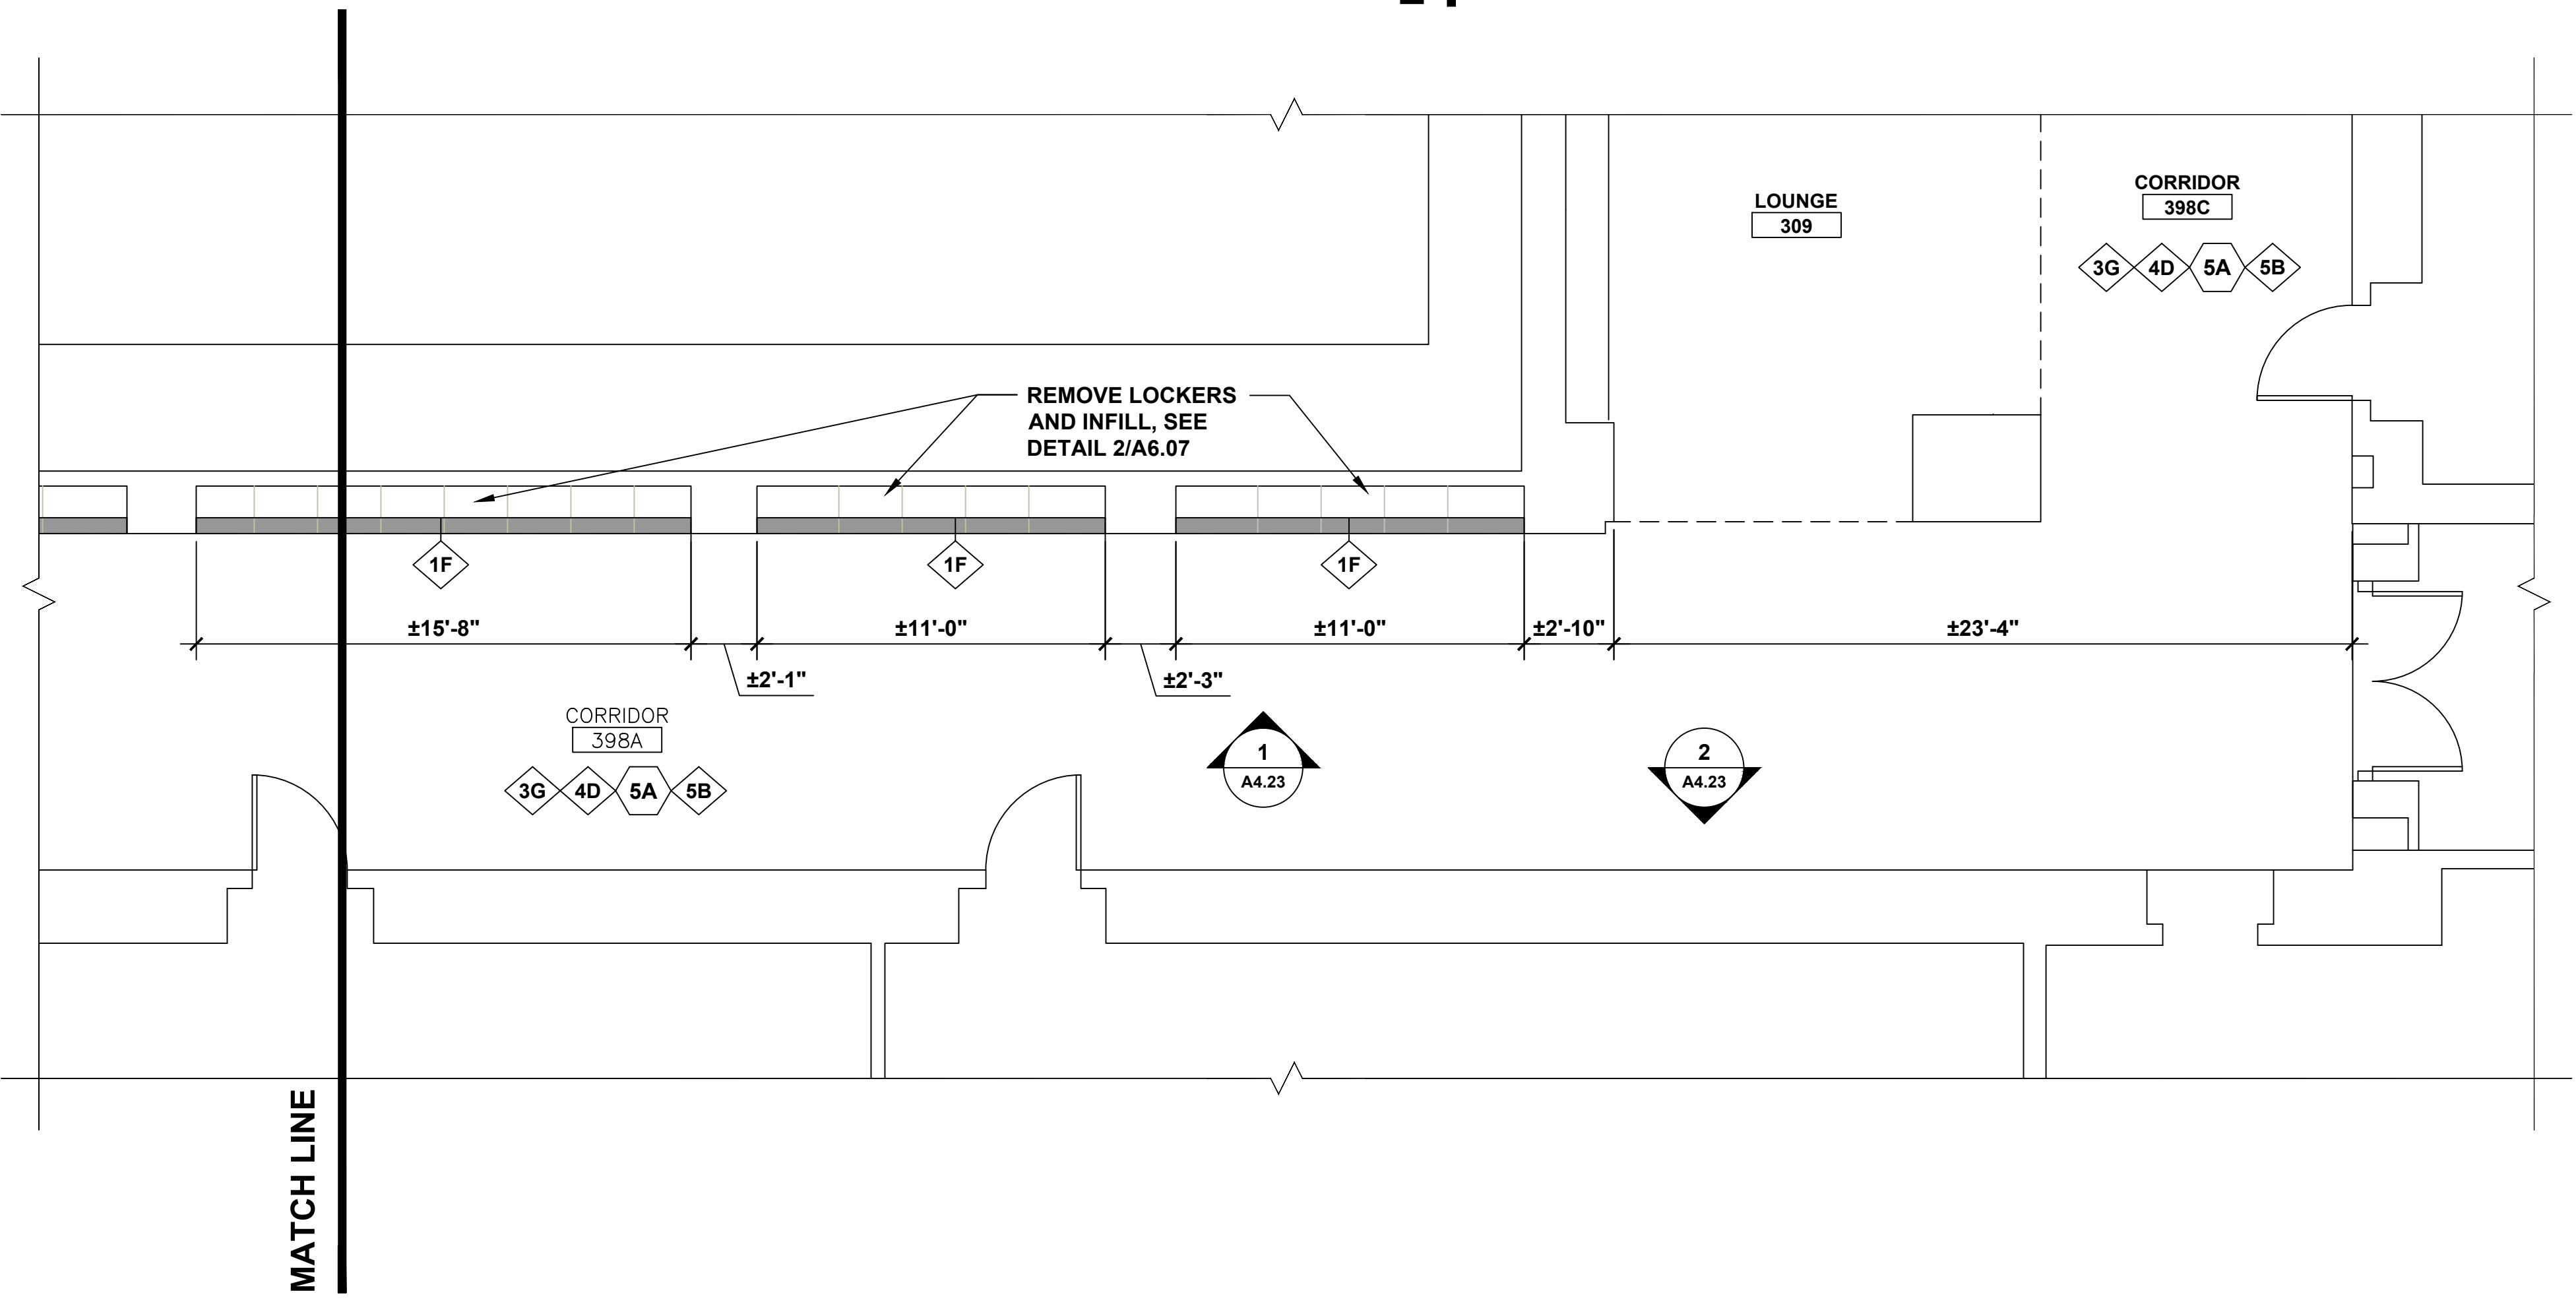
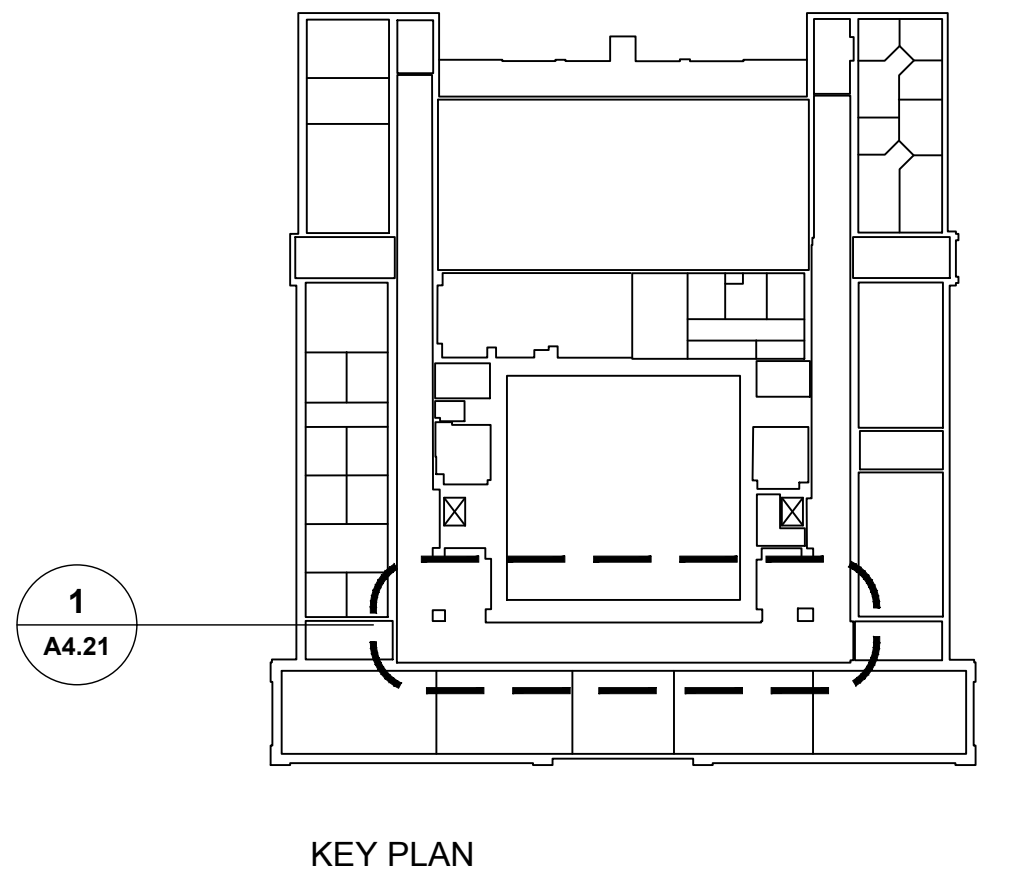
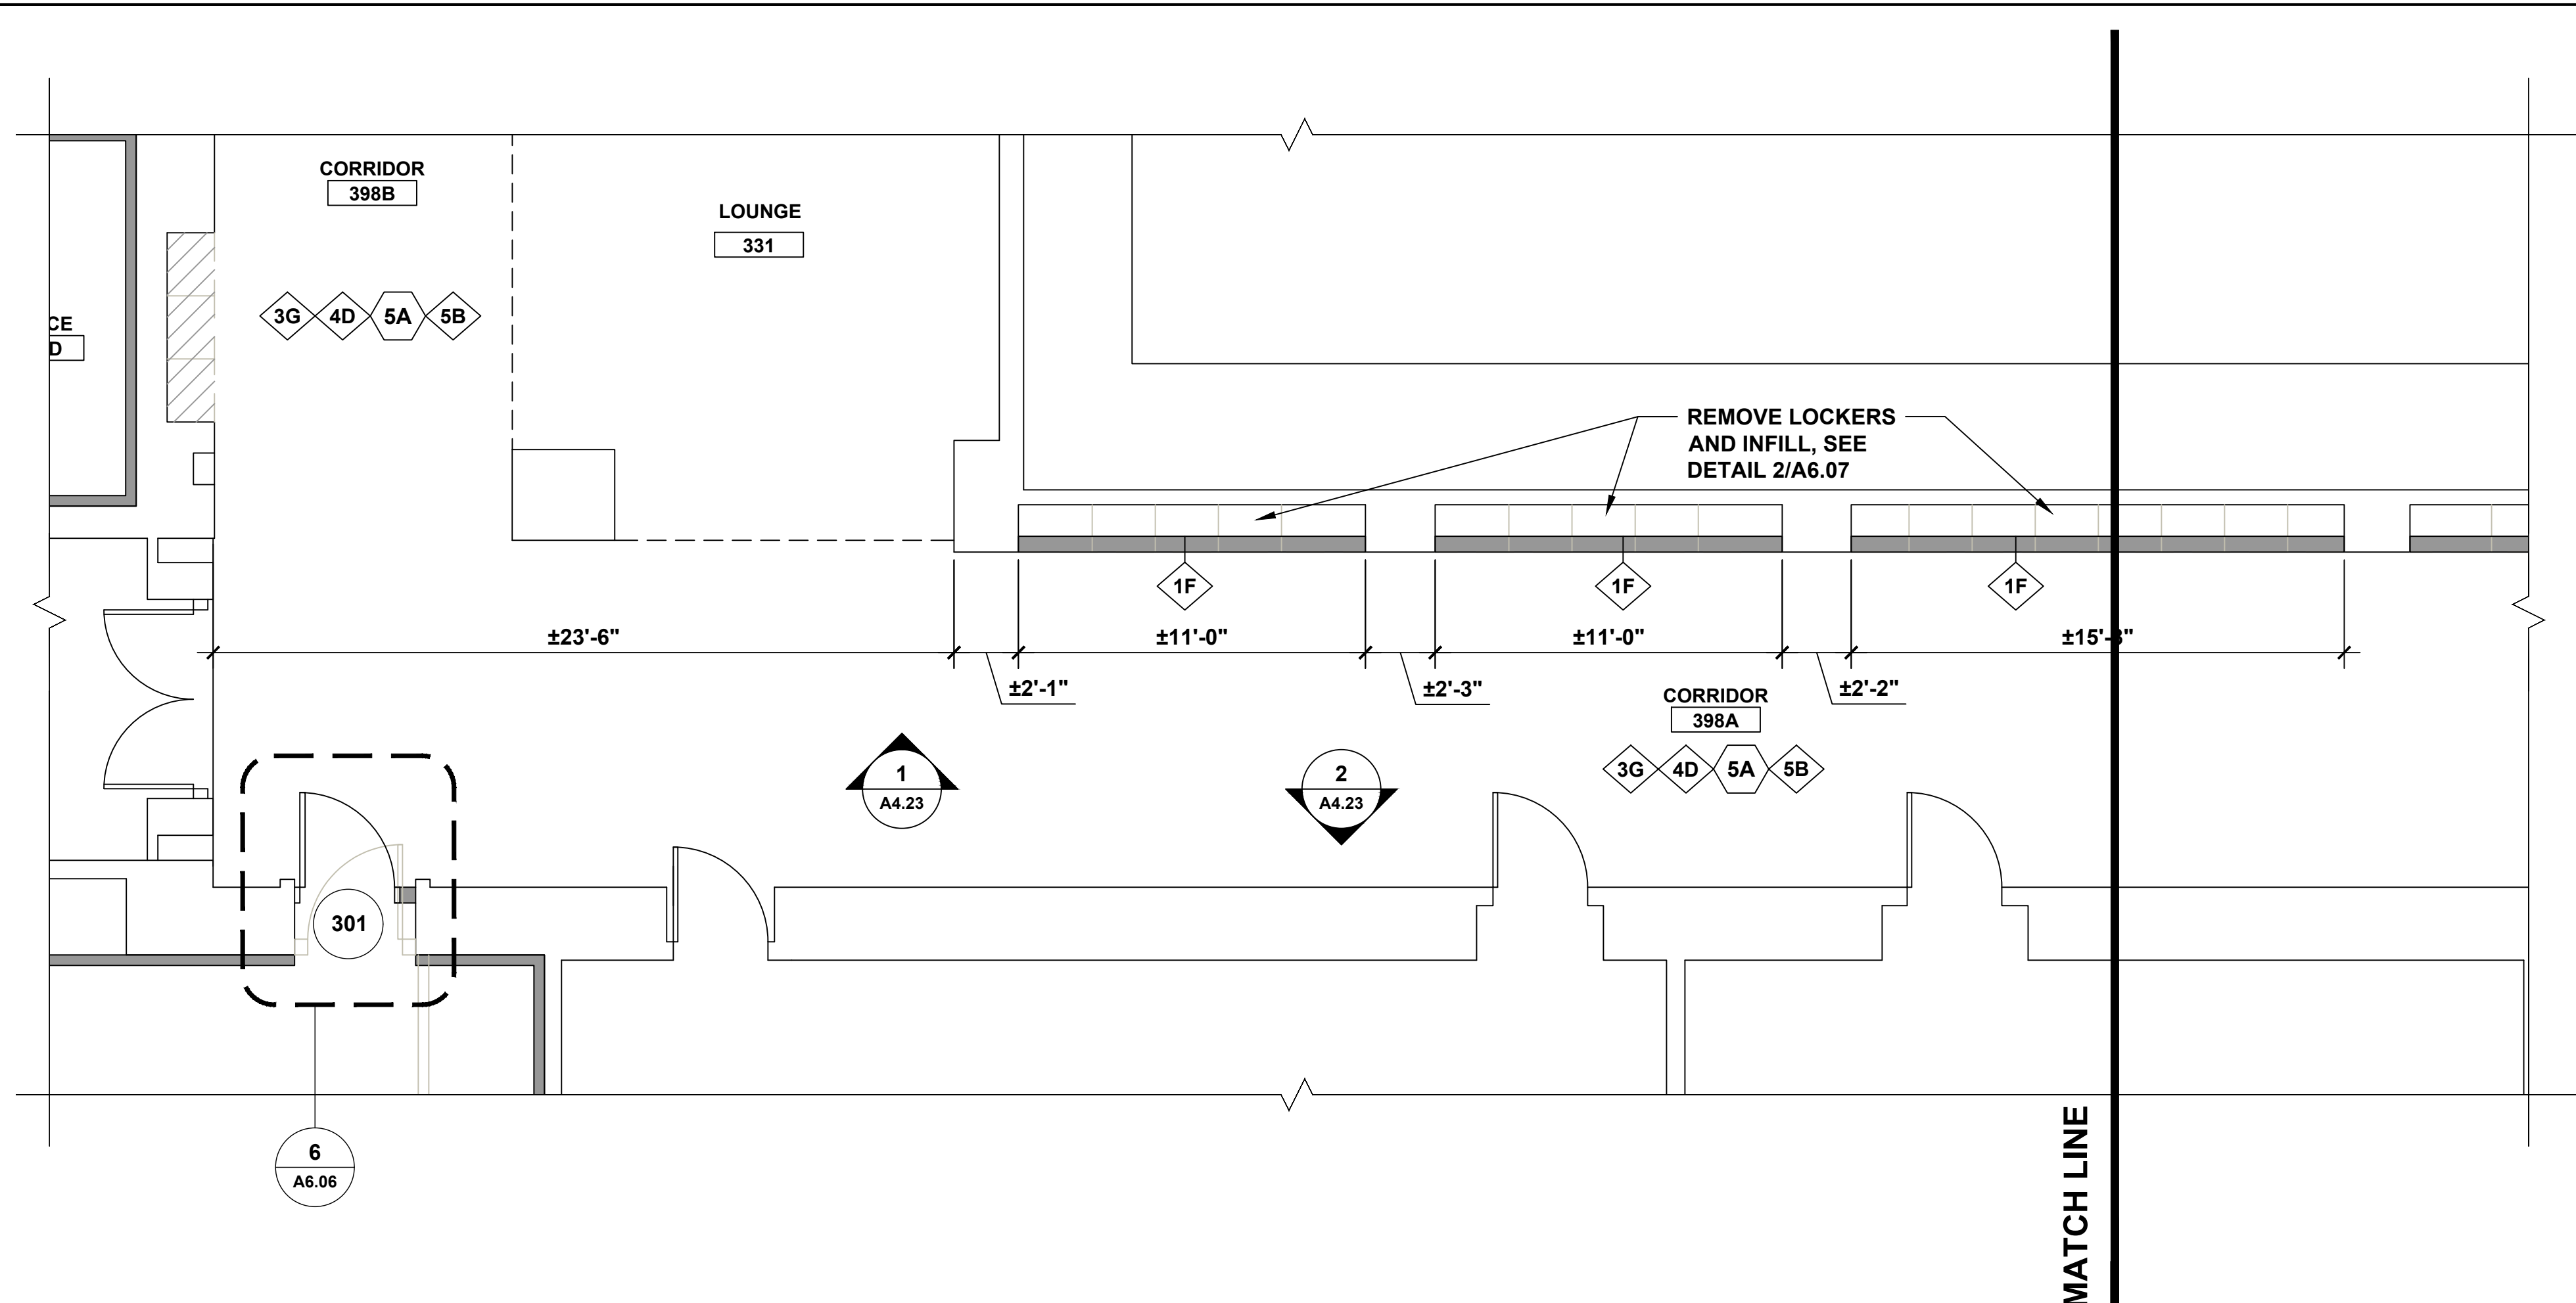
1 SOUTHWEST CORNER PARTIAL PLAN @ CORRIDOR

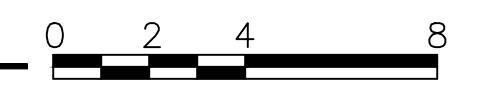

2 SOUTHEAST CORNER PARTIAL PLAN @ CORRIDOR

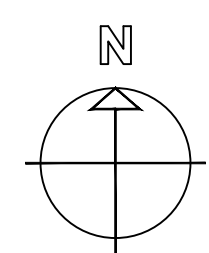



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| drawing title | | THIRD FLOOR CORRIDOR PARTIAL PLANS | | STATE OF CONNECTICUT DEPARTMENT OF ADMINISTRATIVE SERVICES | |
| REVISIONS | | drawing prepared by | | date | |
| mark | date | description | | scale | |
| | 8/4/17 | SCHEMATIC DESIGN SUBMISSION | | AS NOTED | |
| | 1/15/18 | DESIGN DEVELOPMENT SUBMISSION | | | |
| | 4/16/18 | CONSTRUCTION DOCUMENTS | | | |
| | 5/23/18 | | | | |
| | 7/25/18 | | | | |
| project | | WESTERN CT STATE UNIVERSITY WHITE HALL 2ND AND 3RD FLOOR RENOVATIONS DANBURY, CONNECTICUT | | approved by | |
| drawing no. | | A4.20 | | drawing no. | |
| CAD no. | | BI-RD-299 | | drawing no. | |




- DEMOLITION KEY NOTES**
- 1A REMOVE MASONRY WALL.
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 - 2A REMOVE DOOR AND FRAME.
 - 2B REMOVE DOOR. EXISTING FRAME TO REMAIN.
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 - 3B REMOVE VCT FLOOR.
 - 3C REMOVE CARPET.
 - 4A REMOVE C.T. WAINSCOT AND BASE.
 - 4B REMOVE VINYL BASE
 - 5A REMOVE ACT CEILING.
 - 6A REMOVE LAV.
 - 6B REMOVE TOILET & TOILET PARTITION.
 - 6C REMOVE URINAL AND URINAL SCREEN.

- NEW WORK KEY NOTES**
- 1C PROVIDE MASONRY WALL.
 - 1D PROVIDE 1 HOUR RATED WALL, 3/8" METAL STUDS WITH 5/8" TYPE 'X' GYP. BOARD BOTH SIDES
 - 1E PROVIDE 5/8" MOISTURE RESISTANT GYP BD ON EXISTING STUDS.
 - 1F PROVIDE 3 3/8" METAL STUDS WITH 5/8" TYPE 'X' GYP. BOARD ONE SIDE
 - 1G PROVIDE 3 3/8" METAL STUDS WITH 5/8" TYPE 'X' GYP. BOARD BOTH SIDES
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 - 3D PROVIDE CT FLOOR AND CT BASE.
 - 3E PROVIDE VCT AND RESILIENT BASE.
 - 3F PROVIDE CARPET AND RESILIENT BASE.
 - 3G EXISTING FLOORING TO REMAIN. (PROTECT DURING RENOVATION)
 - 4C PROVIDE CT WAINSCOT AND BASE/ PAINT ABOVE
 - 4D PREP AND PAINT WALLS
 - 4E PROVIDE HORIZONTAL WINDOW BLINDS
 - 5B PROVIDE ACT CEILING.
 - 5C REMOVE & REINSTALL ACT CEILING AFTER MEP WORK IS COMPLETED.
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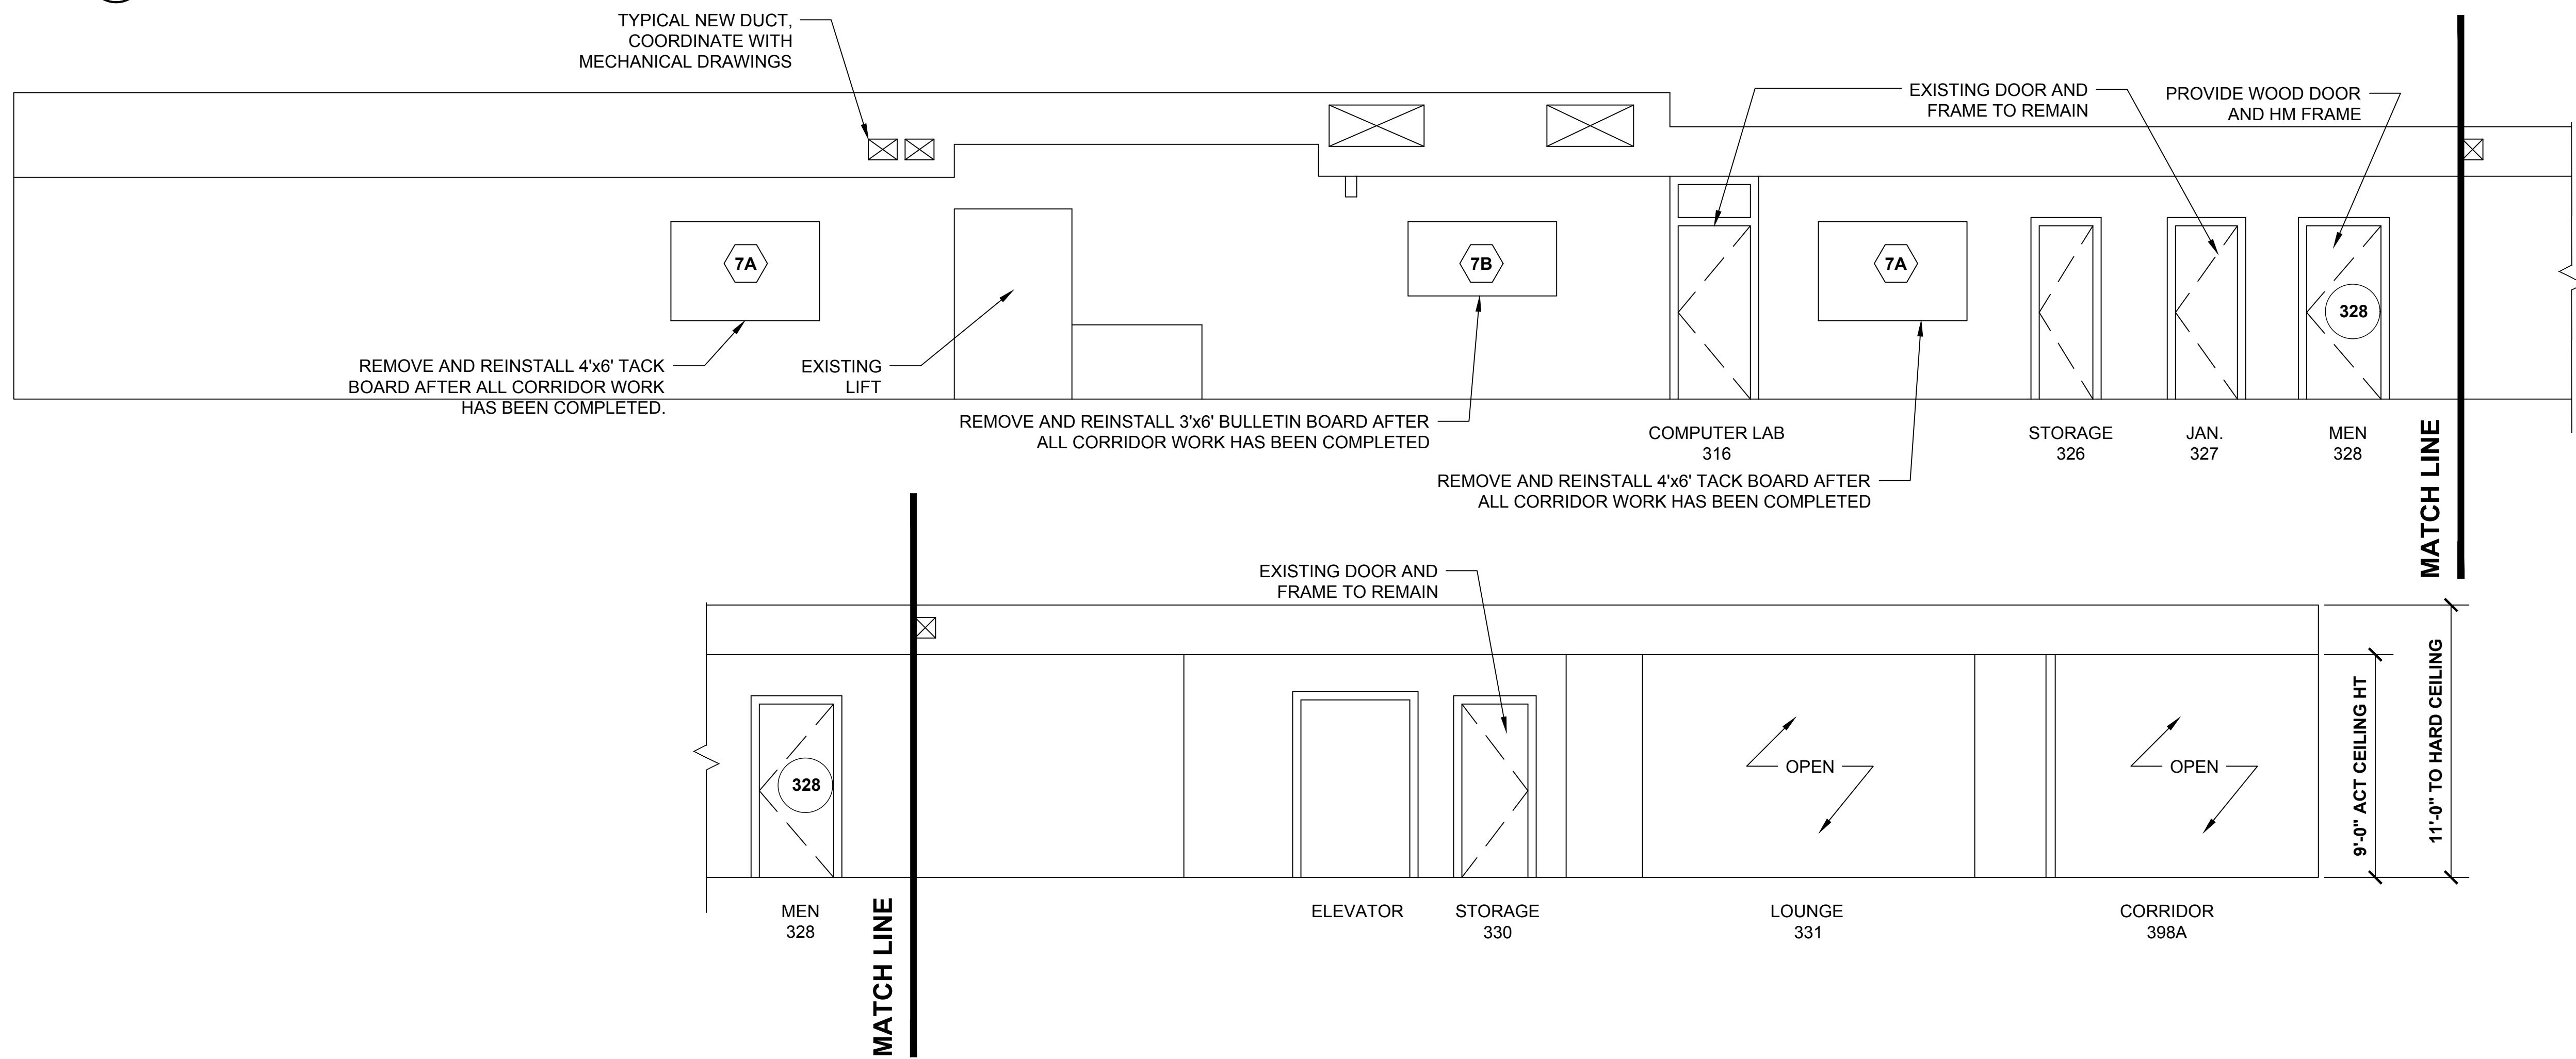
1 SOUTH WING PARTIAL PLAN AT CORRIDOR

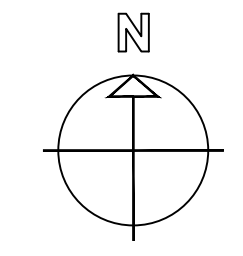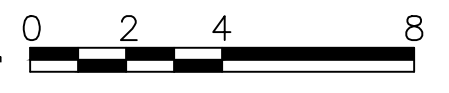


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| drawing title THIRD FLOOR CORRIDOR PARTIAL PLANS | | | STATE OF CONNECTICUT DEPARTMENT OF ADMINISTRATIVE SERVICES | |
| REVISIONS | | | drawing prepared by AMES & WHITAKER ARCHITECTS 31 LIBERTY STREET SOUTHINGTON, CT | |
| mark | date | description | date | scale |
| | 8/4/17 | SCHEMATIC DESIGN SUBMISSION | 07/25/18 | AS NOTED |
| | 1/15/18 | DESIGN DEVELOPMENT SUBMISSION | | |
| | 4/16/18 | CONSTRUCTION DOCUMENTS | | |
| | 5/23/18 | | | |
| | 7/25/18 | | | |
| project WESTERN CT STATE UNIVERSITY WHITE HALL 2ND AND 3RD FLOOR RENOVATIONS DANBURY, CONNECTICUT | | | drawn by SP/ICA | approved by AL |
| drawing no. A4.21 | | | drawing no. | |
| CAD no. | | | project no. BI-RD-299 | |

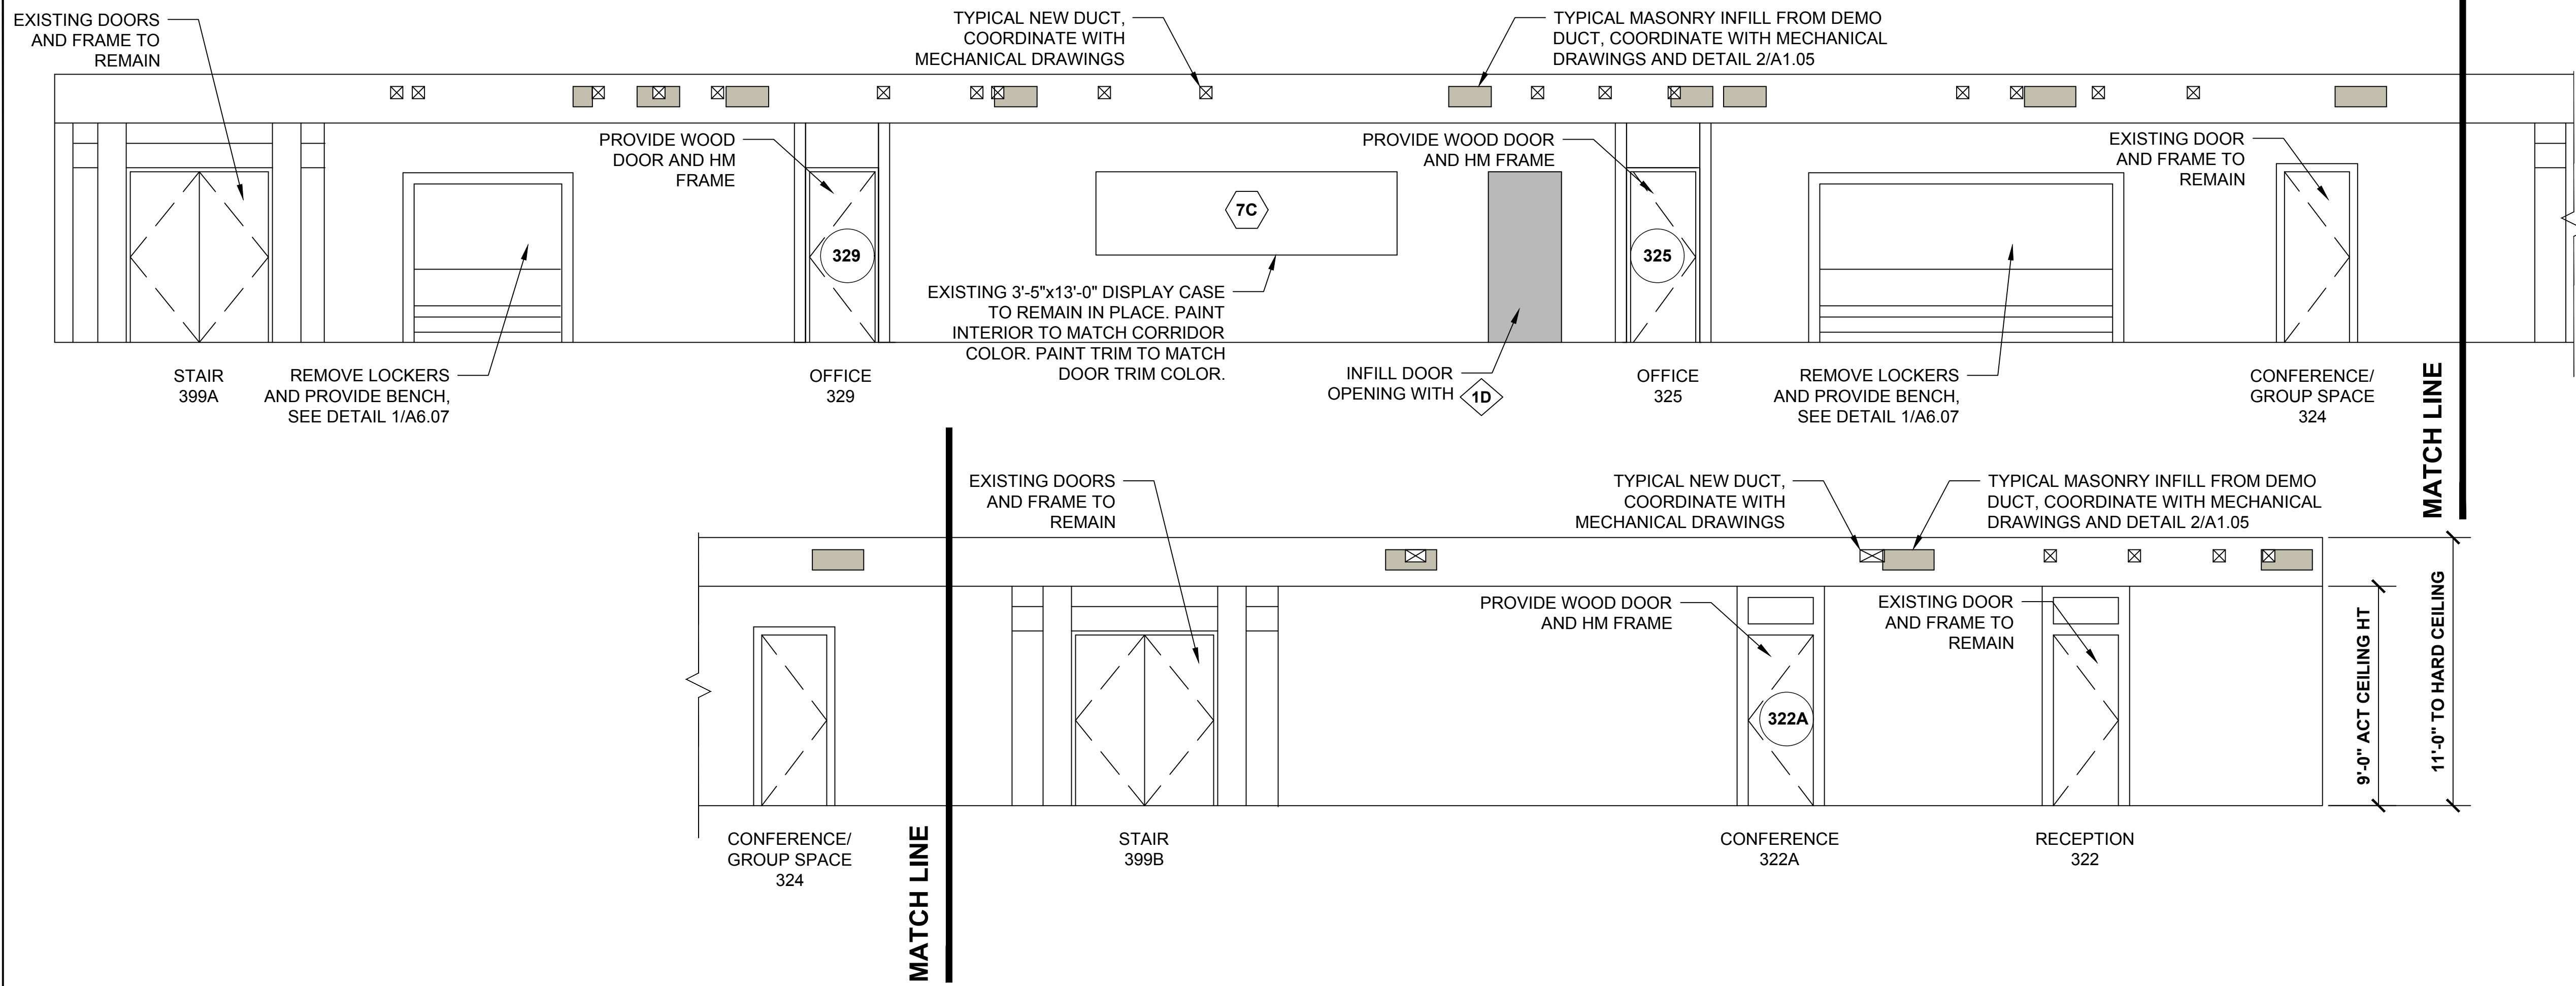

1 CORRIDOR INTERIOR ELEVATION




2 CORRIDOR INTERIOR ELEVATION


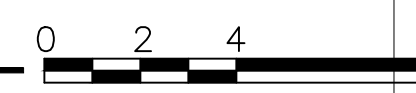


- TYPICAL CORRIDOR NOTES:**
- EXISTING FLOORING TO REMAIN. (PROTECT DURING RENOVATION)
 - PREP AND PAINT WALLS.
 - PROVIDE ACT CEILING.


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| drawing title THIRD FLOOR - INTERIOR ELEVATIONS AT CORRIDOR | | | STATE OF CONNECTICUT DEPARTMENT OF ADMINISTRATIVE SERVICES | | |
| REVISIONS | | | drawing prepared by AMES & WHITAKER ARCHITECTS 31 LIBERTY STREET SOUTHINGTON, CT | | |
| mark | date | description | date | scale | AS NOTED |
| | 8/4/17 | SCHEMATIC DESIGN SUBMISSION | 07/25/18 | | |
| | 1/15/18 | DESIGN DEVELOPMENT SUBMISSION | | | |
| | 4/16/18 | CONSTRUCTION DOCUMENTS | | | |
| | 5/23/18 | | | | |
| | 7/25/18 | | | | |
| project WESTERN CT STATE UNIVERSITY WHITE HALL 2ND AND 3RD FLOOR RENOVATIONS DANBURY, CONNECTICUT | | | drawn by SP/ICA approved by AL drawing no. A4.22 | | |
| CAD no. | | project no. BI-RD-299 | | | |

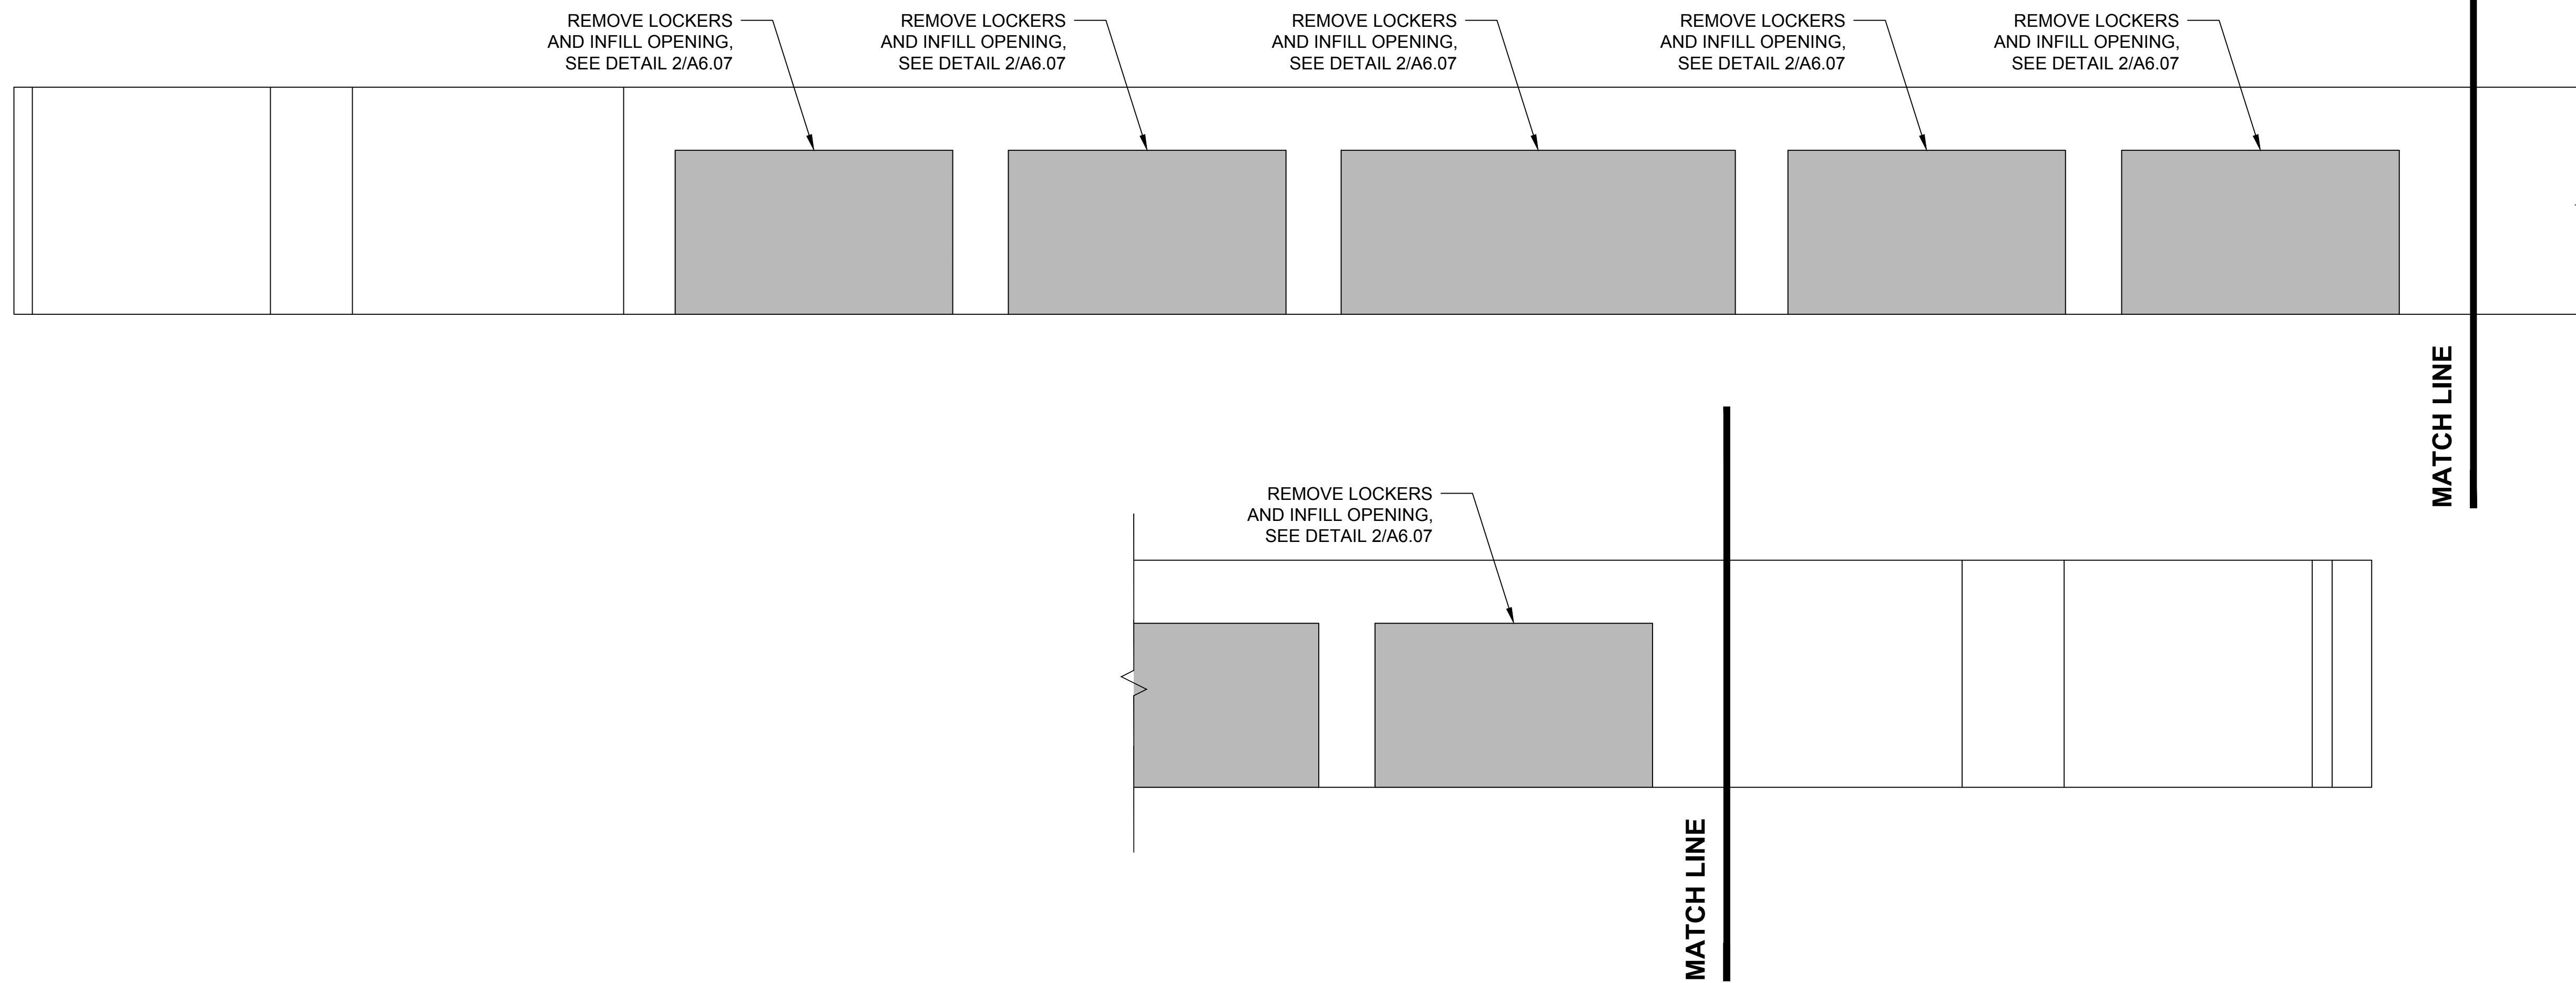

1 CORRIDOR INTERIOR ELEVATION

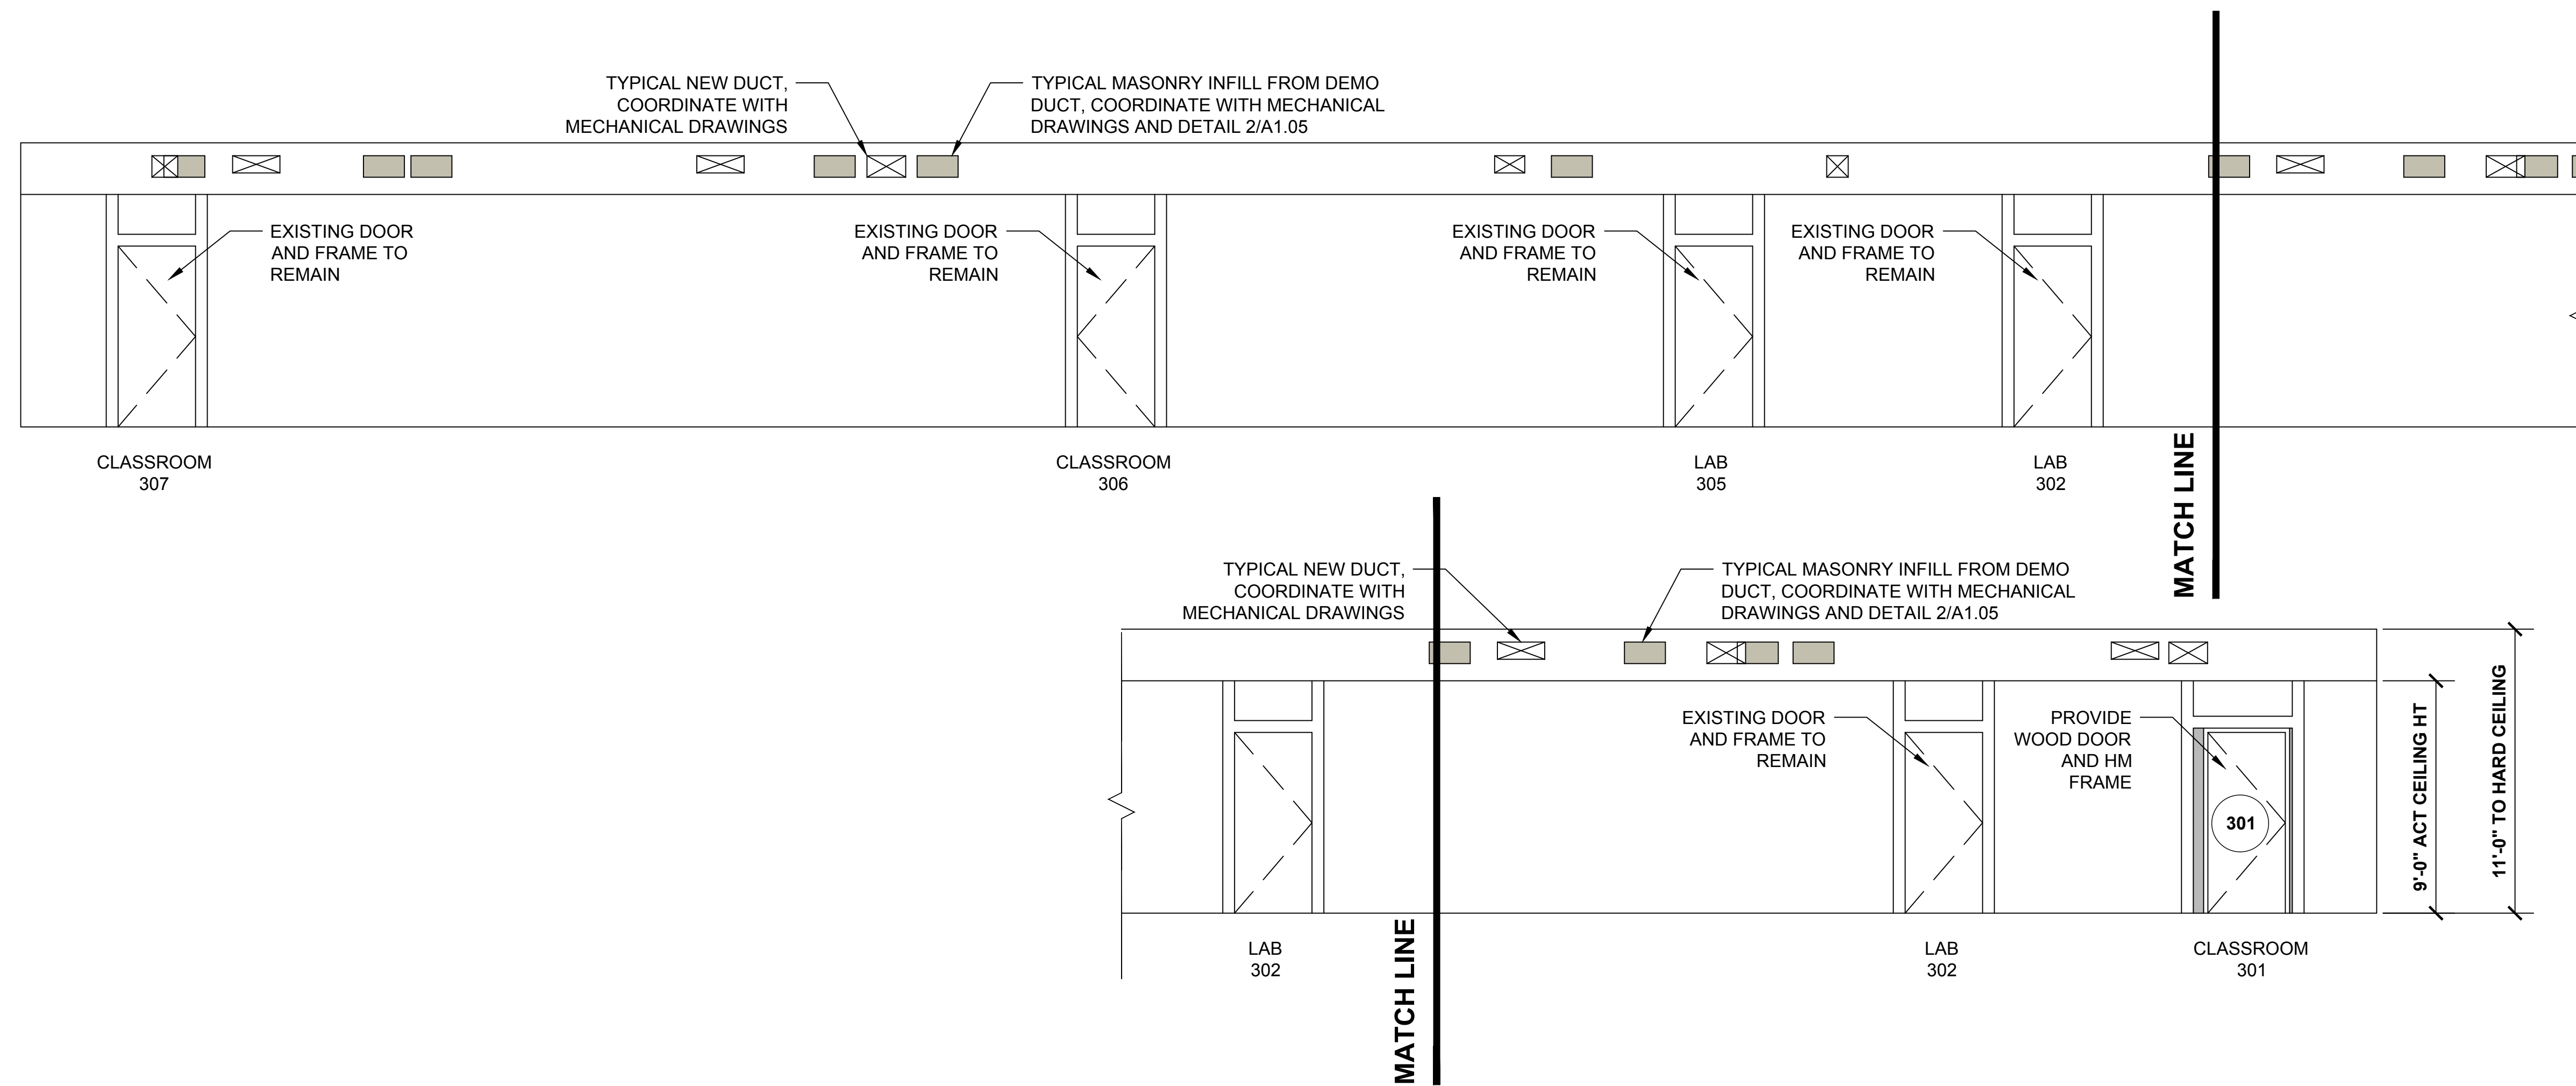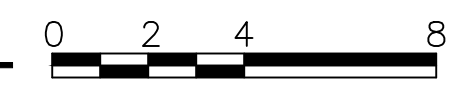


2 CORRIDOR INTERIOR ELEVATION

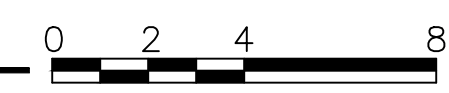


- TYPICAL CORRIDOR NOTES:**
1. EXISTING FLOORING TO REMAIN. (PROTECT DURING RENOVATION)
 2. PREP AND PAINT WALLS.
 3. PROVIDE ACT CEILING.

| | | | | | |
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| drawing title THIRD FLOOR - INTERIOR ELEVATIONS AT CORRIDOR | | | STATE OF CONNECTICUT DEPARTMENT OF ADMINISTRATIVE SERVICES | | |
| REVISIONS | | | drawing prepared by AMES & WHITAKER ARCHITECTS 31 LIBERTY STREET SOUTHINGTON, CT | | |
| mark | date | description | date | scale | AS NOTED |
| | 8/4/17 | SCHEMATIC DESIGN SUBMISSION | 07/25/18 | | |
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| | 4/16/18 | CONSTRUCTION DOCUMENTS | | | |
| | 5/23/18 | | | | |
| | 7/25/18 | | | | |
| project WESTERN CT STATE UNIVERSITY WHITE HALL 2ND AND 3RD FLOOR RENOVATIONS DANBURY, CONNECTICUT | | | drawn by SP/CA | approved by AL | drawing no. A4.23 |
| CAD no. | | | project no. BI-RD-299 | | |

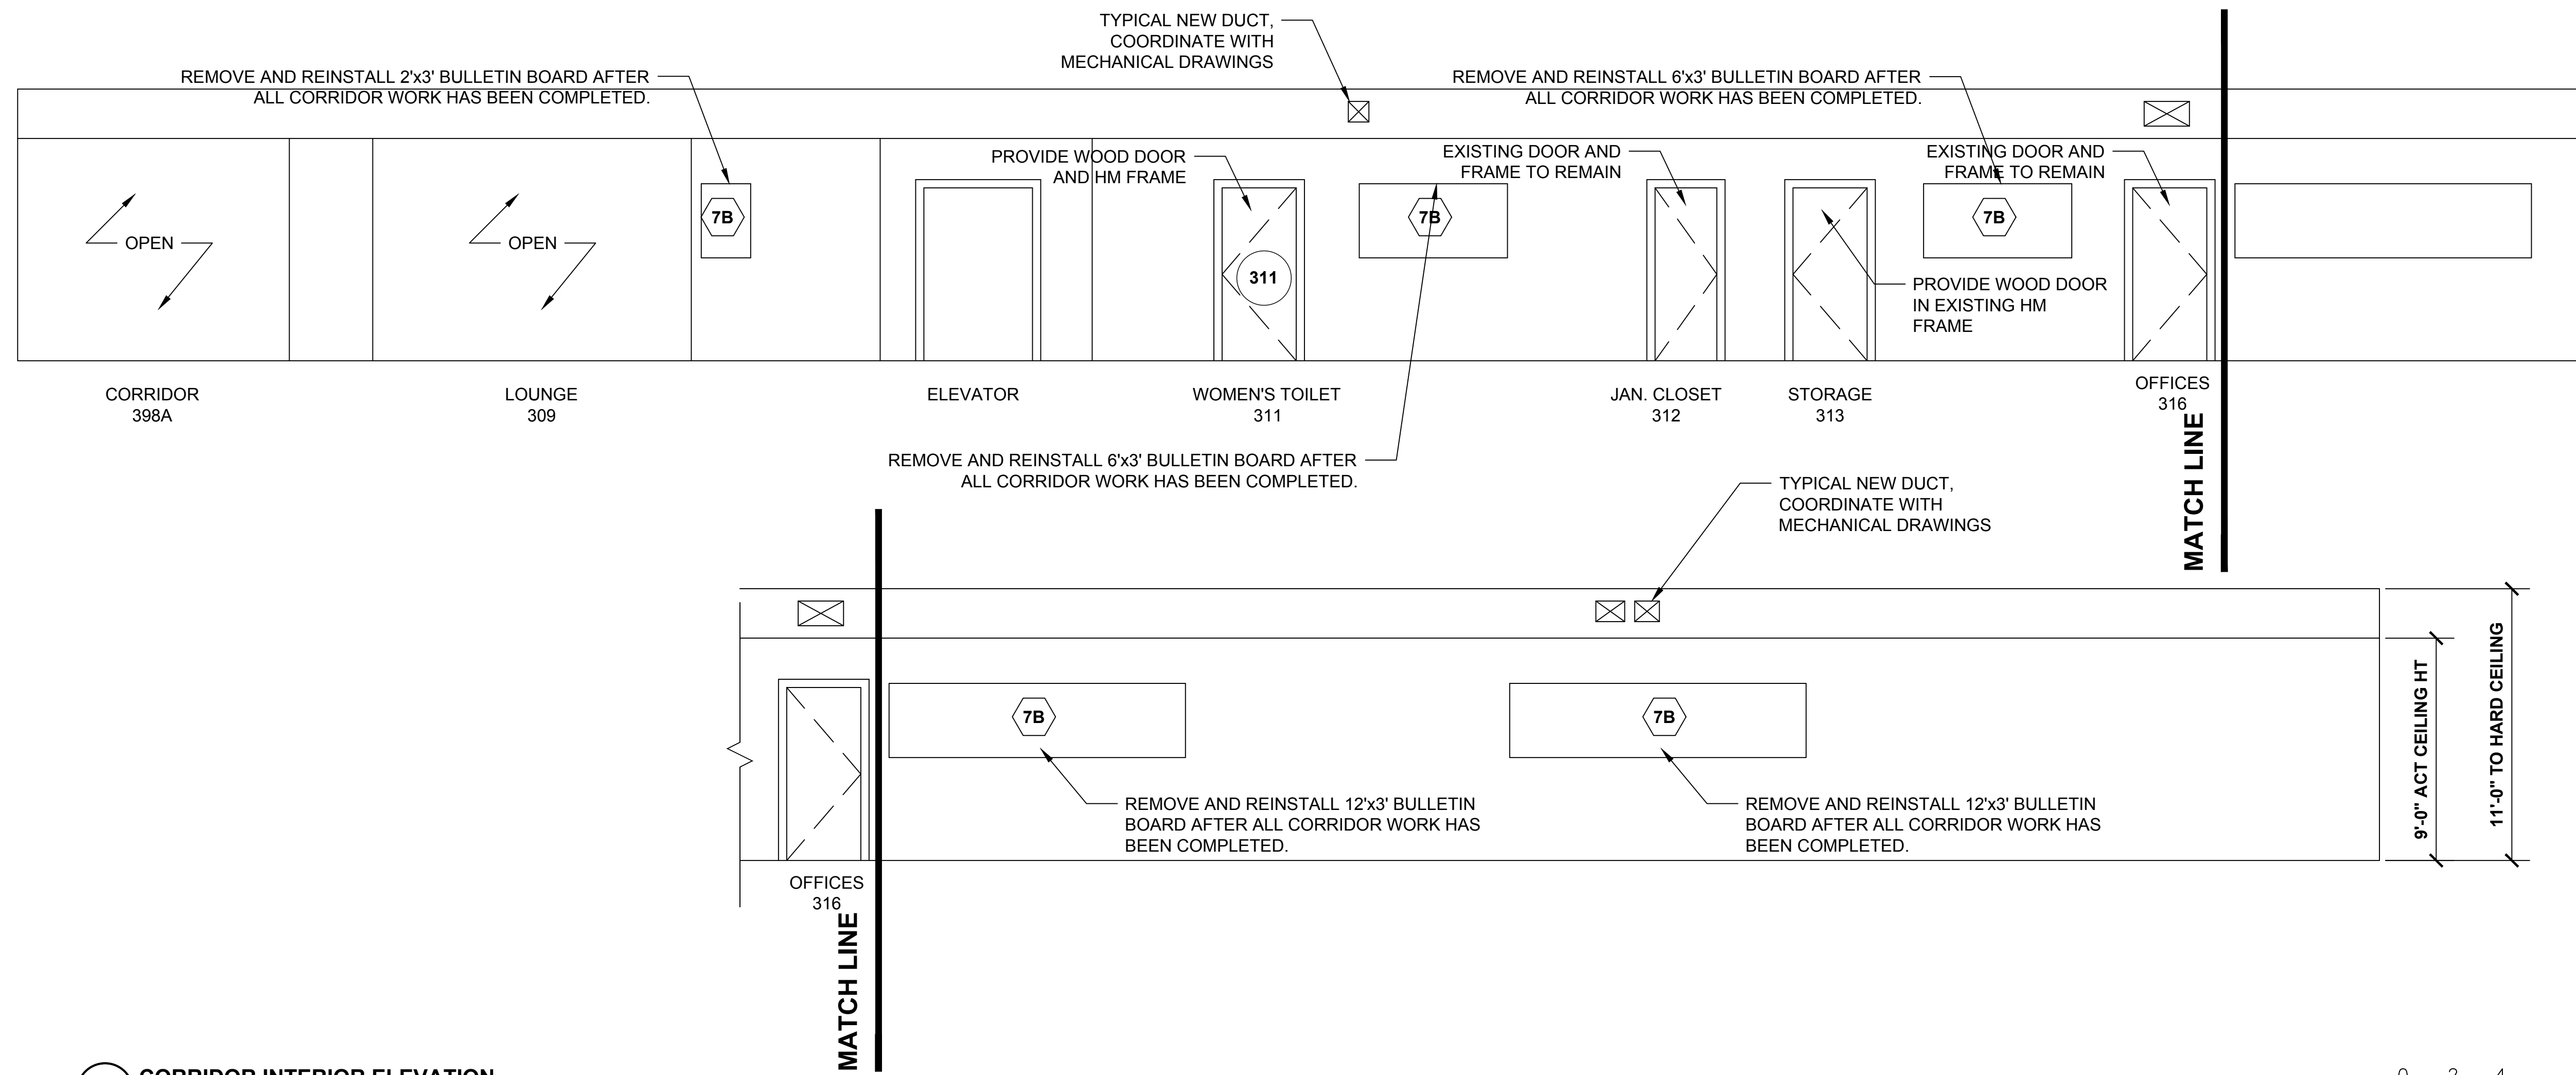


1 CORRIDOR INTERIOR ELEVATION

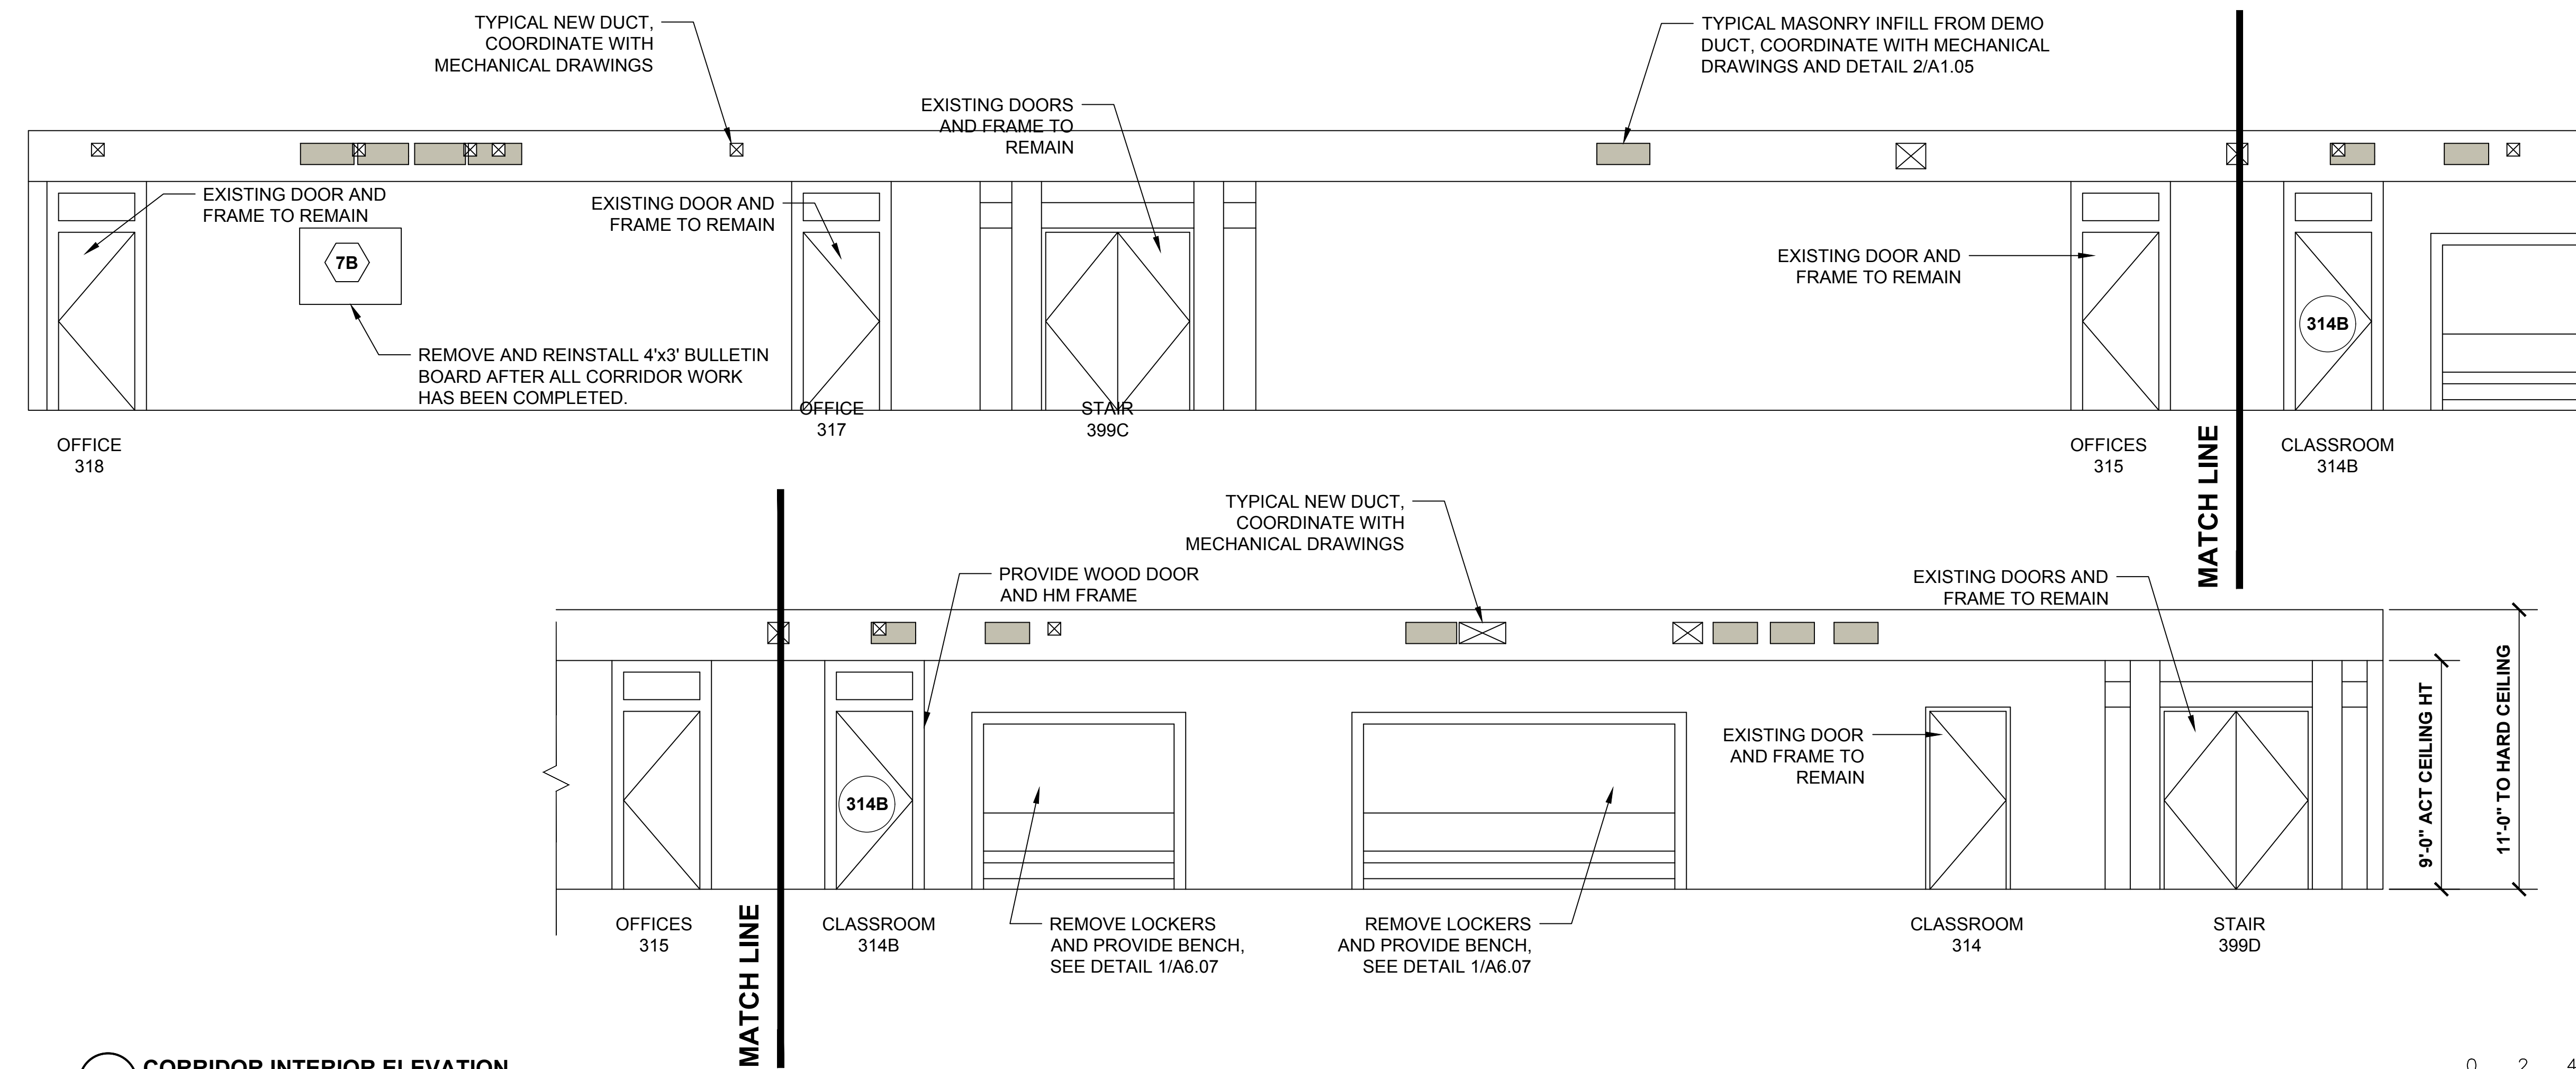


2 CORRIDOR INTERIOR ELEVATION

- TYPICAL CORRIDOR NOTES:**
1. EXISTING FLOORING TO REMAIN. (PROTECT DURING RENOVATION)
 2. PREP AND PAINT WALLS.
 3. PROVIDE ACT CEILING.


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|---|---------|-------------------------------|--|-------|----------|
| drawing title THIRD FLOOR - INTERIOR ELEVATIONS AT CORRIDOR | | | STATE OF CONNECTICUT DEPARTMENT OF ADMINISTRATIVE SERVICES | | |
| REVISIONS | | | drawing prepared by AMES & WHITAKER ARCHITECTS 31 LIBERTY STREET SOUTHINGTON, CT | | |
| mark | date | description | date | scale | AS NOTED |
| | 8/4/17 | SCHEMATIC DESIGN SUBMISSION | 07/25/18 | | |
| | 1/15/18 | DESIGN DEVELOPMENT SUBMISSION | | | |
| | 4/16/18 | CONSTRUCTION DOCUMENTS | | | |
| | 5/23/18 | | | | |
| | 7/25/18 | | | | |
| project WESTERN CT STATE UNIVERSITY WHITE HALL 2ND AND 3RD FLOOR RENOVATIONS DANBURY, CONNECTICUT | | | drawn by SP/CA approved by AL drawing no. A4.24 | | |
| CAD no. | | | project no. BI-RD-299 | | |

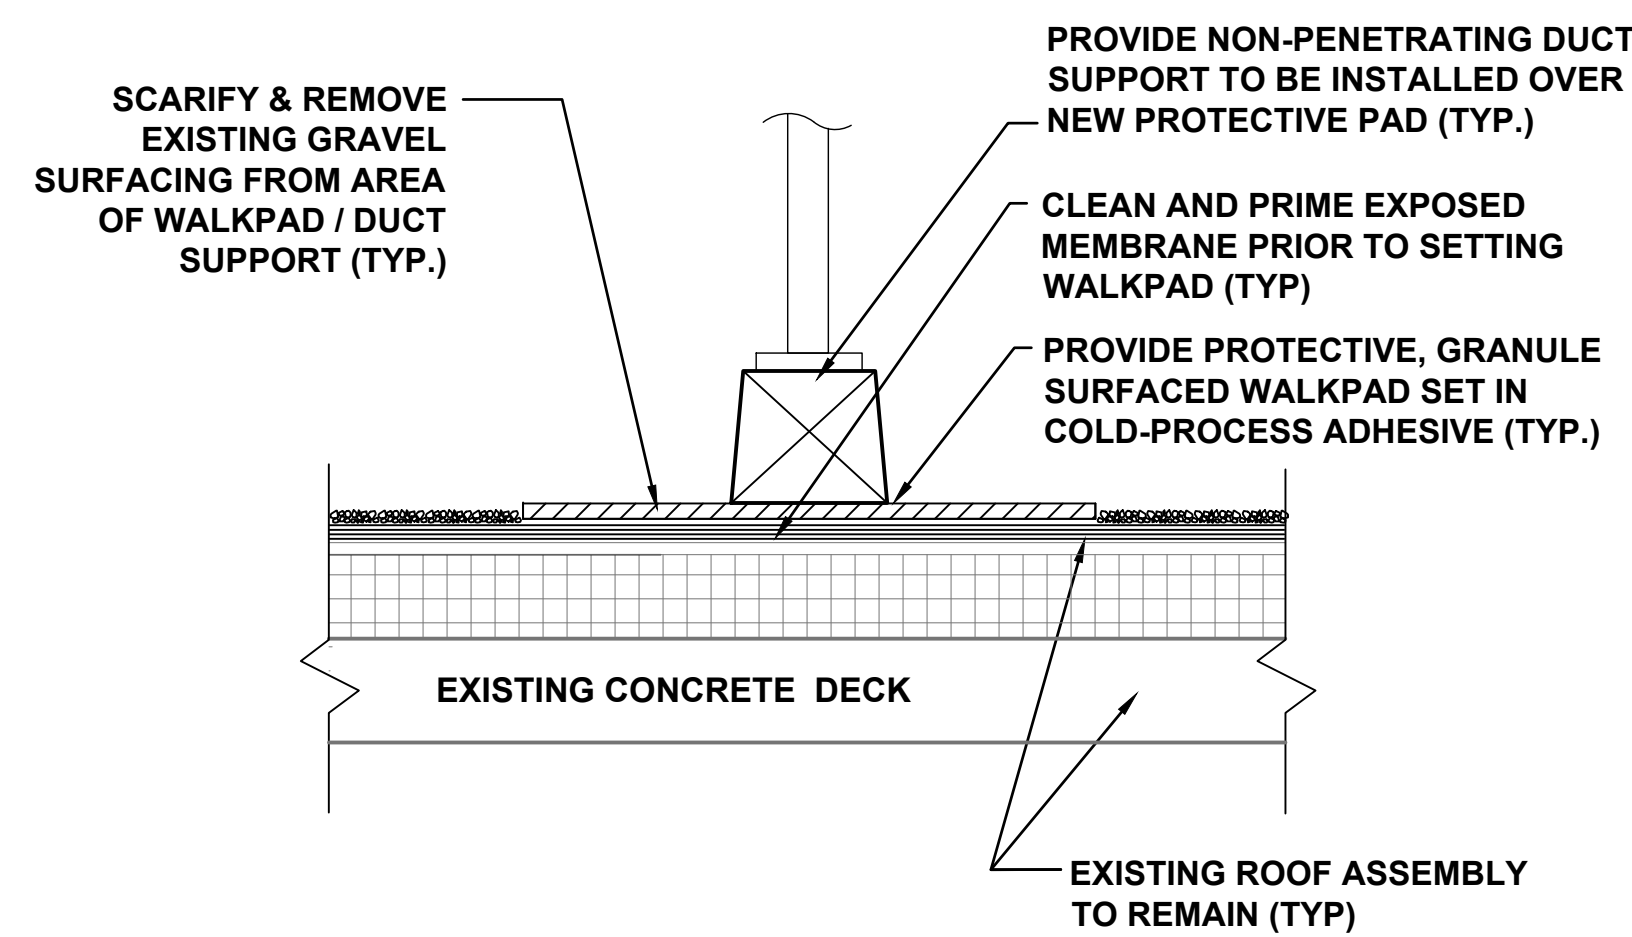


1 NON-PENETRATING EQUIP. SUPPORT DETAIL
N.T.S.

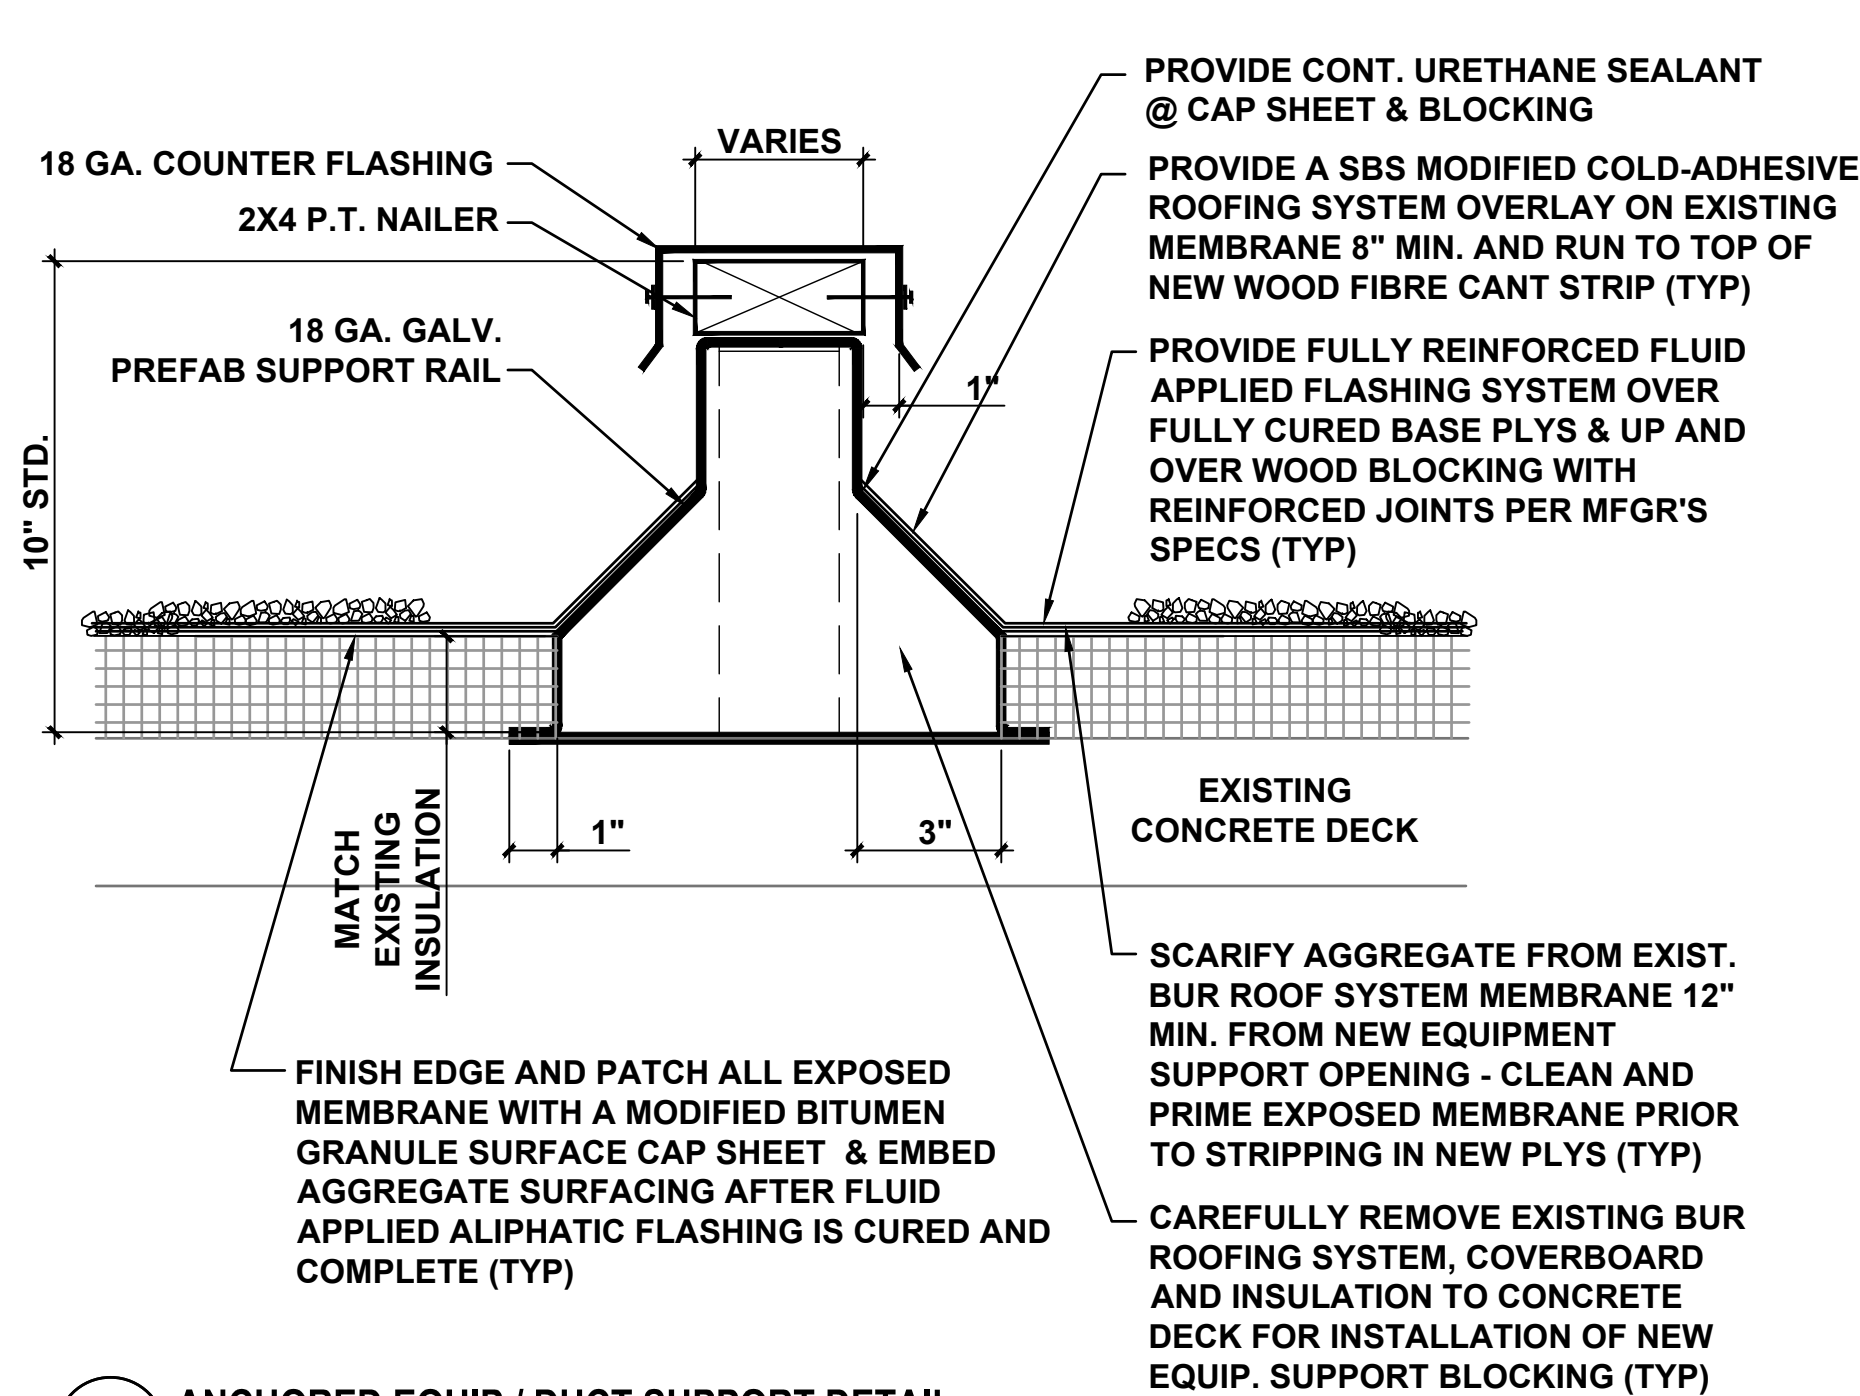


2 ANCHORED EQUIP./DUCT SUPPORT DETAIL
N.T.S.

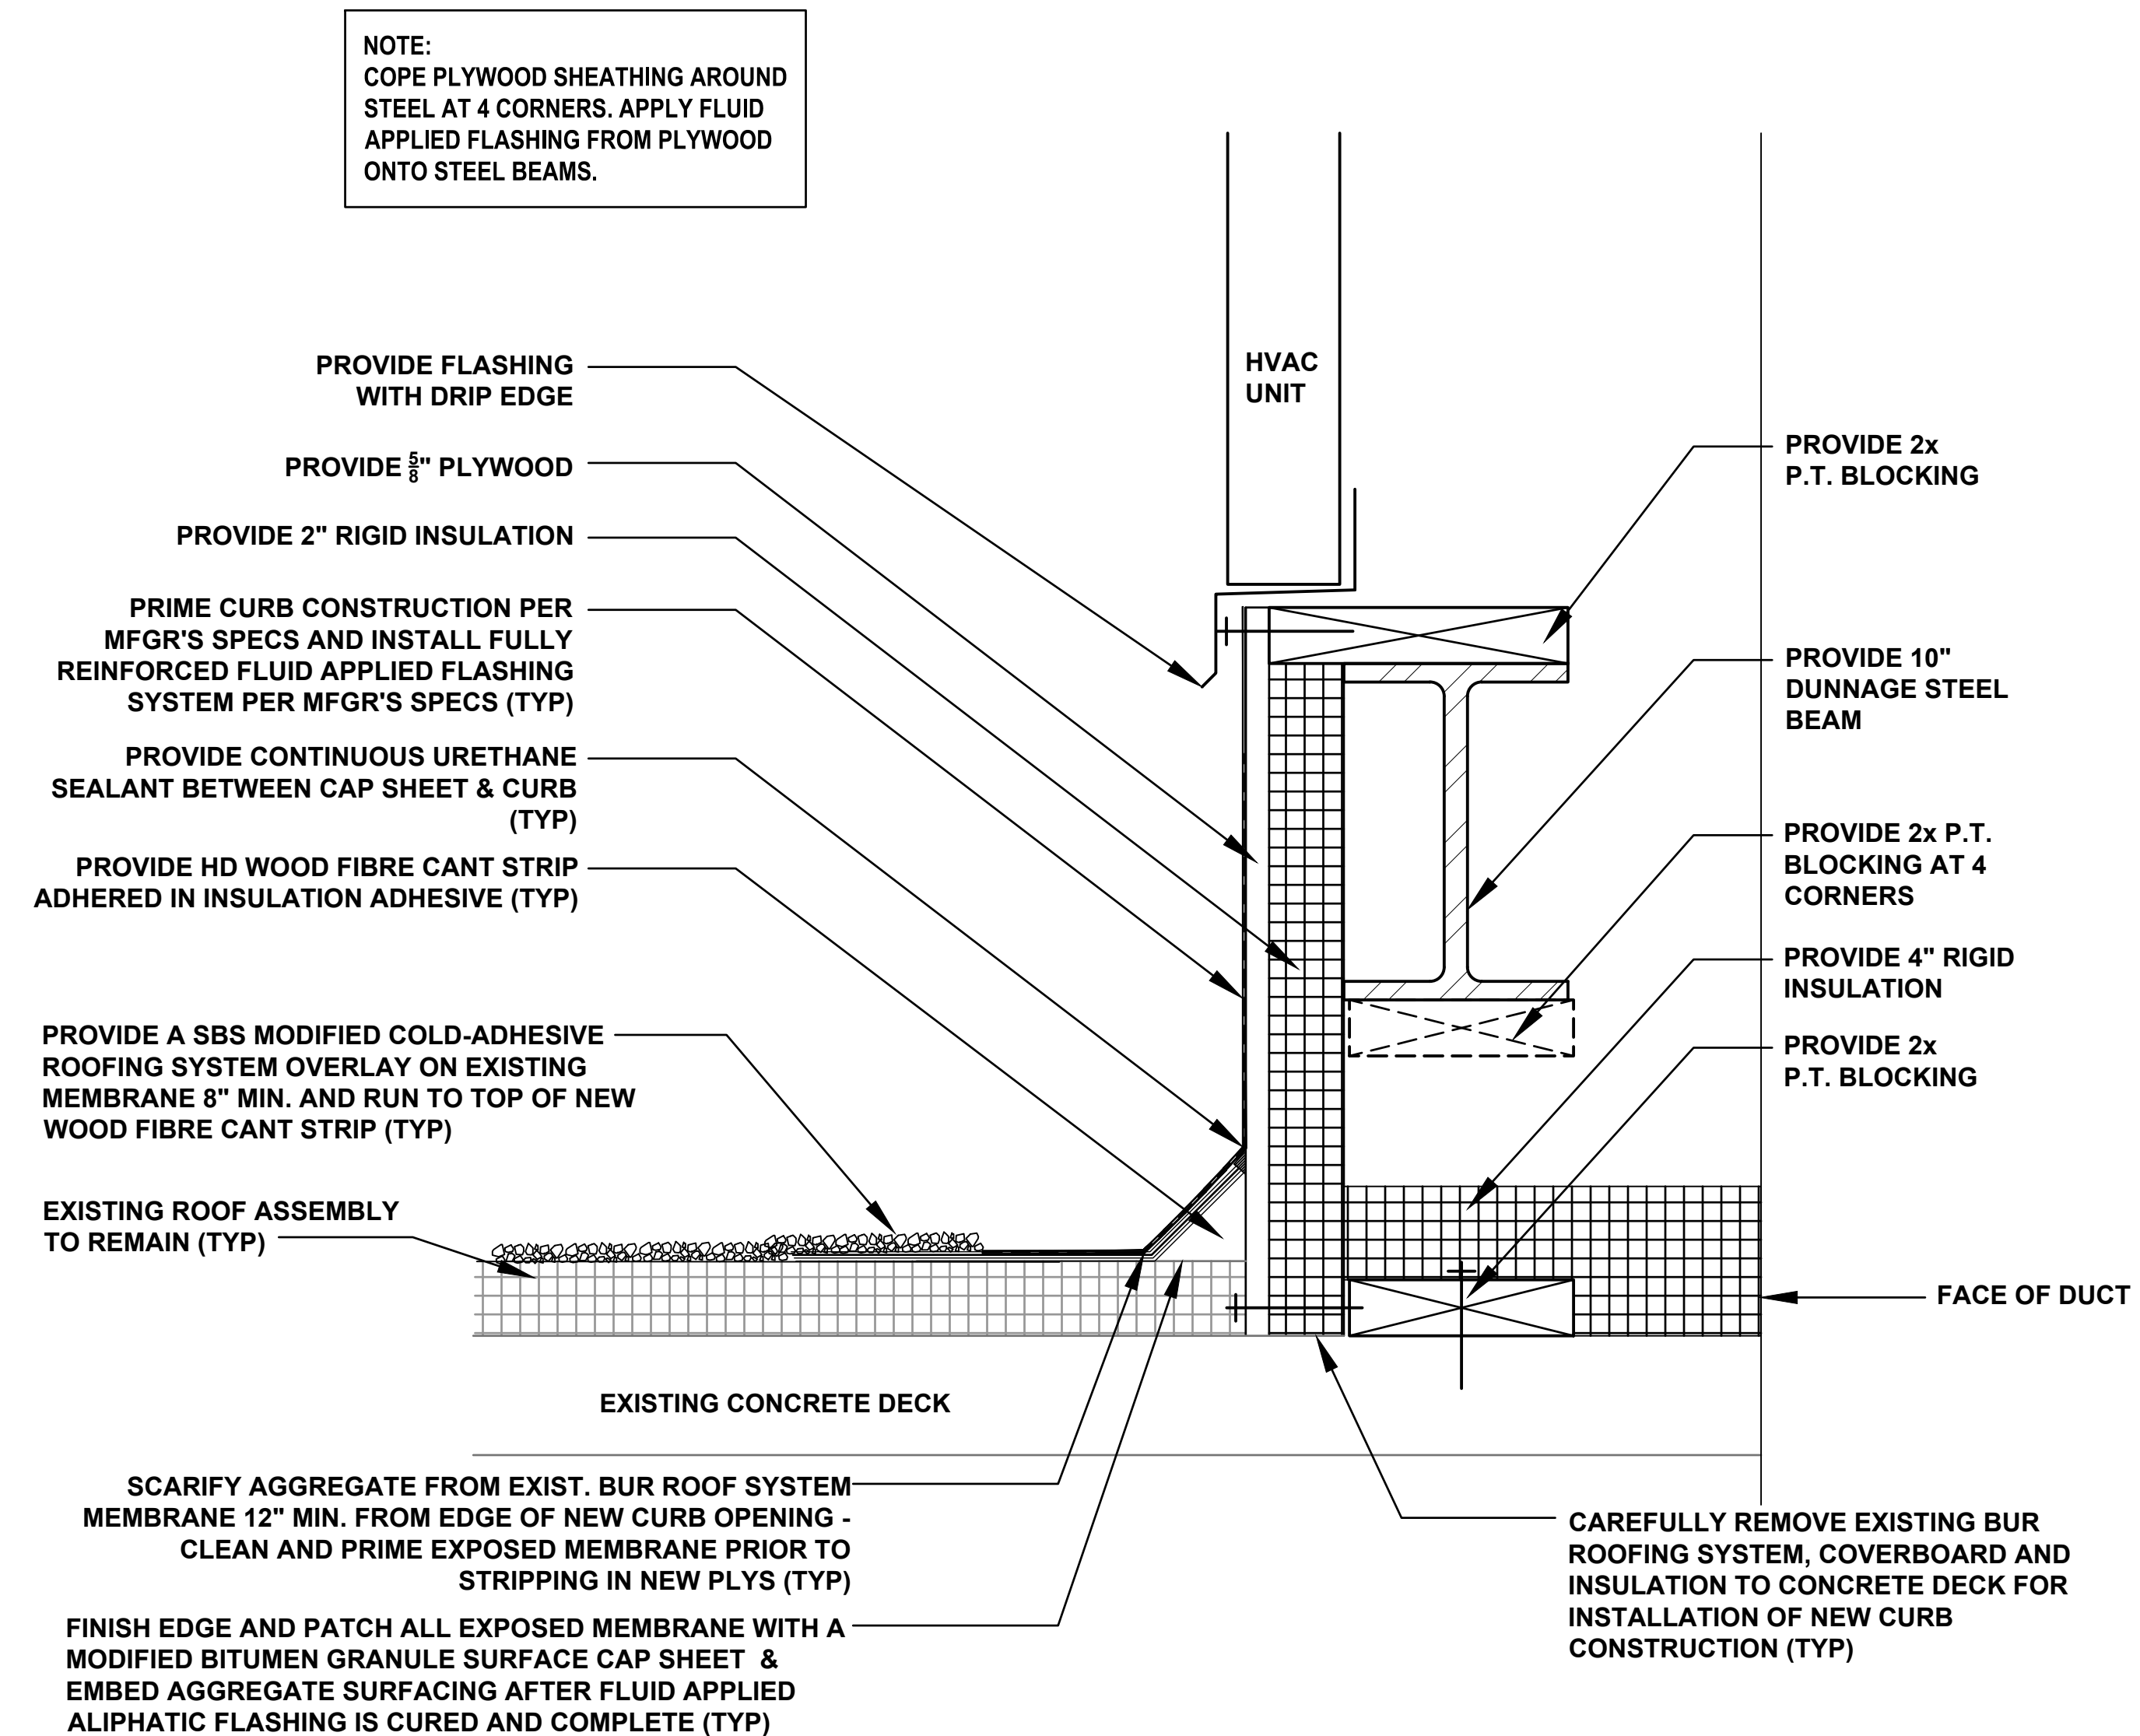


4 HVAC CURB FLASHING DETAIL
N.T.S.

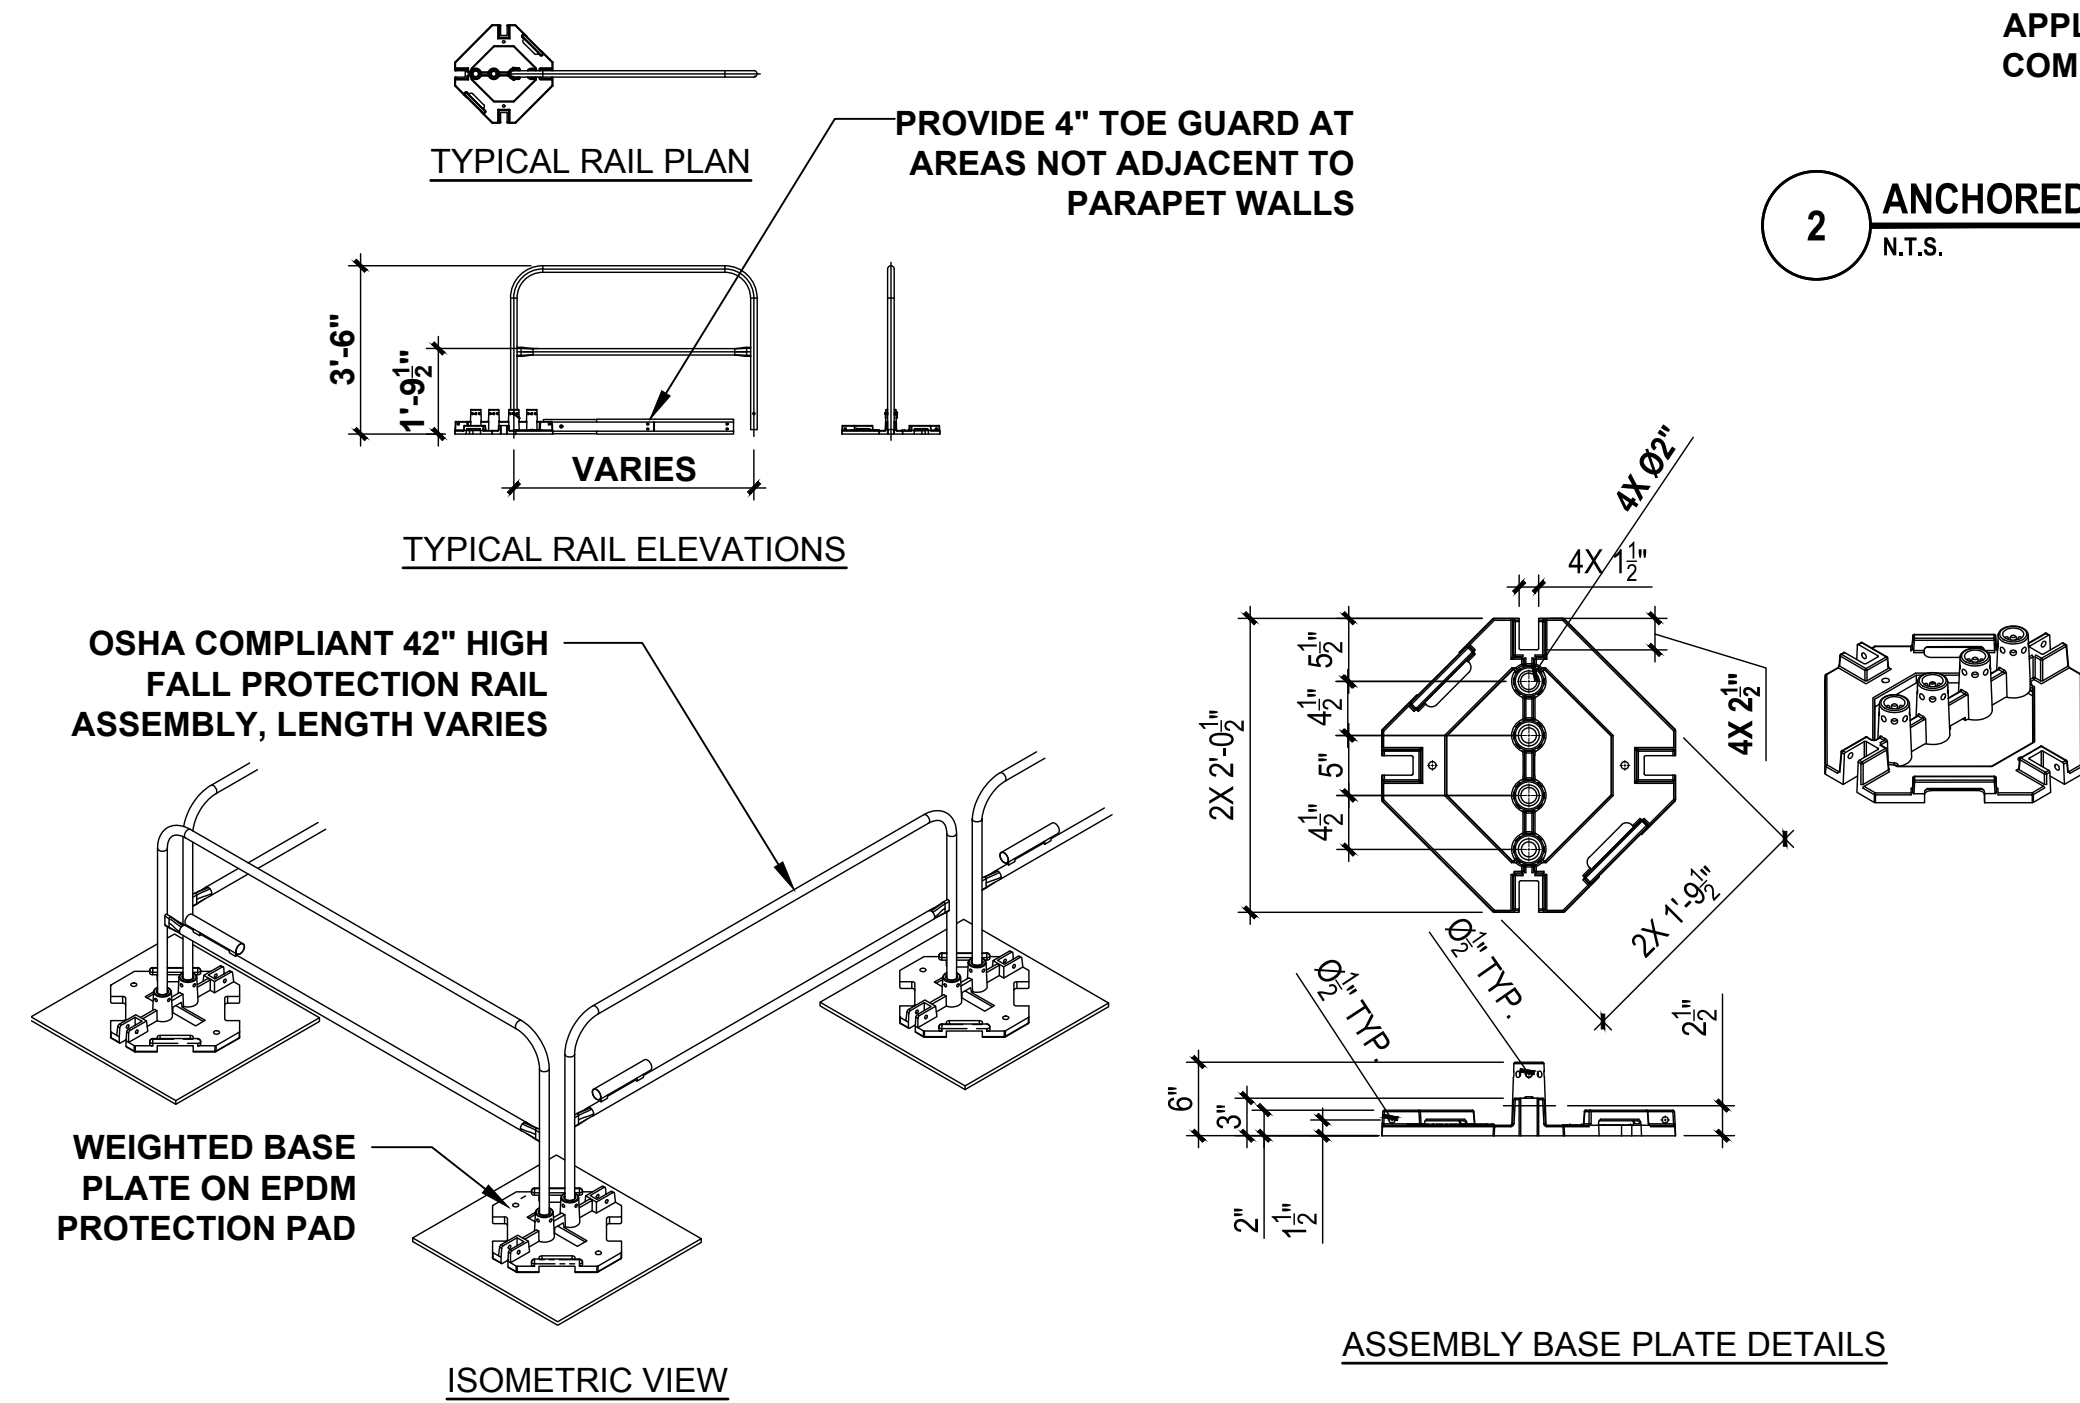

3 FALL PROTECTION RAILING SYSTEM ASSEMBLY DETAILS
N.T.S.


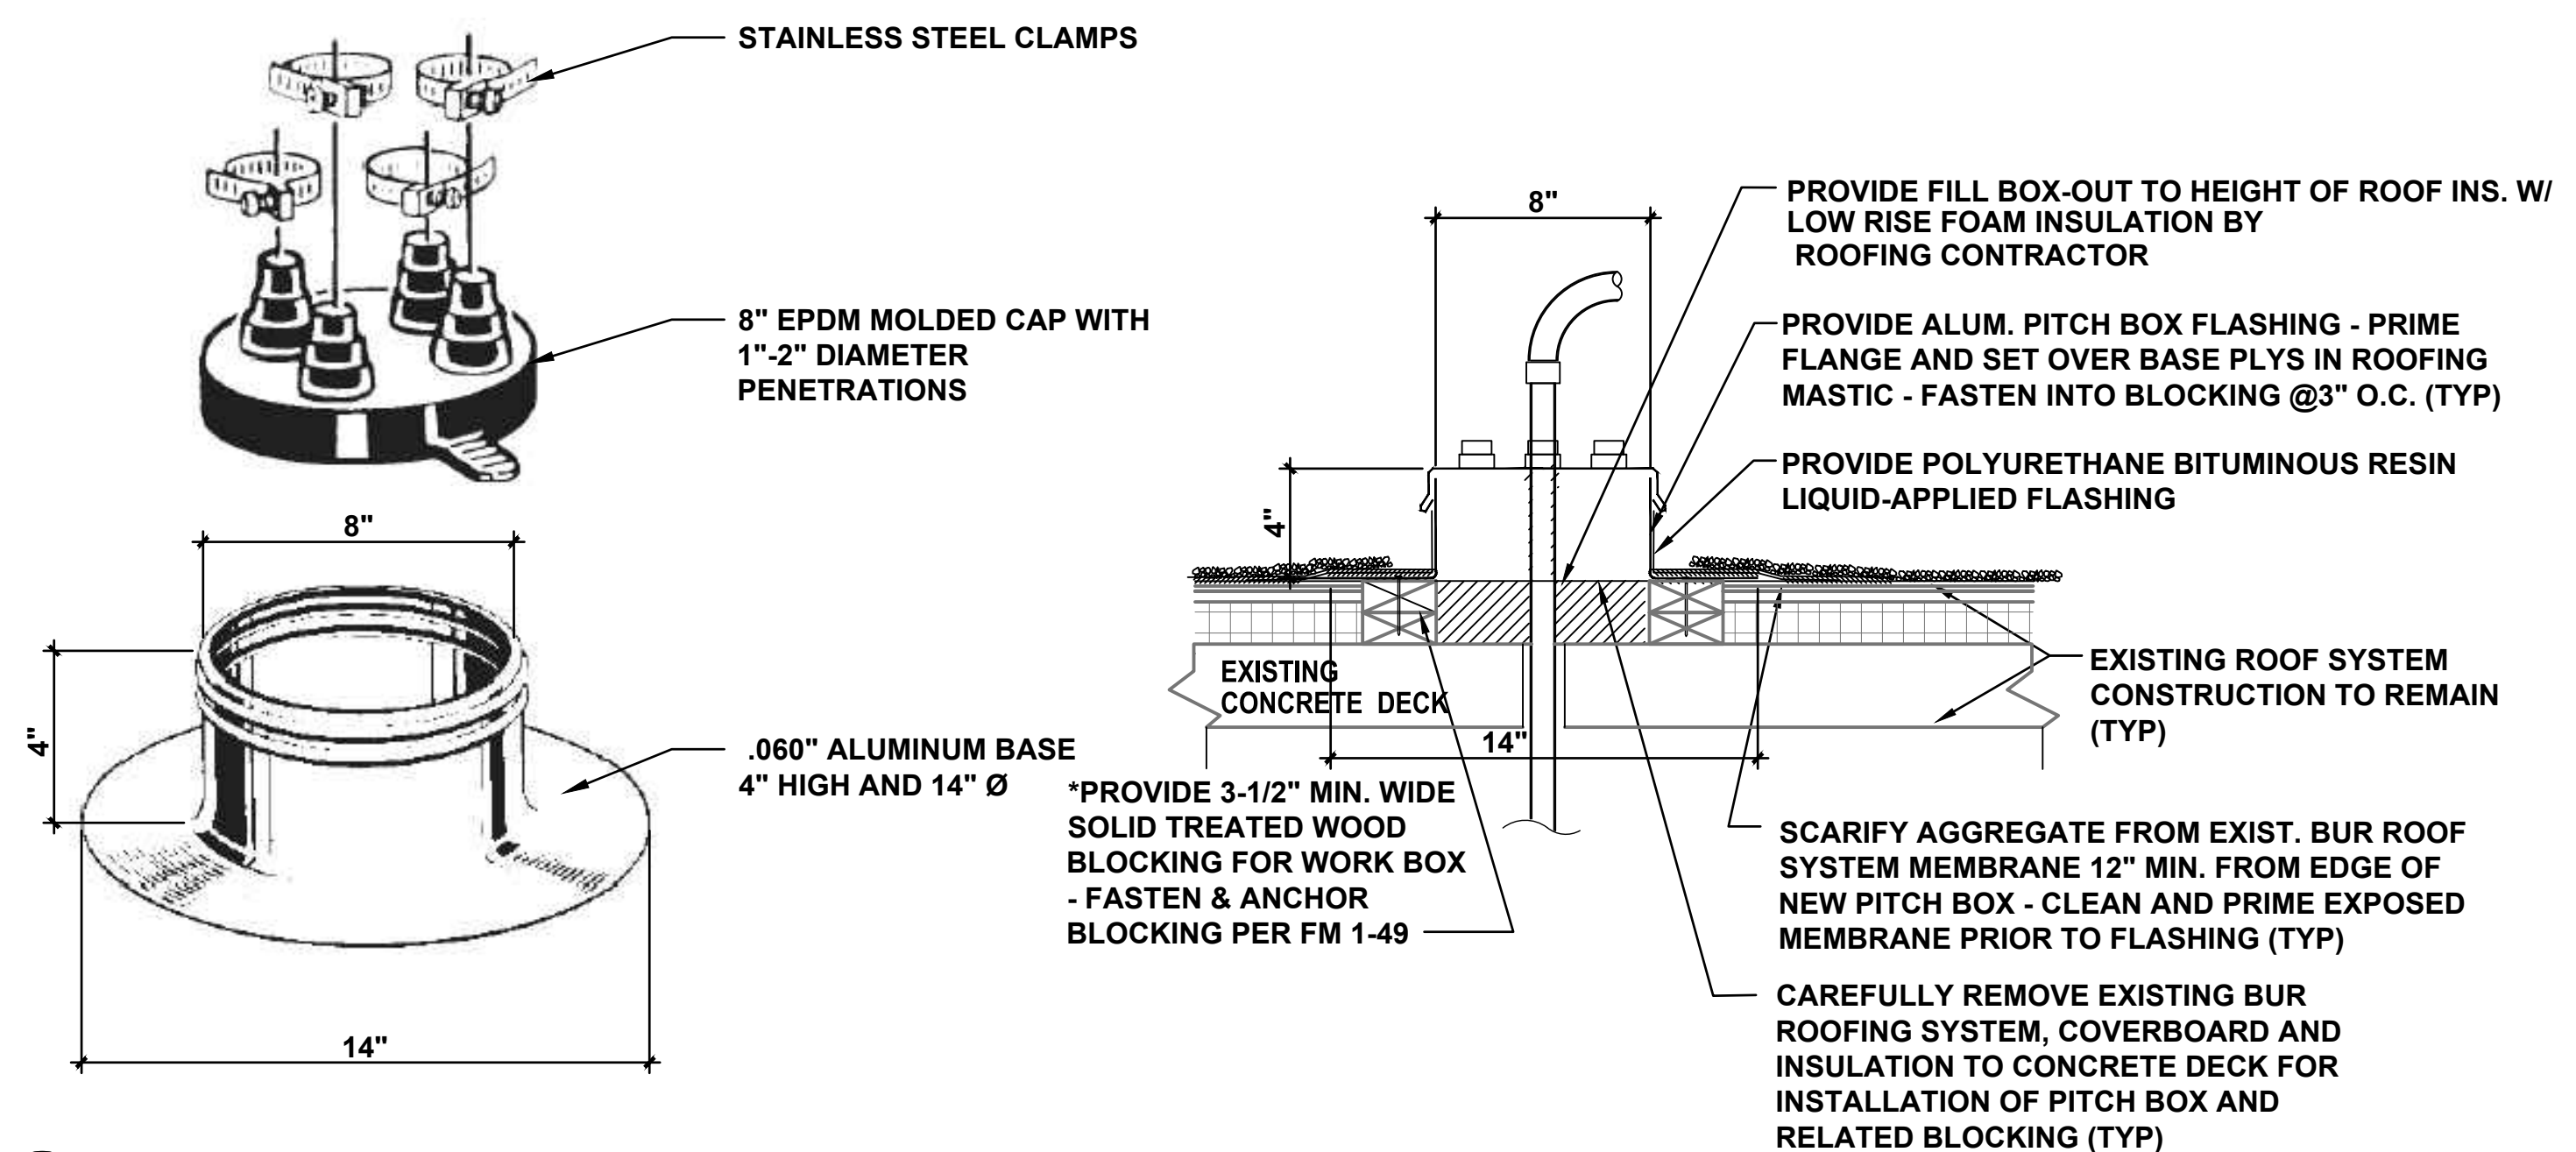


5 PIPING PENETRATION DETAIL
N.T.S.


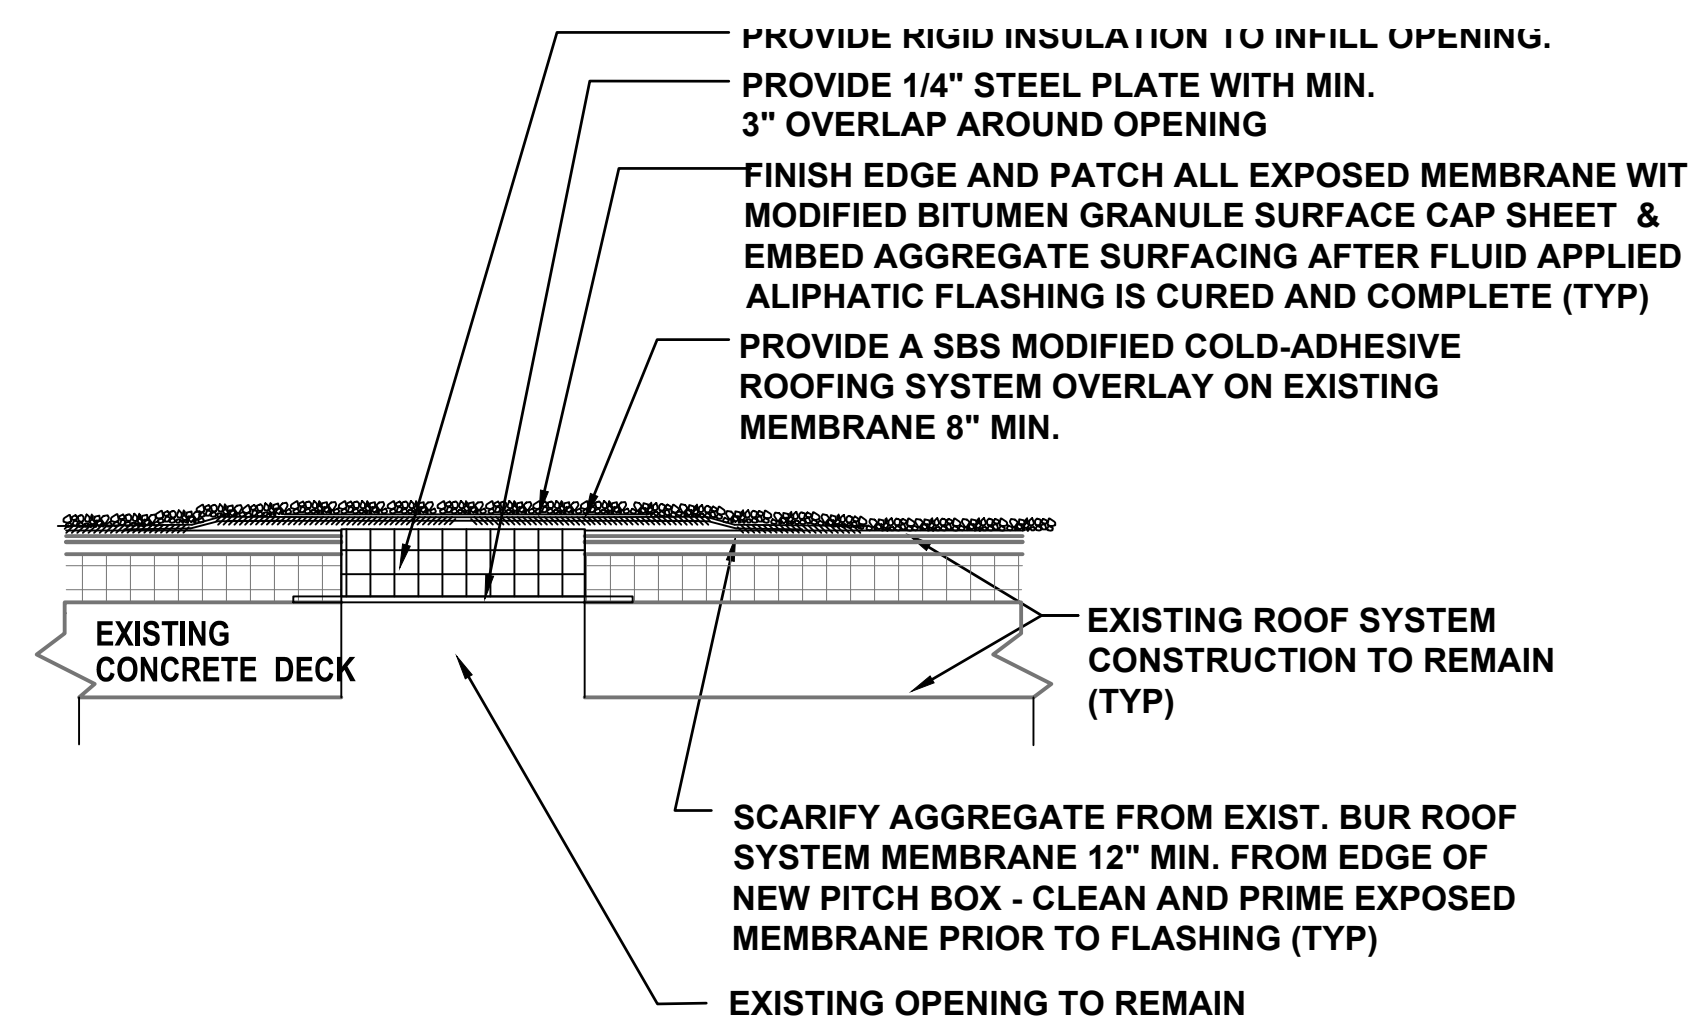


5 PITCH POCKET INFILL DETAIL
N.T.S.

| drawing title | | | STATE OF CONNECTICUT | | |
|---------------|------|-------------------------------|---------------------------------------|-------------|-----------|
| ROOF DETAILS | | | DEPARTMENT OF ADMINISTRATIVE SERVICES | | |
| REVISIONS | | | | | |
| mark | date | description | drawing prepared by | date | scale |
| | | | AMES & WHITAKER ARCHITECTS | 07/25/18 | AS NOTED |
| 8/4/17 | | SCHEMATIC DESIGN SUBMISSION | 31 LIBERTY STREET SOUTHINGTON, CT | | |
| 1/15/18 | | DESIGN DEVELOPMENT SUBMISSION | | | |
| 4/16/18 | | CONSTRUCTION DOCUMENTS | | | |
| 5/23/18 | | | | | |
| 7/25/18 | | | | | |
| | | | project | | |
| | | | WESTERN CT STATE UNIVERSITY | drawn by | SP/CA |
| | | | WHITE HALL | approved by | AL |
| | | | 2ND AND 3RD FLOOR RENOVATIONS | drawing no. | A5.01 |
| | | | DANBURY, CONNECTICUT | | |
| | | | CAD no. | project no. | BI-RD-299 |

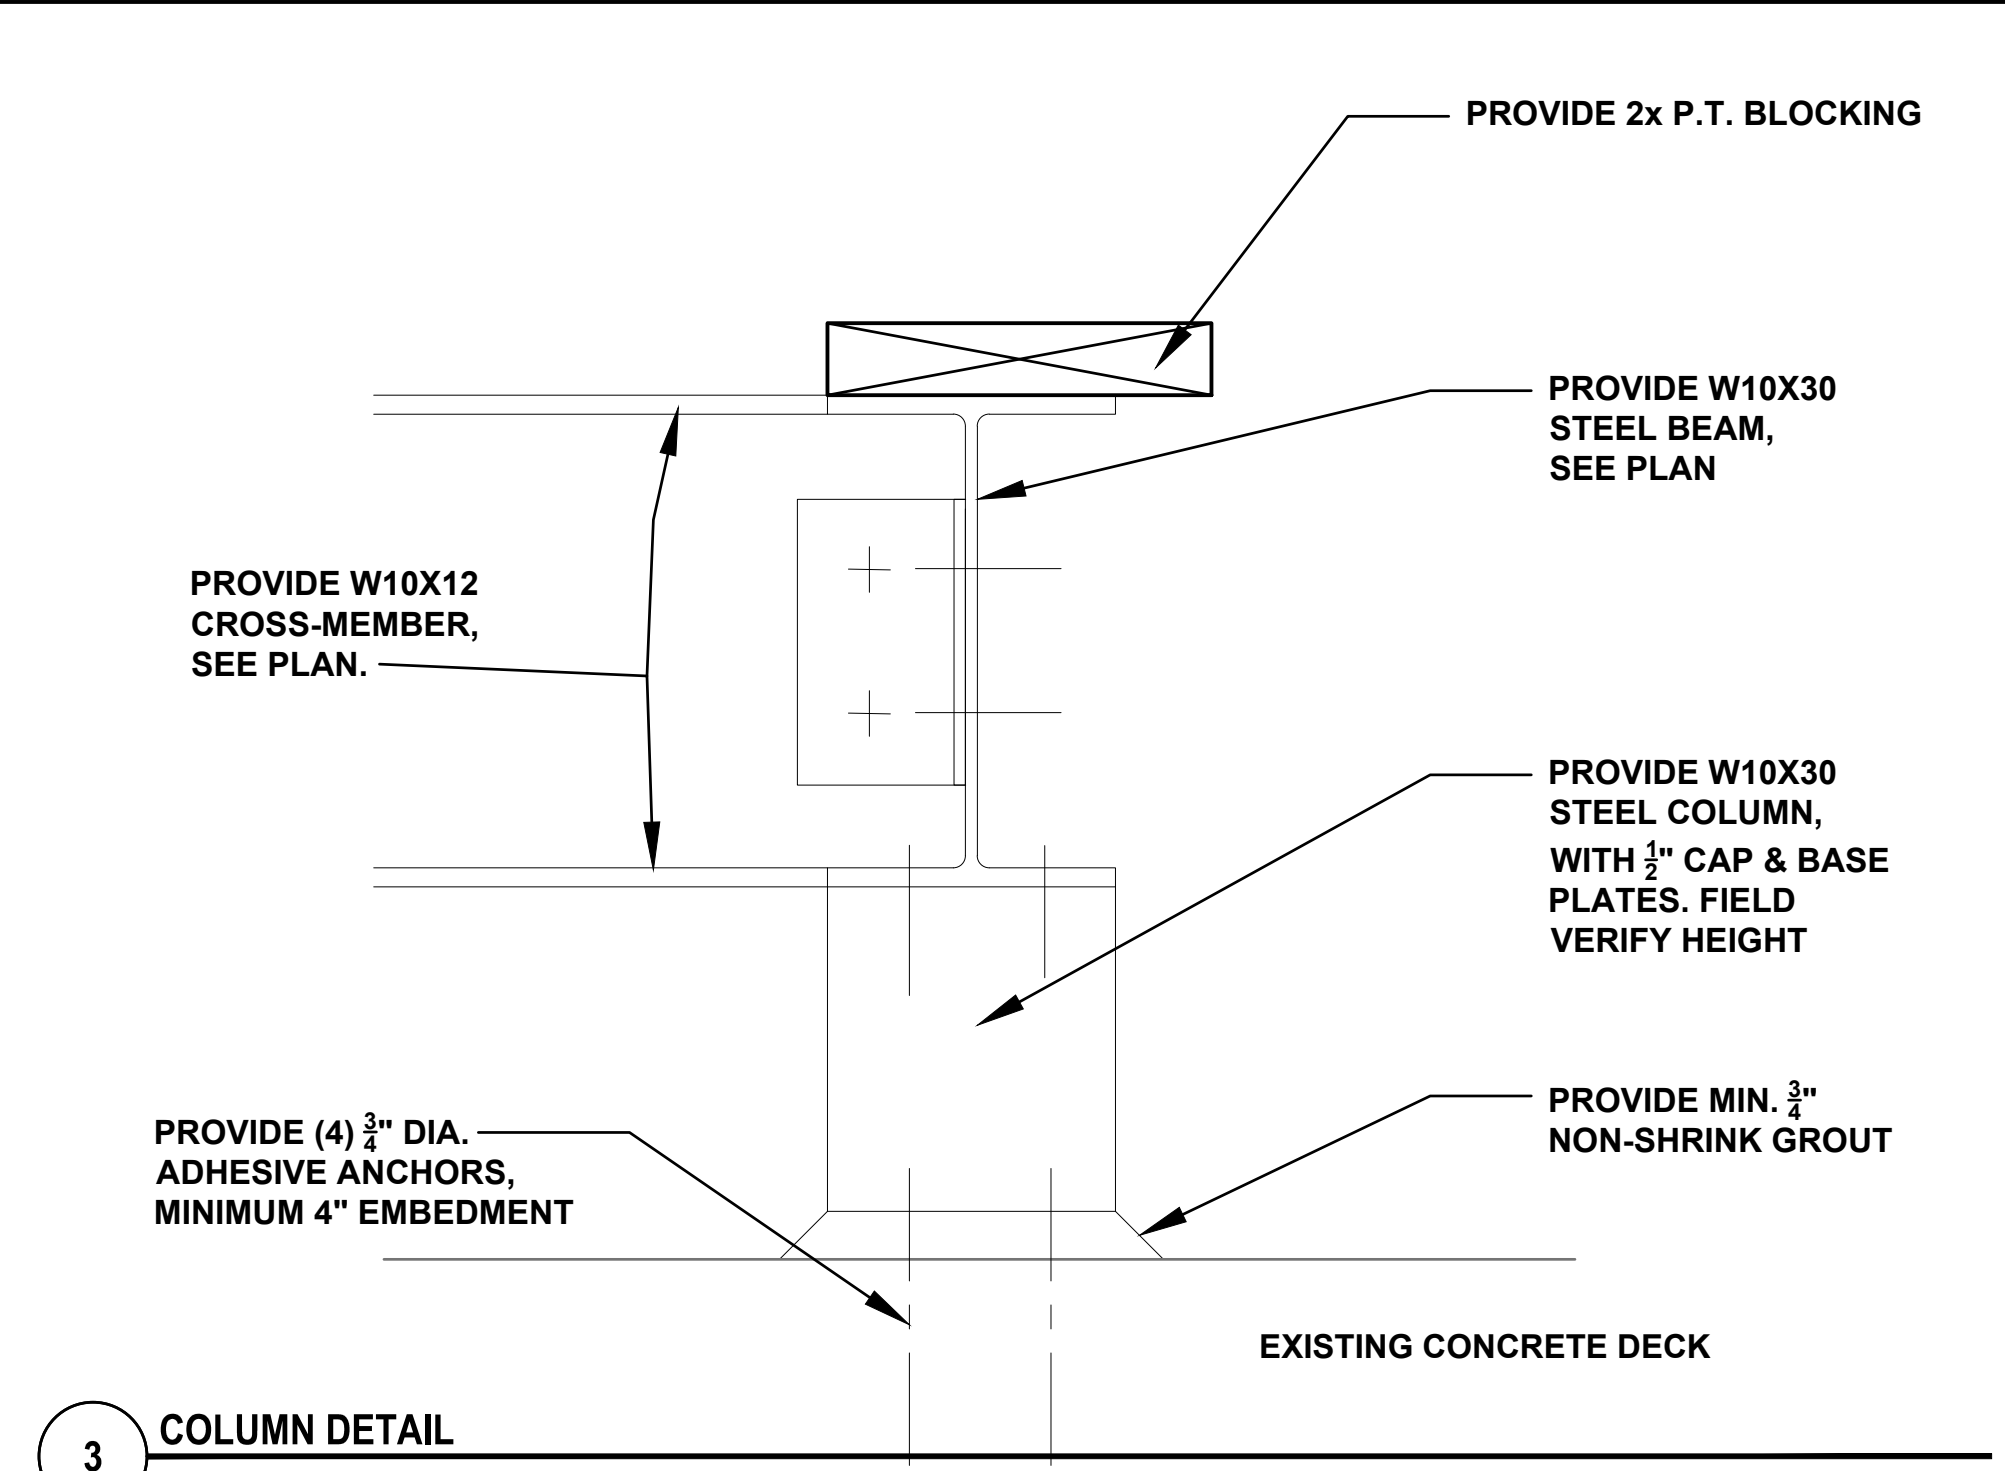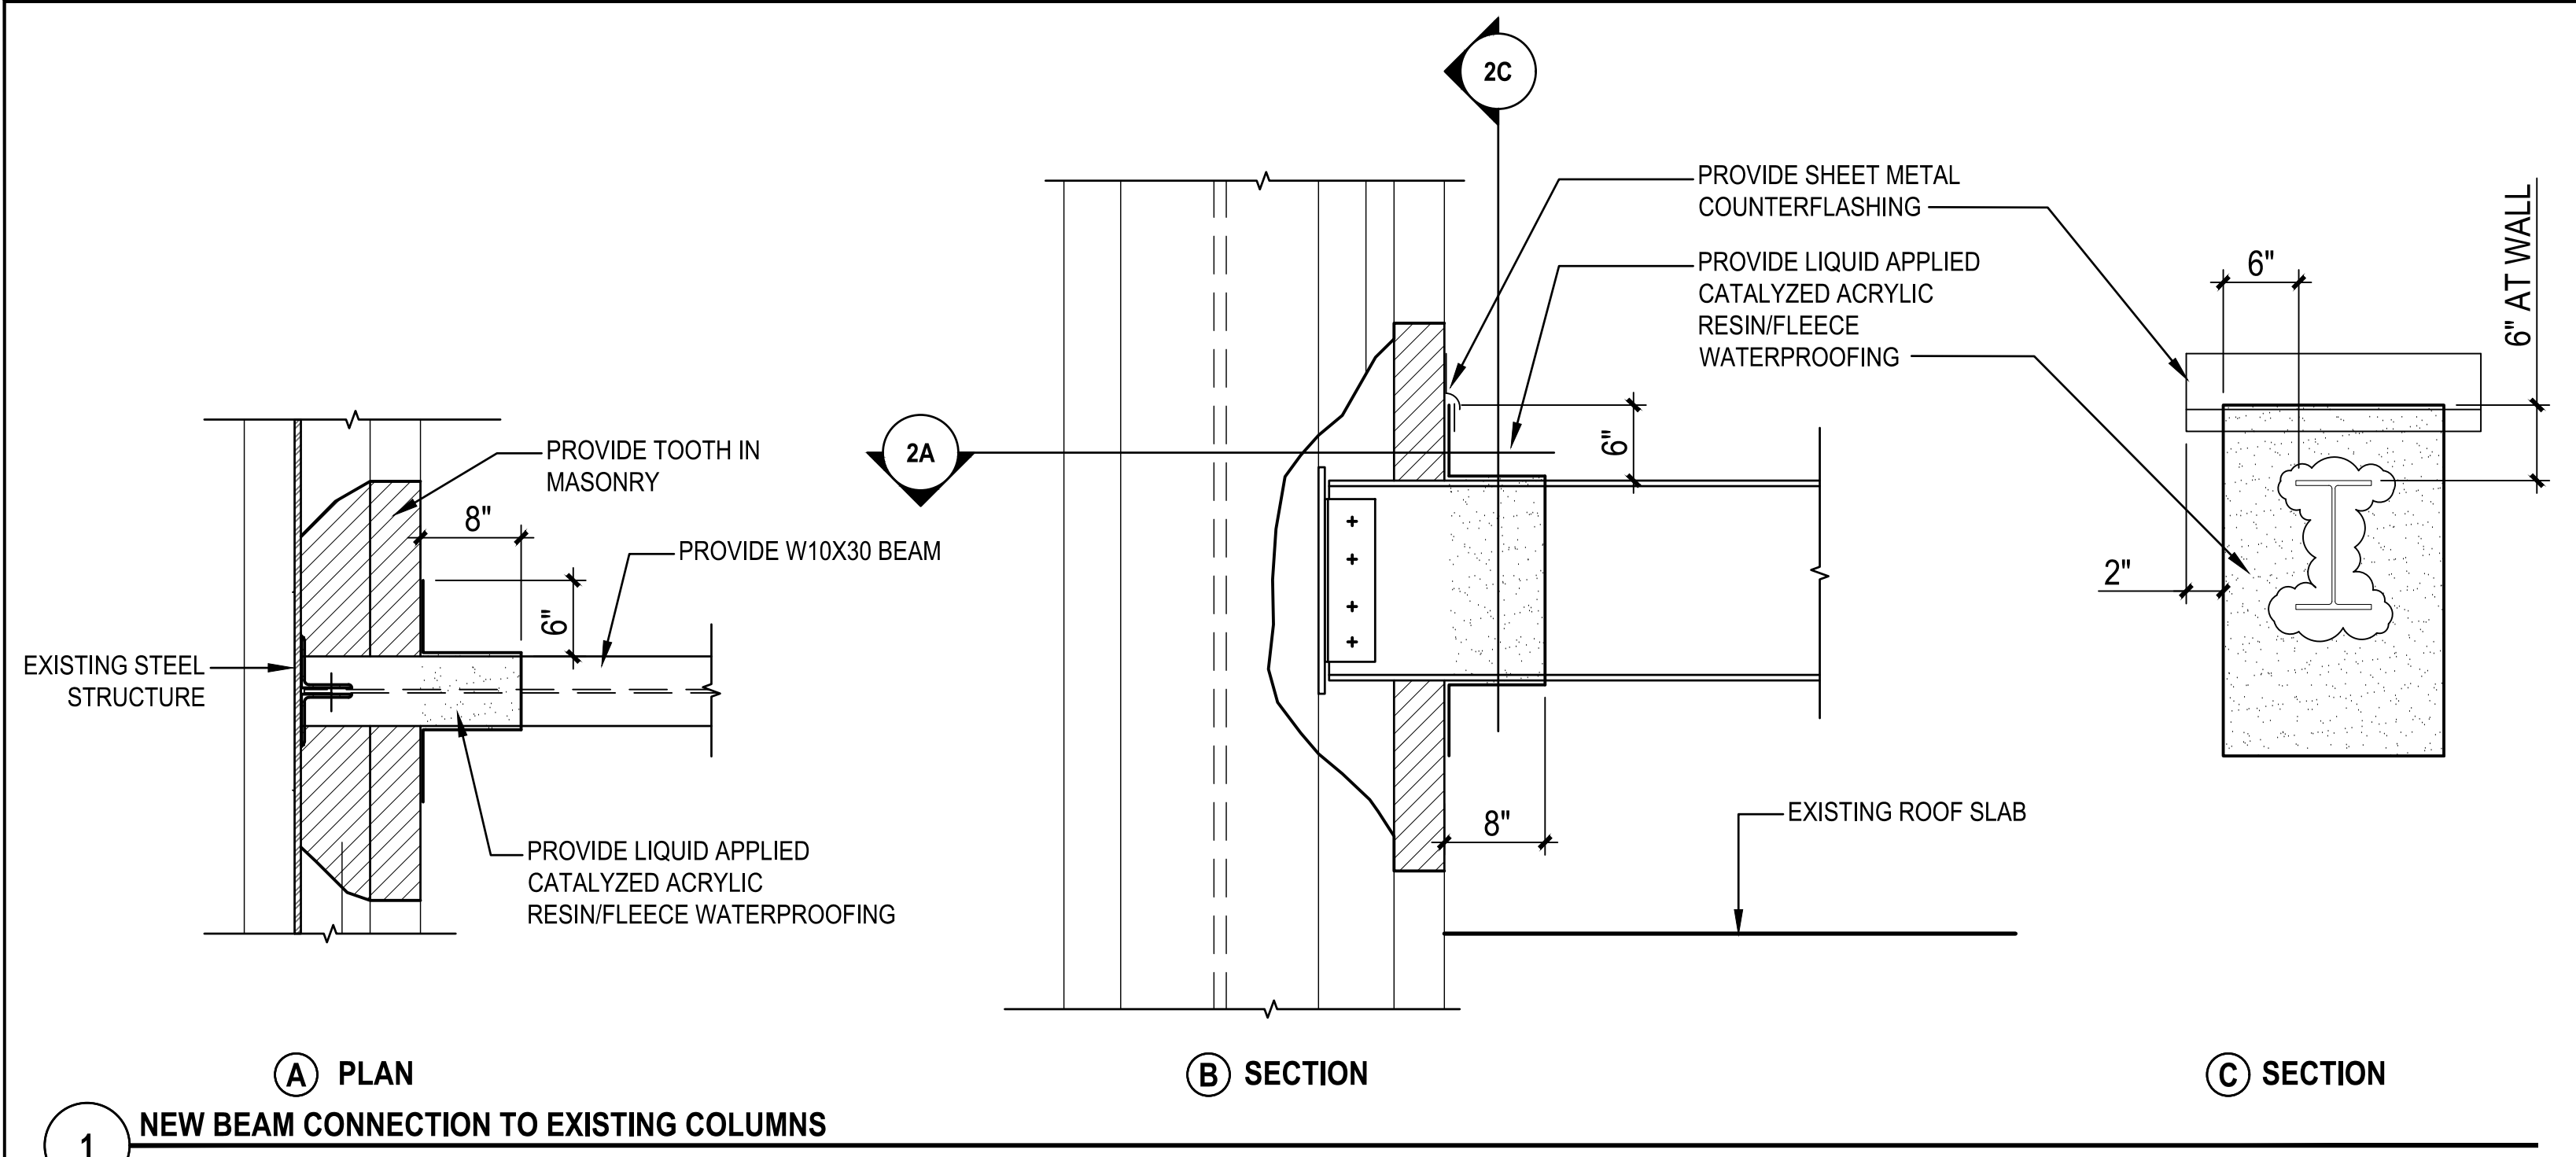

- STRUCTURAL STEEL NOTES:**
1. FABRICATION AND ERECTION OF STRUCTURAL STEEL SHALL CONFORM WITH THE AMERICAN INSTITUTE OF STEEL CONSTRUCTION, "MANUAL OF STEEL CONSTRUCTION" (LATEST EDITION) OR THE "MANUAL FOR STEEL CONSTRUCTION, LOAD AND RESISTANCE FACTOR DESIGN" (LATEST EDITION).
 2. ALL STEEL DETAILS AND CONNECTIONS SHALL BE IN ACCORDANCE WITH THE REQUIREMENTS OF THE AISC "SPECIFICATIONS FOR STRUCTURAL STEEL BUILDINGS, ALLOWABLE STRESS DESIGN AND PLASTIC DESIGN", (LATEST EDITION) OR THE "MANUAL FOR STEEL CONSTRUCTION, LOAD AND RESISTANCE FACTOR DESIGN", (LATEST EDITION). BRACED FRAME CONNECTIONS SHALL BE DESIGNED IN ACCORDANCE WITH THE REQUIREMENTS OF THE AISC "SEISMIC PROVISIONS FOR STRUCTURAL BUILDINGS" 2002 EDITION.
 3. ALL CONNECTION MATERIAL, BASE PLATES, ANGLES AND MISCELLANEOUS FRAMING SHALL CONFORM TO ASTM STANDARD A-36 UNLESS OTHERWISE NOTED.
 4. SHOP AND FIELD CONNECTIONS NOT SPECIFICALLY DETAILED ON THE DRAWINGS MAY BE BOLTED OR WELDED.
 5. WHEN INDICATED AS BOLTED ON THE DRAWINGS, ALL SHOP OR FIELD BOLTED BEAM TO BEAM CONNECTIONS SHALL BE BOLTED CONNECTIONS USING 3/4 INCH DIAMETER A325 BEARING BOLTS IN STANDARD HOLES UNLESS SPECIFICALLY NOTED OTHERWISE.
 6. OVERSIZED OR SLOTTED HOLES SHALL NOT BE USED FOR ANY CONNECTIONS UNLESS SPECIFICALLY INDICATED ON THE DRAWINGS OR APPROVED IN WRITING BY THE ENGINEER.
 7. ALL ANCHOR RODS SHALL CONFORM TO F1554 UNLESS OTHERWISE NOTED.
 8. ALL WELDS INDICATED SHALL MEET THE MINIMUM WELD SIZE SPECIFIED BY THE CURRENT AISC MANUAL OF STEEL DESIGN.
 9. ALL WELDING SHALL BE PERFORMED BY QUALIFIED WELDERS IN ACCORDANCE WITH A.W.S. SPECIFICATIONS, (LATEST EDITIONS). ALL WELDING ELECTRODES SHALL CONFORM TO A.W.S. A5.1 GRADE E-70. BARE ELECTRODES AND GRANULAR FLUX SHALL CONFORM TO A.W.S. A5.17, F70 A.W.S. FLUX CLASSIFICATION.
 10. THE CONTRACTOR SHALL PROVIDE THE ENGINEER WITH SHOP DRAWINGS TO BE APPROVED PRIOR TO FABRICATING STEEL.

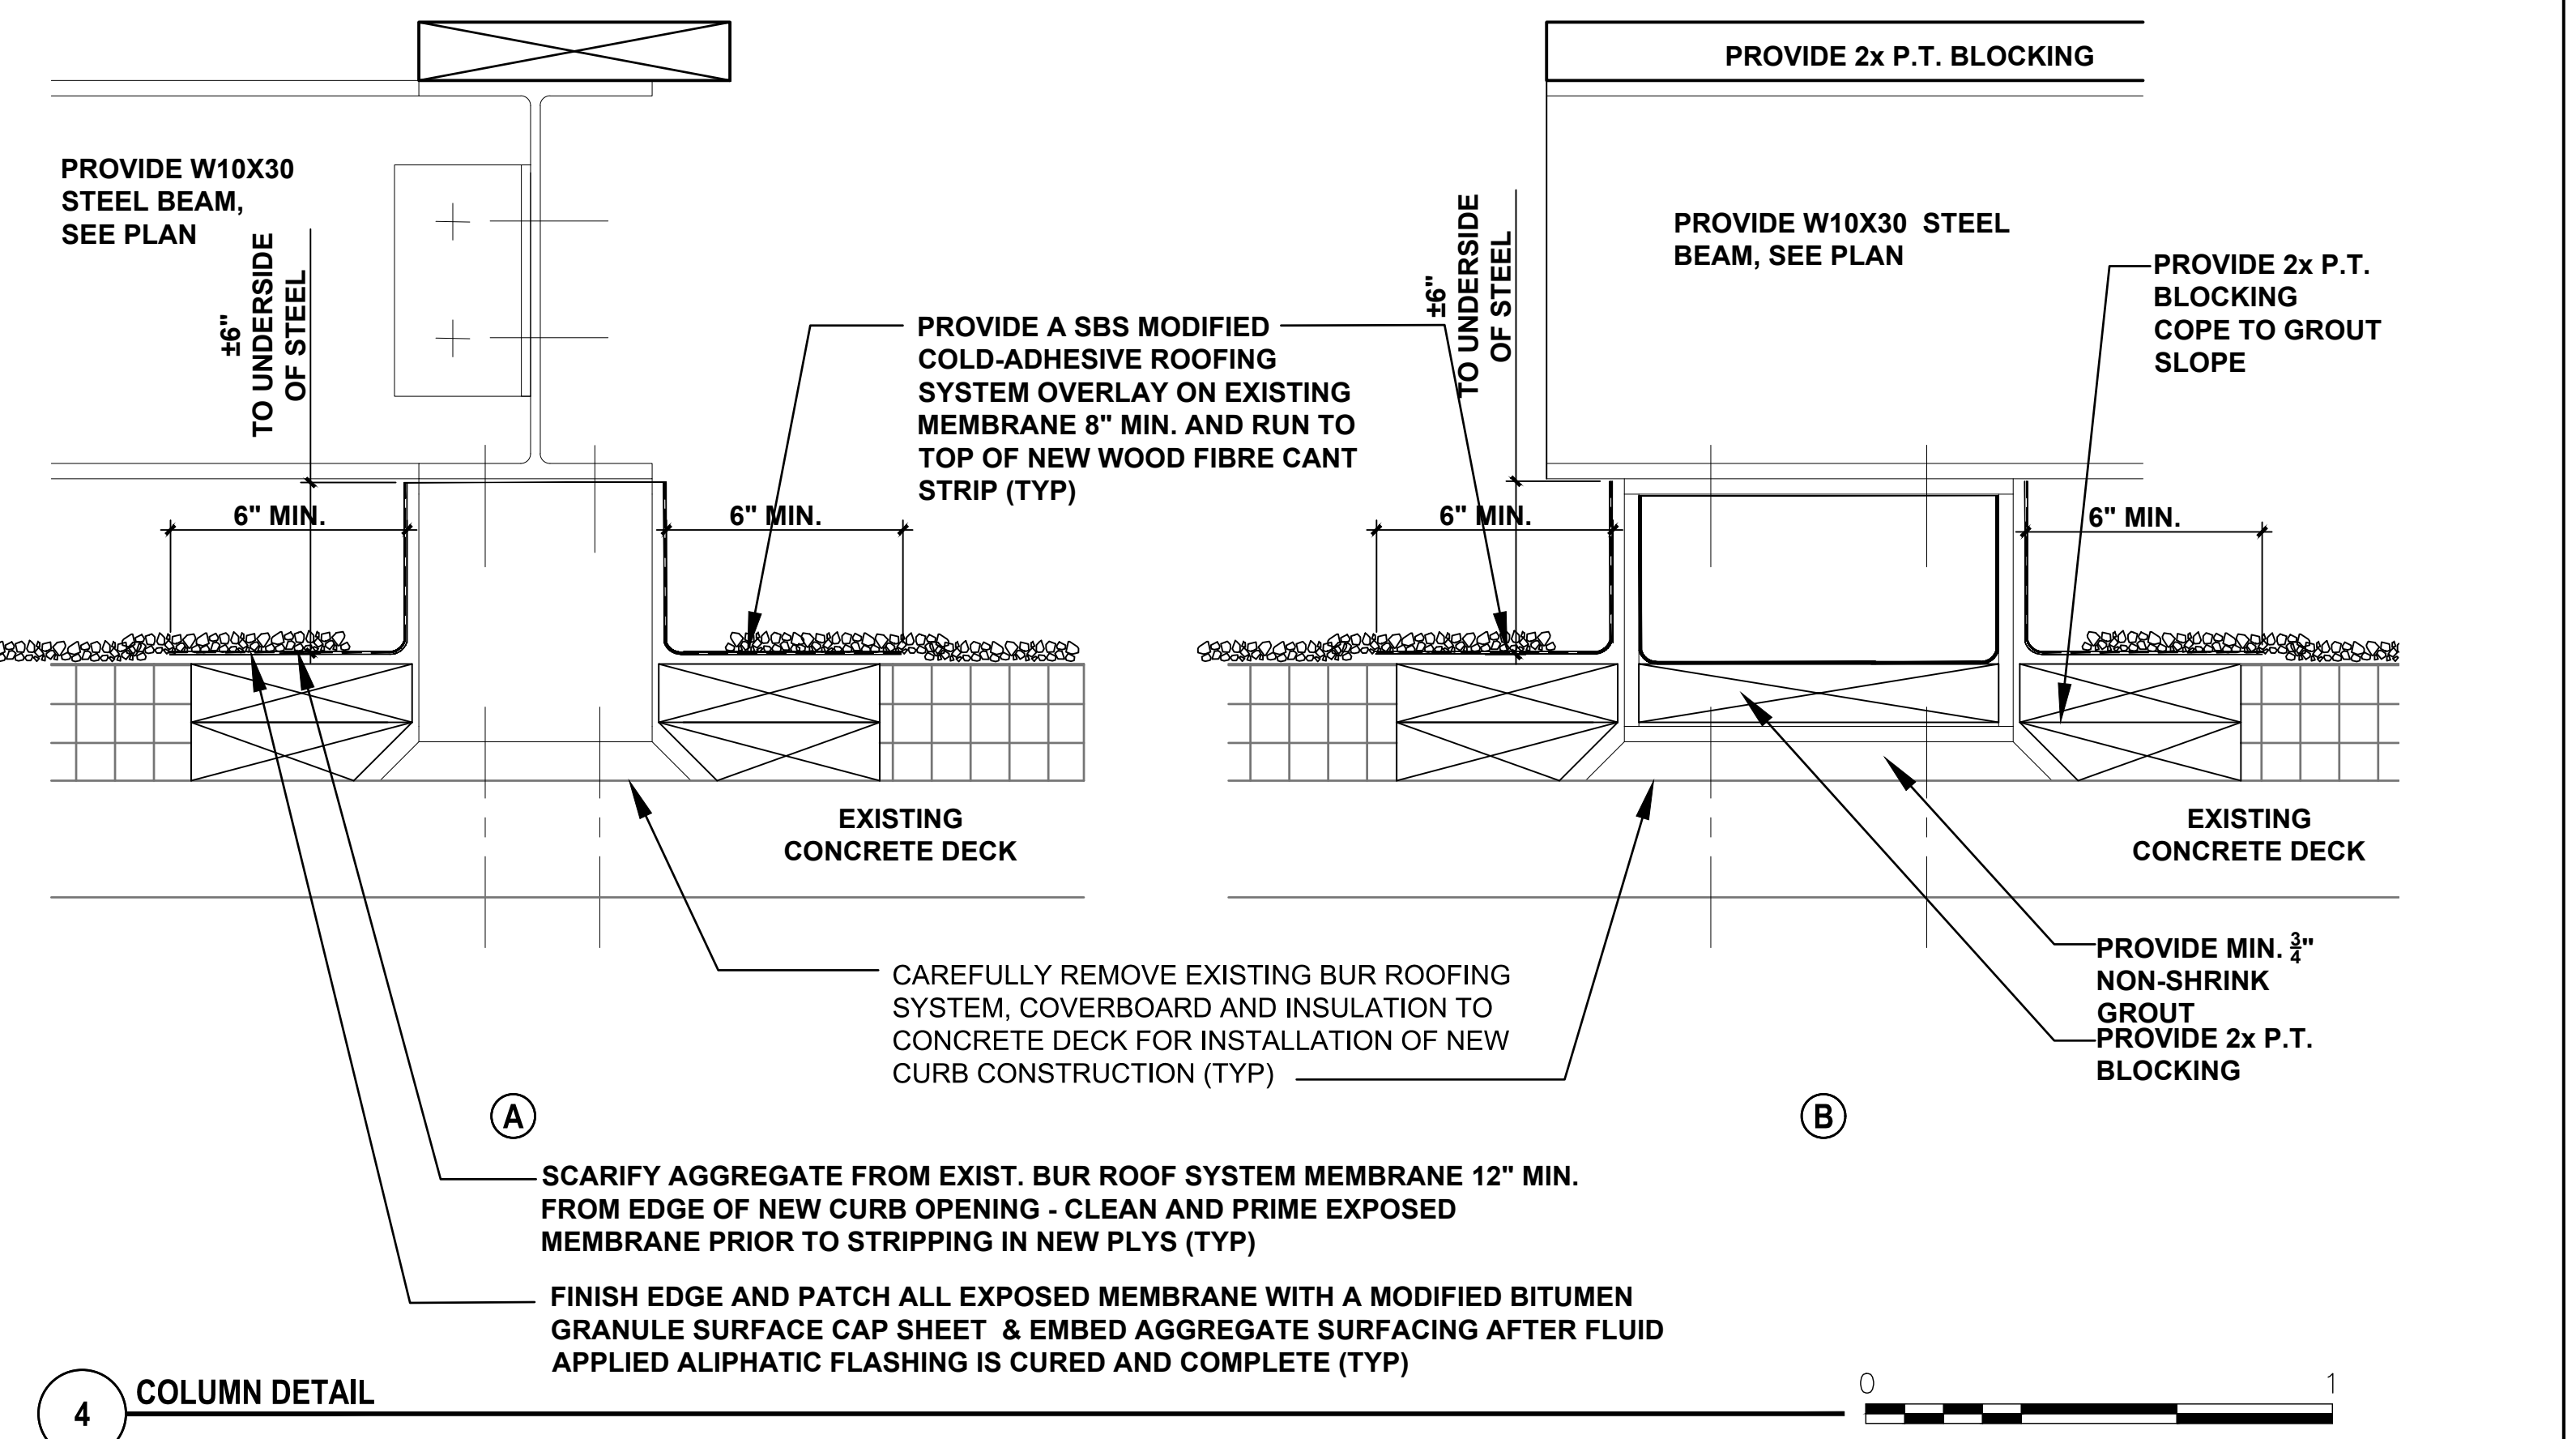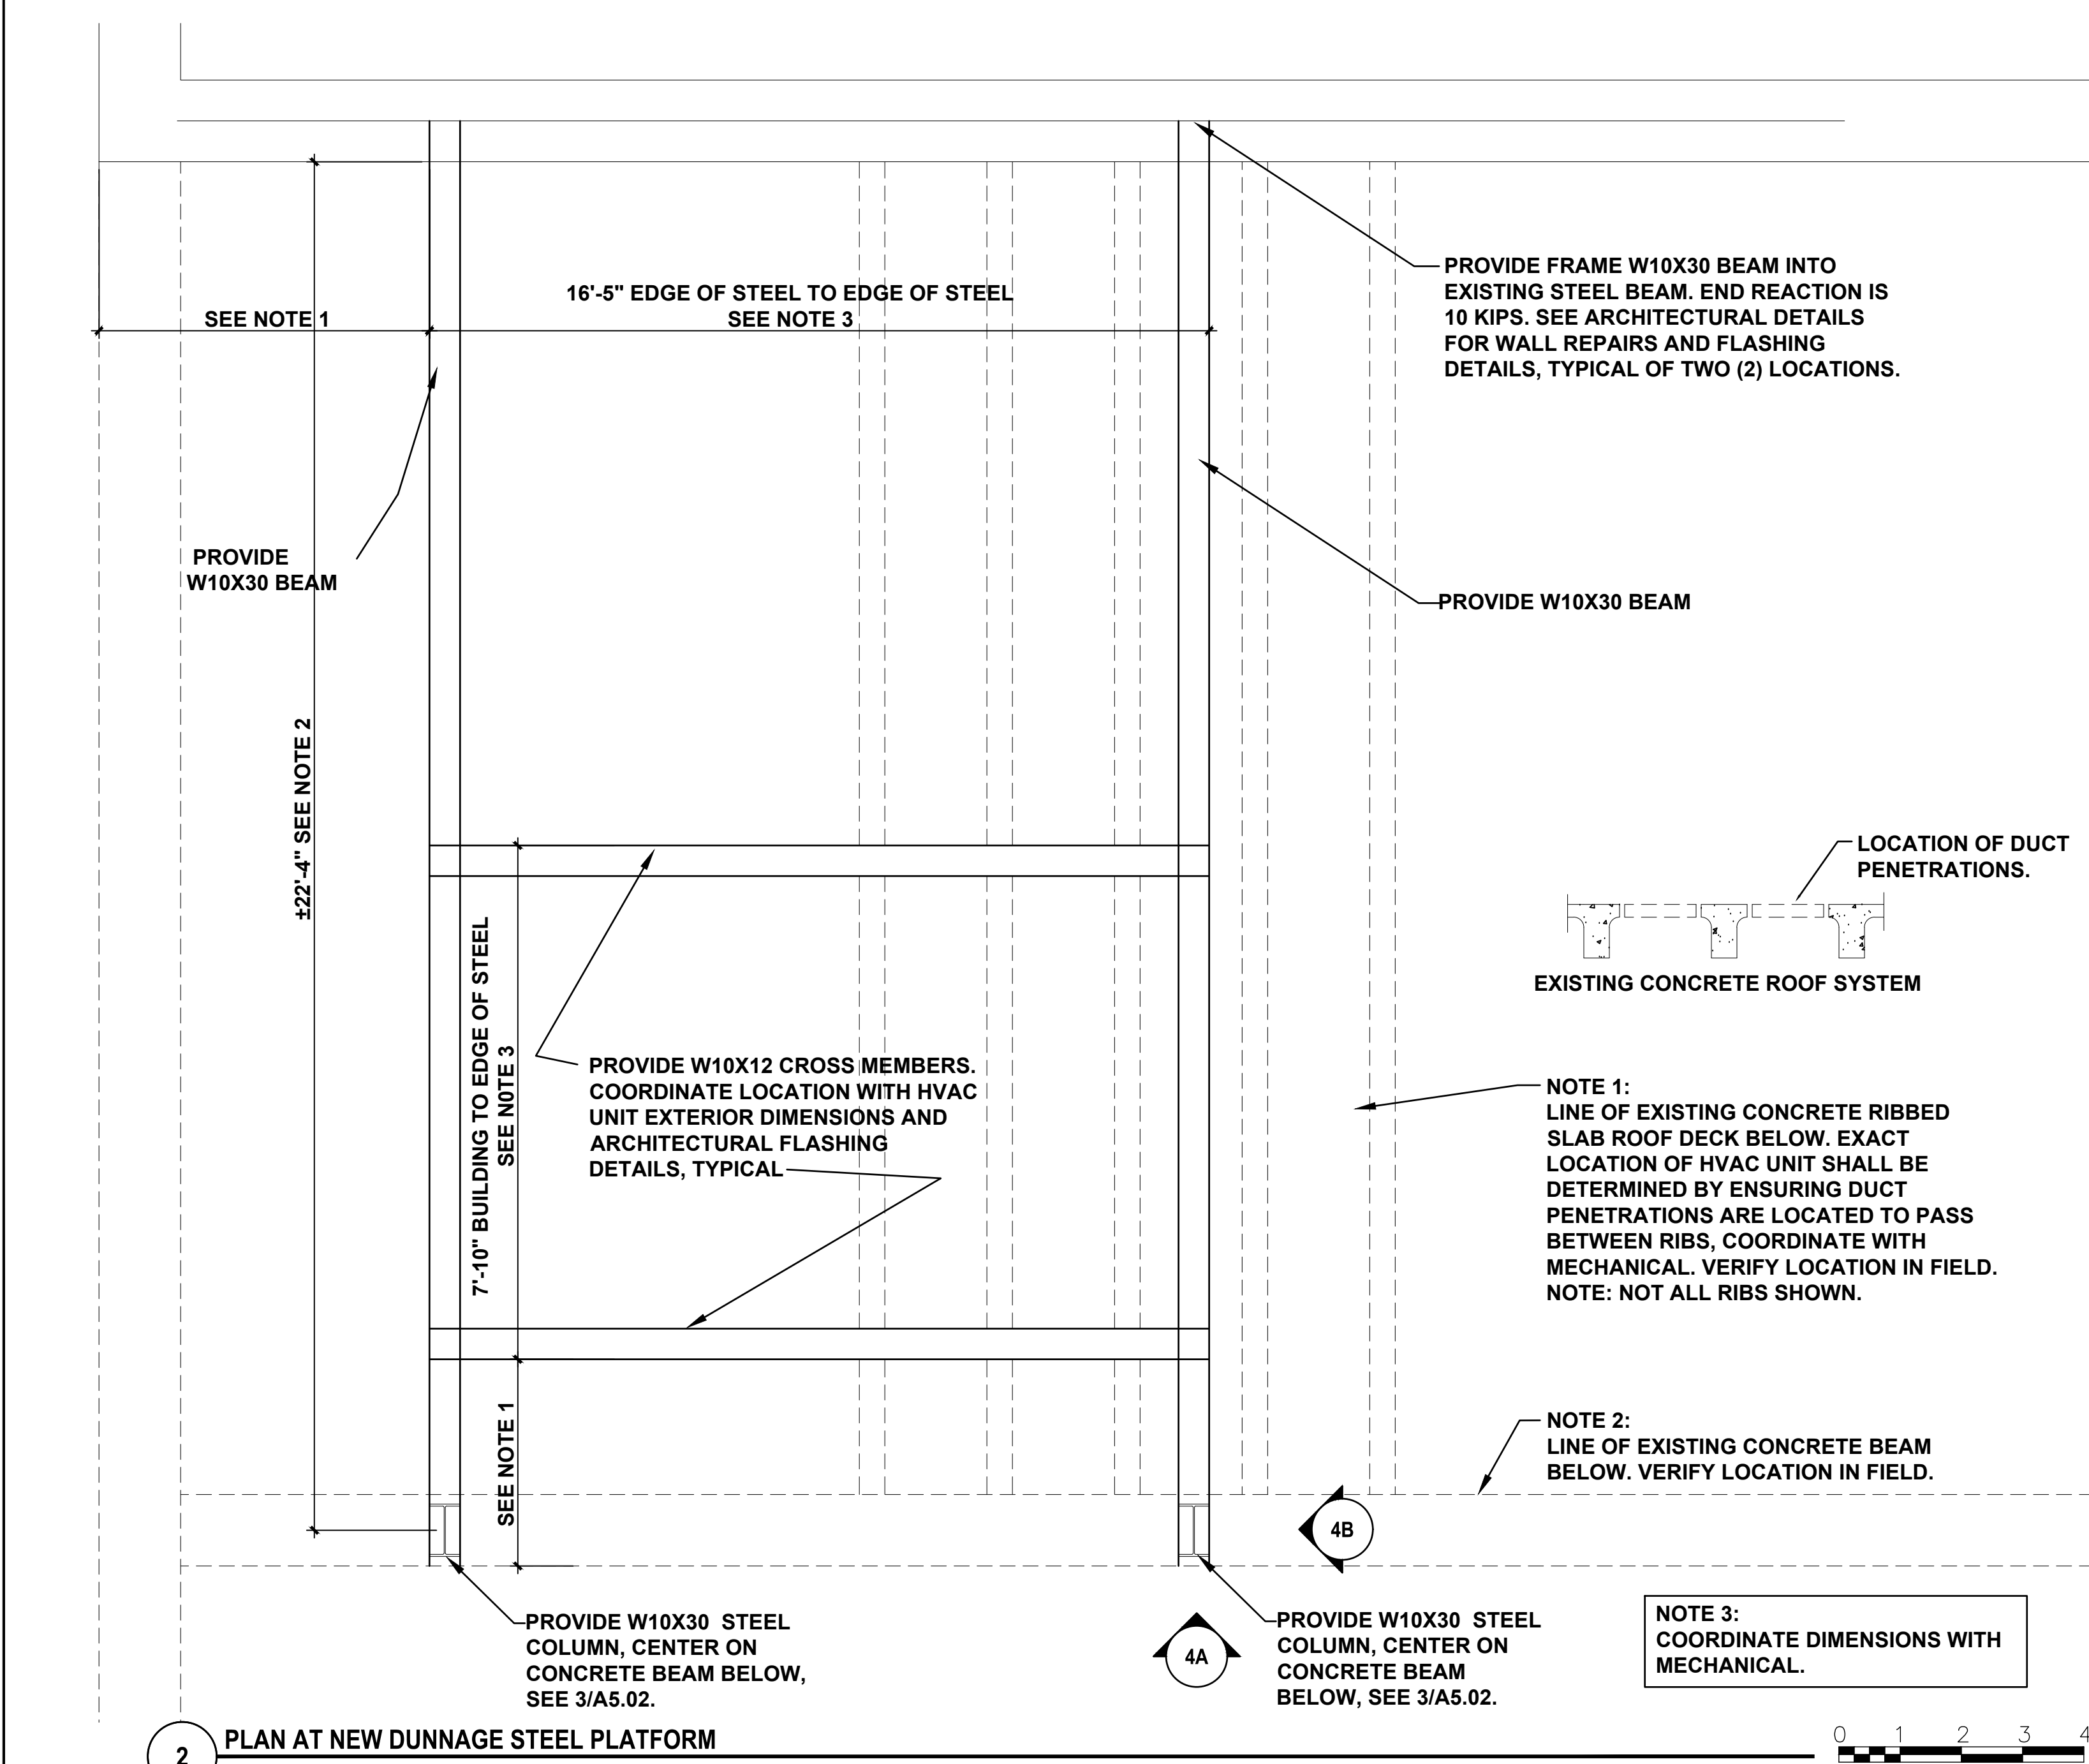

| drawing title | | | STATE OF CONNECTICUT | |
|---------------|---------|-------------------------------|---------------------------------------|--------------|
| ROOF DETAILS | | | DEPARTMENT OF ADMINISTRATIVE SERVICES | |
| REVISIONS | | | | |
| mark | date | description | drawing prepared by | date |
| | | | AMES & WHITAKER ARCHITECTS | 07/25/18 |
| | | | 31 LIBERTY STREET | scale |
| | | | SOUTHINGTON, CT | AS NOTED |
| | | | project | |
| | 8/4/17 | SCHEMATIC DESIGN SUBMISSION | WESTERN CT STATE UNIVERSITY | drawn by |
| | 1/15/18 | DESIGN DEVELOPMENT SUBMISSION | WHITE HALL | SP/CA |
| | 4/16/18 | CONSTRUCTION DOCUMENTS | 2ND AND 3RD FLOOR RENOVATIONS | approved by |
| | 5/23/18 | | DANBURY, CONNECTICUT | AL |
| | 7/25/18 | | | drawing no. |
| | | | CAD no. | project no. |
| | | | | BI-RD-299 |
| | | | | A5.02 |

ROOM FINISH SCHEDULE

Main table with columns: NO., ROOM NAME, FLOOR, BASE, WALL (NORTH, EAST, SOUTH, WEST), CEILING (MATERIAL, HEIGHT), NOTES, NO.

ROOM FINISH LEGEND - BASIS OF DESIGN

Legend table with categories: CEILING TILE, CARPET, CERAMIC TILE, VINYL COMPOSITION TILE, BASE, SOLID SURFACE TOILET PARTITION

PAINT KEY - BASIS OF DESIGN

Table with columns: LOCATION, MANF, COLOR, FINISH. Includes paint manufacturer info (PITT = PITTSBURGH PAINT, P&L = PRATT & LAMBERT) and a list of 7 notes.

NOTES:


- 1. TOUCH PAINT AT DAMAGED AREAS FROM CONSTRUCTION. PAINT TO NEAREST CUT OFF/ CORNER POINT.
2. REMOVE EXISTING ACT TO INSTALL NEW MEP WORK. REINSTALL TILES - 25% TO BE NEW TILES TO REPLACE ANY DAMAGED TILES.
3. PROVIDE (2) 4'X8' WHITEBOARDS. COORDINATE LOCATION WITH OWNER.

Table with drawing title (THIRD FLOOR ROOM FINISH SCHEDULE), drawing prepared by (AMES & WHITAKER ARCHITECTS), project (WESTERN CT STATE UNIVERSITY), and drawing no. (A6.02).


DOOR SCHEDULE

| NO. | LOCATION | SIZE | DOOR | | | | | FRAME | | | | | | NOTES | NO. | |
|------|--|-------------------------------|----------|----------|--------|---------|----------|----------|----------|--------|----------|------|------|-------|----------------------------------|------|
| | | | TYPE | MATL | FINISH | GLAZING | RATING | TYPE | MATL | FINISH | RATING | HEAD | JAMB | | | SILL |
| 301 | FROM CLASSROOM 301 TO CORRIDOR 398A | 3'-0"x7'-0"x1 $\frac{3}{4}$ " | NL | WD | STAIN | D-20 | 20 MIN. | F-1 | H.M. | PT | 20 MIN. | H-2 | J-2 | S-1 | SEE NOTE 1, 3 | 301 |
| 310 | FROM IDF ROOM 310 TO CORRIDOR 398C | EXISTING | EXISTING | EXISTING | PT | | EXISTING | EXISTING | EXISTING | PT | EXISTING | - | - | - | SEE NOTE 2 | 310 |
| 311 | FROM WOMEN'S 311 TO CORRIDOR 398C | 3'-0"x7'-0"x1 $\frac{3}{4}$ " | LV | WD | STAIN | ---- | 20 MIN. | F-1 | H.M. | PT | 20 MIN. | H-2 | J-2 | S-1 | SEE NOTE 3, AND MARBLE THRESHOLD | 311 |
| 314B | FROM CLASSROOM 314B TO CORRIDOR 398C | 3'-0"x7'-0"x1 $\frac{3}{4}$ " | NL | WD | STAIN | D-20 | 20 MIN. | F-1 | H.M. | PT | 20 MIN. | H-2 | J-2 | S-1 | SEE NOTE 1, 3 | 314B |
| 322A | FROM CONFERENCE ROOM 322A TO CORRIDOR 398B | 3'-0"x7'-0"x1 $\frac{3}{4}$ " | | WD | STAIN | | 20 MIN. | F-1 | H.M. | PT | 20 MIN. | H-2 | J-2 | S-1 | SEE NOTE 3 | 322A |
| 325 | FROM CORRIDOR 325 TO CORRIDOR 398B | 3'-0"x7'-0"x1 $\frac{3}{4}$ " | NL | WD | STAIN | ---- | 20 MIN. | F-1 | H.M. | PT | 20 MIN. | H-2 | J-2 | S-1 | SEE NOTE 1, 3 | 325 |
| 325A | FROM OFFICE 325A TO CORRIDOR 325 | 3'-0"x7'-0"x1 $\frac{3}{4}$ " | F | WD | STAIN | ---- | 20 MIN. | F-1 | H.M. | PT | 20 MIN. | H-1 | J-1 | S-1 | | 325A |
| 325B | FROM OFFICE 325B TO CORRIDOR 325 | 3'-0"x7'-0"x1 $\frac{3}{4}$ " | F | WD | STAIN | ---- | 20 MIN. | F-1 | H.M. | PT | 20 MIN. | H-1 | J-1 | S-1 | | 325B |
| 325C | FROM OFFICE 325C TO CORRIDOR 325 | 3'-0"x7'-0"x1 $\frac{3}{4}$ " | F | WD | STAIN | ---- | 20 MIN. | F-1 | H.M. | PT | 20 MIN. | H-1 | J-1 | S-1 | | 325C |
| 325D | FROM OFFICE 325D TO CORRIDOR 325 | 3'-0"x7'-0"x1 $\frac{3}{4}$ " | F | WD | STAIN | ---- | 20 MIN. | F-1 | H.M. | PT | 20 MIN. | H-1 | J-1 | S-1 | | 325D |
| 328 | FROM MEN'S TOILET 328 TO CORRIDOR 398B | 3'-0"x7'-0"x1 $\frac{3}{4}$ " | LV | WD | STAIN | ---- | 20 MIN. | F-1 | H.M. | PT | 20 MIN. | H-2 | J-2 | S-1 | SEE NOTE 3, AND MARBLE THRESHOLD | 328 |
| 329 | FROM OFFICE 329 TO CORRIDOR 398B | 3'-0"x7'-0"x1 $\frac{3}{4}$ " | NL | WD | STAIN | ---- | 20 MIN. | F-1 | H.M. | PT | 20 MIN. | H-2 | J-2 | S-1 | SEE NOTE 1, 3 | 329 |
| 329A | FROM OFFICE 329A TO OFFICE 329 | 3'-0"x7'-0"x1 $\frac{3}{4}$ " | F | WD | STAIN | ---- | 20 MIN. | F-1 | H.M. | PT | 20 MIN. | H-1 | J-1 | S-1 | | 329A |
| 329B | FROM OFFICE 329B TO OFFICE 329 | 3'-0"x7'-0"x1 $\frac{3}{4}$ " | F | WD | STAIN | ---- | 20 MIN. | F-1 | H.M. | PT | 20 MIN. | H-1 | J-1 | S-1 | | 329B |
| 329C | FROM OFFICE 329C TO OFFICE 329 | 3'-0"x7'-0"x1 $\frac{3}{4}$ " | F | WD | STAIN | ---- | 20 MIN. | F-1 | H.M. | PT | 20 MIN. | H-1 | J-1 | S-1 | | 329C |
| 329D | FROM OFFICE 329D TO OFFICE 329 | 3'-0"x7'-0"x1 $\frac{3}{4}$ " | F | WD | STAIN | ---- | 20 MIN. | F-1 | H.M. | PT | 20 MIN. | H-1 | J-1 | S-1 | | 329D |
| 330 | FROM STORAGE 330 TO CORRIDOR 398B | EXISTING | EXISTING | EXISTING | PT | | EXISTING | EXISTING | EXISTING | PT | EXISTING | - | - | - | SEE NOTE 2 | 330 |


DOOR DETAILS

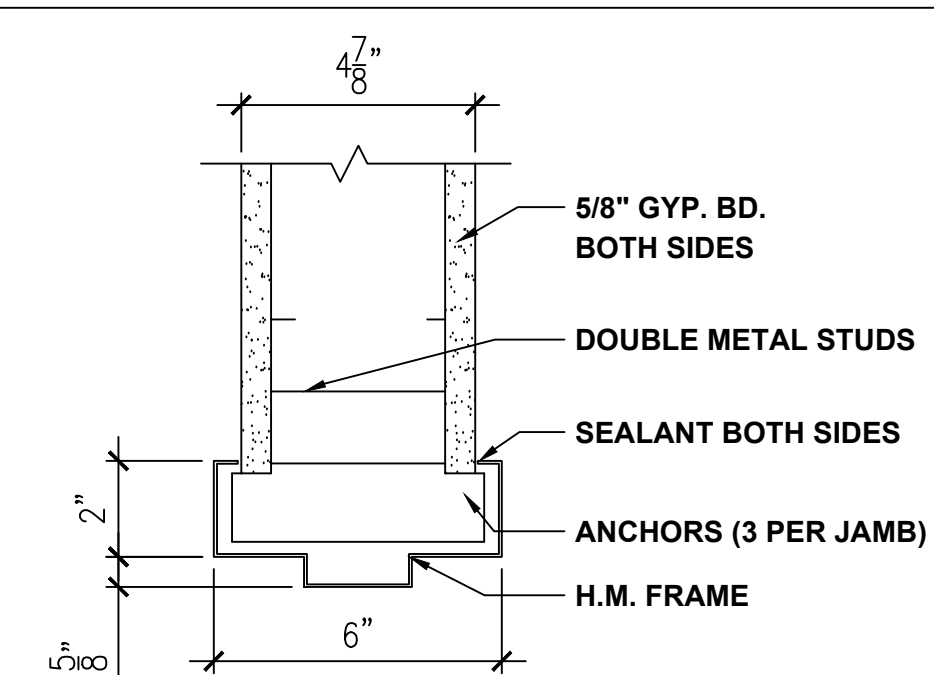


J 1

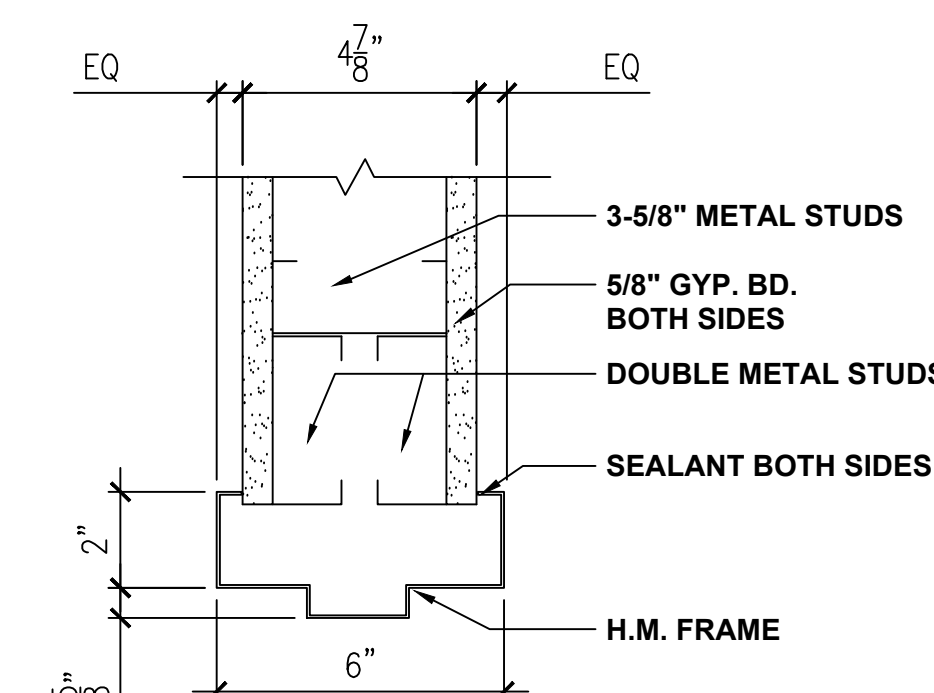

H 1

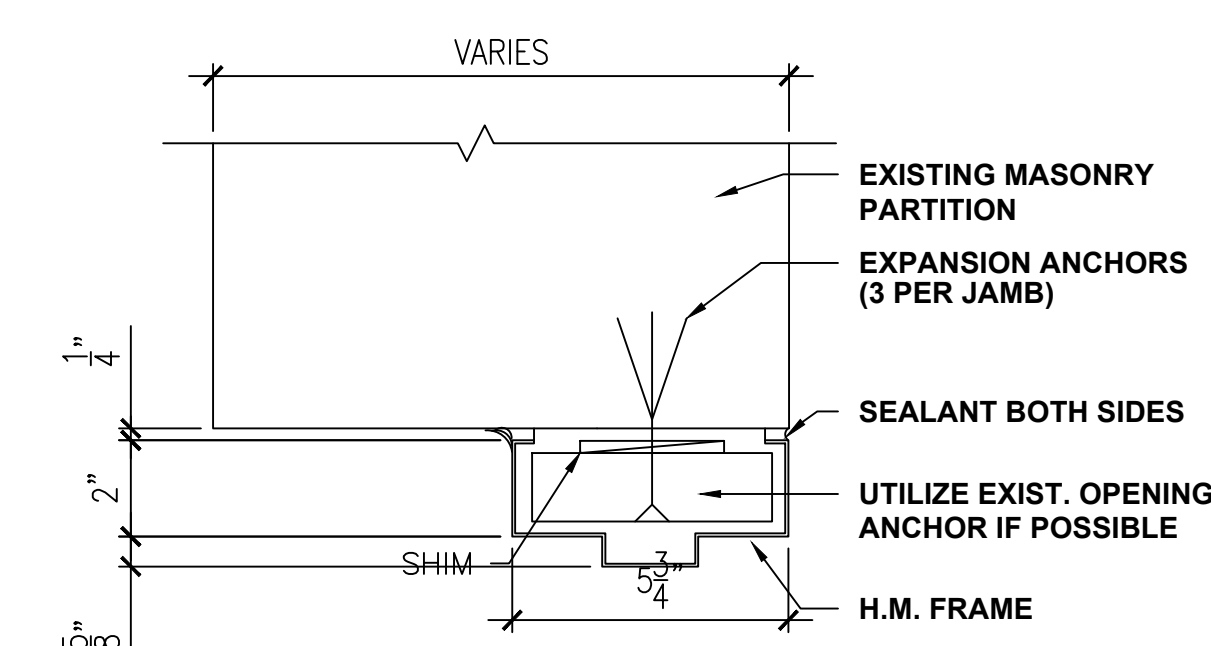


J 2

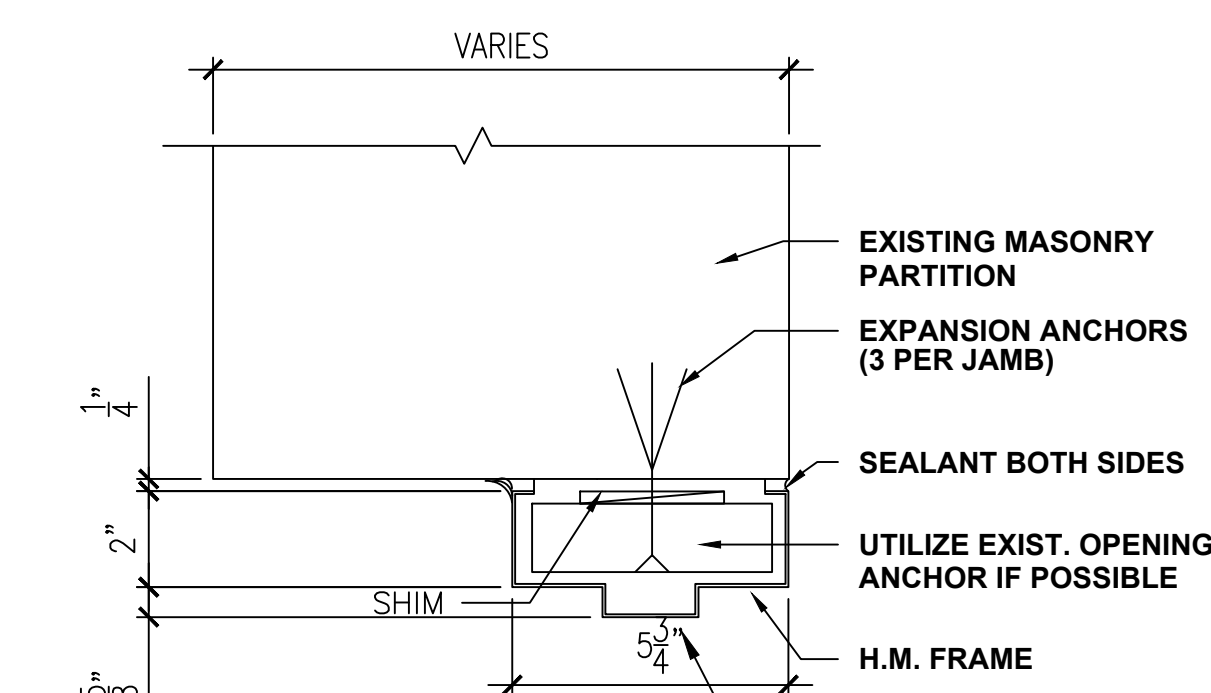



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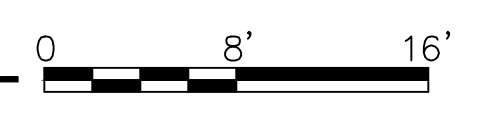
SILL DETAIL




S-1

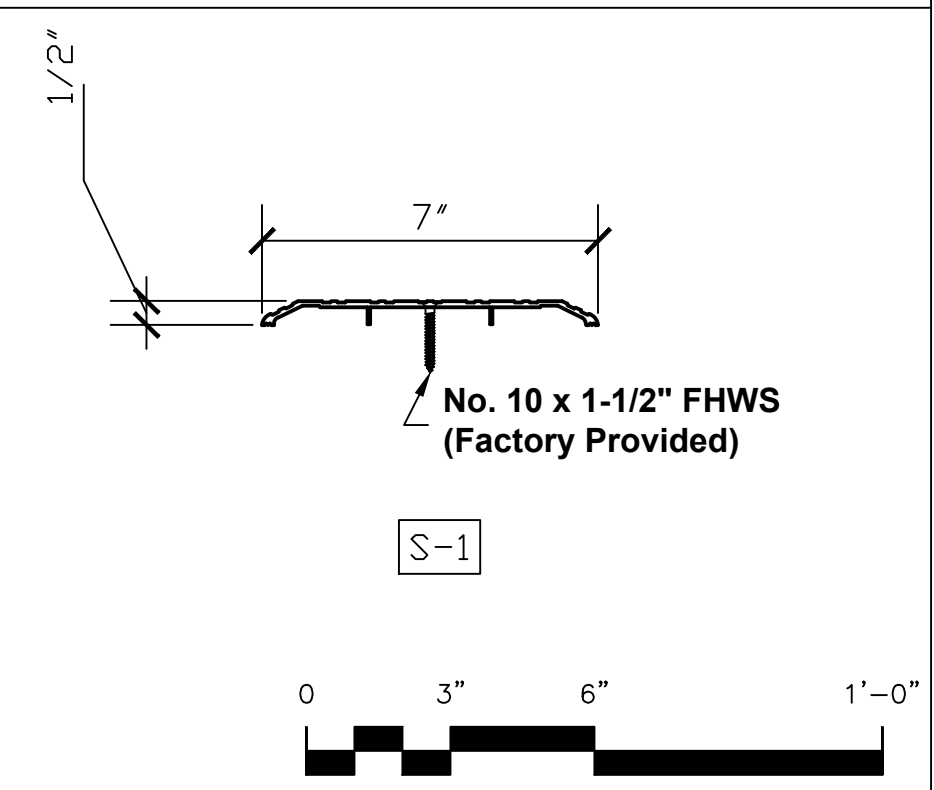


1 BASEMENT MECHANICAL ROOM PLAN
FOR PLAN OF ENTIRE FLOOR SEE SHEET EP1.00

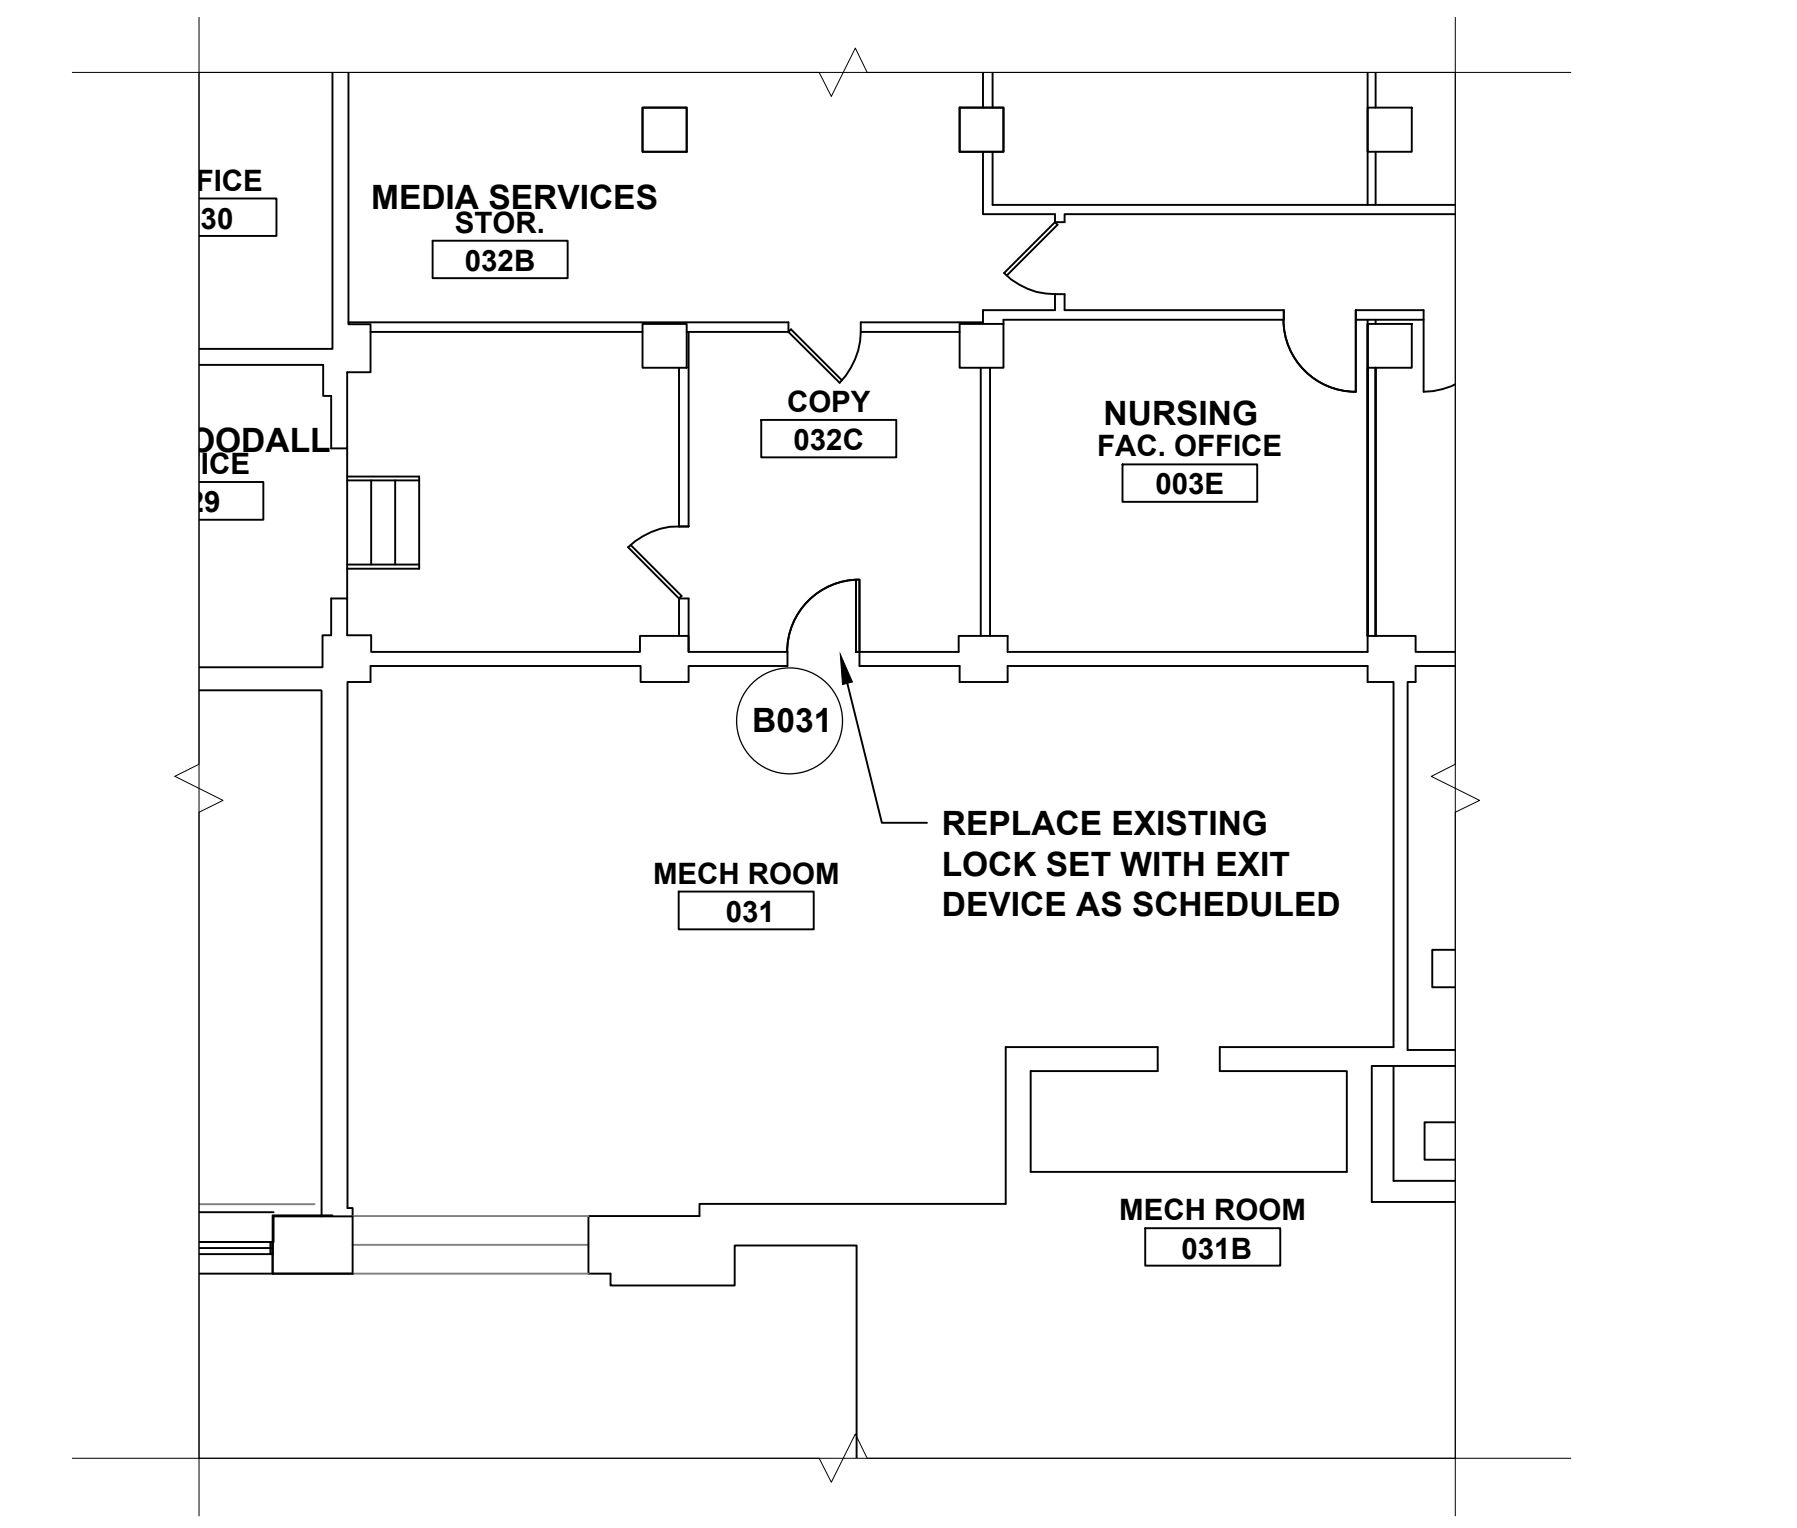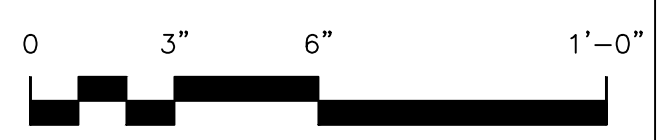

DOOR TYPES

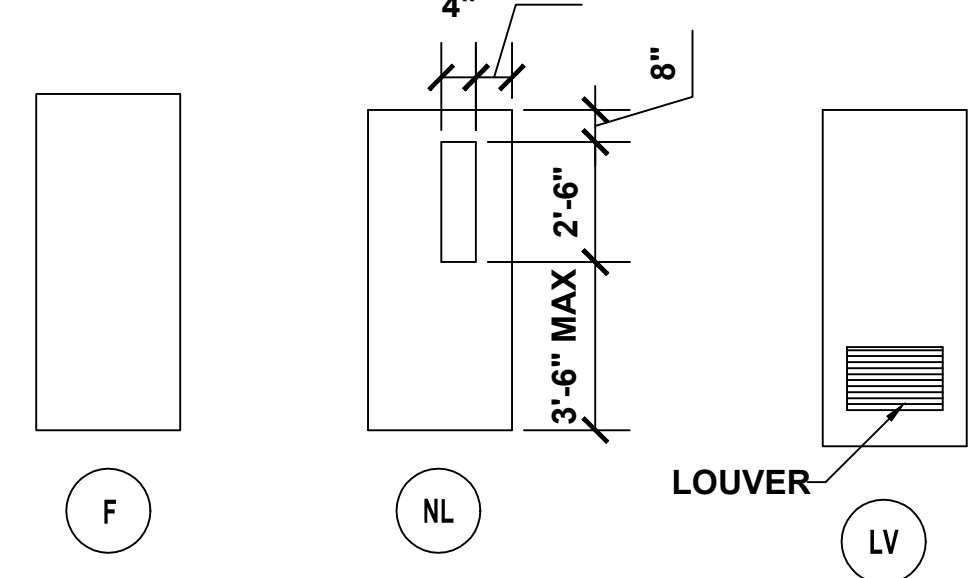


FRAME TYPES

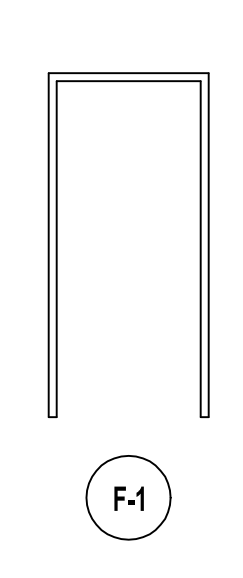


NOTES:

1. MODIFICATIONS AT EXISTING DOOR OPENINGS FOR ACCESSIBLE CLEARANCE, SEE DRAWINGS A6.05 AND A6.06.
2. EXISTING DOOR AND FRAME TO REMAIN. PAINT DOOR & FRAME THE WALL COLOR.
3. TOOTH IN BRICK WALLS AT NEW HM FRAMES, SEE DETAIL 1/A6.05
4. REFER TO PROJECT MANUAL SECTION 08 71 00 FOR DOOR HARDWARE SCHEDULE.

| | | | | | |
|---|----------|-------------------------------|--|-------------|-------------|
| drawing title THIRD FLOOR DOOR SCHEDULE | | | STATE OF CONNECTICUT DEPARTMENT OF ADMINISTRATIVE SERVICES | | |
| REVISIONS | | | | | |
| mark | date | description | drawing prepared by | date | scale |
| | 8/4/17 | SCHEMATIC DESIGN SUBMISSION | AMES & WHITAKER ARCHITECTS 31 LIBERTY STREET SOUTHINGTON, CT | 07/25/18 | AS NOTED |
| | 1/15/18 | DESIGN DEVELOPMENT SUBMISSION | | | |
| | 4/16/18 | CONSTRUCTION DOCUMENTS | project | | |
| | 5/23/18 | | WESTERN CT STATE UNIVERSITY | | drawn by |
| | 7/25/18 | | WHITE HALL | | approved by |
| | 10/11/18 | | 2ND AND 3RD FLOOR RENOVATIONS | | AL |
| | | | DANBURY, CONNECTICUT | | drawing no. |
| | | | CAD no. | project no. | A6.04 |
| | | | | BI-RD-299 | |

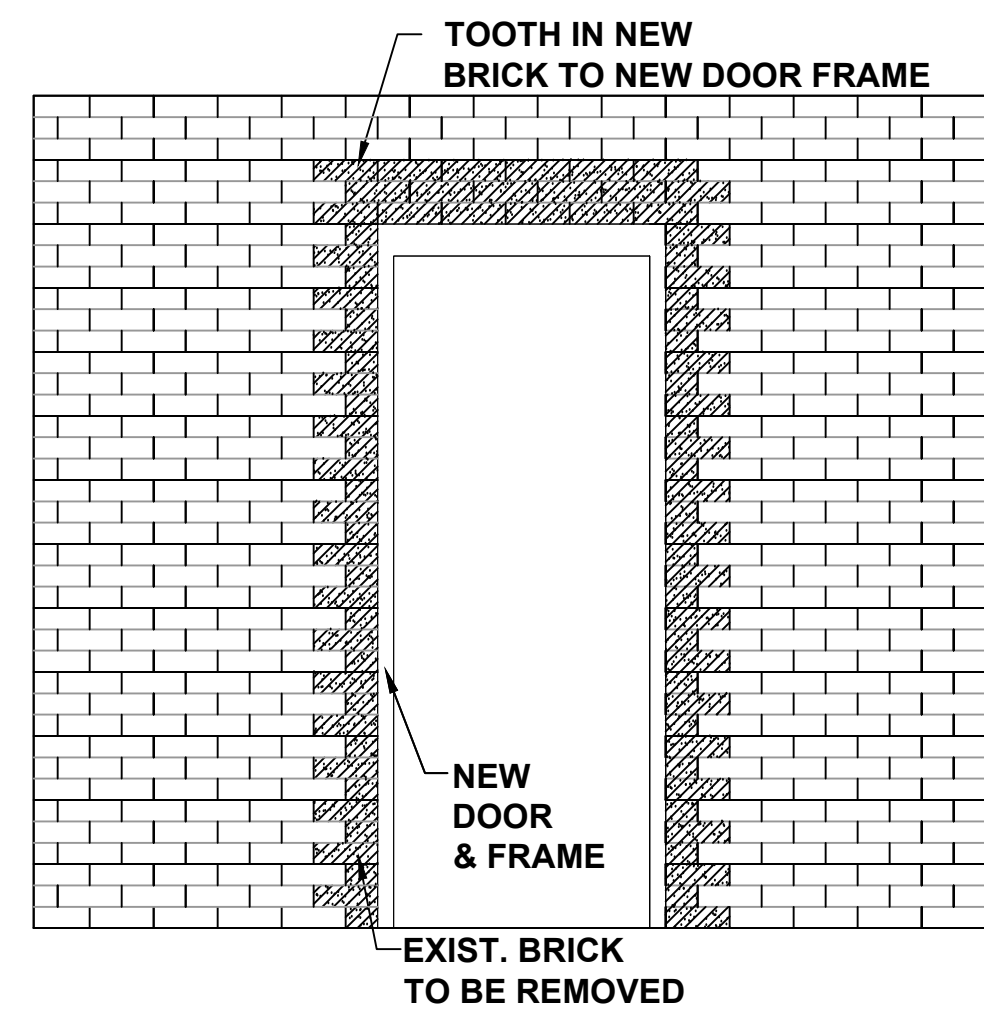


1 NEW DOOR AND FRAME IN EXISTING MASONRY WALL

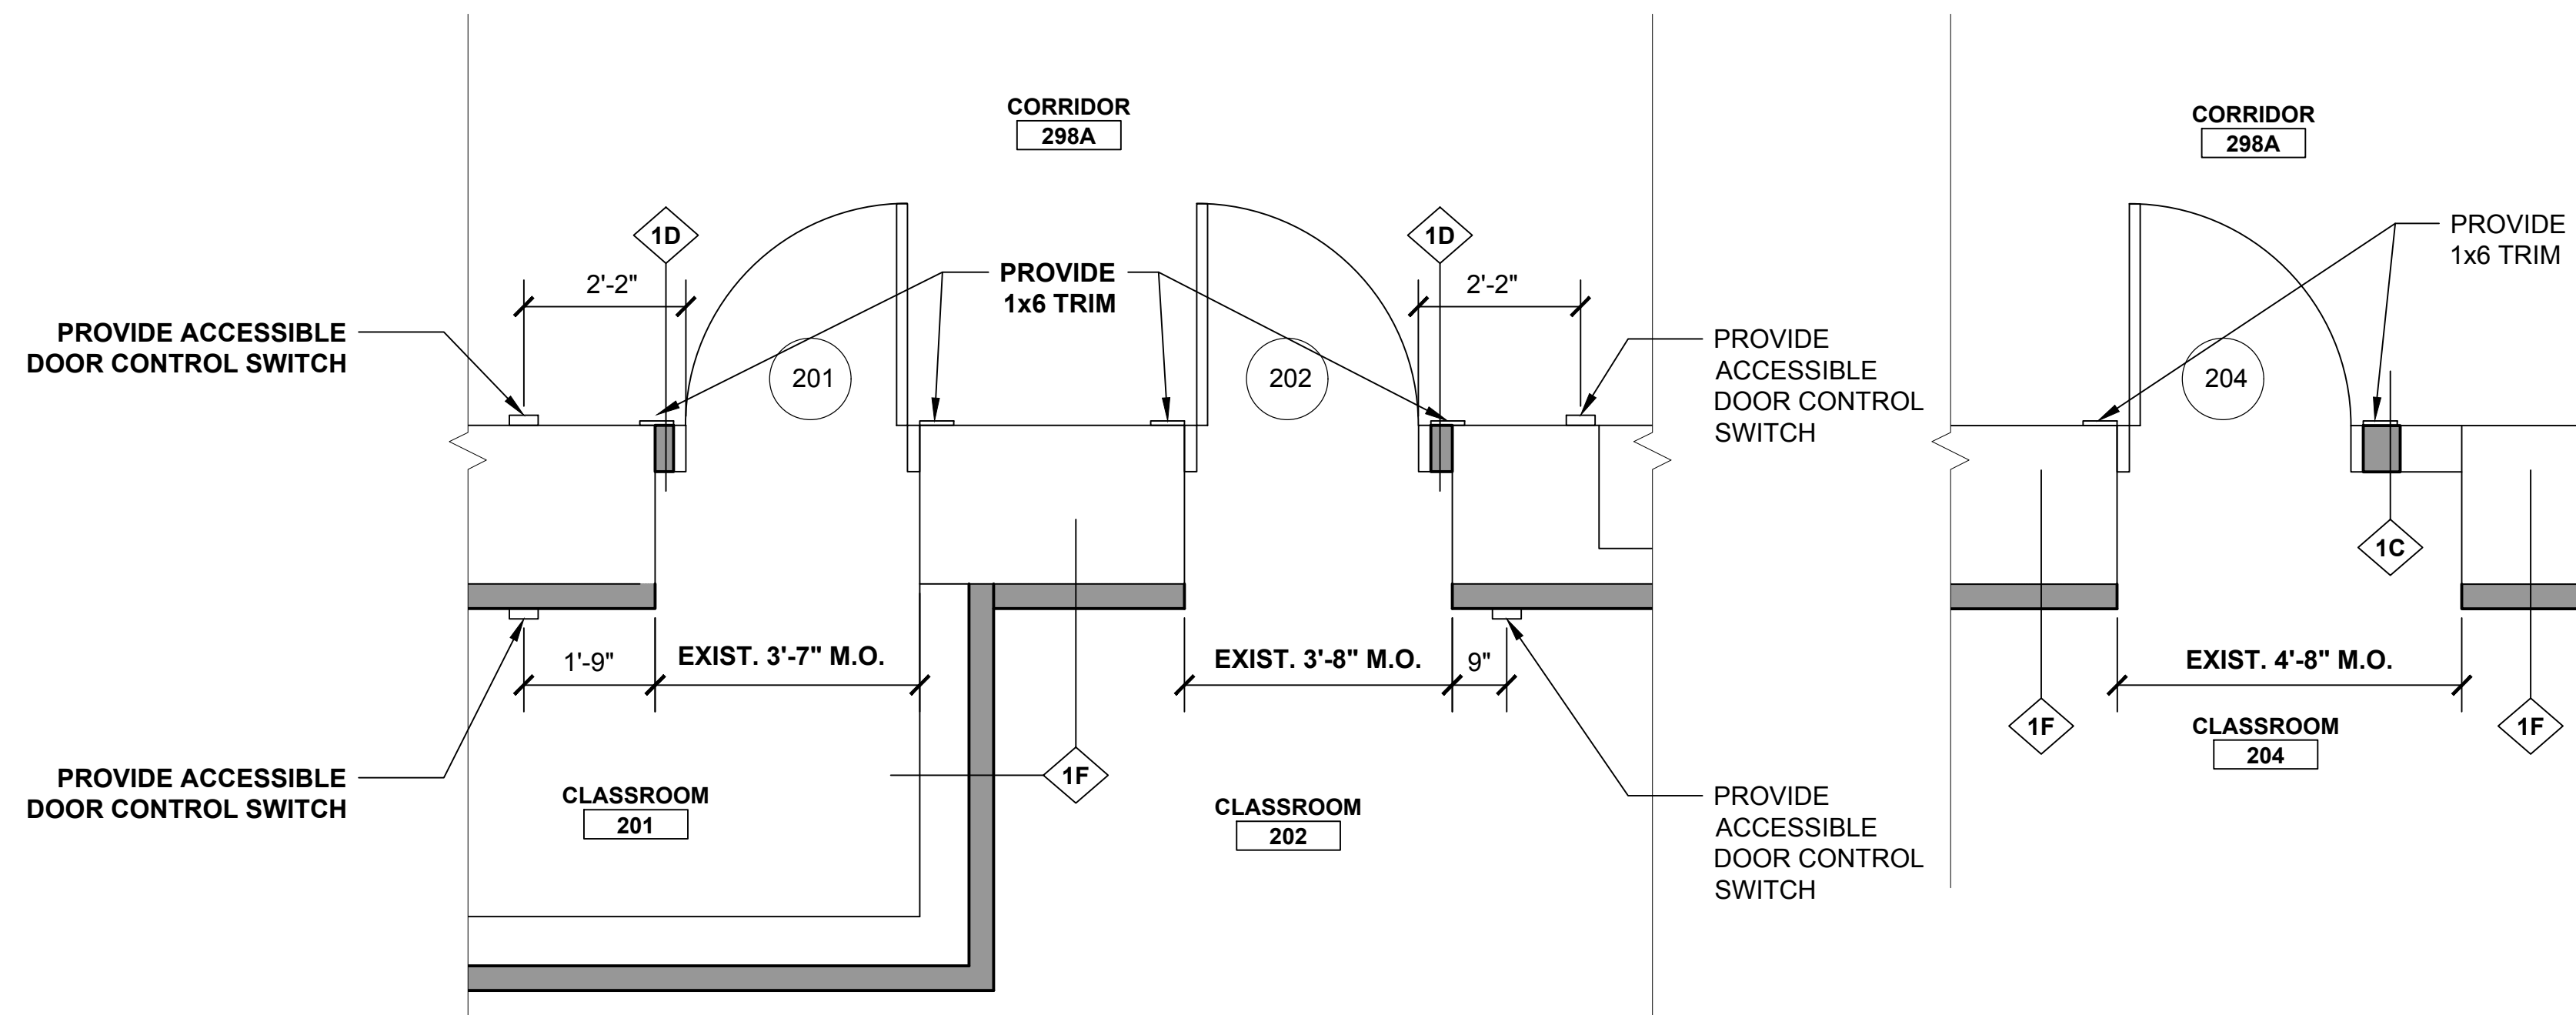


2 DETAIL PLAN AT DOORS 201 & 202

PROVIDE ACCESSIBLE POWER DOOR SWITCH


3 DETAIL PLAN AT DOOR 204

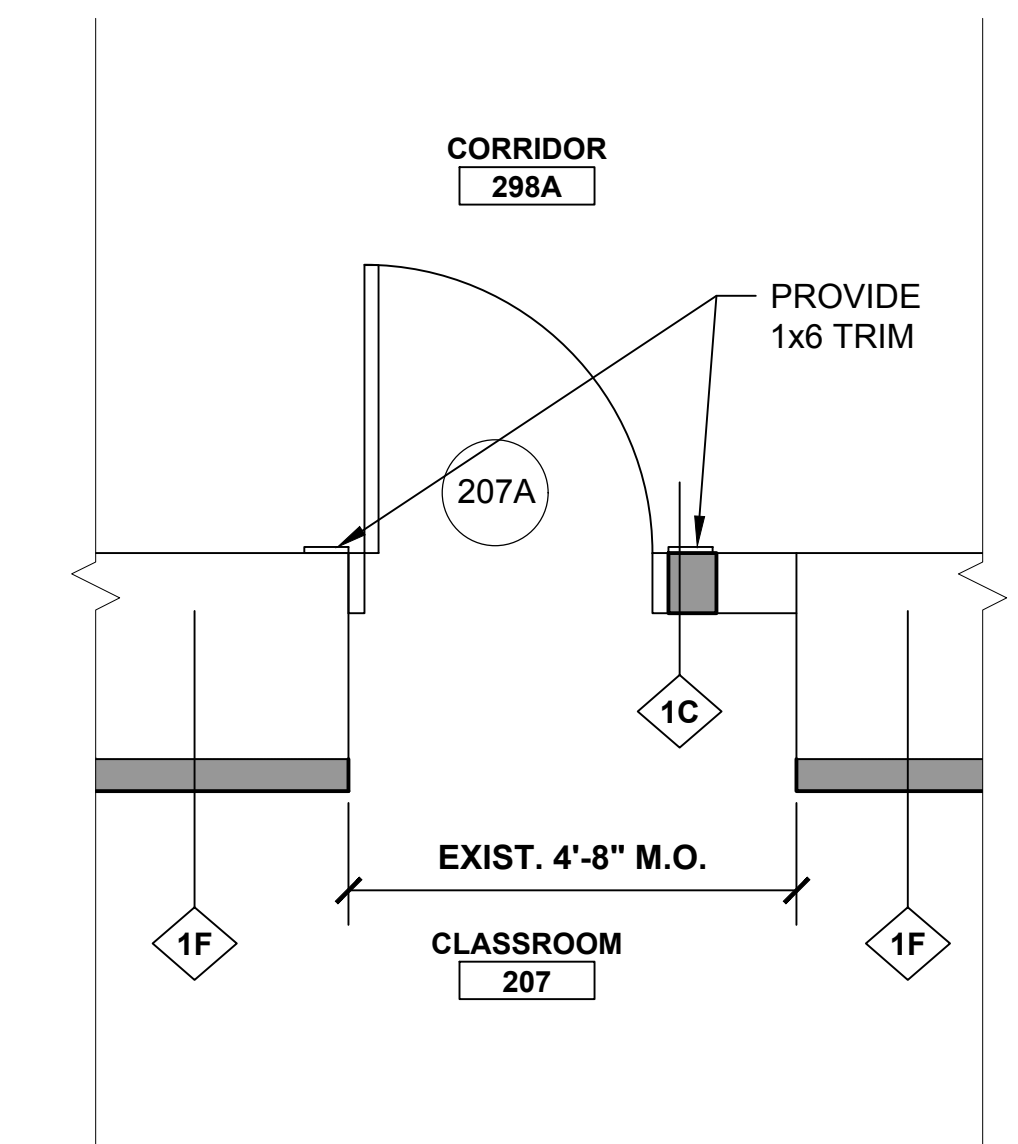


4 DETAIL PLAN AT DOOR 207A

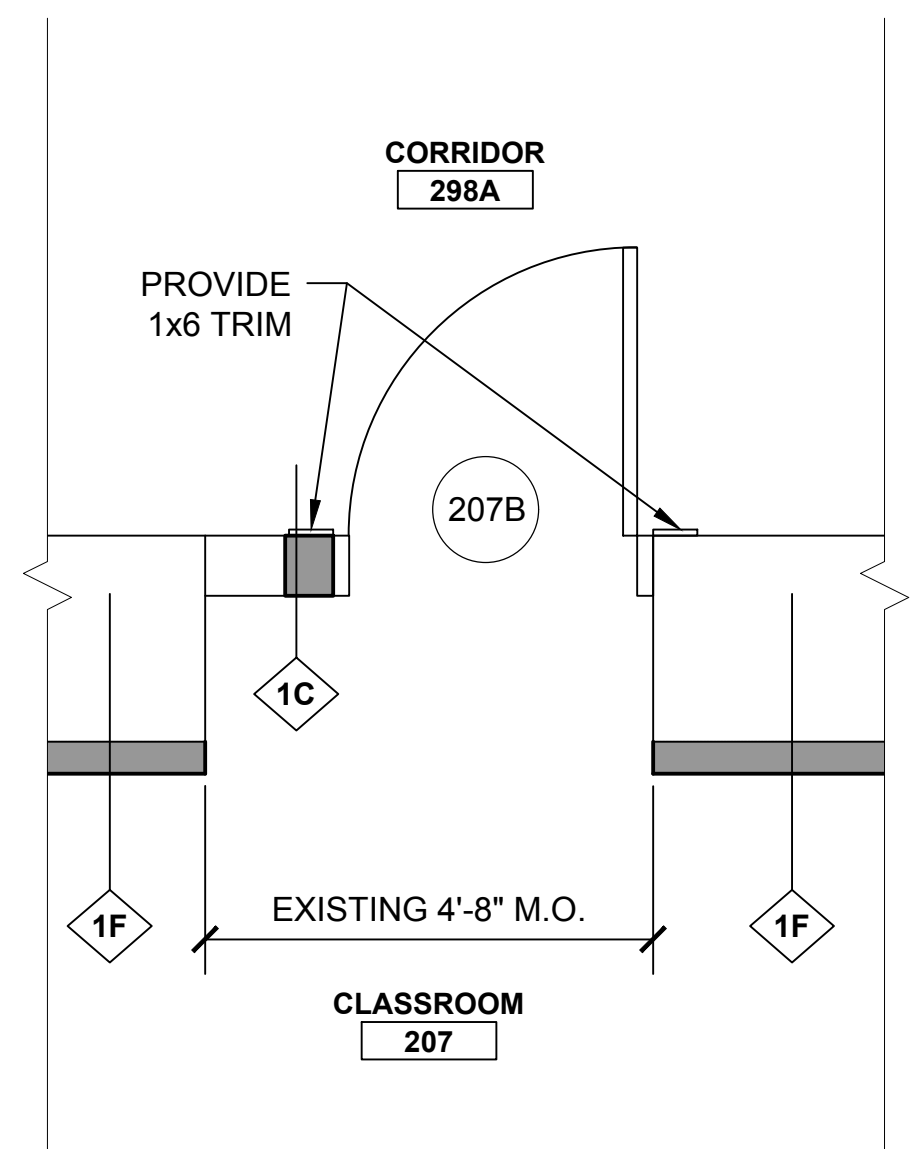


5 DETAIL PLAN AT DOOR 207B

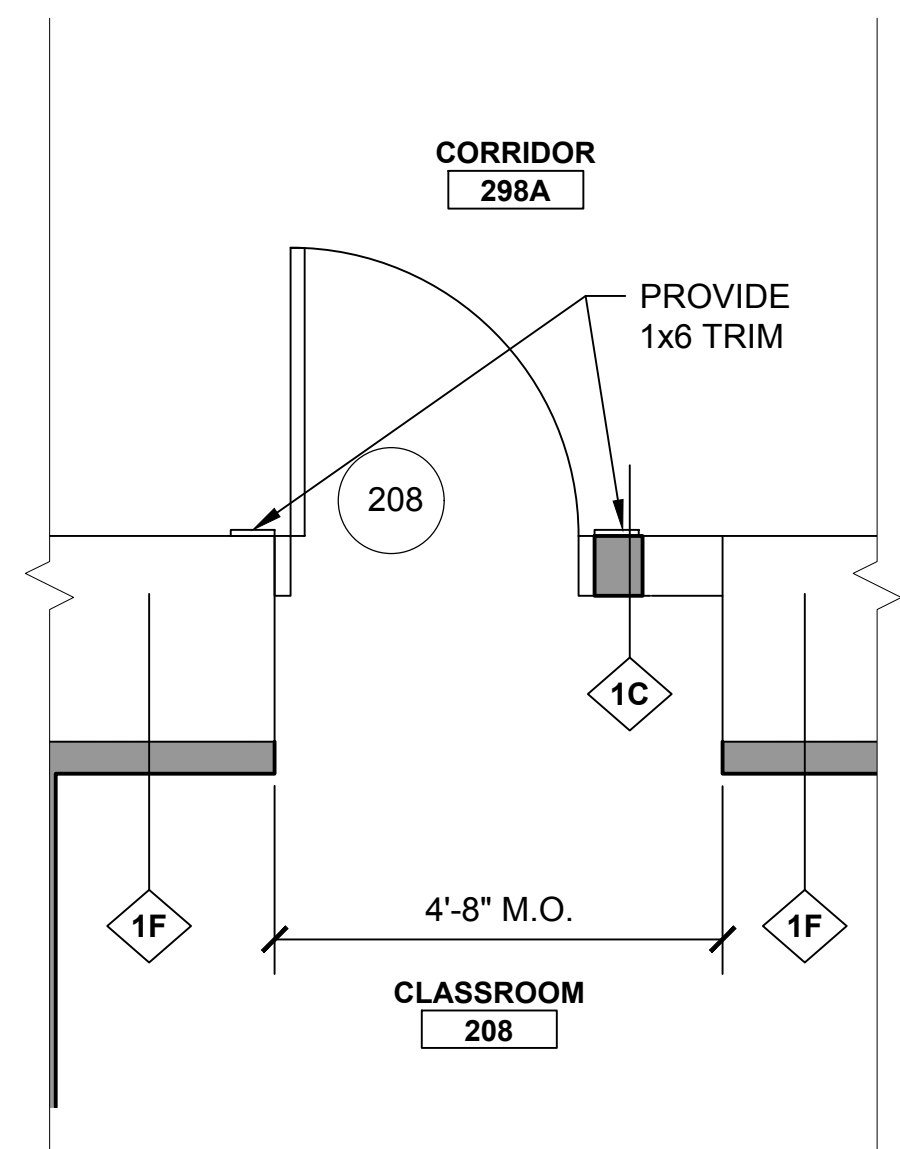


6 DETAIL PLAN AT DOOR 208

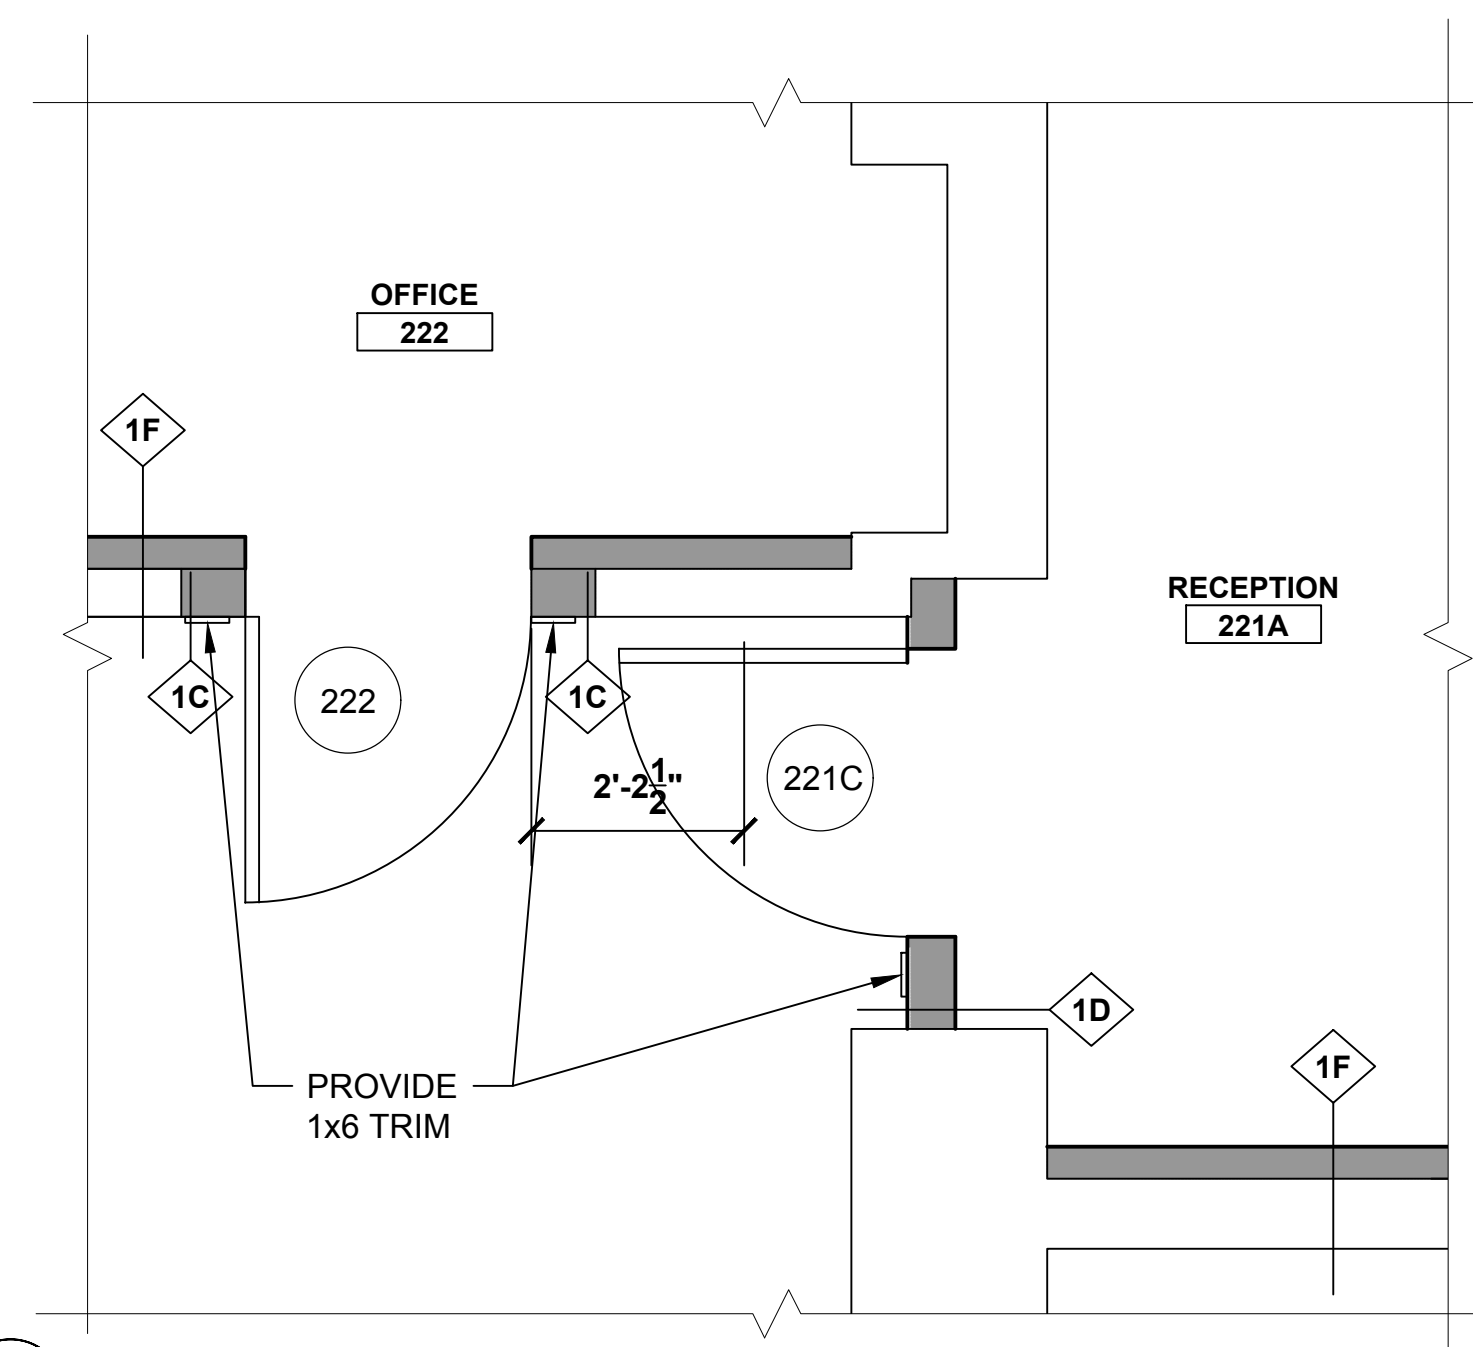

7 DETAIL PLAN AT DOORS 221C & 222

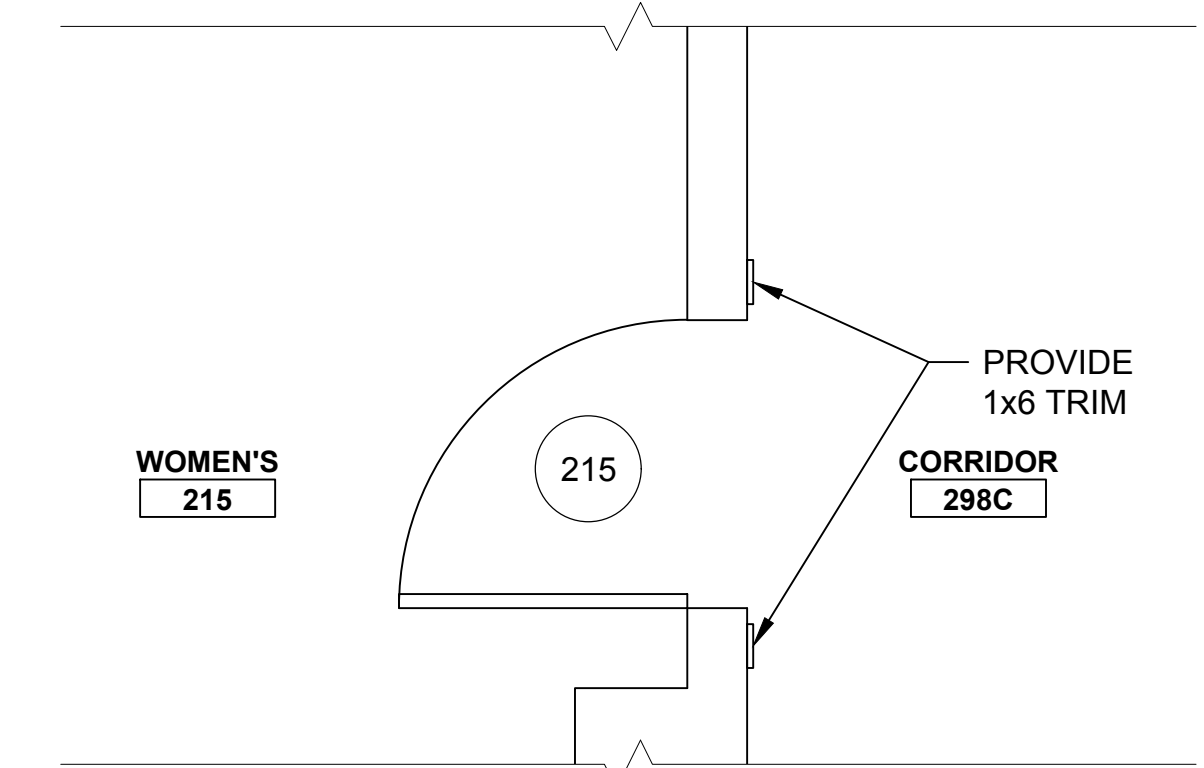


8 DETAIL PLAN AT DOOR 215

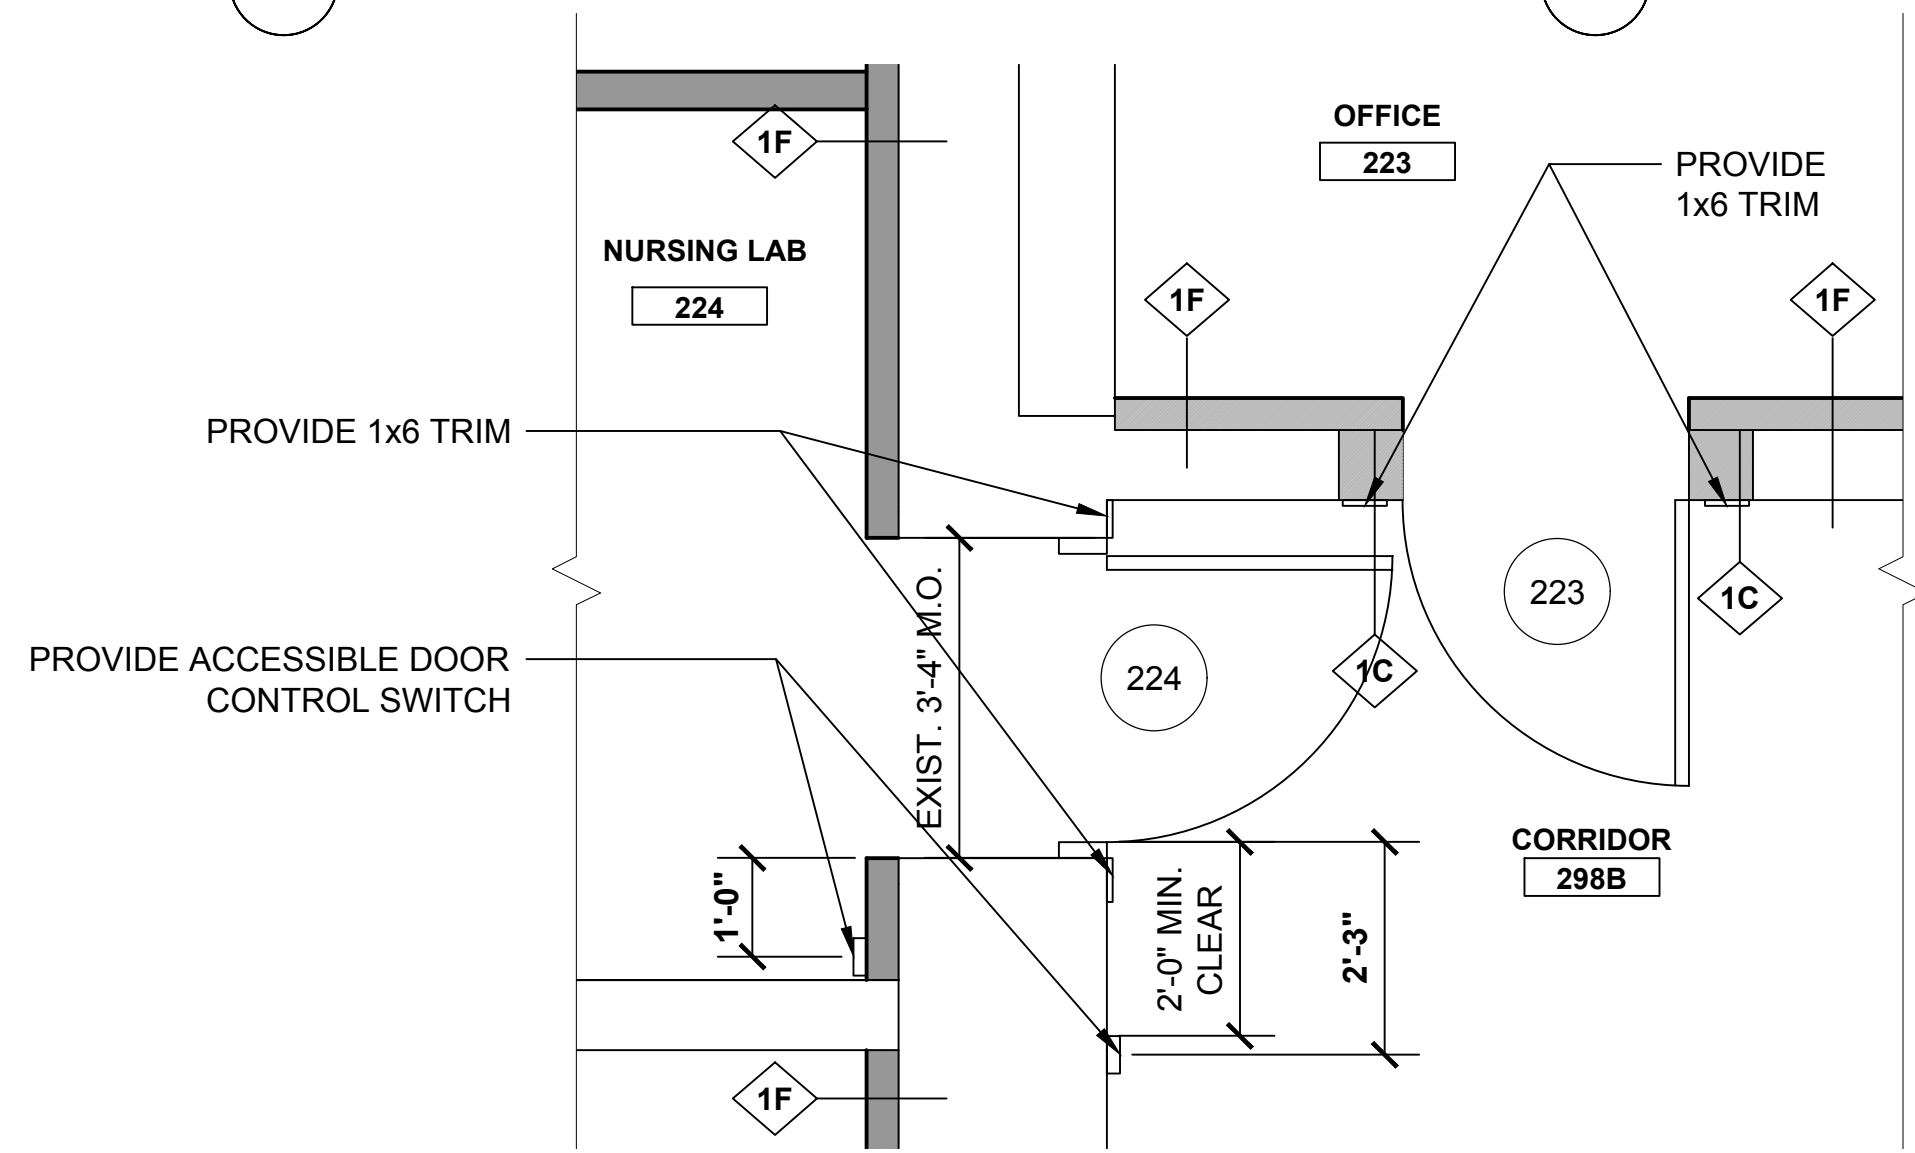

9 DETAIL PLAN AT DOOR 223 & 224

PROVIDE ACCESSIBLE POWER DOOR SWITCH AT DOOR 224

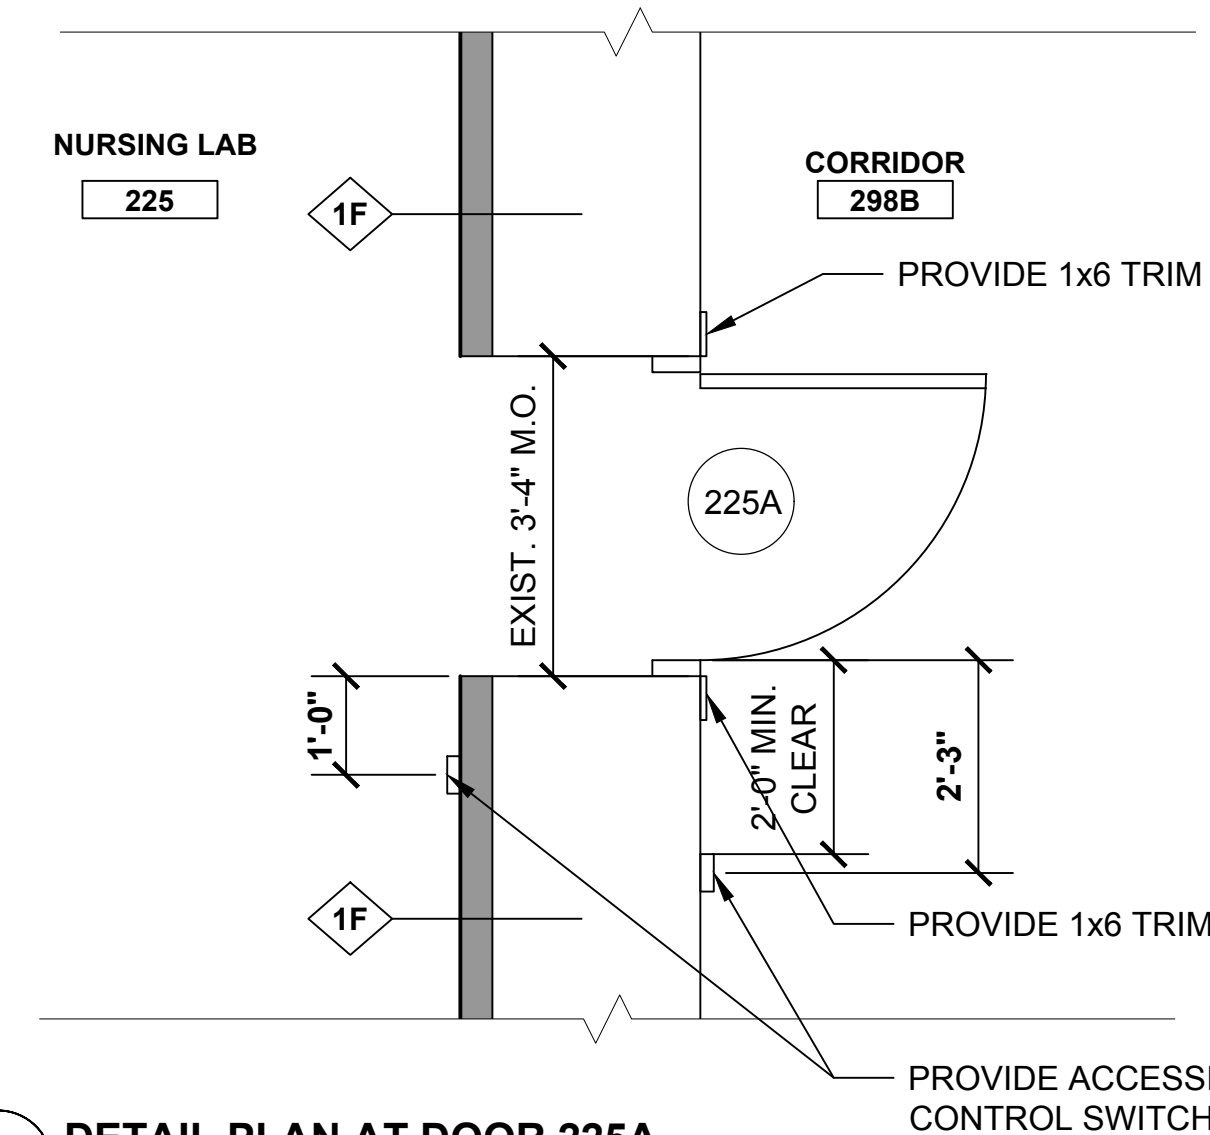


10 DETAIL PLAN AT DOOR 225A


PROVIDE ACCESSIBLE POWER DOOR SWITCH




| drawing title | | | STATE OF CONNECTICUT | |
|-----------------------|---------|-------------------------------|--|--------------------------|
| DOOR AND WALL DETAILS | | | DEPARTMENT OF ADMINISTRATIVE SERVICES | |
| REVISIONS | | | | |
| mark | date | description | drawing prepared by | date |
| | 8/4/17 | SCHEMATIC DESIGN SUBMISSION | AMES & WHITAKER ARCHITECTS 31 LIBERTY STREET SOUTHINGTON, CT | 07/25/18 |
| | 1/15/18 | DESIGN DEVELOPMENT SUBMISSION | | scale AS NOTED |
| | 4/16/18 | CONSTRUCTION DOCUMENTS | project | drawn by SP/CA |
| | 5/23/18 | | WESTERN CT STATE UNIVERSITY WHITE HALL | approved by AL |
| | 7/25/18 | | 2ND AND 3RD FLOOR RENOVATIONS | drawing no. |
| | 1/21/19 | | DANBURY, CONNECTICUT | A6.05 |
| | | | CAD no. | project no. BI-RD-299 |

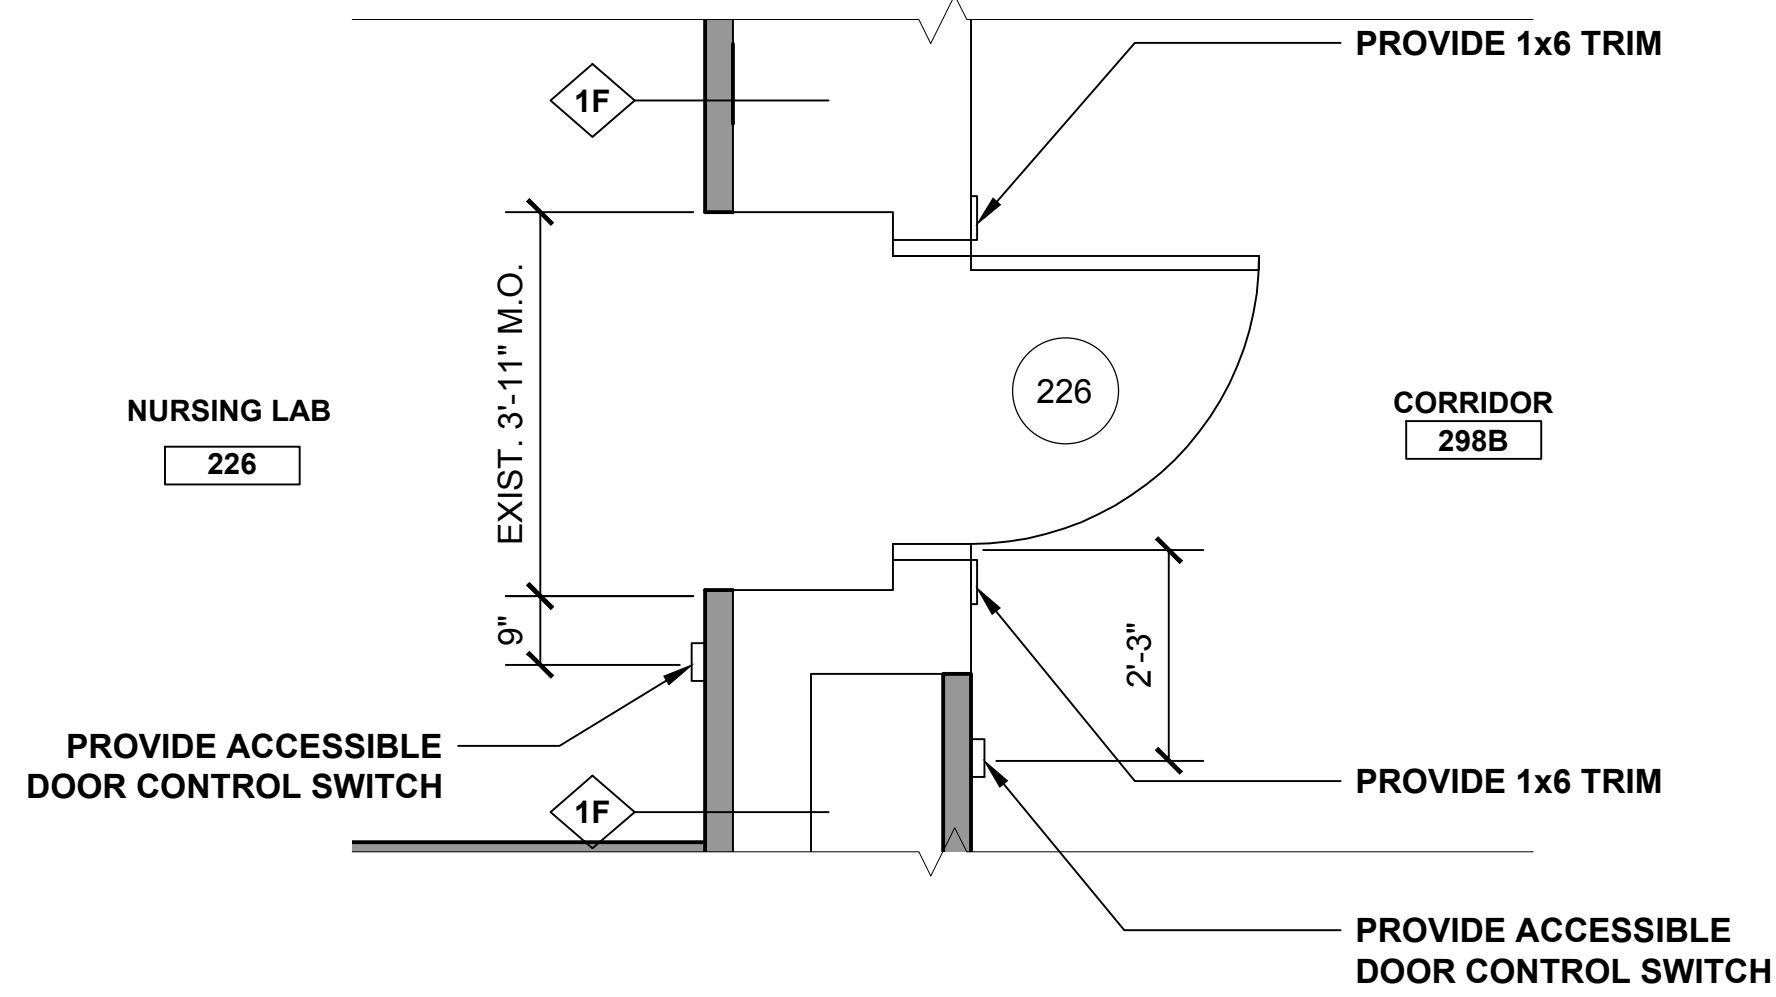


1 **DETAIL PLAN AT DOOR 226**
PROVIDE ACCESSIBLE POWER DOOR SWITCH

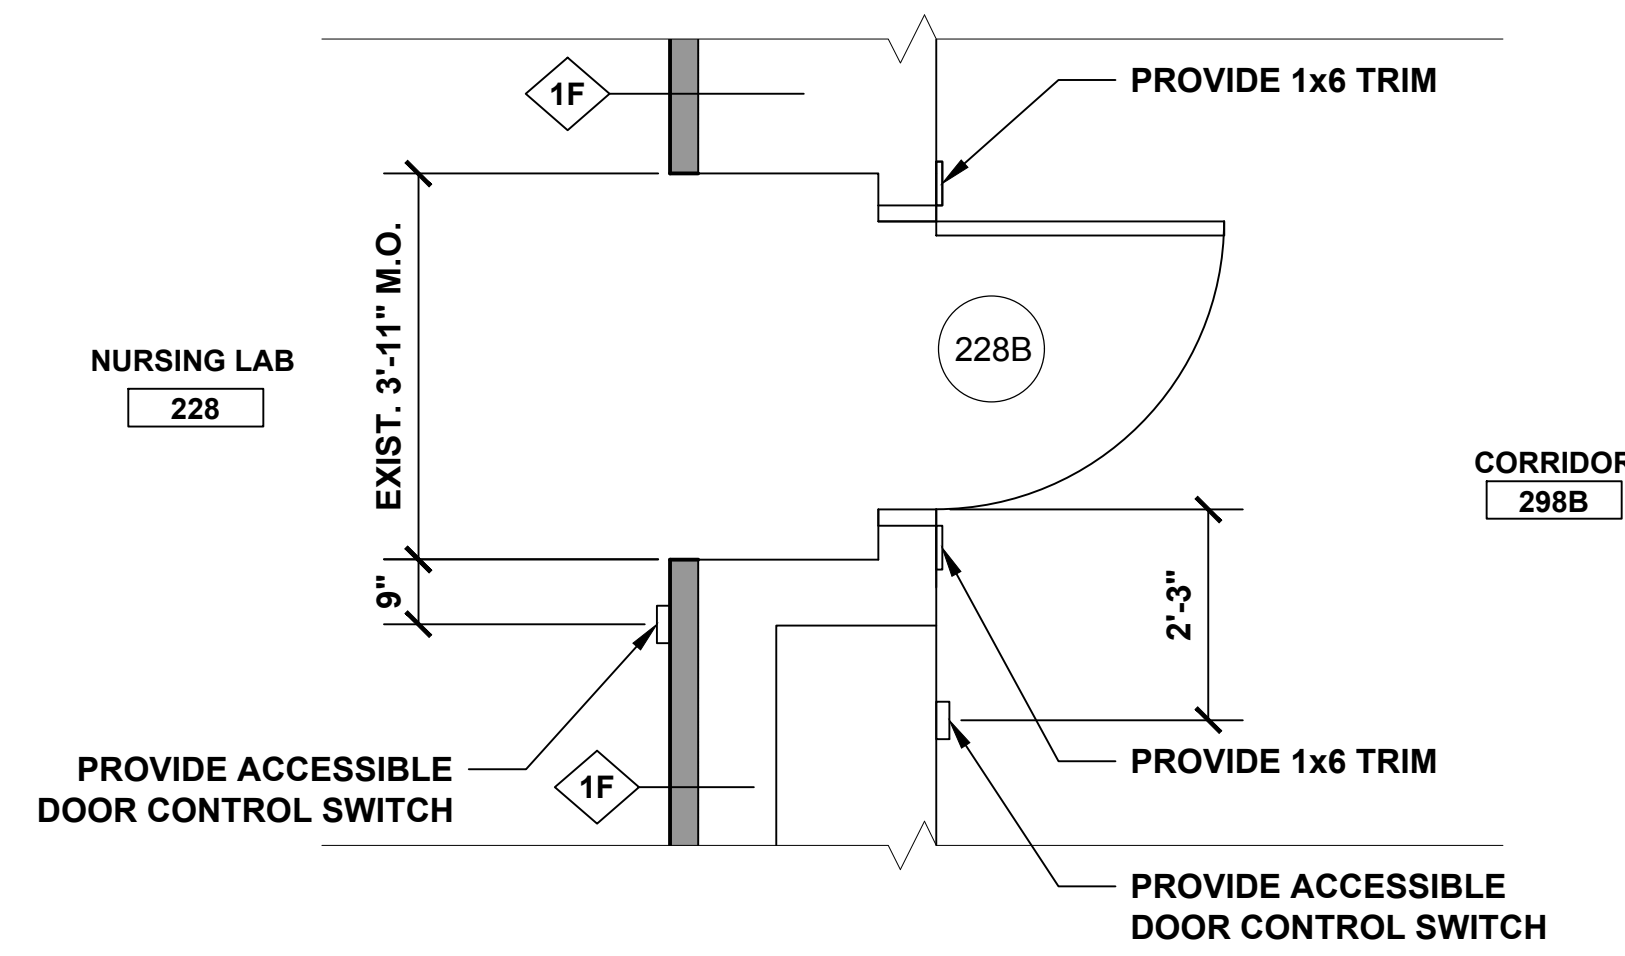


2 **DETAIL PLAN AT DOOR 228B**
PROVIDE ACCESSIBLE POWER DOOR SWITCH

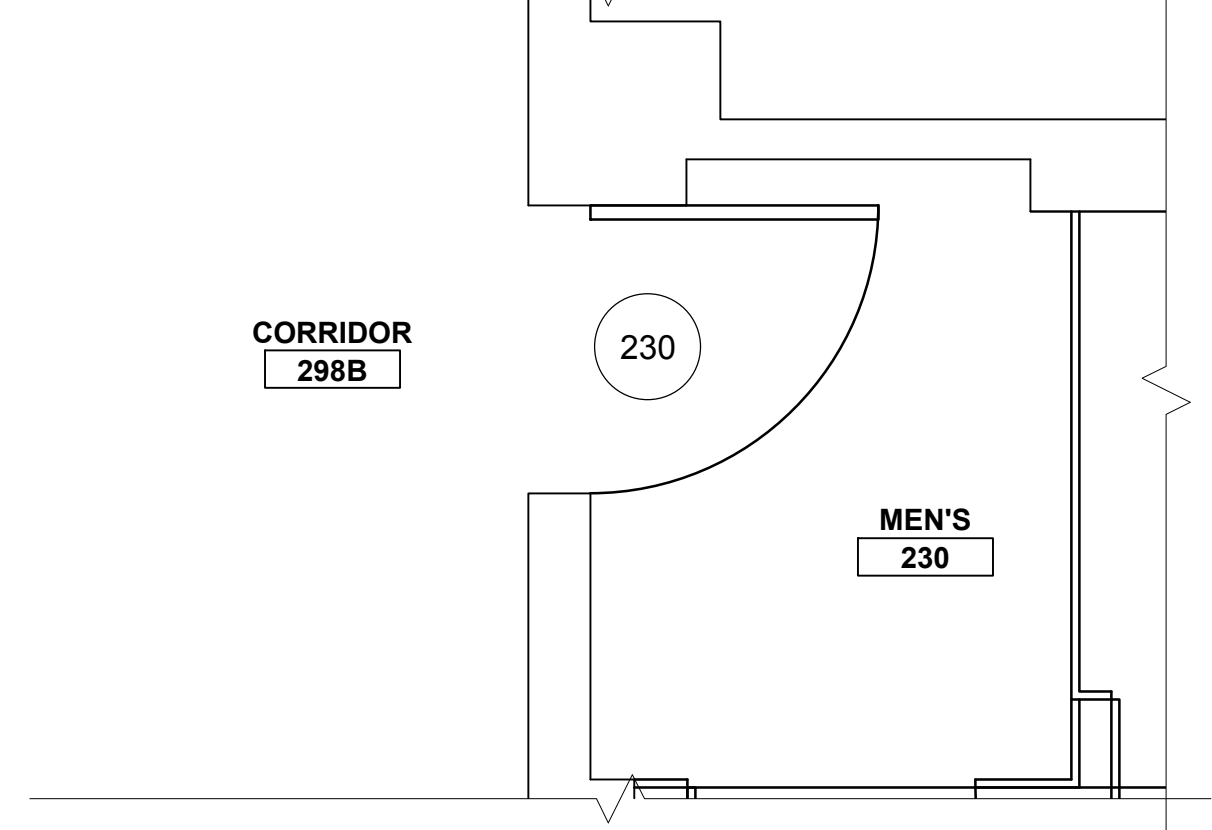


3 **DETAIL PLAN AT DOOR 230**

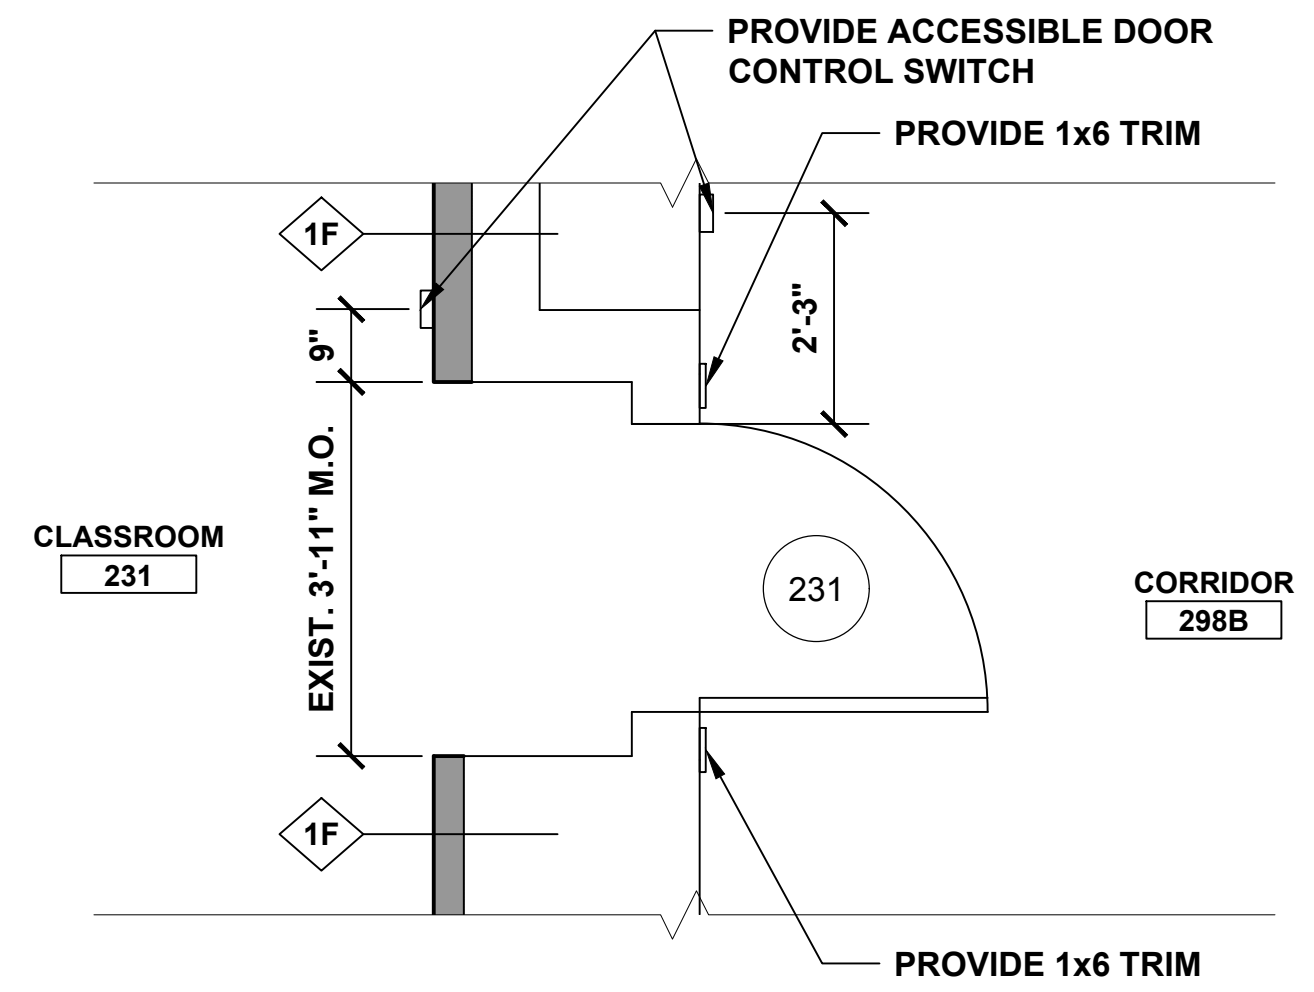


4 **DETAIL PLAN AT DOOR 231**
PROVIDE ACCESSIBLE POWER DOOR SWITCH

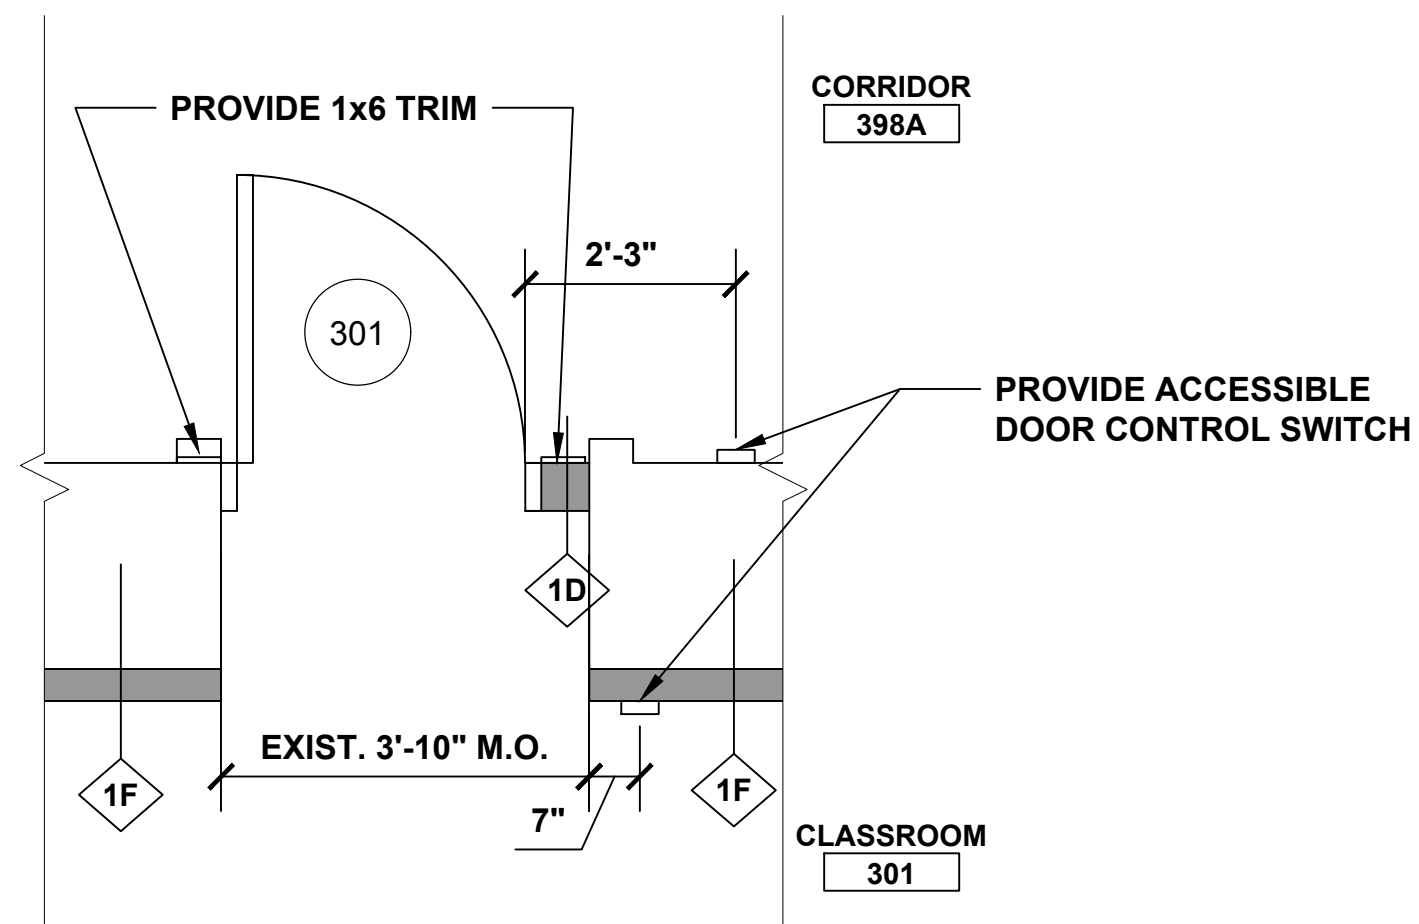


6 **DETAIL PLAN AT DOOR 301**
PROVIDE ACCESSIBLE POWER DOOR SWITCH

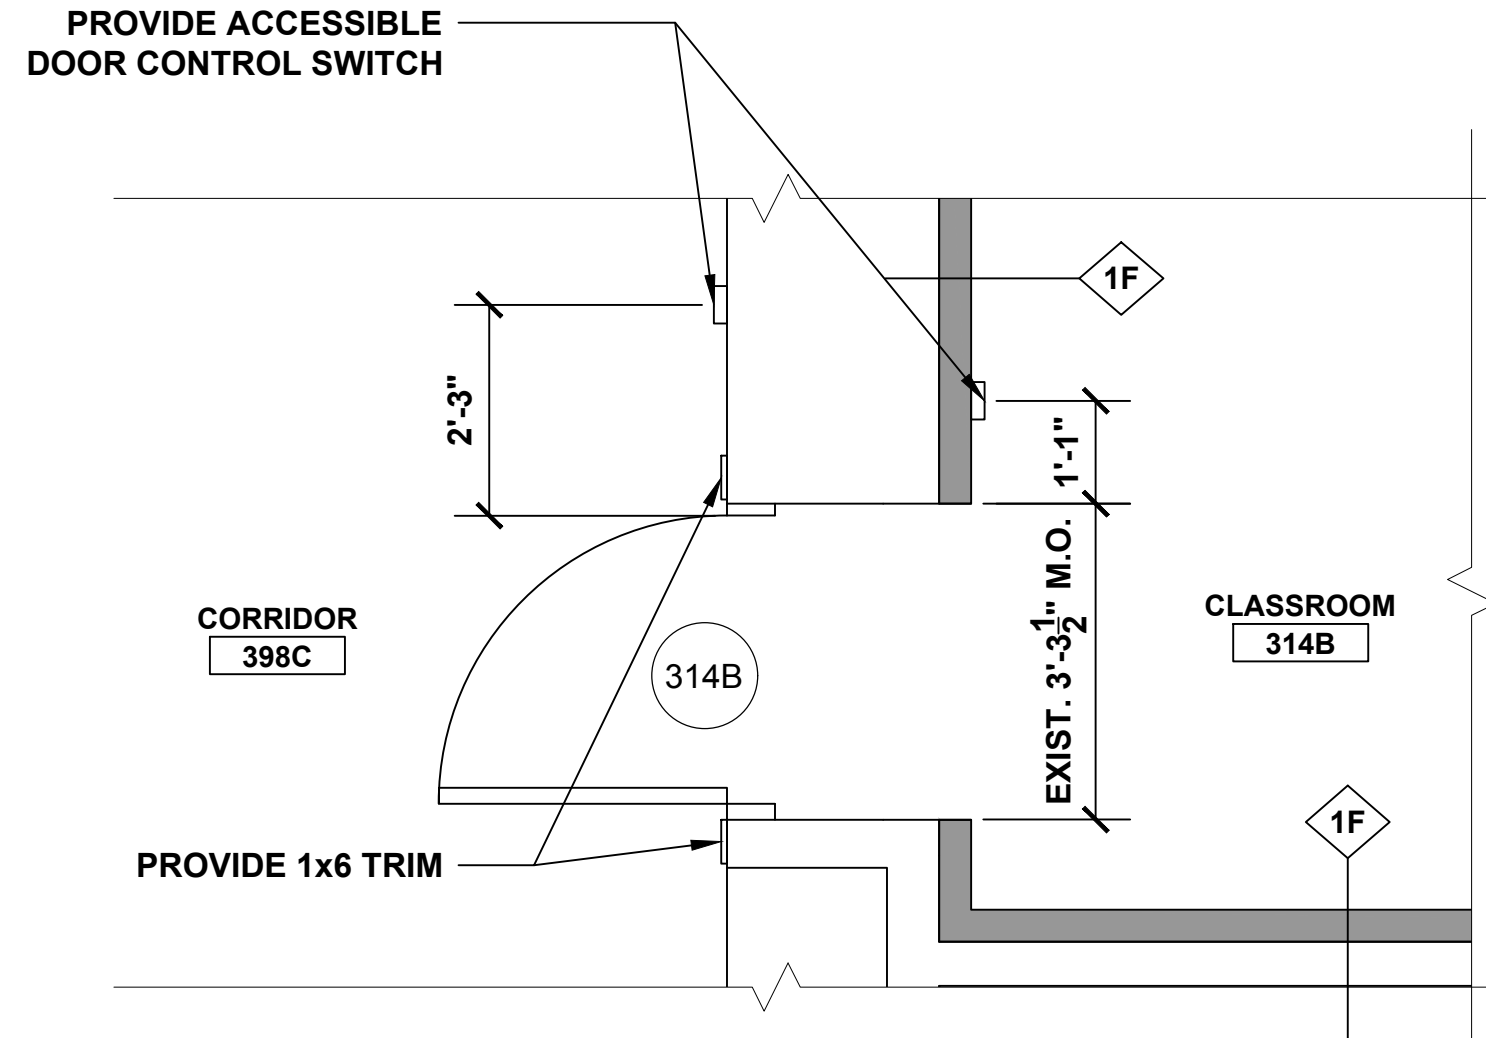


7 **DETAIL PLAN AT DOOR 314B**
PROVIDE ACCESSIBLE POWER DOOR SWITCH

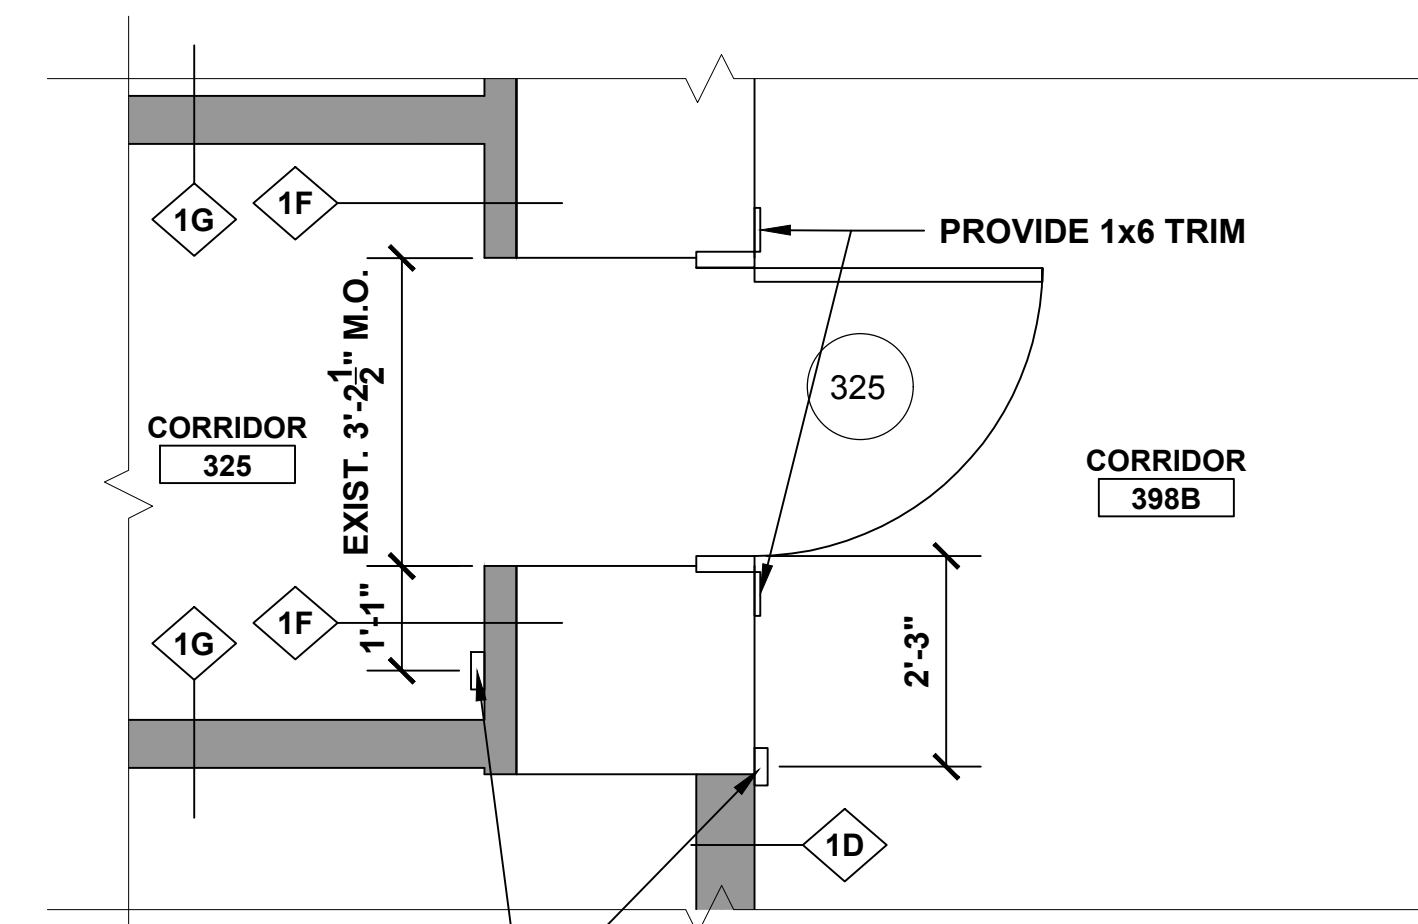


8 **DETAIL PLAN AT DOOR 325**
PROVIDE ACCESSIBLE POWER DOOR SWITCH

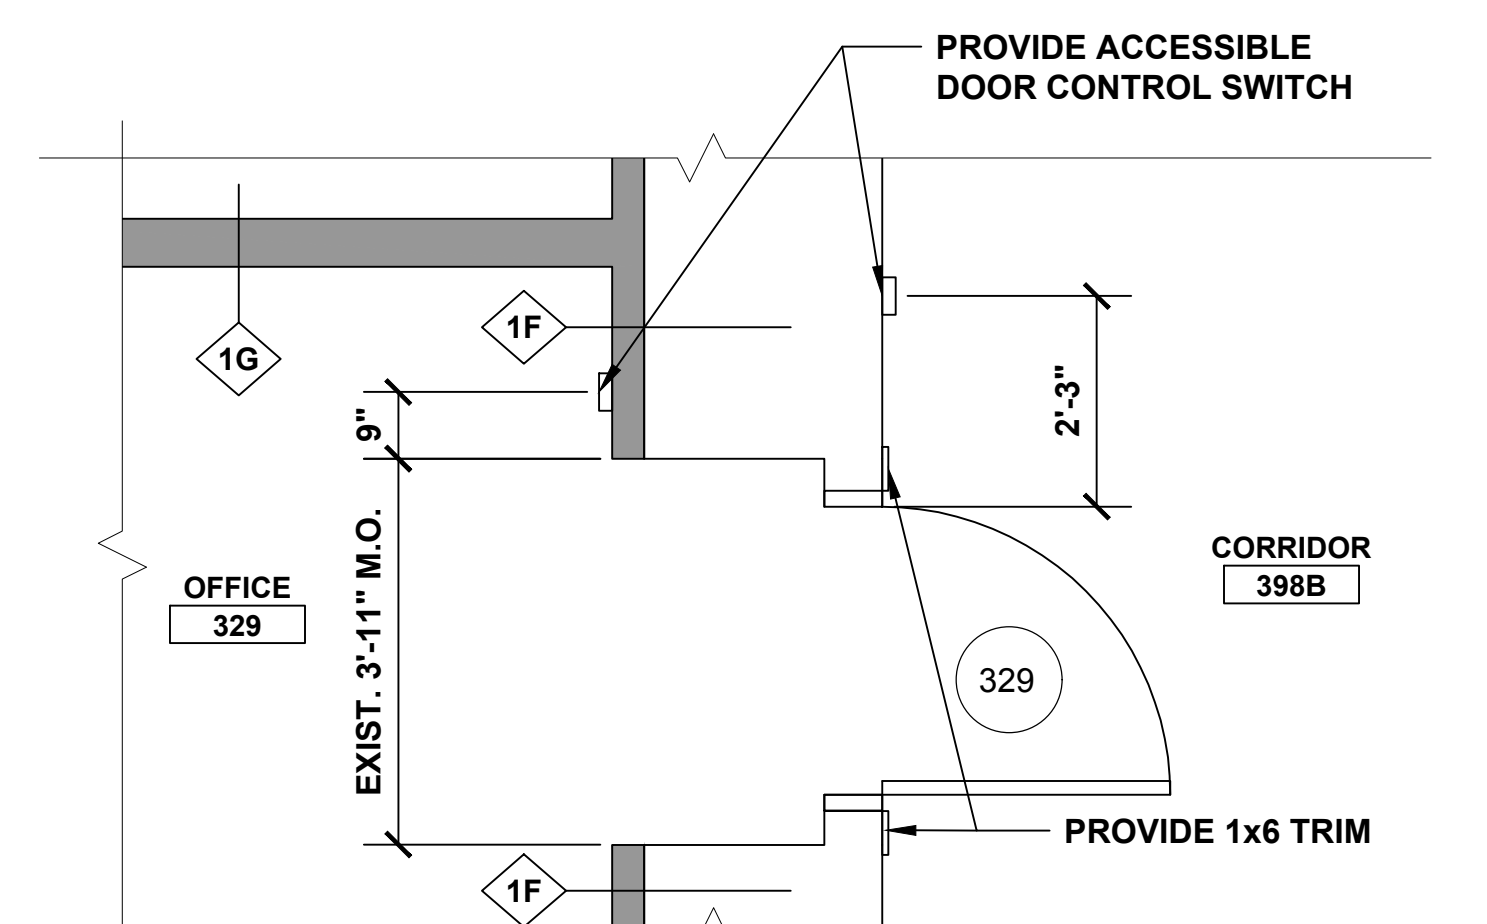


9 **DETAIL PLAN AT DOOR 329**
PROVIDE ACCESSIBLE POWER DOOR SWITCH

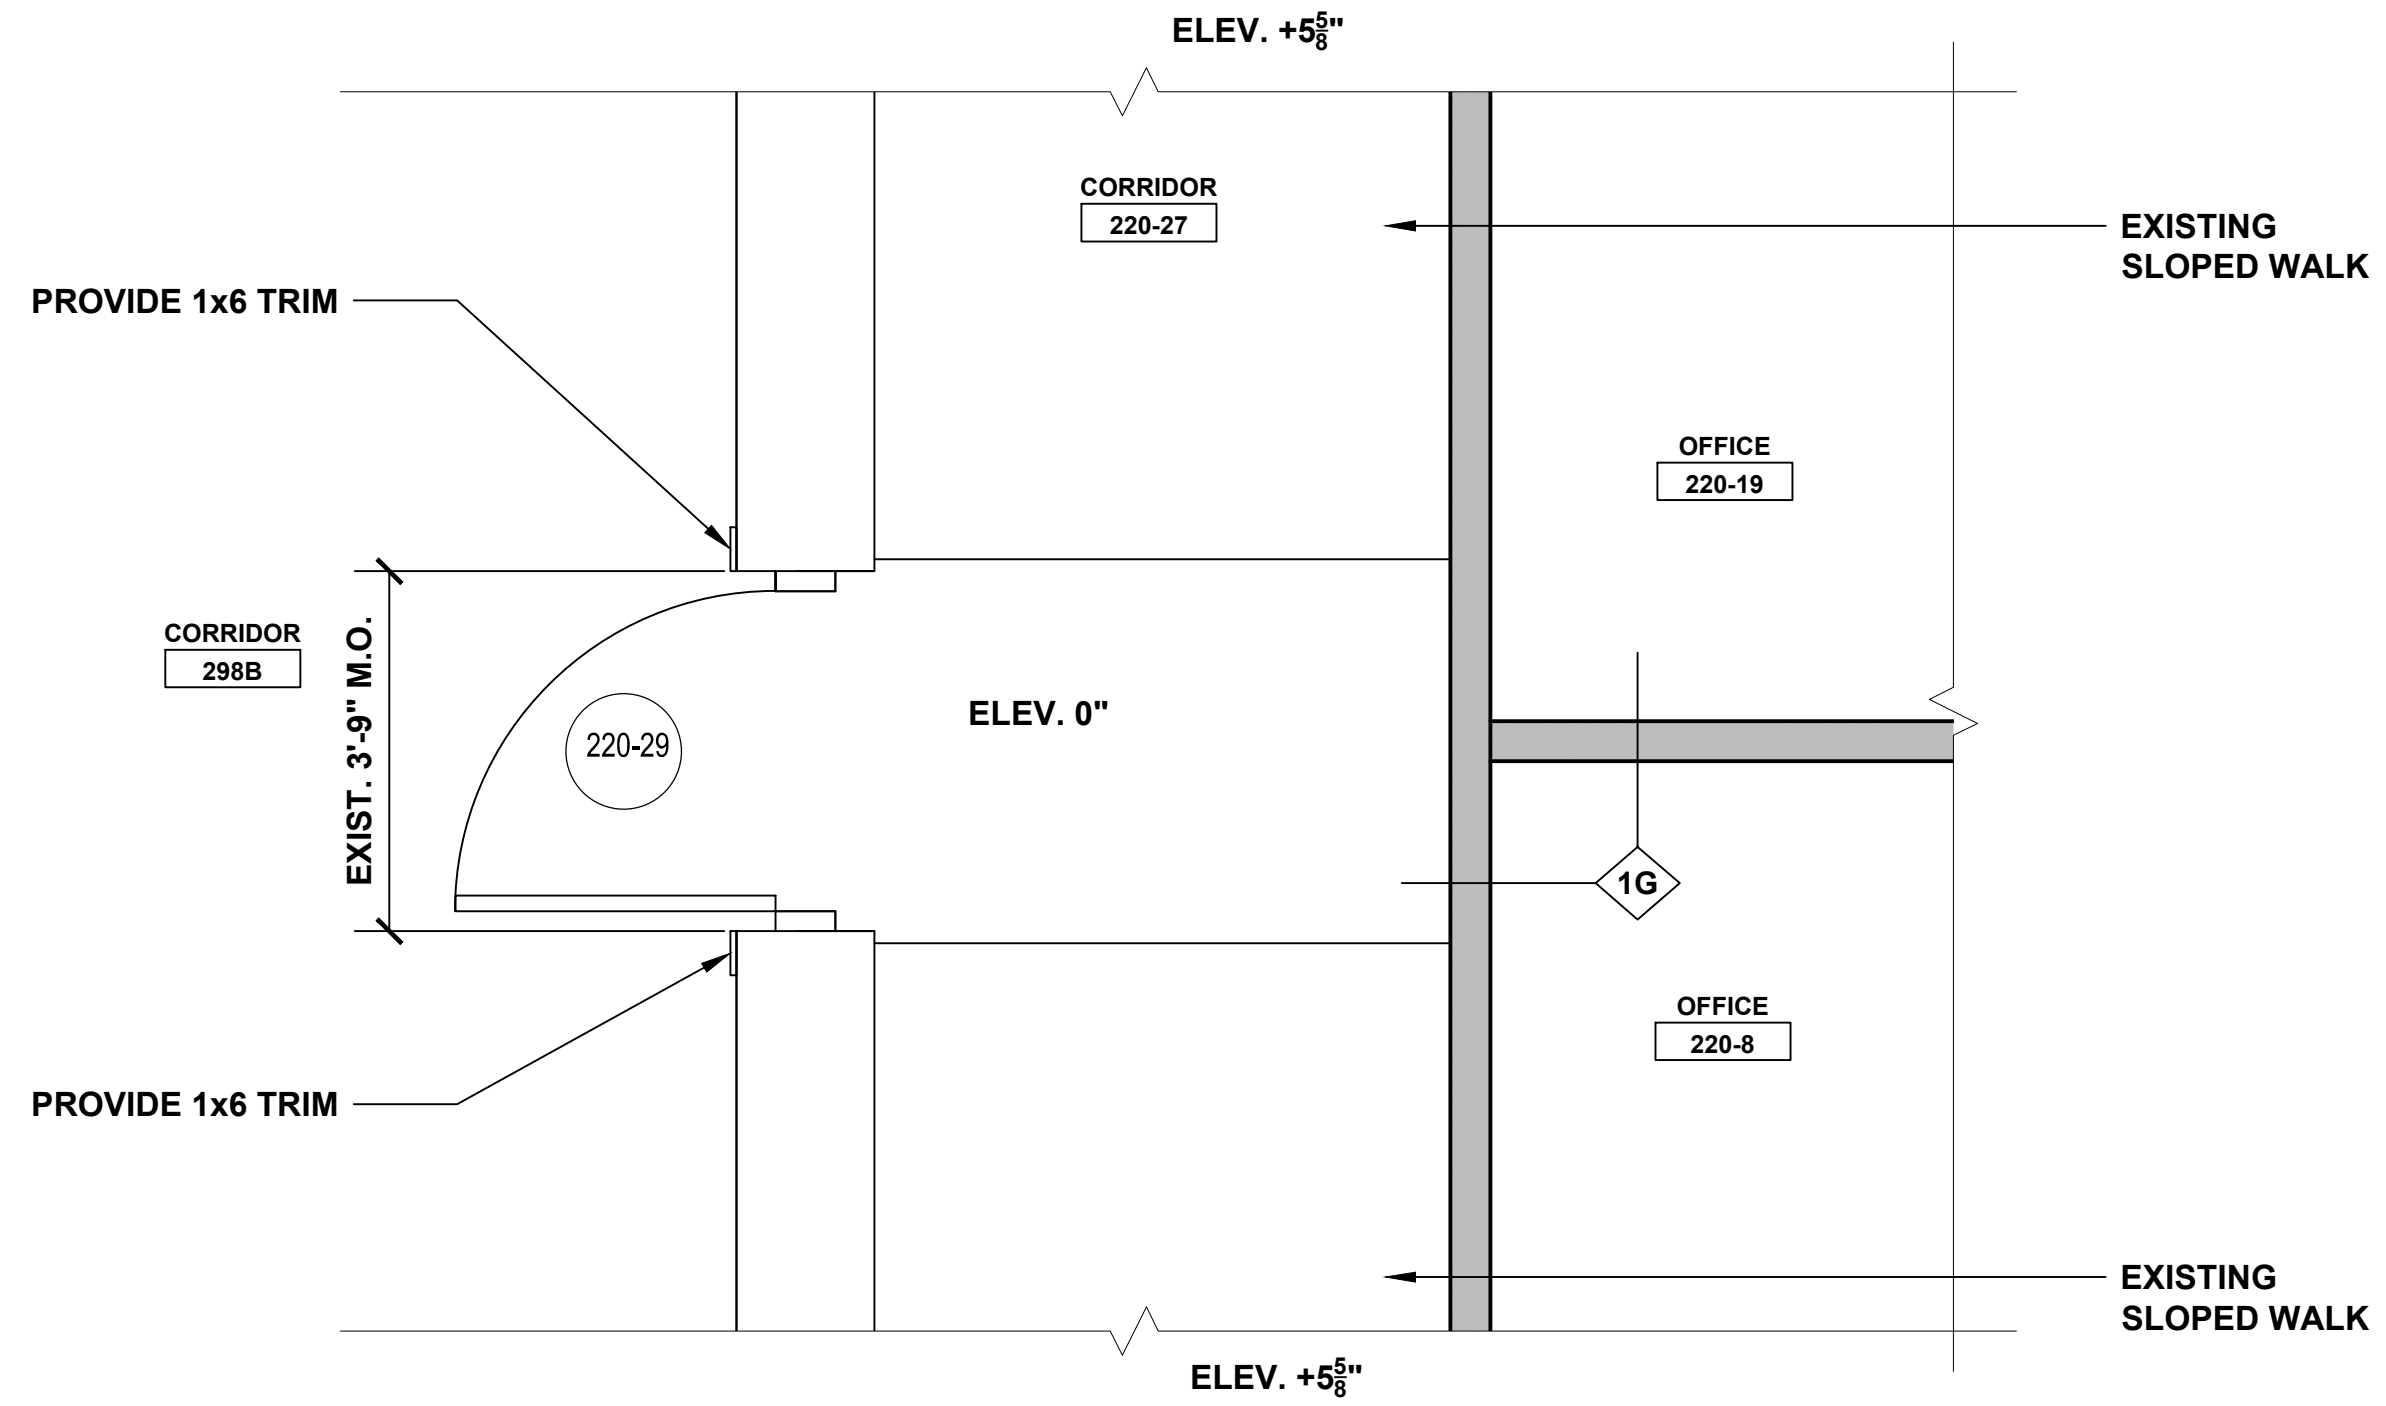


10 **DETAIL PLAN AT DOOR 220-29**
PROVIDE ACCESSIBLE POWER DOOR SWITCH

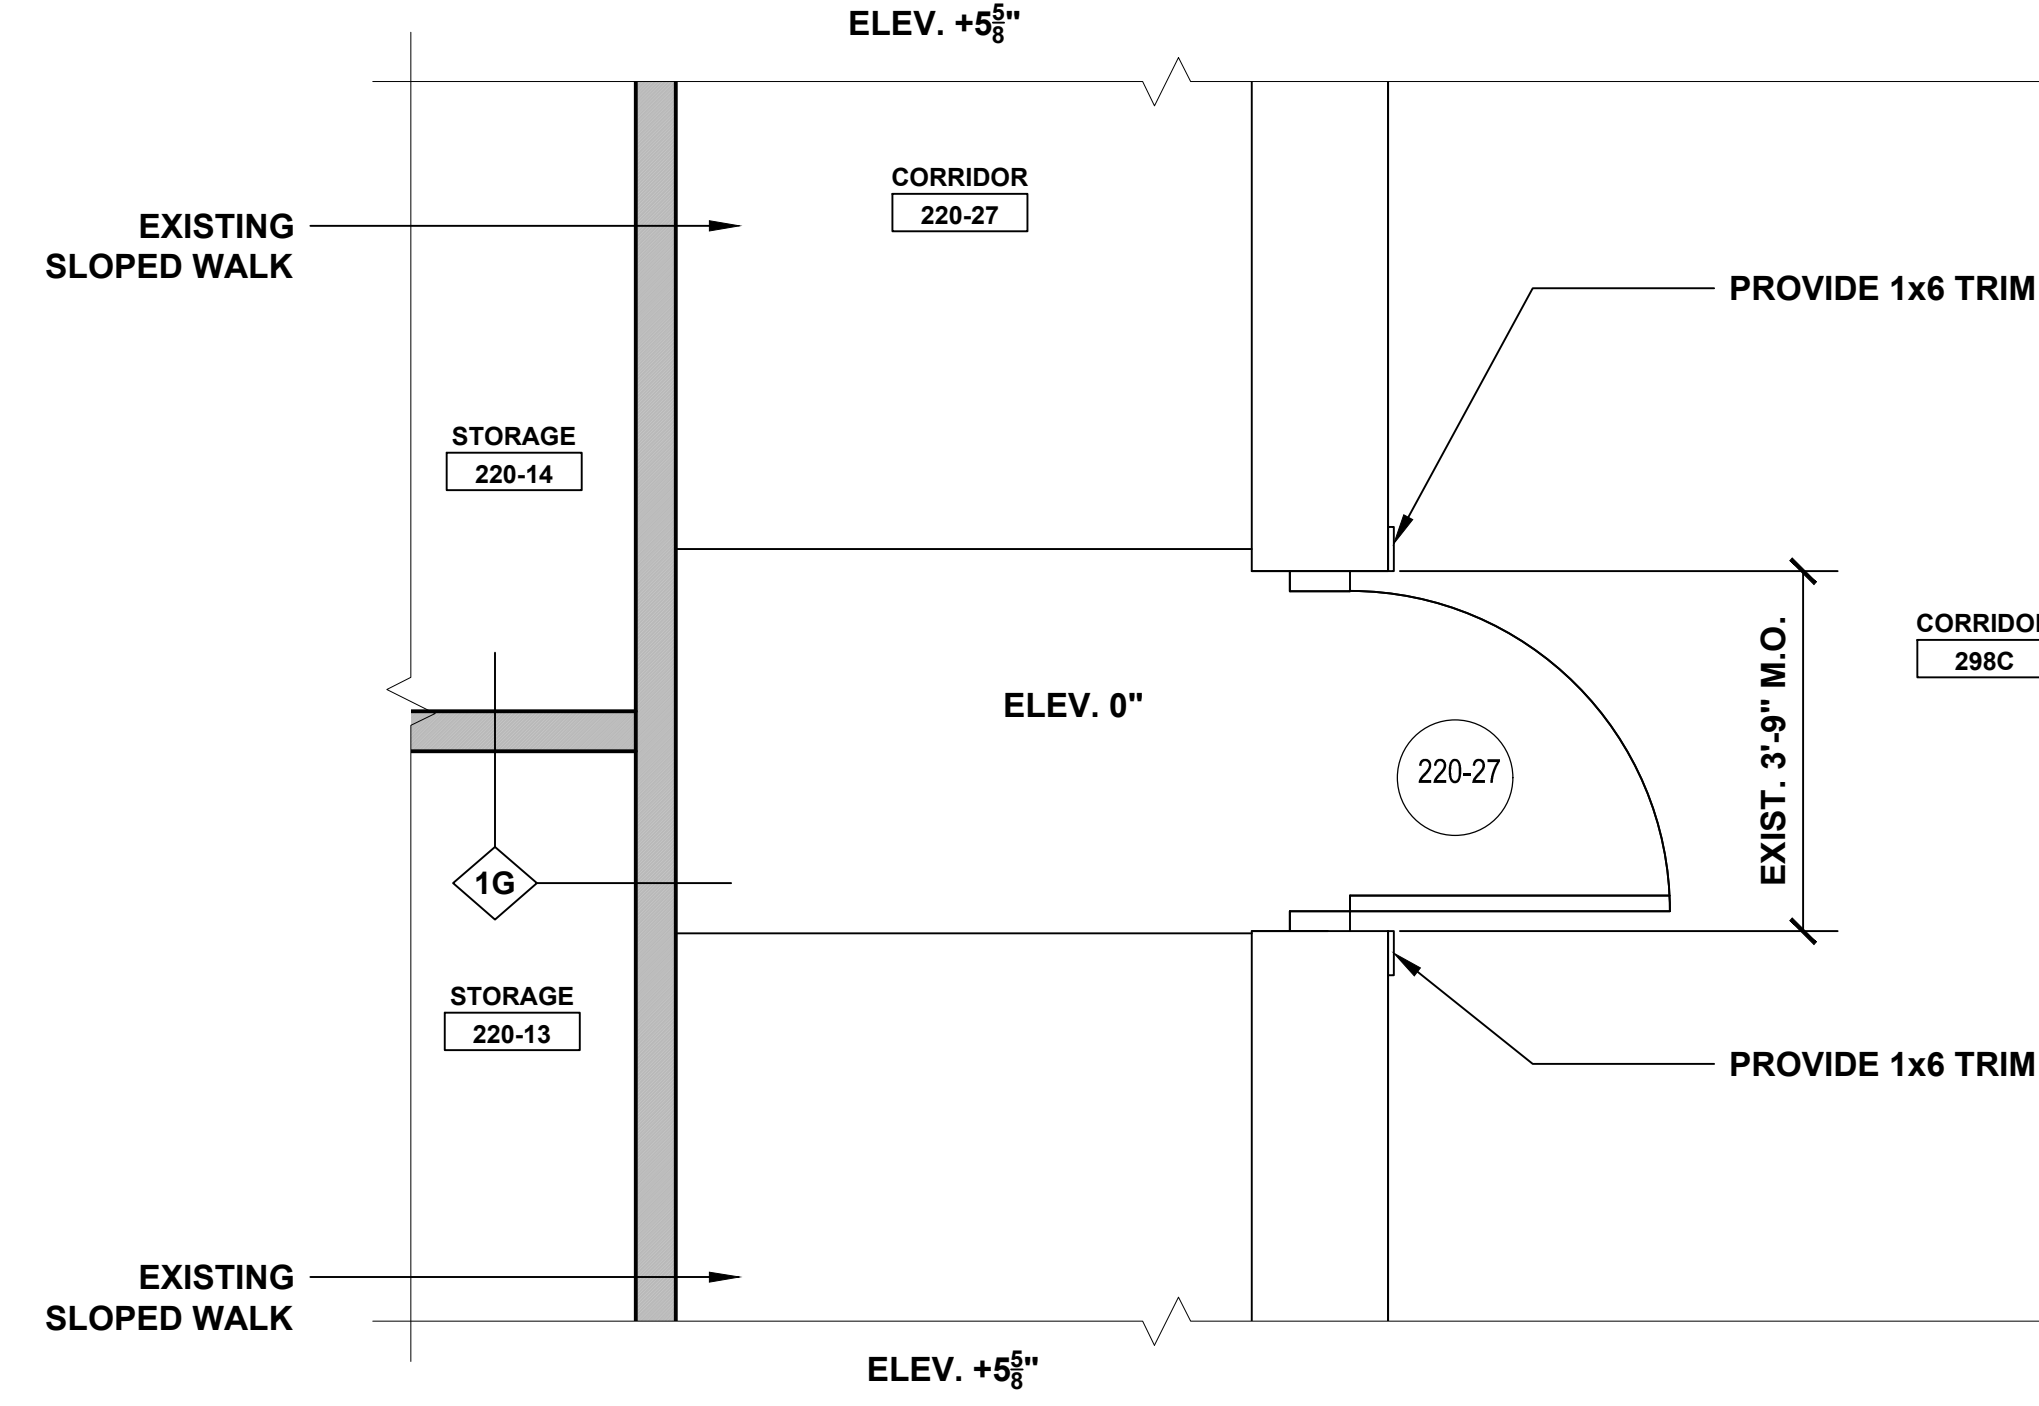

11 **DETAIL PLAN AT DOOR 220-27**
PROVIDE ACCESSIBLE POWER DOOR SWITCH








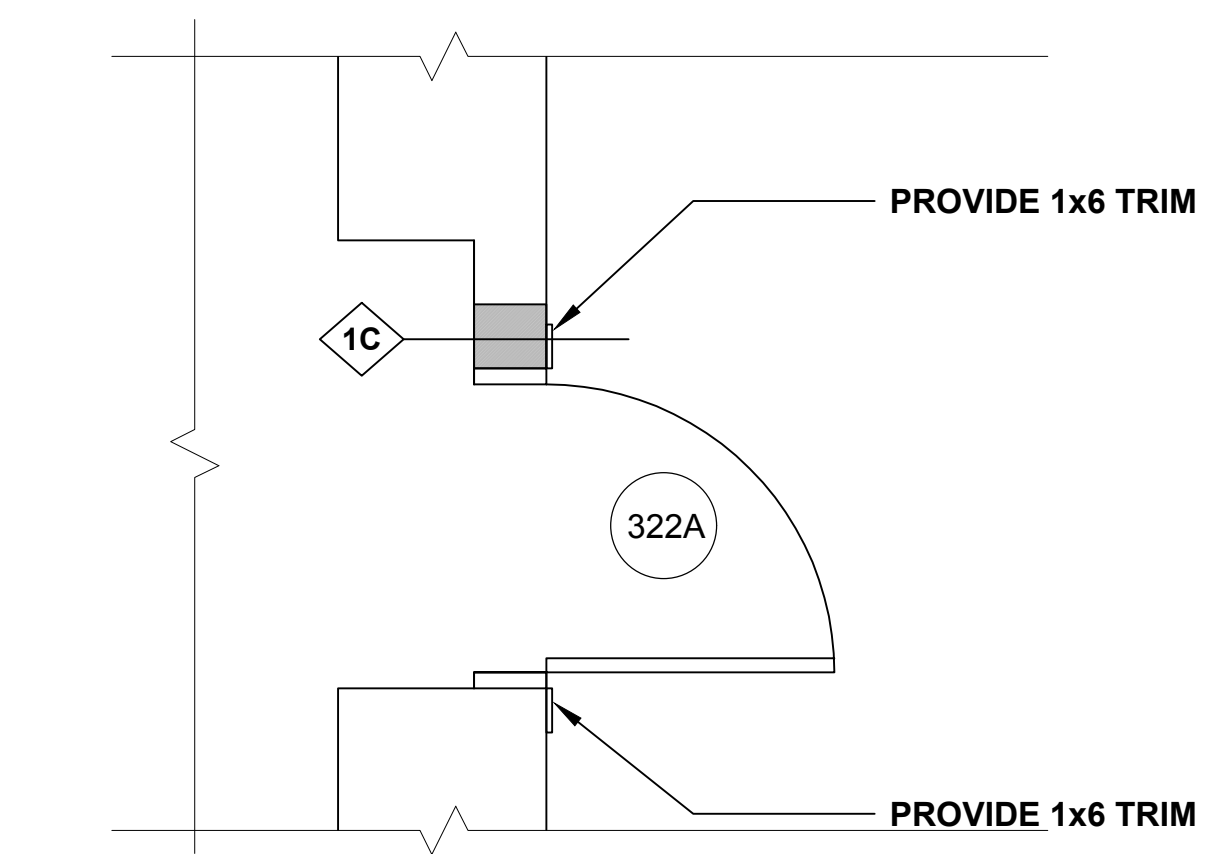


12 **DETAIL PLAN AT DOOR 322A**

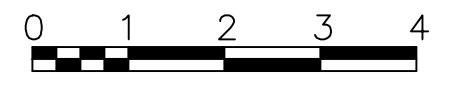



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| drawing title DOOR AND WALL DETAILS | | | STATE OF CONNECTICUT DEPARTMENT OF ADMINISTRATIVE SERVICES | | |
| REVISIONS | | | drawing prepared by AMES & WHITAKER ARCHITECTS | | |
| mark | date | description | 31 LIBERTY STREET SOUTHINGTON, CT | | date 07/25/18 |
| | 8/4/17 | SCHEMATIC DESIGN SUBMISSION | project WESTERN CT STATE UNIVERSITY WHITE HALL 2ND AND 3RD FLOOR RENOVATIONS DANBURY, CONNECTICUT | | scale AS NOTED |
| | 1/15/18 | DESIGN DEVELOPMENT SUBMISSION | drawn by SP/ICA | | approved by AL |
| | 4/16/18 | CONSTRUCTION DOCUMENTS | drawing no. | | A6.06 |
| | 5/23/18 | | CAD no. | | project no. BI-RD-299 |
| | 7/25/18 | | | | |
| | 1/21/19 | | | | |

WALL TYPES

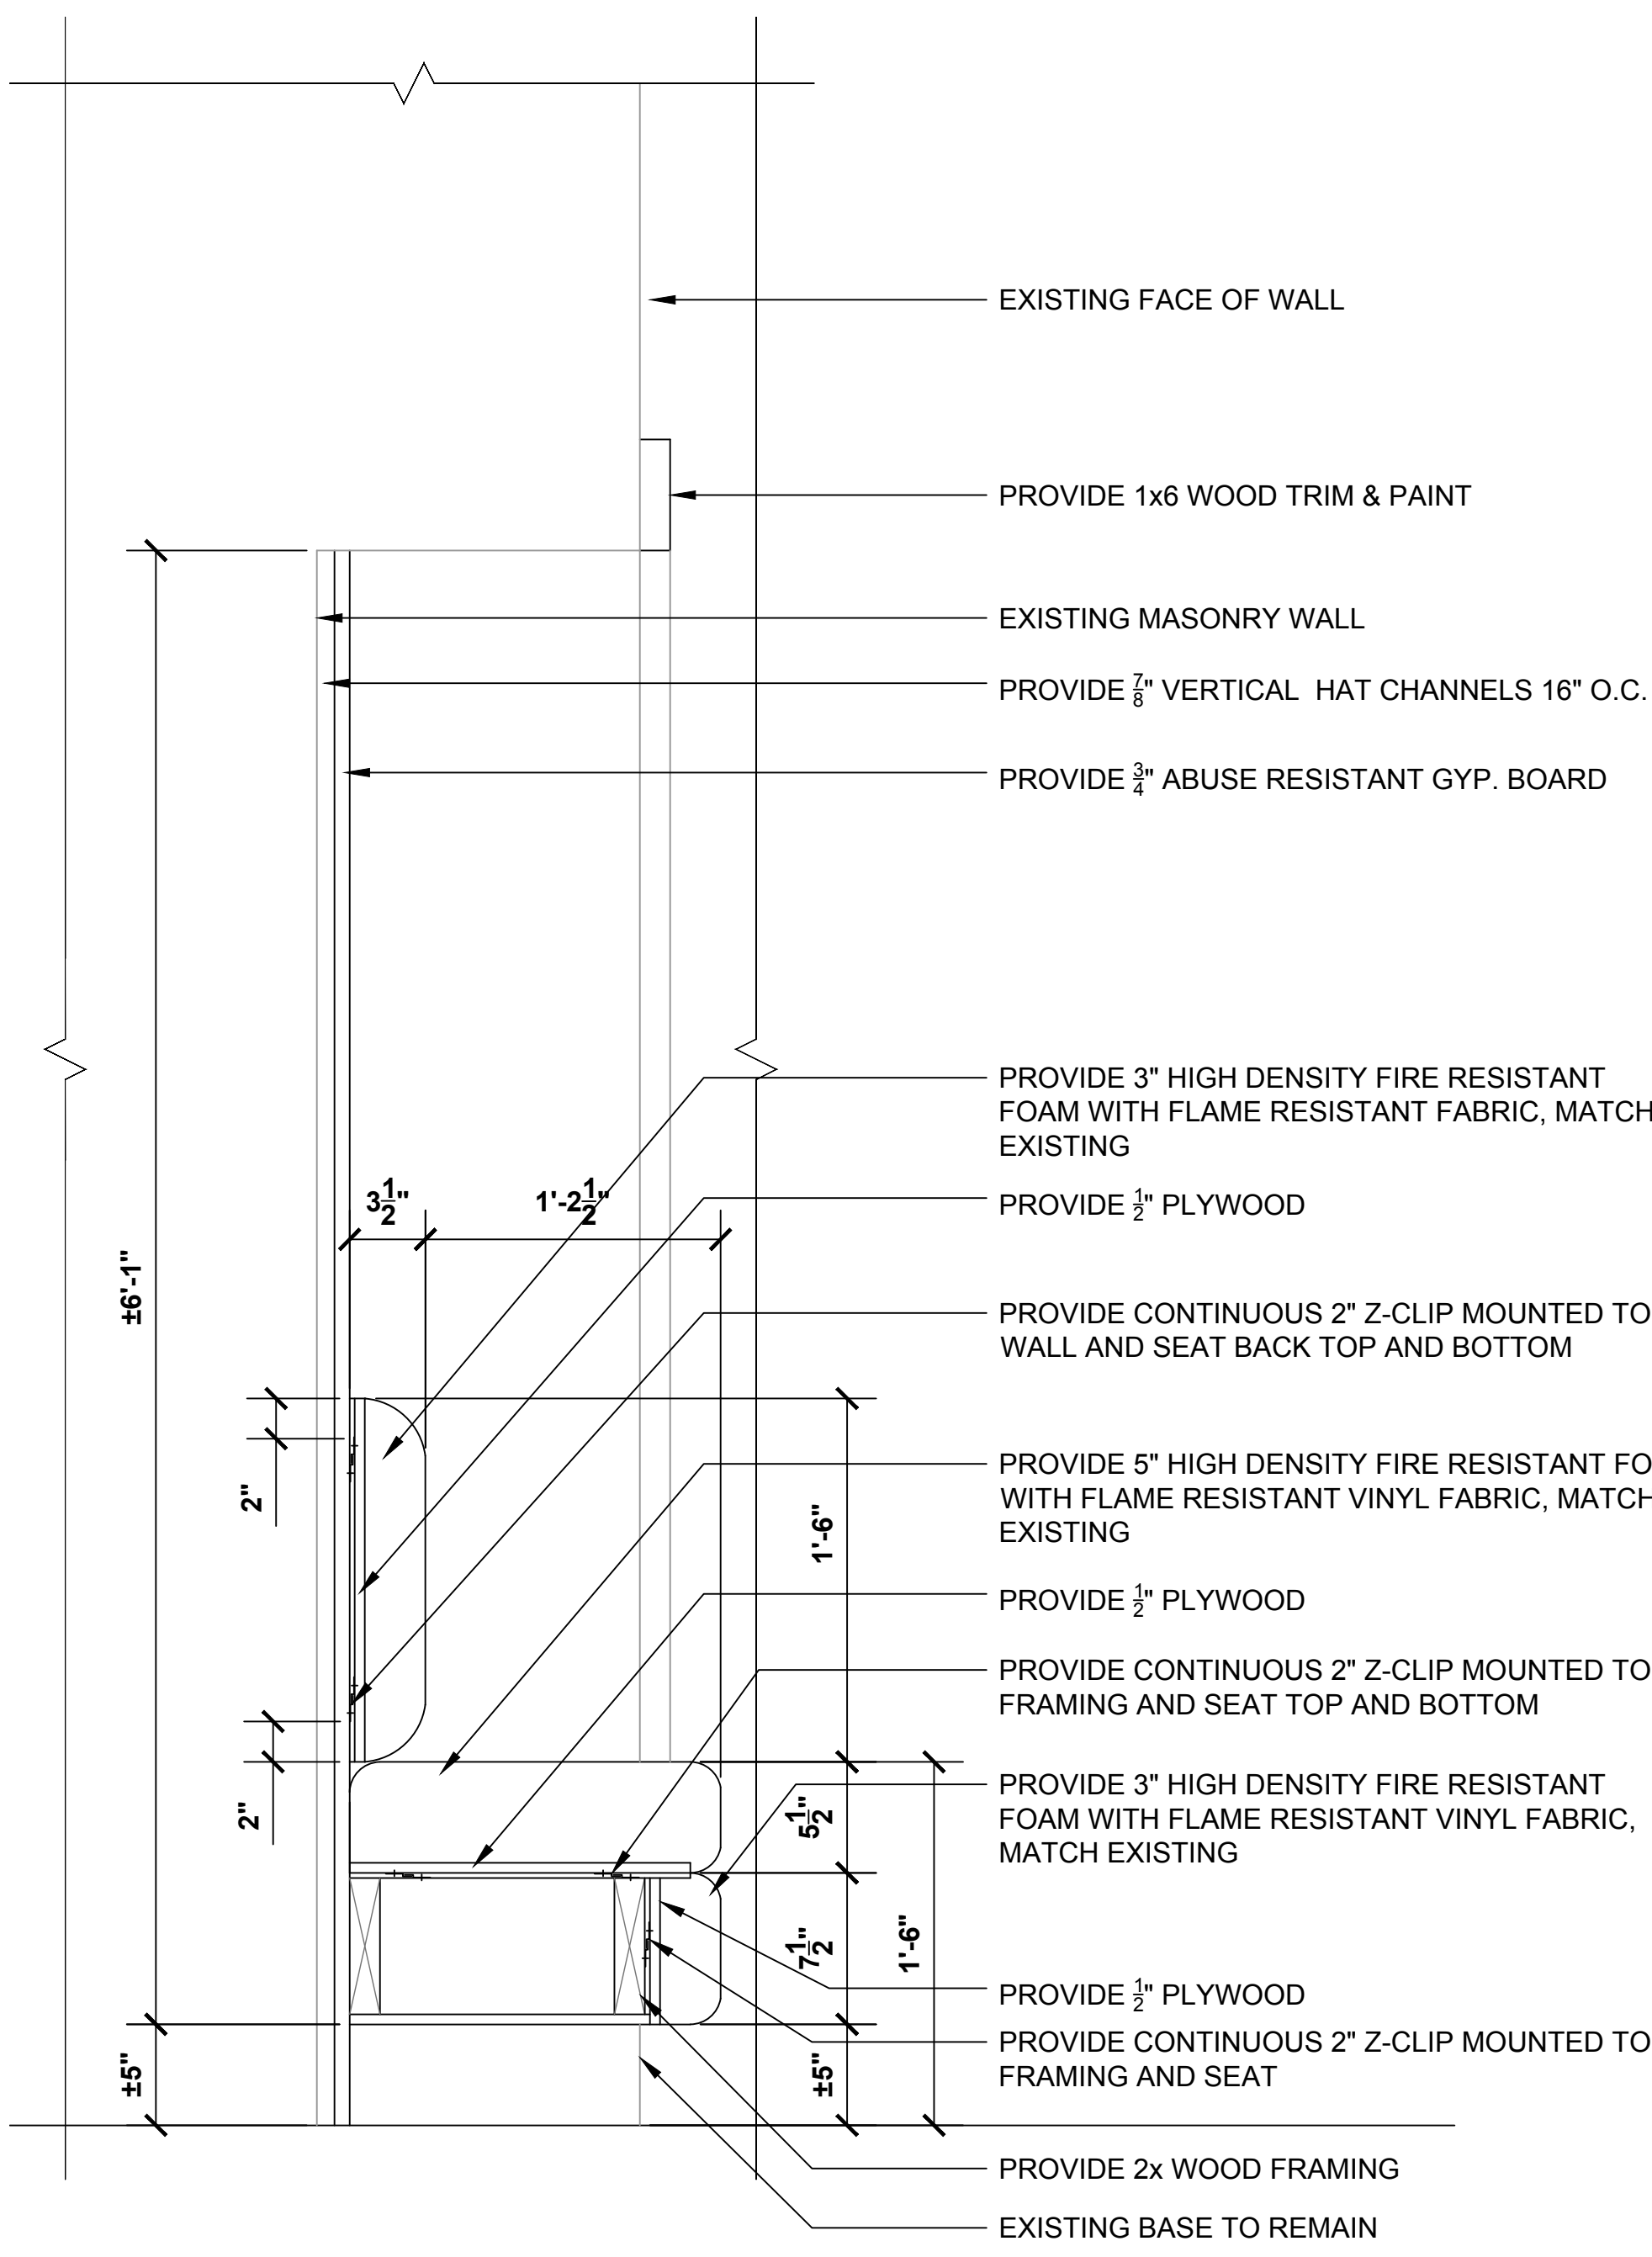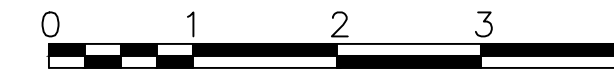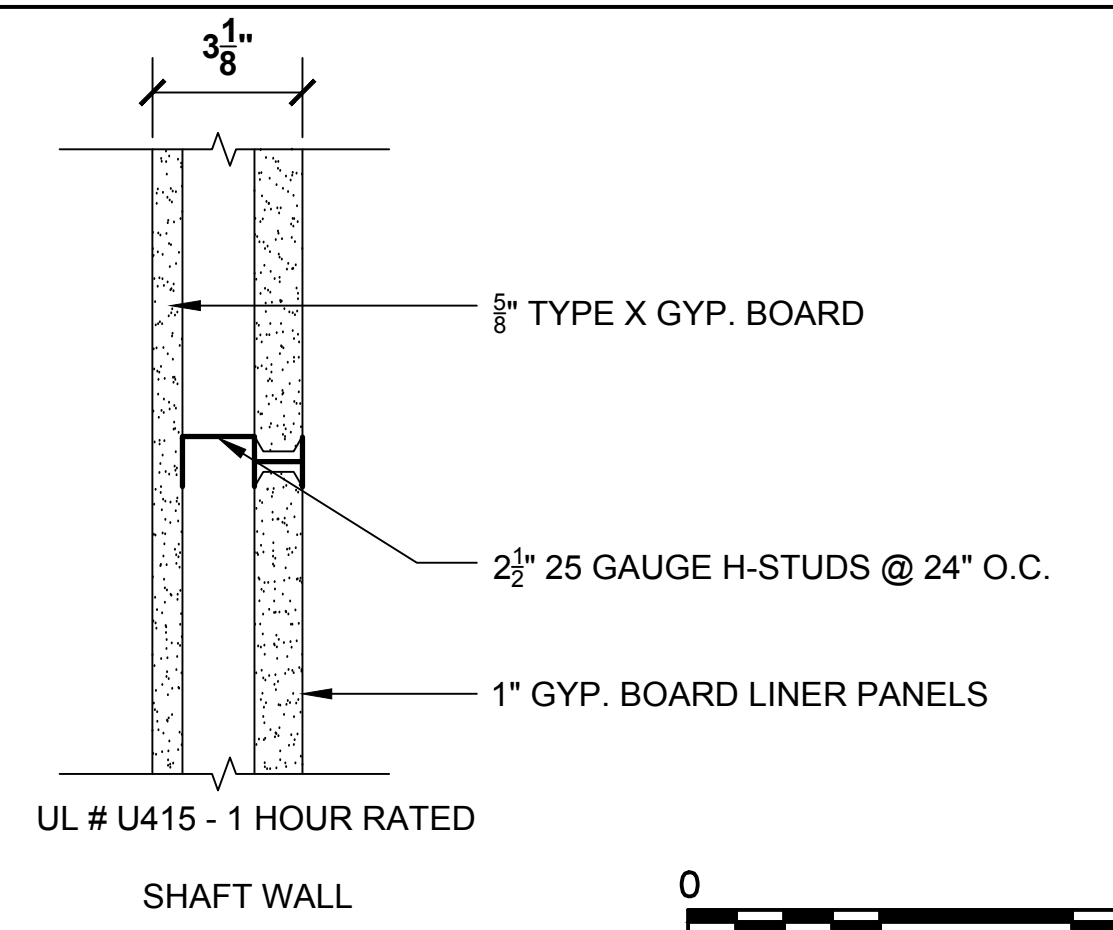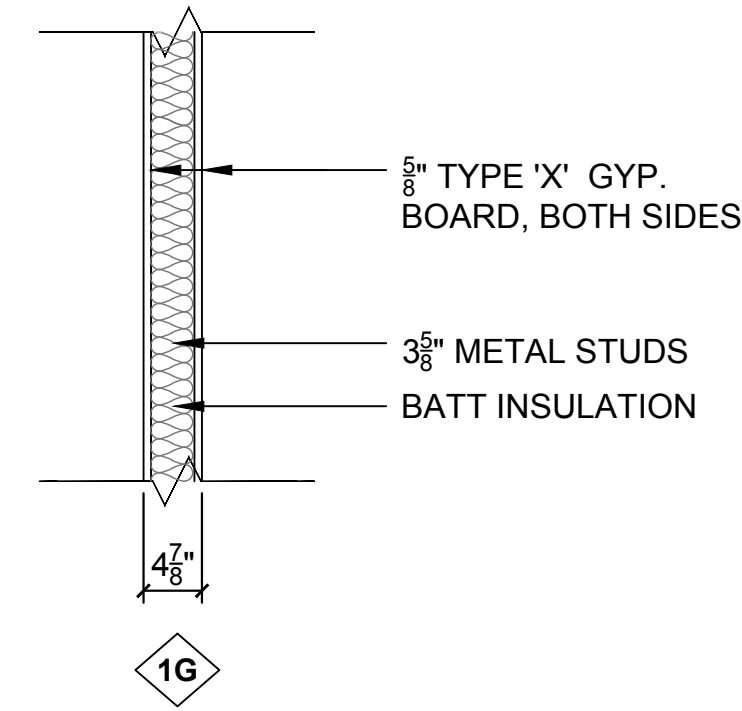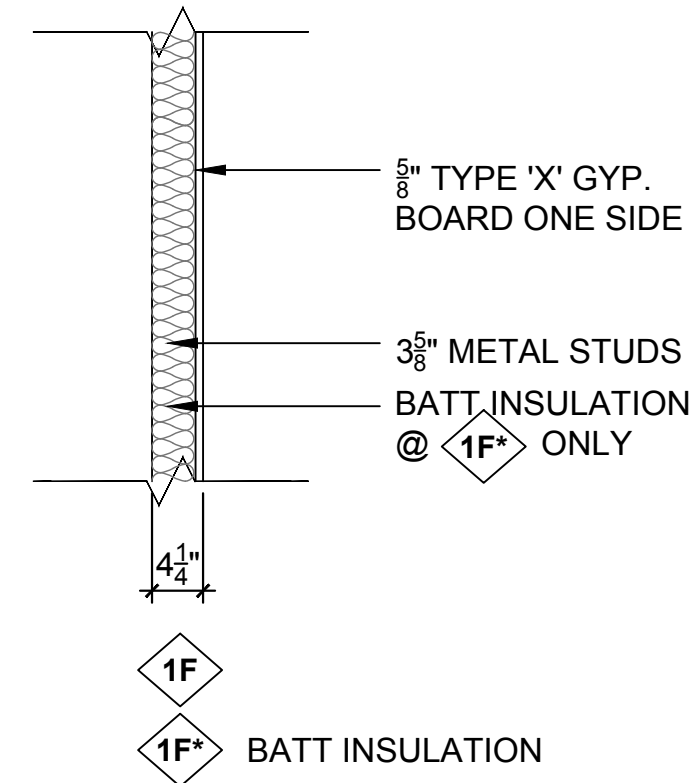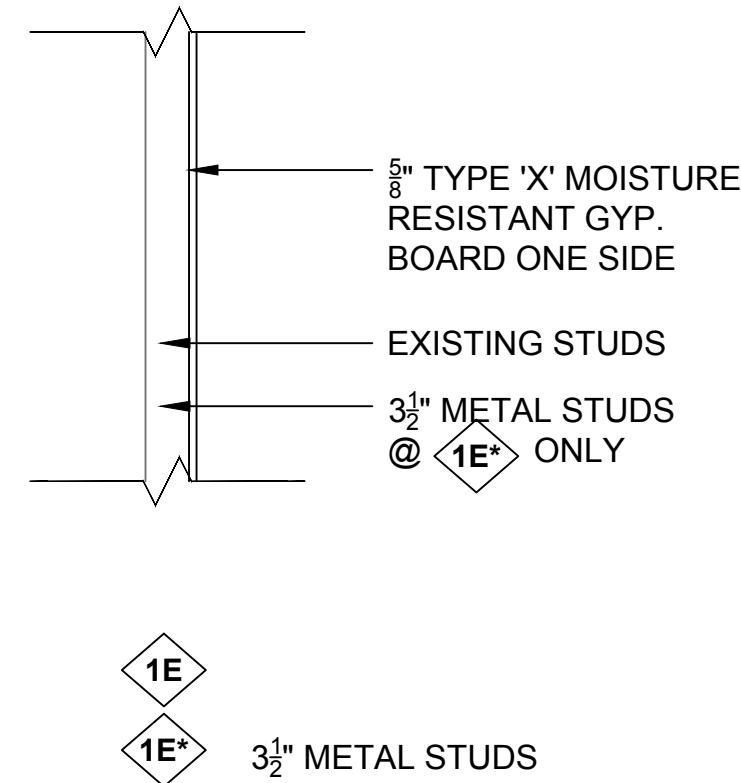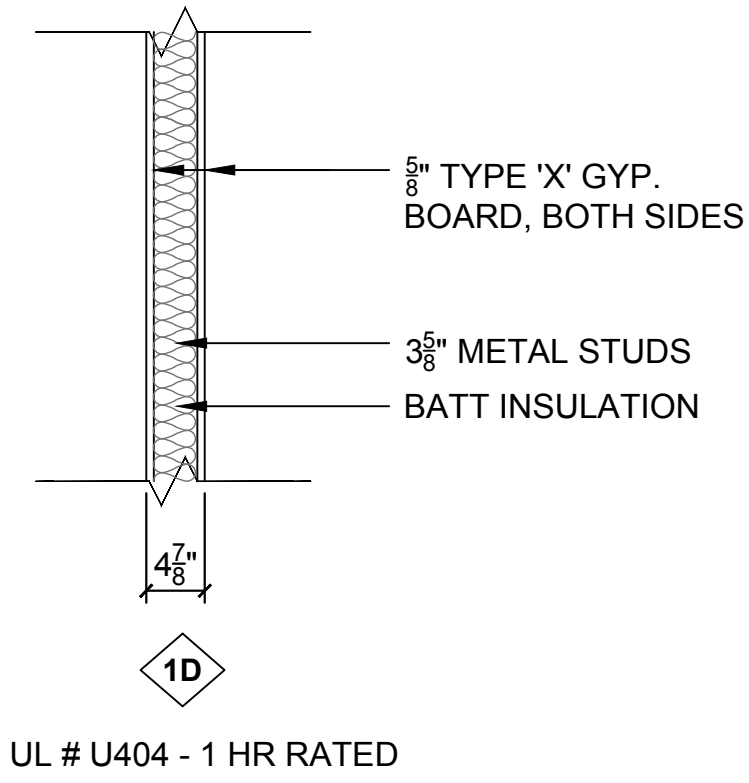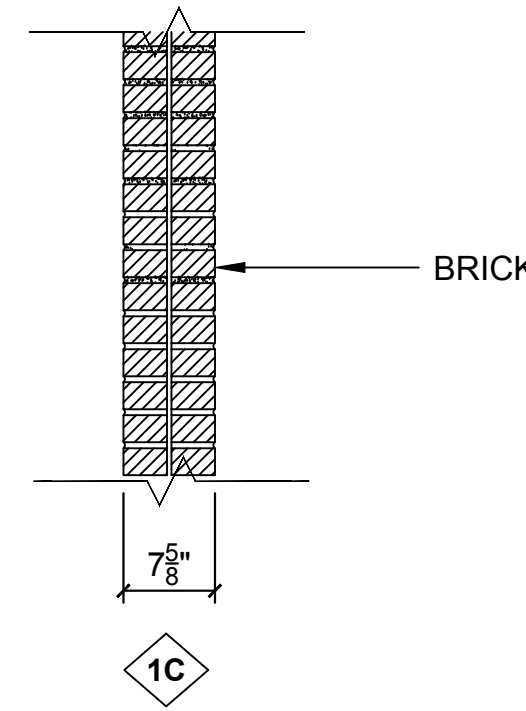


1 BENCH DETAIL


FABRIC:
 SEAT BACK FABRIC: STINSON "TRACING" COLLECTION: #6631 YACHT BLUE
 SEAT FABRIC: ARCCOM "FRONTIER" COLLECTION: #AC-67495 AVOCADO

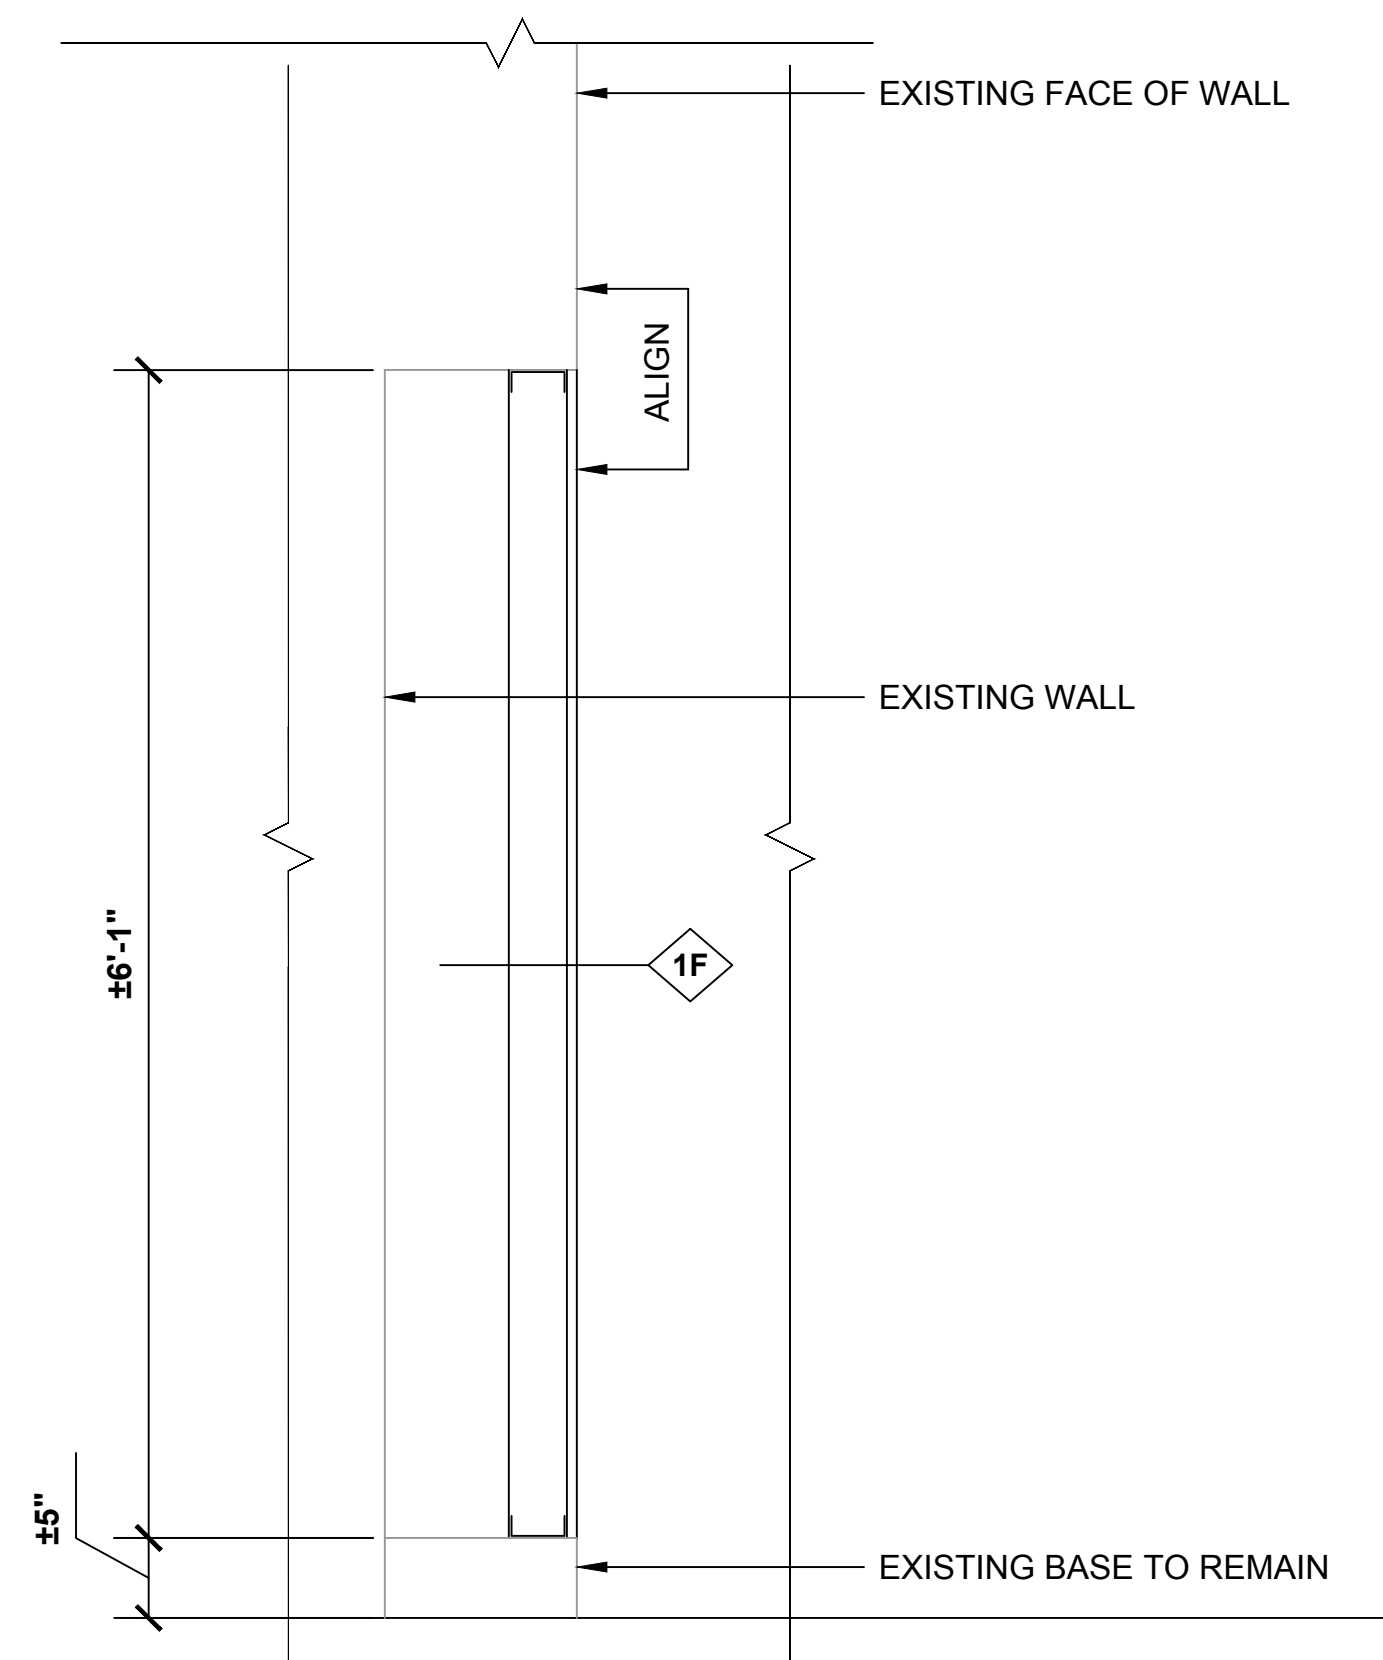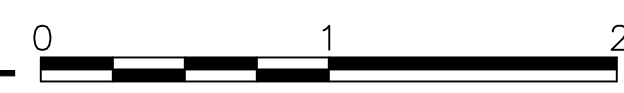

2 LOCKER INFILL DETAIL

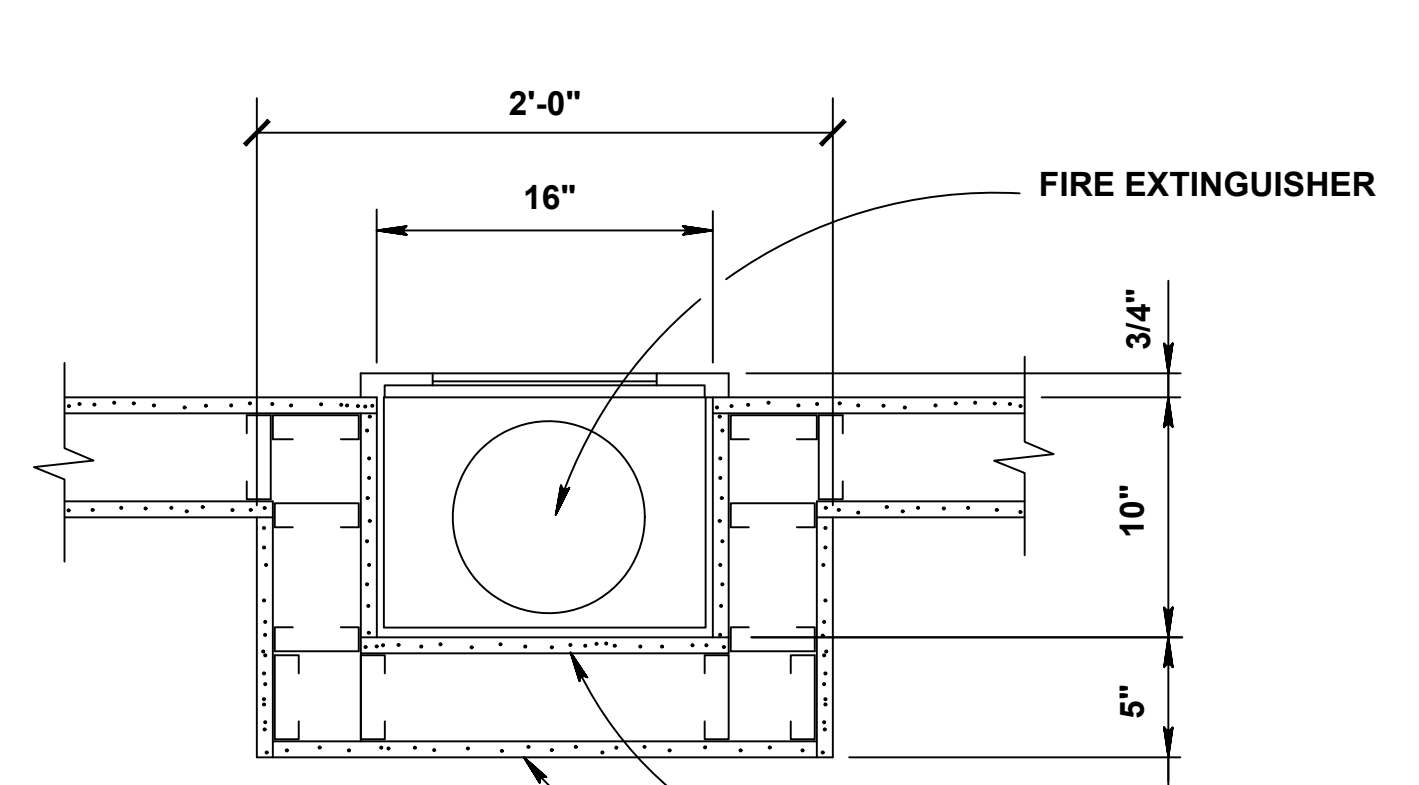


4 FIRE EXTINGUISHER CABINET DETAIL

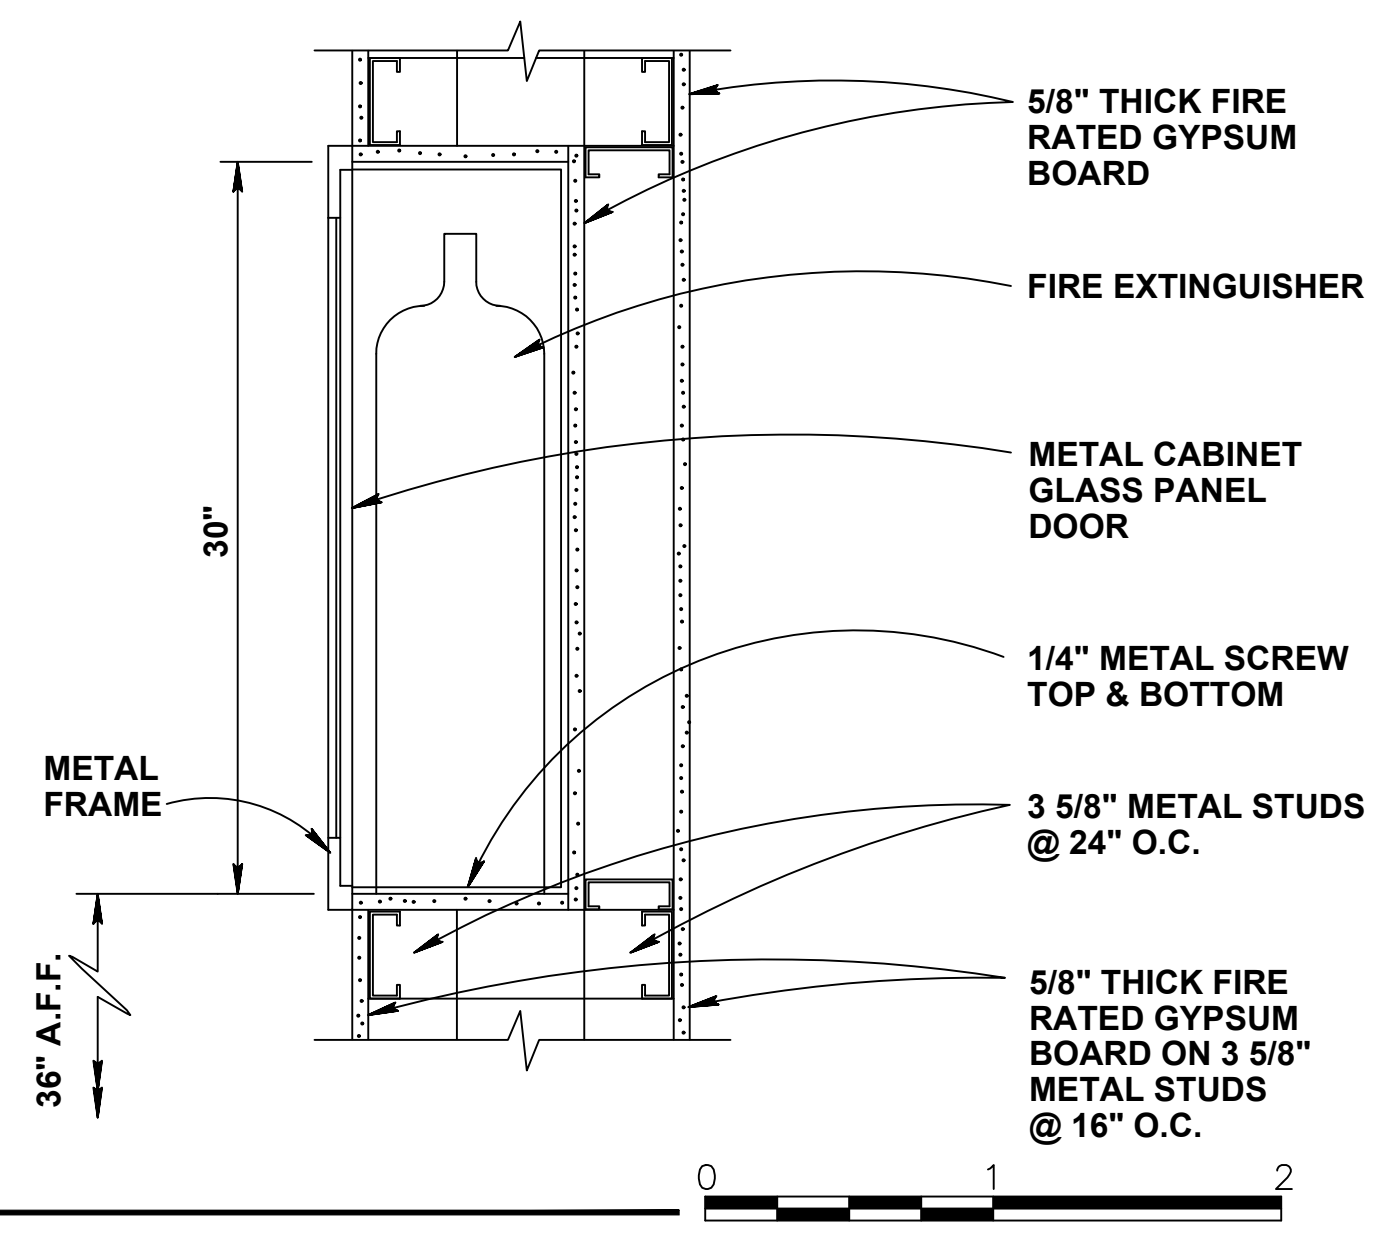

| | | | | | |
|---|---------|-------------------------------|--|-------------------|-----------------------------|
| drawing title WALL TYPES & DETAILS | | | STATE OF CONNECTICUT DEPARTMENT OF ADMINISTRATIVE SERVICES | | |
| REVISIONS | | | drawing prepared by AMES & WHITAKER ARCHITECTS 31 LIBERTY STREET SOUTHINGTON, CT | | |
| mark | date | description | date | scale | AS NOTED |
| | 8/4/17 | SCHEMATIC DESIGN SUBMISSION | 07/25/18 | | |
| | 1/15/18 | DESIGN DEVELOPMENT SUBMISSION | | | |
| | 4/16/18 | CONSTRUCTION DOCUMENTS | | | |
| | 5/23/18 | | | | |
| | 7/25/18 | | | | |
| project WESTERN CT STATE UNIVERSITY WHITE HALL 2ND AND 3RD FLOOR RENOVATIONS DANBURY, CONNECTICUT | | | drawn by SP/CA | approved by AL | drawing no. A6.07 |
| CAD no. | | | project no. BI-RD-299 | | |

System No. C-AJ-5091
 F Rating — 2 Hr
 T Ratings — 0 and 1 Hr (See Items 2 and 4)
 L Rating At Ambient — 4 CFM/Sq Ft
 L Rating At 400 F — Less Than 1 CFM/Sq Ft

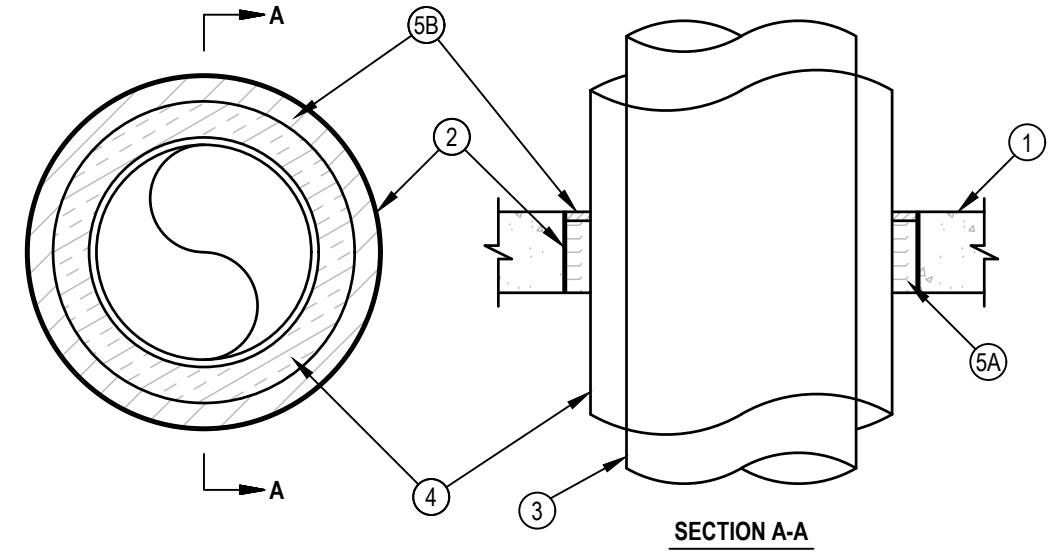


1. FLOOR OR WALL ASSEMBLY — MIN 4-1/2 IN. (114 MM) THICK REINFORCED LIGHTWEIGHT OR NORMAL WEIGHT (100-150 PCF OR 1600-2400 KG/M3) CONCRETE. WALL MAY ALSO BE CONSTRUCTED OF ANY UL CLASSIFIED CONCRETE BLOCKS*. MAX DIAM OF OPENING IS 19-1/2 IN. (495 MM). SEE CONCRETE BLOCKS (CAZT) CATEGORY IN THE FIRE RESISTANCE DIRECTORY FOR NAMES OF MANUFACTURERS.
2. METALLIC SLEEVE — (OPTIONAL) — NOM 20 IN. (508 MM) DIAM (OR SMALLER) SCHEDULE 10 (OR HEAVIER) STEEL SLEEVE CAST OR GROUTED INTO FLOOR OR WALL ASSEMBLY. FLUSH WITH FLOOR OR WALL SURFACES OR EXTENDING A MAX OF 3 IN. (76 MM) ABOVE FLOOR OR BEYOND BOTH SURFACES OF WALL. IF THE STEEL SLEEVE EXTENDS BEYOND THE TOP SURFACE OF THE FLOOR OR BOTH SURFACES OF THE WALL, THE T RATING OF THE FIRESTOP SYSTEM IS 0 HR.
- 2A. SHEET METAL SLEEVE — (OPTIONAL) — MAX 6 IN. (152 MM) DIAM, MIN 26 GA GALV STEEL PROVIDED WITH A 26 GA GALV STEEL SQUARE FLANGE SPOT WELDED TO THE SLEEVE AT APPROXIMATELY MID-HEIGHT. OR FLUSH WITH BOTTOM OF SLEEVE IN FLOORS, AND SIZED TO BE A MIN OF 2 IN. (51 MM) LARGER THAN THE SLEEVE DIAM. THE SLEEVE IS TO BE CAST IN PLACE FLUSH WITH BOTTOM SURFACE OF FLOOR AND MAY EXTEND A MAX OF 1 IN. (25 MM) ABOVE THE TOP SURFACE OF THE FLOOR.
- 2B. SHEET METAL SLEEVE — (OPTIONAL) — MAX 12 IN. (305 MM) DIAM, MIN 24 GA GALV STEEL PROVIDED WITH A 24 GA GALV STEEL SQUARE FLANGE SPOT WELDED TO THE SLEEVE AT APPROXIMATELY MID-HEIGHT. OR FLUSH WITH BOTTOM OF SLEEVE IN FLOORS, AND SIZED TO BE A MIN OF 2 IN. (51 MM) LARGER THAN THE SLEEVE DIAM. THE SLEEVE IS TO BE CAST IN PLACE FLUSH WITH BOTTOM SURFACE OF FLOOR AND MAY EXTEND A MAX OF 1 IN. (25 MM) ABOVE THE TOP SURFACE OF THE FLOOR.
3. THROUGH PENETRANTS — ONE METALLIC PIPE OR TUBING TO BE INSTALLED EITHER CONCENTRICALLY OR ECCENTRICALLY WITHIN THE FIRESTOP SYSTEM. PIPE OR TUBING TO BE RIGIDLY SUPPORTED ON BOTH SIDES OF FLOOR OR WALL ASSEMBLY. THE FOLLOWING TYPES AND SIZES OF METALLIC PIPES OR TUBING MAY BE USED:
 - A. STEEL PIPE — NOM 12 IN. (305 MM) DIAM (OR SMALLER) SCHEDULE 10 (OR HEAVIER) STEEL PIPE.
 - B. IRON PIPE — NOM 12 IN. (305 MM) DIAM (OR SMALLER) CAST OR DUCTILE IRON PIPE.
 - C. COPPER PIPE — NOM 6 IN. (152 MM) DIAM (OR SMALLER) REGULAR (OR HEAVIER) COPPER PIPE.
 - D. COPPER TUBING — NOM 6 IN. (152 MM) DIAM (OR SMALLER) TYPE L (OR HEAVIER) COPPER TUBING.
4. PIPE COVERING — MIN 1/2 IN. (13 MM) TO MAX 2 IN. (51 MM) THICK HOLLOW CYLINDRICAL HEAVY DENSITY (MIN 3.5 PCF OR 56 KG/M3) GLASS FIBER UNITS JACKETED ON THE OUTSIDE WITH AN ALL-SERVICE JACKET. LONGITUDINAL JOINTS SEALED WITH METAL FASTENERS OR FACTORY-APPLIED, SELF-SEALING LAP TAPE. TRANSVERSE JOINTS SECURED WITH METAL FASTENERS OR WITH BUTT TAPE SUPPLIED WITH THE PRODUCT. THE ANNULAR SPACE BETWEEN THE INSULATED PIPE AND THE EDGE OF THE PERIPHERY OF THE OPENING SHALL BE MIN 1/2 IN. (13 MM) TO A MAX 2-1/4 IN. (57 MM), WHEN THICKNESS OF PIPE COVERING IS LESS THAN 2 IN. (51 MM). THE T RATING FOR THE FIRESTOP SYSTEM IS 0 HR.
- SEE PIPE EQUIPMENT COVERING — MATERIALS — (BRU) CATEGORY IN THE BUILDING MATERIALS DIRECTORY FOR NAMES OF MANUFACTURERS. ANY PIPE COVERING MATERIAL MEETING THE ABOVE SPECIFICATIONS AND BEARING THE UL CLASSIFICATION MARKING WITH A FLAME SPREAD INDEX OF 25 OR LESS AND A SMOKE DEVELOPED INDEX OF 50 OR LESS MAY BE USED.
- 4A. PIPE COVERING — (NOT SHOWN) — AS AN ALTERNATE TO ITEM 4, MAX 2 IN. (51 MM) THICK CYLINDRICAL CALCIUM SILICATE (MIN 14 PCF) UNITS SIZED TO THE OUTSIDE DIAM OF THE PIPE OR TUBE MAY BE USED. PIPE INSULATION SECURED WITH STAINLESS STEEL BANDS OR MIN 8 AWG STAINLESS STEEL WIRE SPACED MAX 12 IN. (305 MM) OC. THE ANNULAR SPACE SHALL BE MIN 1/2 IN. (13 MM) TO MAX 2-1/4 IN. (57 MM).
5. FIRESTOP SYSTEM — THE FIRESTOP SYSTEM SHALL CONSIST OF THE FOLLOWING:
 - A. PACKING MATERIAL — MIN 4 IN. (102 MM) THICKNESS OF MIN 4 PCF (64 KG/M3) MINERAL WOOL BATT INSULATION FIRMLY PACKED INTO OPENING AS A PERMANENT FORM. PACKING MATERIAL TO BE RECESSED FROM TOP SURFACE OF FLOOR OR FROM BOTH SURFACES OF WALL AS REQUIRED TO ACCOMMODATE THE REQUIRED THICKNESS OF FILL MATERIAL.
 - B. FILL, VOID OR CAVITY MATERIAL* — SEALANT — MIN 1/2 IN. (13 MM) THICKNESS OF FILL MATERIAL APPLIED WITHIN THE ANNULUS, FLUSH WITH TOP SURFACE OF FLOOR OR WITH BOTH SURFACES OF WALL. HILTI CONSTRUCTION CHEMICALS, DIV OF HILTI INC — FS-ONE SEALANT

*BEARING THE UL CLASSIFICATION MARK

INSULATED METALLIC PIPE THROUGH CONCRETE FLOOR OR WALL (5.5.5)

1

System No. W-L-3065
 F Ratings — 1 and 2 Hr (See Item 1)
 T Rating — 0 Hr

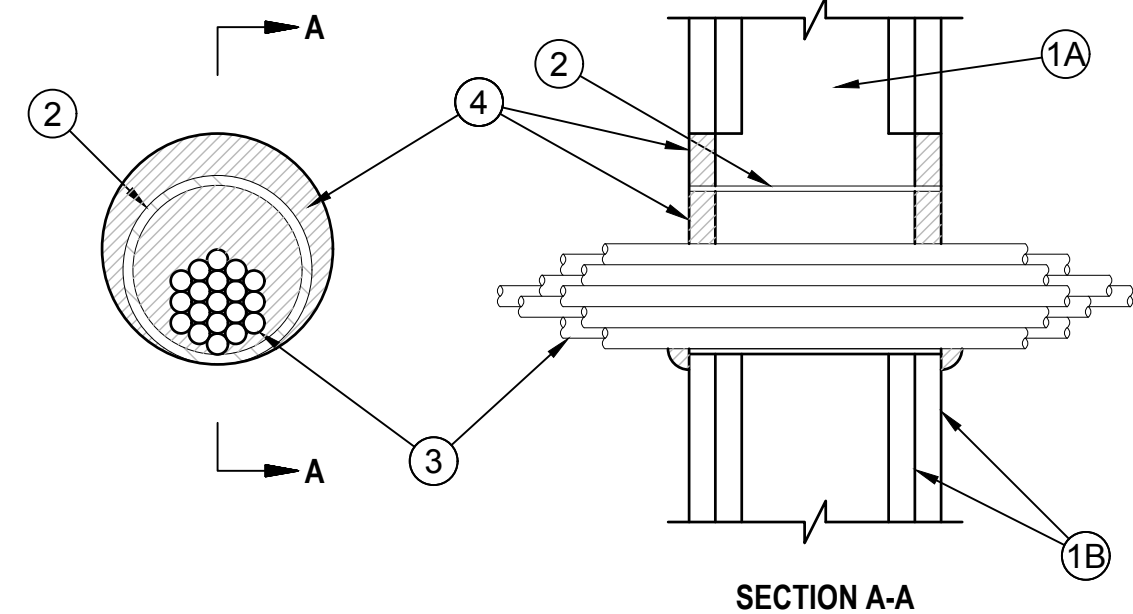

1. WALL ASSEMBLY — THE 1 OR 2 FIRE-RATED GYPSUM WALLBOARD/STUD WALL ASSEMBLY SHALL BE CONSTRUCTED OF THE MATERIALS AND IN THE MANNER SPECIFIED IN THE INDIVIDUAL U300, U400 OR V400 SERIES WALL AND PARTITION DESIGNS IN THE UL FIRE RESISTANCE DIRECTORY AND SHALL INCLUDE THE FOLLOWING CONSTRUCTION FEATURES:
 - A. STUDS — WALL FRAMING MAY CONSIST OF EITHER WOOD STUDS OR STEEL CHANNEL STUDS. WOOD STUDS TO CONSIST OF NOM 2 BY 4 IN. (51 BY 102 MM) LUMBER SPACED 16 IN. (406 MM) OC. STEEL STUDS TO BE MIN 2-1/2 IN. (64 MM) WIDE AND SPACED MAX 24 IN. (610 MM) OC.
 - B. GYPSUM BOARD* — NOM 5/8 IN. (16 MM) THICK GYPSUM BOARD, WITH SQUARE OR TAPERED EDGES. THE GYPSUM BOARD TYPE, THICKNESS, NUMBER OF LAYERS, FASTENER TYPE AND SHEET ORIENTATION SHALL BE AS SPECIFIED IN THE INDIVIDUAL U300, U400 OR V400 SERIES DESIGN IN THE UL FIRE RESISTANCE DIRECTORY. MAX DIAM OF OPENING IS 5-1/2 IN. (138 MM) WHEN SLEEVE (ITEM 2) IS EMPLOYED. MAX DIAM OF OPENING IS 4 IN. (102 MM) WHEN SLEEVE (ITEM 2) IS NOT EMPLOYED.
- THE F RATING OF THE FIRESTOP SYSTEM IS EQUAL TO THE FIRE RATING OF THE WALL ASSEMBLY.
2. METALLIC SLEEVE — (OPTIONAL) — NOM 4 IN. (102 MM) DIAM (OR SMALLER) STEEL ELECTRICAL METALLIC TUBING (EMT) OR SCHEDULE 5 (OR HEAVIER) STEEL PIPE OR MIN 0.016 IN. THICK (0.41 MM, NO. 28 GA) GALV STEEL SLEEVE INSTALLED FLUSH WITH WALL SURFACES. THE ANNULAR SPACE BETWEEN STEEL SLEEVE AND PERIPHERY OF OPENING SHALL BE MIN 0 IN. (0 MM, POINT CONTACT) TO MAX 1 IN. (25 MM), WHEN SCHEDULE 5 STEEL PIPE OR EMT IS USED. SLEEVE MAY EXTEND UP TO 18 IN. (457 MM) BEYOND THE WALL SURFACES.
3. CABLES — AGGREGATE CROSS-SECTIONAL AREA OF CABLE IN OPENING TO BE MAX 45 PERCENT OF THE CROSS-SECTIONAL AREA OF THE OPENING. THE ANNULAR SPACE BETWEEN THE CABLE BUNDLE AND THE PERIPHERY OF THE OPENING TO BE MIN 0 IN. (0 MM, POINT CONTACT) TO MAX 1 IN. (25 MM). CABLES TO BE RIGIDLY SUPPORTED ON BOTH SIDES OF THE WALL ASSEMBLY. ANY COMBINATION OF THE FOLLOWING TYPES AND SIZES OF COPPER CONDUCTOR CABLES MAY BE USED:
 - A. MAX 7/8 IN. (21.9 MM) DIAM SINGLE CONDUCTOR OR MULTI CONDUCTOR TYPE MI CABLE. A MIN 1/8 IN. (3 MM) SEPARATION SHALL BE MAINTAINED BETWEEN MI CABLES AND ANY OTHER TYPES OF CABLE.
 - B. MAX 25 PAIR NO. 24 AWG TELEPHONE CABLE WITH PVC INSULATION AND JACKET.
 - C. TYPE RGU COAXIAL CABLE WITH POLYETHYLENE (PE) INSULATION AND PVC JACKET HAVING A MAX OUTSIDE DIAMETER OF 1/2 IN. (13 MM).
 - D. MULTIPLE FIBER OPTICAL COMMUNICATION CABLE JACKETED WITH PVC AND HAVING A MAX OD OF 5/8 IN. (16 MM).
 - E. THROUGH PENETRATING PRODUCTS* — MAX THREE COPPER CONDUCTOR NO. 8 AWG, METAL-CLAD CABLE*.
- AFC CABLE SYSTEMS INC
- F. MAX 3/8 IN. (9.5 MM) DIAM COPPER GROUND CABLE WITH OR WITHOUT A PVC JACKET.
- G. MAX 3/4 IN. (19 MM) DIAM COPPER GROUND CABLE WITH OR WITHOUT A PVC JACKET.
- H. FIRE RESISTIVE CABLES* — MAX 1-1/4 IN. (32 MM) DIAM SINGLE CONDUCTOR OR MULTI CONDUCTOR TYPE MI CABLE. A MIN 1/8 IN. (3 MM) SEPARATION SHALL BE MAINTAINED BETWEEN MI CABLES AND ANY OTHER TYPES OF CABLE.
- I. MAX 4/8 IN. (12.7 MM) DIAM ALUMINUM SER CABLE WITH PVC INSULATION AND JACKET.
- J. THROUGH PENETRATING PRODUCT* — ANY CABLES, METAL-CLAD CABLE* OR ARMORED CABLE* CURRENTLY CLASSIFIED UNDER THE THROUGH PENETRATING PRODUCTS CATEGORY. SEE THROUGH PENETRATING PRODUCTS CATEGORY. SEE THROUGH PENETRATING PRODUCTS CATEGORY (XHT-V) CATEGORY IN THE FIRE RESISTANCE DIRECTORY FOR NAMES OF MANUFACTURERS.
4. FILL, VOID OR CAVITY MATERIAL* — SEALANT OR PUTTY — FILL MATERIAL APPLIED WITHIN THE ANNULUS, FLUSH WITH EACH END OF THE STEEL SLEEVE OR WALL SURFACE. FILL MATERIAL INSTALLED SYMMETRICALLY ON BOTH SIDES OF THE WALL. A MIN 5/8 IN. (16 MM) THICKNESS OF SEALANT IS REQUIRED FOR THE 1 OR 2 HR F RATING. AN ADDITIONAL 1/2 IN. (13 MM) DIAM BEAD OF FILL MATERIAL SHALL BE APPLIED AROUND THE PERIMETER OF SLEEVE ON BOTH SIDES OF THE WALL WHEN SLEEVE EXTENDS BEYOND SURFACE OF WALL. HILTI CONSTRUCTION CHEMICALS, DIV OF HILTI INC — CP601S, CP666, FS-ONE SEALANTS OR CP618 PUTTY
- *BEARING THE UL CLASSIFICATION MARK

CABLE THROUGH GYPSUM WALL


2

BASIS OF DESIGN

THE FIRE SAFING SEALANTS SHOWN IN DETAILS ARE BASED UPON HILTI CORPORATION PRODUCTS, AND ARE ACCEPTABLE TO FM GLOBAL. PRODUCTS OF OTHER MANUFACTURERS CONFORMING TO THE CRITERIA OF NOTED UL SYSTEMS SHOWN MUST MEET FM GLOBAL STANDARDS. DESIGN MUST MEET ASTM E814 REQUIREMENTS AND FM GLOBAL 4990 APPROVAL STANDARD FOR FIRESTOPPING.


COORDINATE WALL TYPES WITH DRAWING A6.07

| drawing title | | | STATE OF CONNECTICUT DEPARTMENT OF ADMINISTRATIVE SERVICES | |
|------------------|---------|-------------------------------|---|--------------------------|
| FIRESTOP DETAILS | | | REVISIONS | |
| mark | date | description | drawing prepared by | date |
| | 8/4/17 | SCHEMATIC DESIGN SUBMISSION | AMES & WHITAKER ARCHITECTS 31 LIBERTY STREET SOUTHINGTON, CT | 07/25/18 |
| | 1/15/18 | DESIGN DEVELOPMENT SUBMISSION | | scale AS NOTED |
| | 4/16/18 | CONSTRUCTION DOCUMENTS | project WESTERN CT STATE UNIVERSITY WHITE HALL 2ND AND 3RD FLOOR RENOVATIONS DANBURY, CONNECTICUT | drawn by SP/ICA |
| | 5/23/18 | | | approved by AL |
| | 7/25/18 | | drawing no. | A9.02 |
| | | | CAD no. | project no. BI-RD-299 |

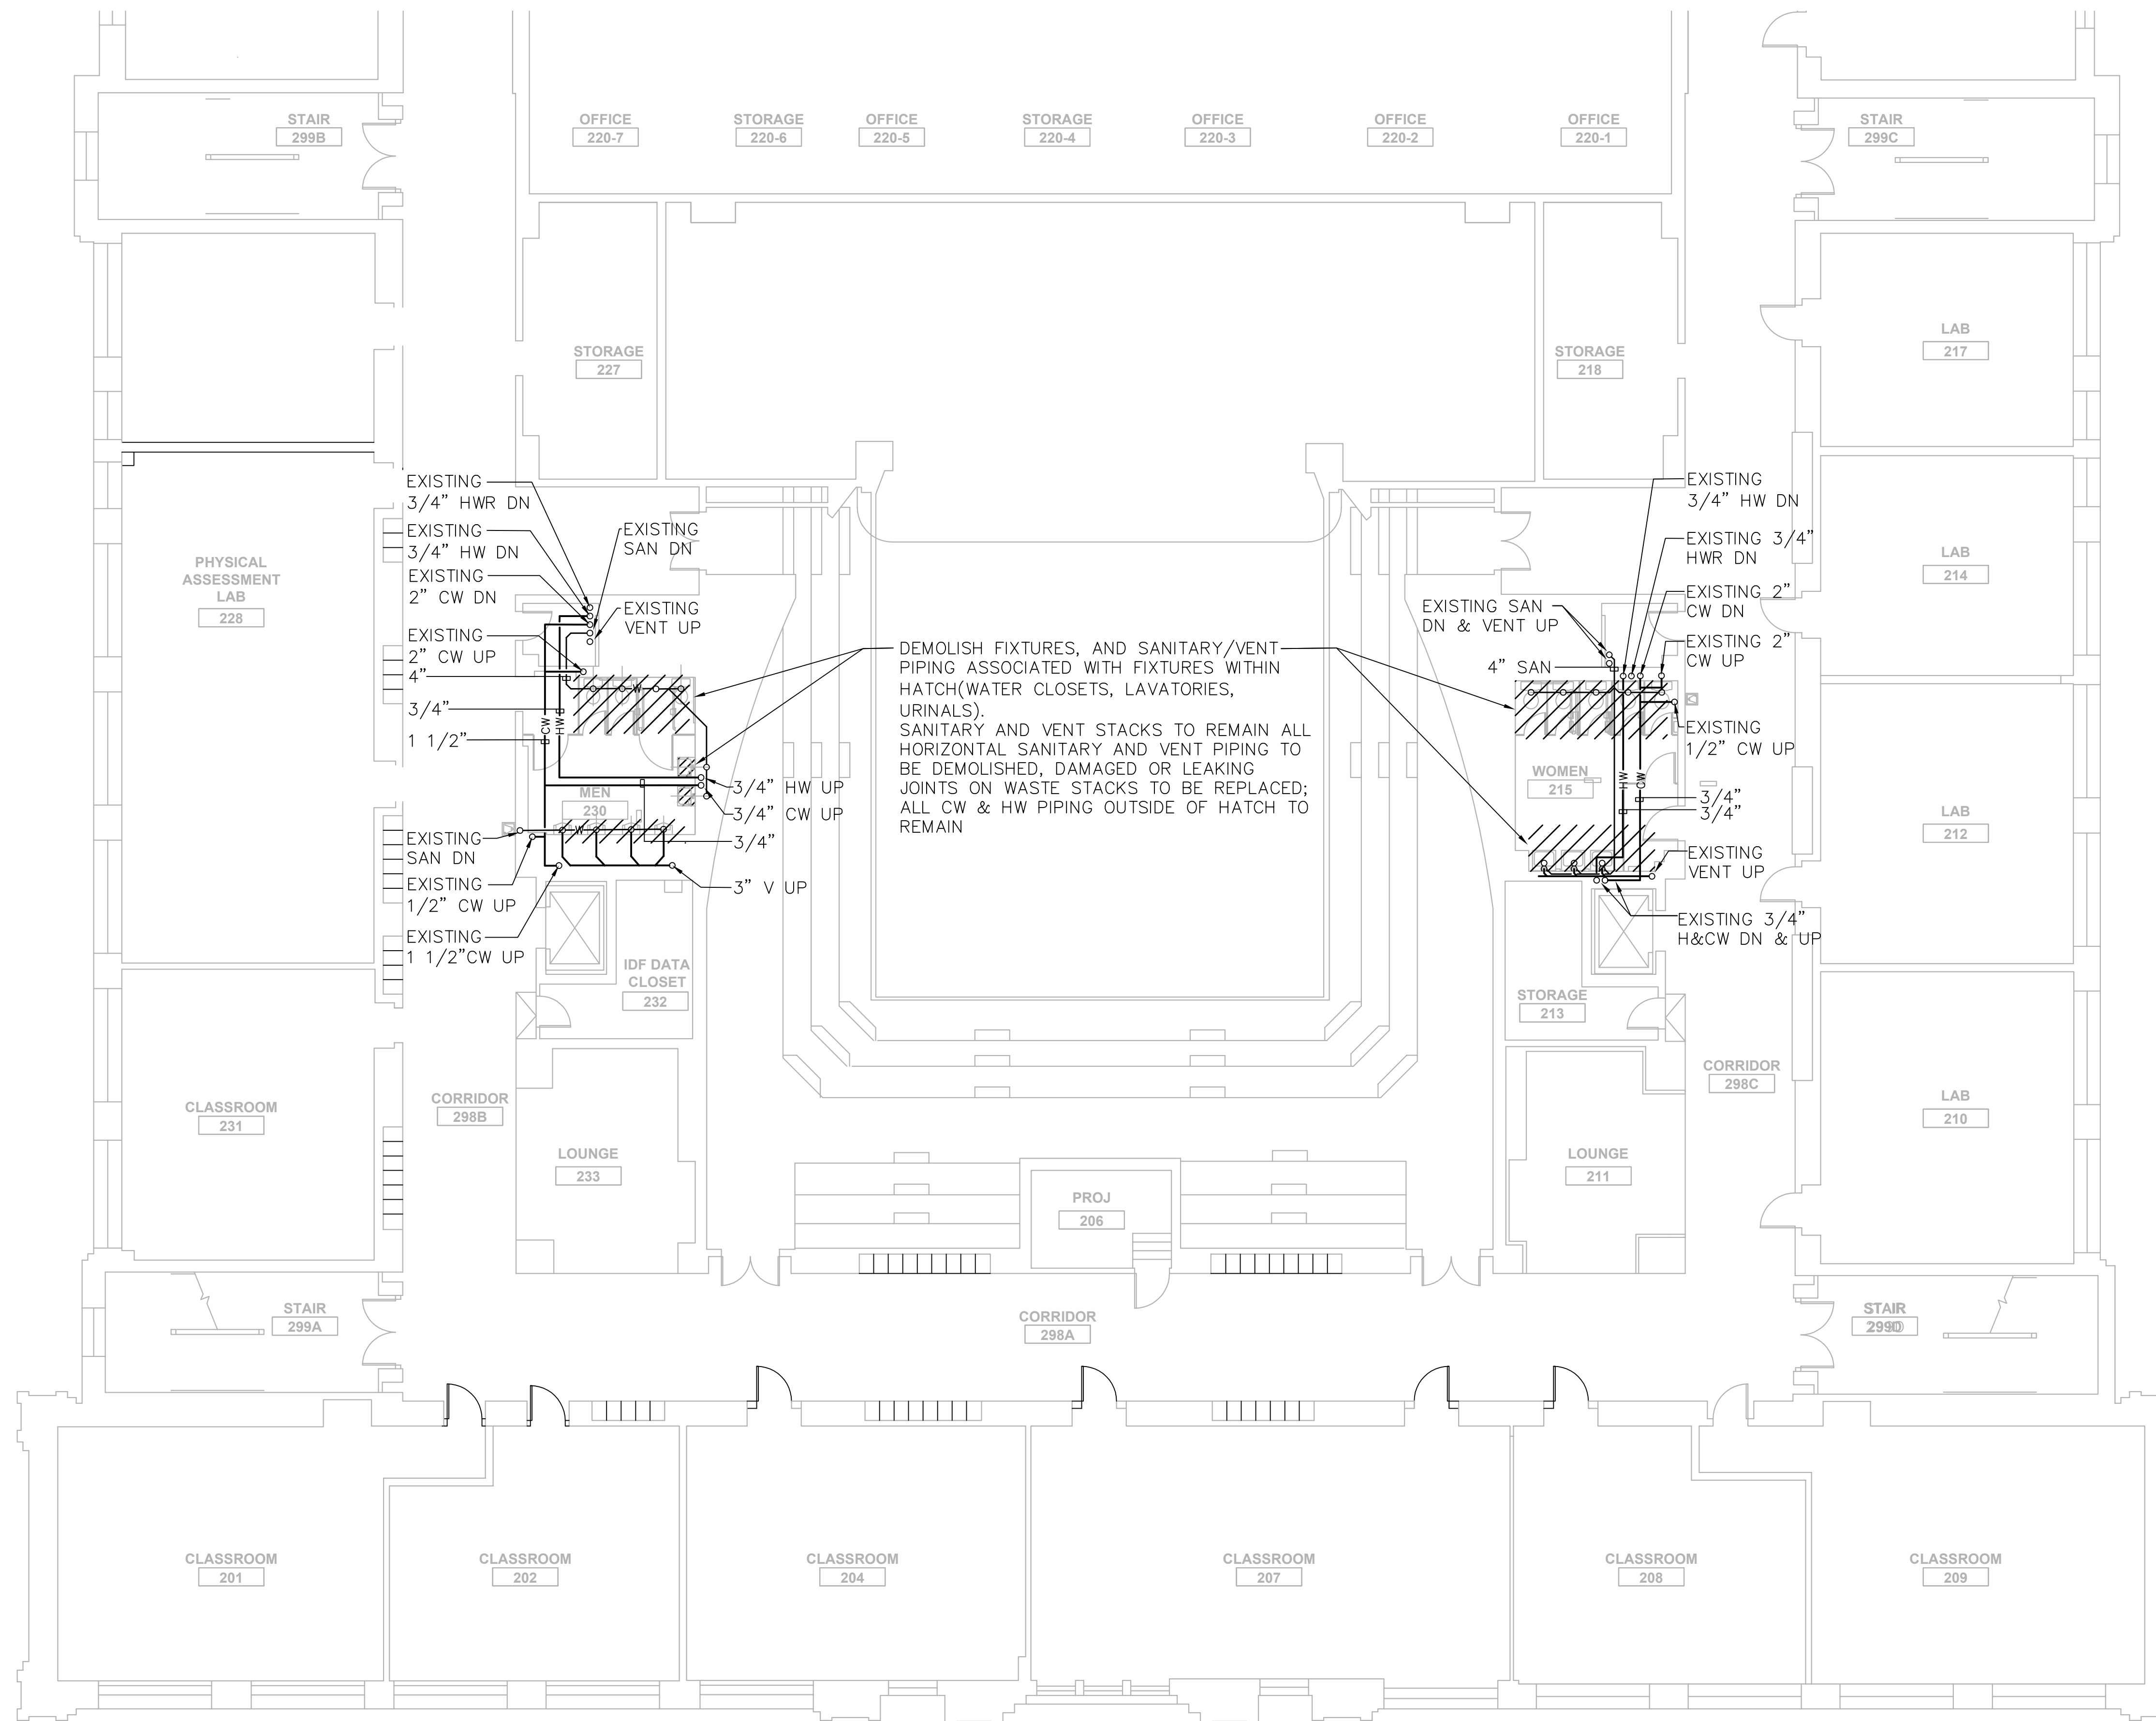


1 SECOND FLOOR PLUMBING DEMOLITION SOUTH
 1/8" = 1' 0"

| | | | | |
|---|---------|-------------------------------|---|------------------------------|
| drawing title PLUMBING SECOND FLOOR - SOUTH DEMO PARTIAL PLAN | | | STATE OF CONNECTICUT DEPARTMENT OF ADMINISTRATIVE SERVICES | |
| REVISIONS | | | | |
| mark | date | description | drawing prepared by | date |
| | 8/4/17 | SCHEMATIC DESIGN SUBMISSION | CONSULTING ENGINEERING SERVICES, INC. 811 MIDDLE STREET MIDDLETOWN, CT | 07/25/18 |
| | 1/15/18 | DESIGN DEVELOPMENT SUBMISSION | | scale AS NOTED |
| | 4/16/18 | CONSTRUCTION DOCUMENTS | project WESTERN CT STATE UNIVERSITY WHITE HALL 2ND AND 3RD FLOOR RENOVATIONS DANBURY, CONNECTICUT | drawn by MDP |
| | 5/23/18 | | | approved by PMA |
| | 1/21/19 | | | drawing no. PD1.01 |
| project no. 61-RD-299 | | | CAD no. | |

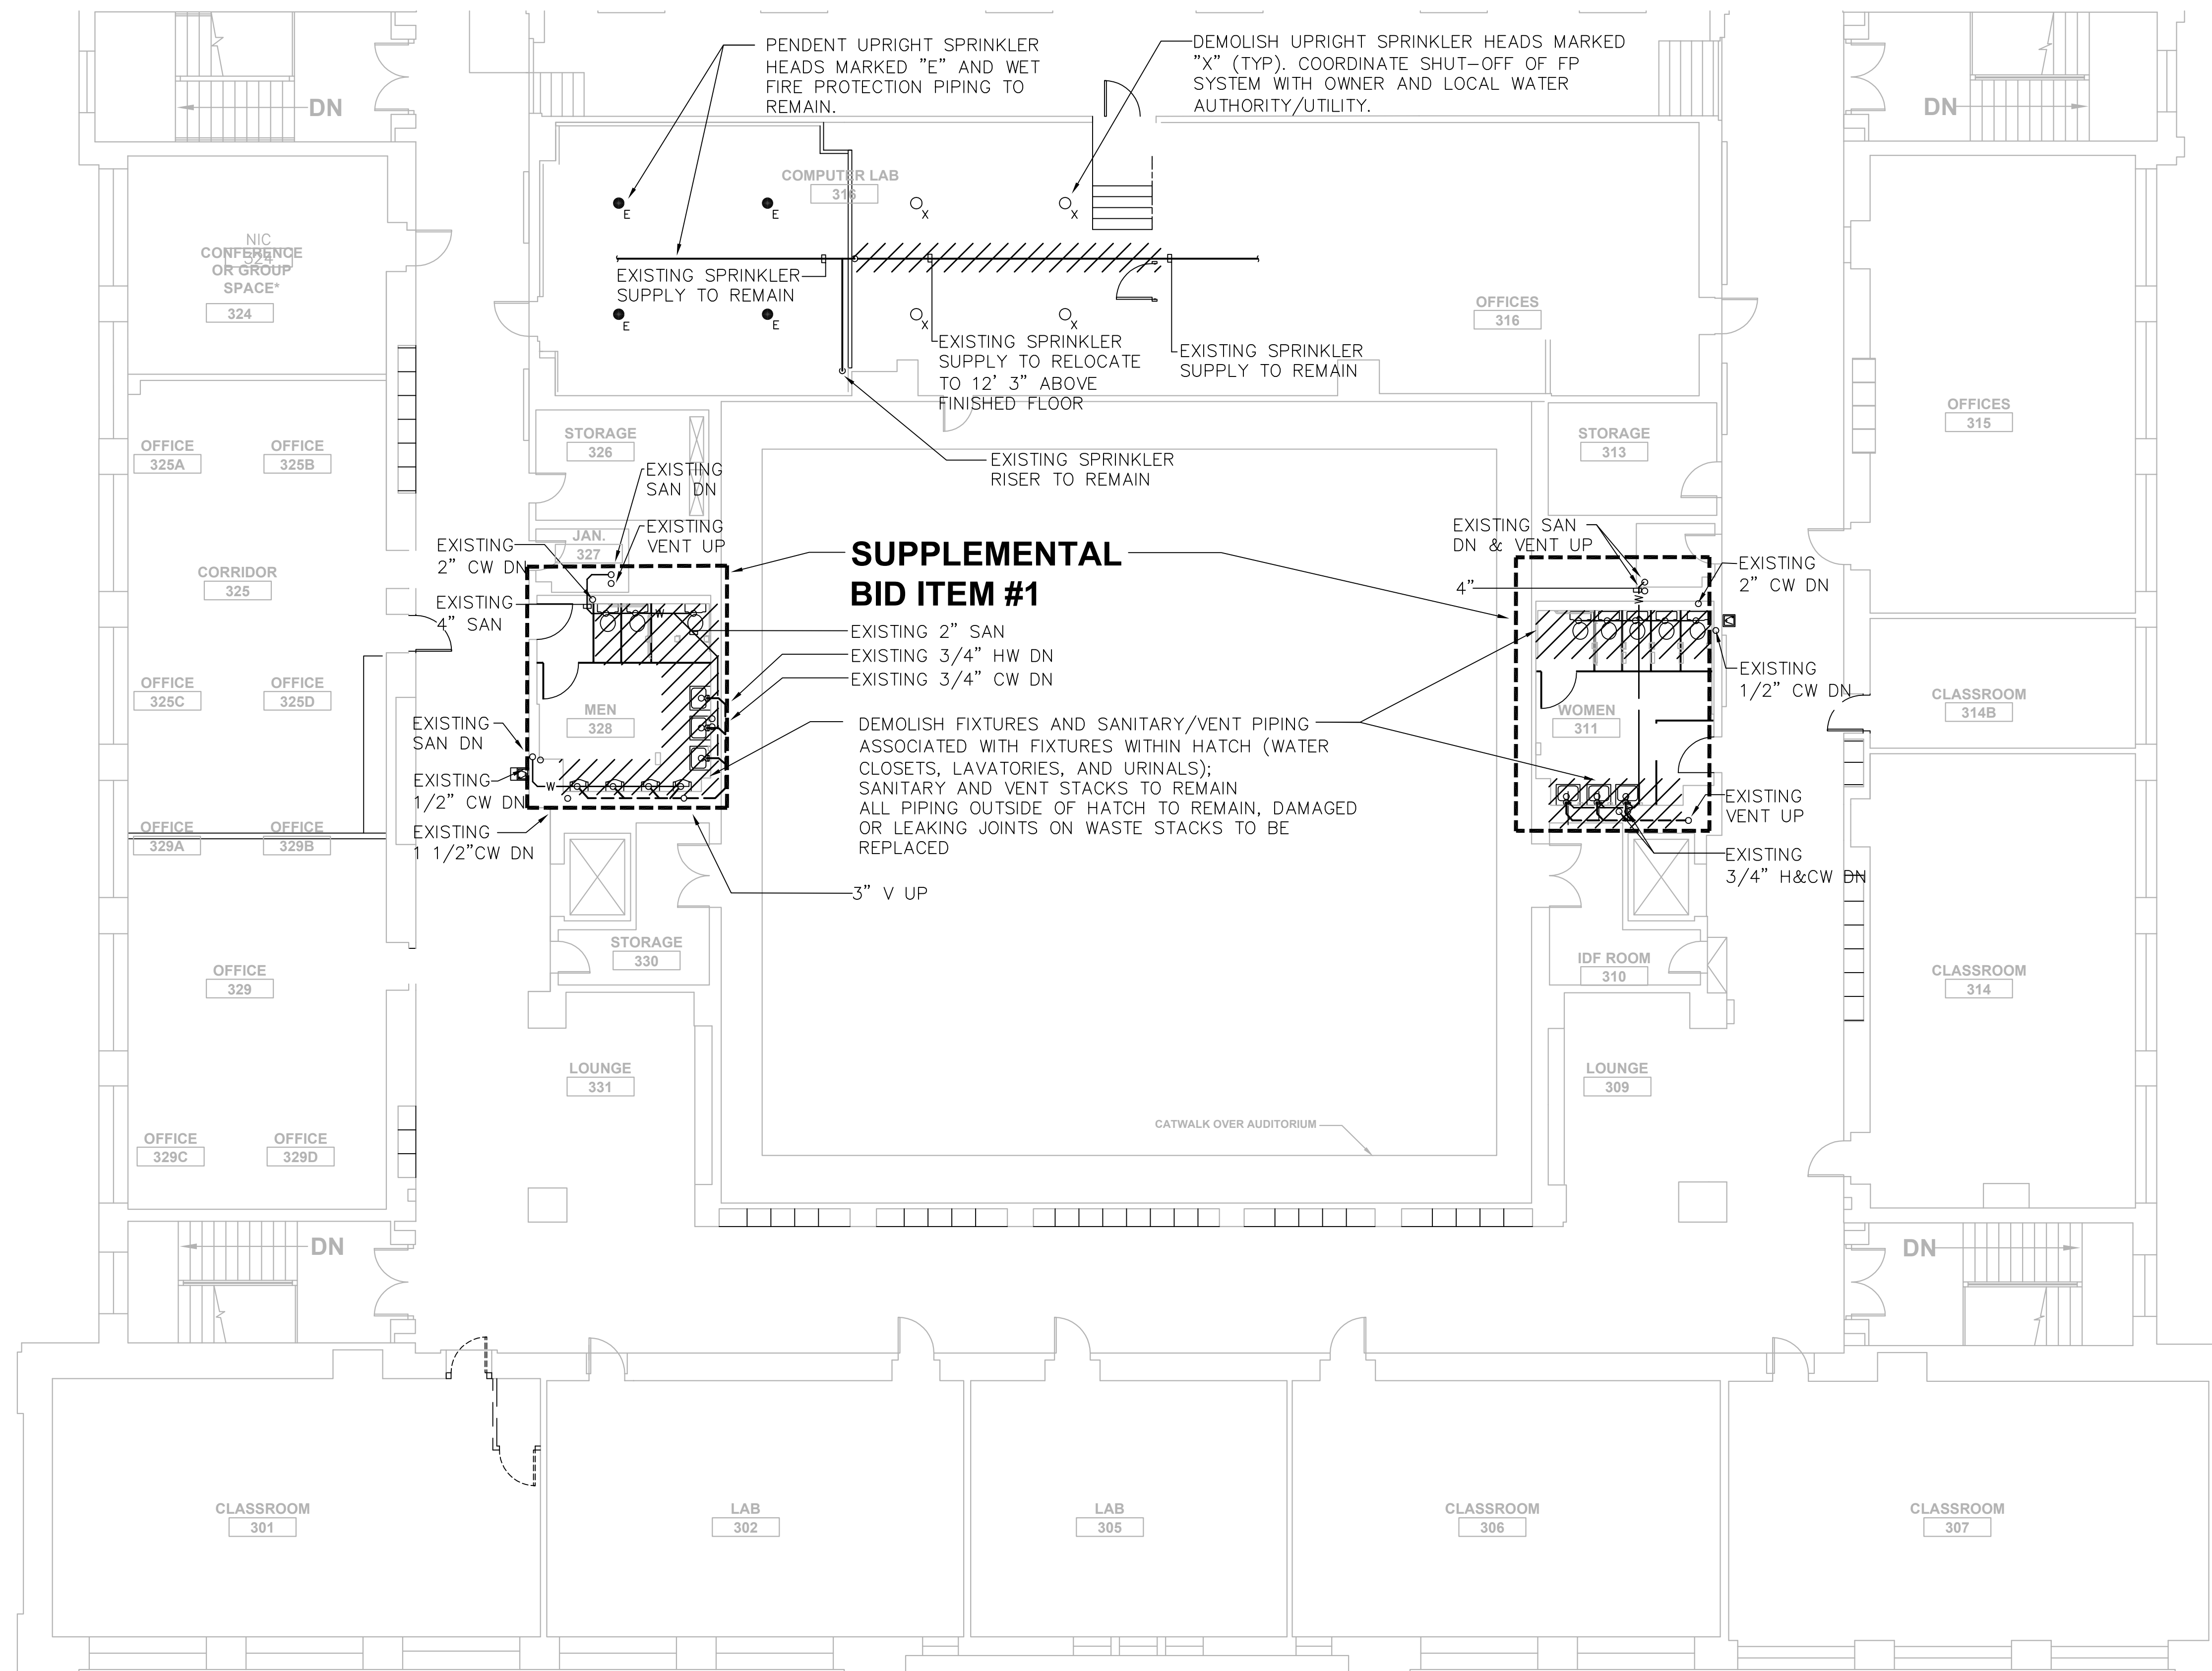

1 THIRD FLOOR FIRE PROTECTION & PLUMBING DEMOLITION SOUTH
 1/8" = 1' 0"

| | | | | | |
|---|---------|-------------------------------|--|--------------------|------------------------------|
| drawing title PLUMBING THIRD FLOOR - SOUTH DEMO PARTIAL PLAN | | | STATE OF CONNECTICUT DEPARTMENT OF ADMINISTRATIVE SERVICES | | |
| REVISIONS | | | drawing prepared by CONSULTING ENGINEERING SERVICES, INC. 811 MIDDLE STREET MIDDLETOWN, CT | | |
| mark | date | description | date | scale | AS NOTED |
| | 8/4/17 | SCHEMATIC DESIGN SUBMISSION | 07/25/18 | | |
| | 1/15/18 | DESIGN DEVELOPMENT SUBMISSION | | | |
| | 4/16/18 | CONSTRUCTION DOCUMENTS | | | |
| | 5/23/18 | | | | |
| | 7/25/18 | | | | |
| | 1/21/19 | | | | |
| project WESTERN CT STATE UNIVERSITY WHITE HALL 2ND AND 3RD FLOOR RENOVATIONS DANBURY, CONNECTICUT | | | drawn by MDP | approved by PMA | drawing no. PD1.02 |
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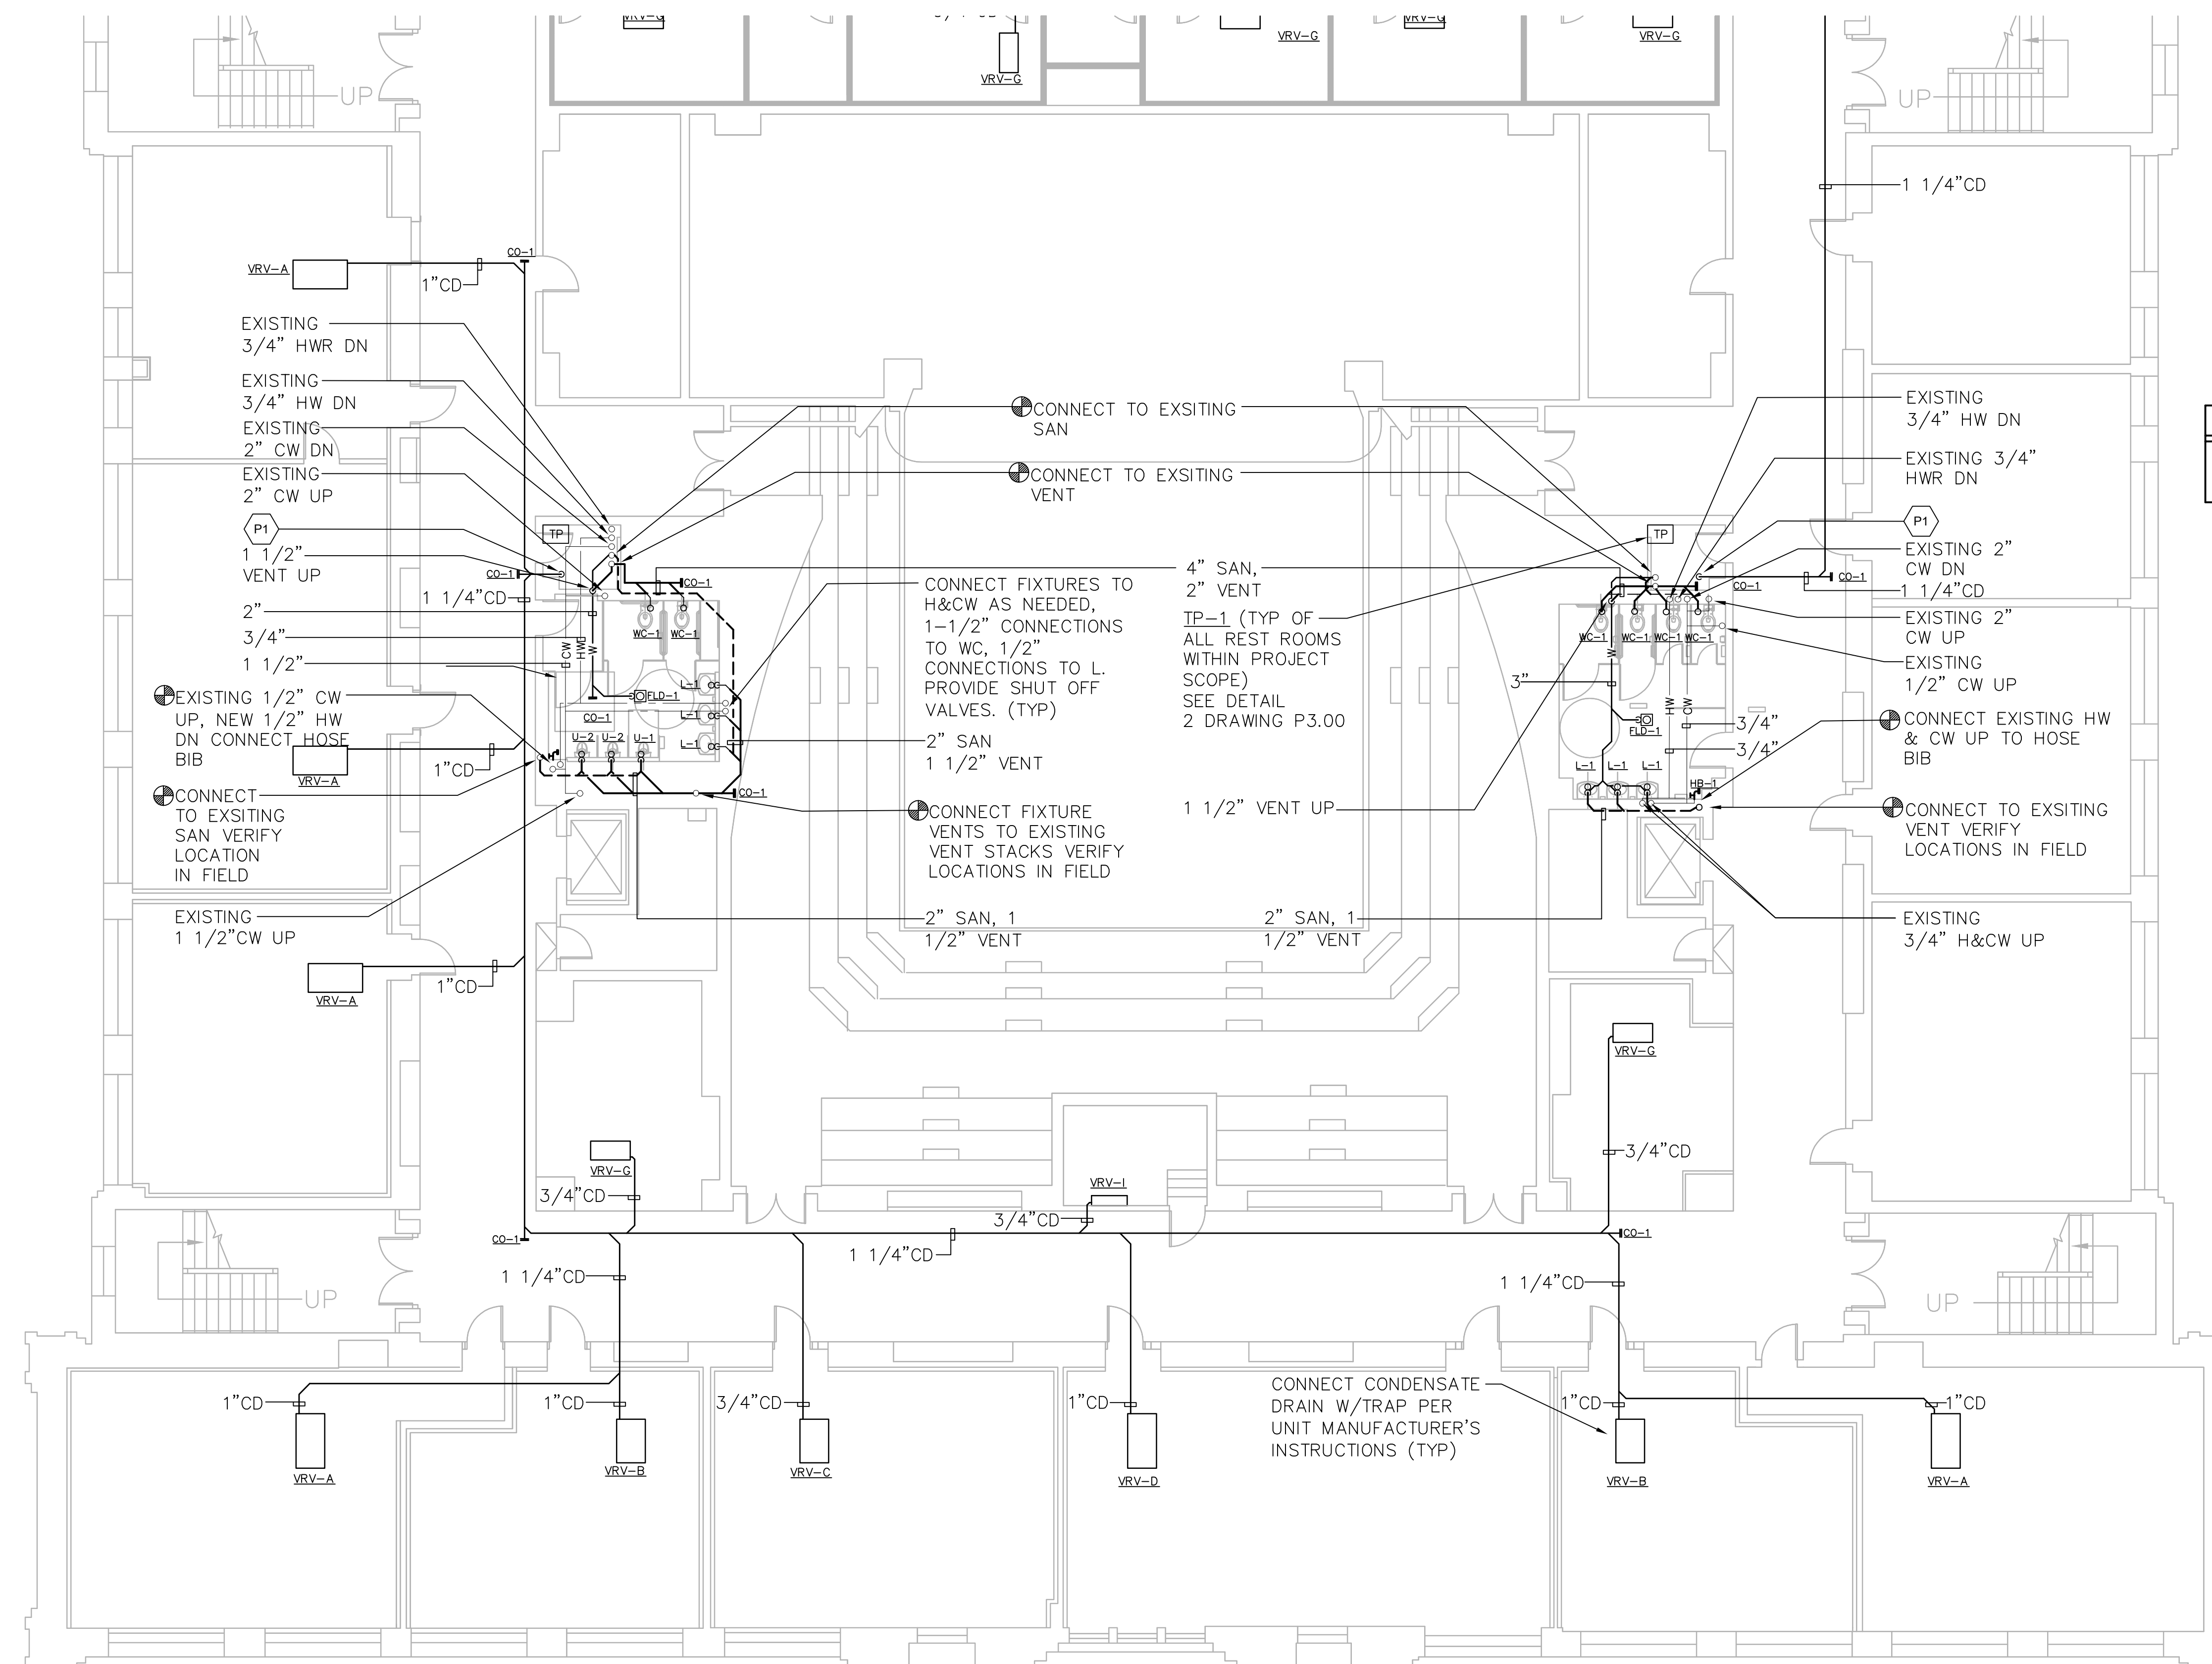


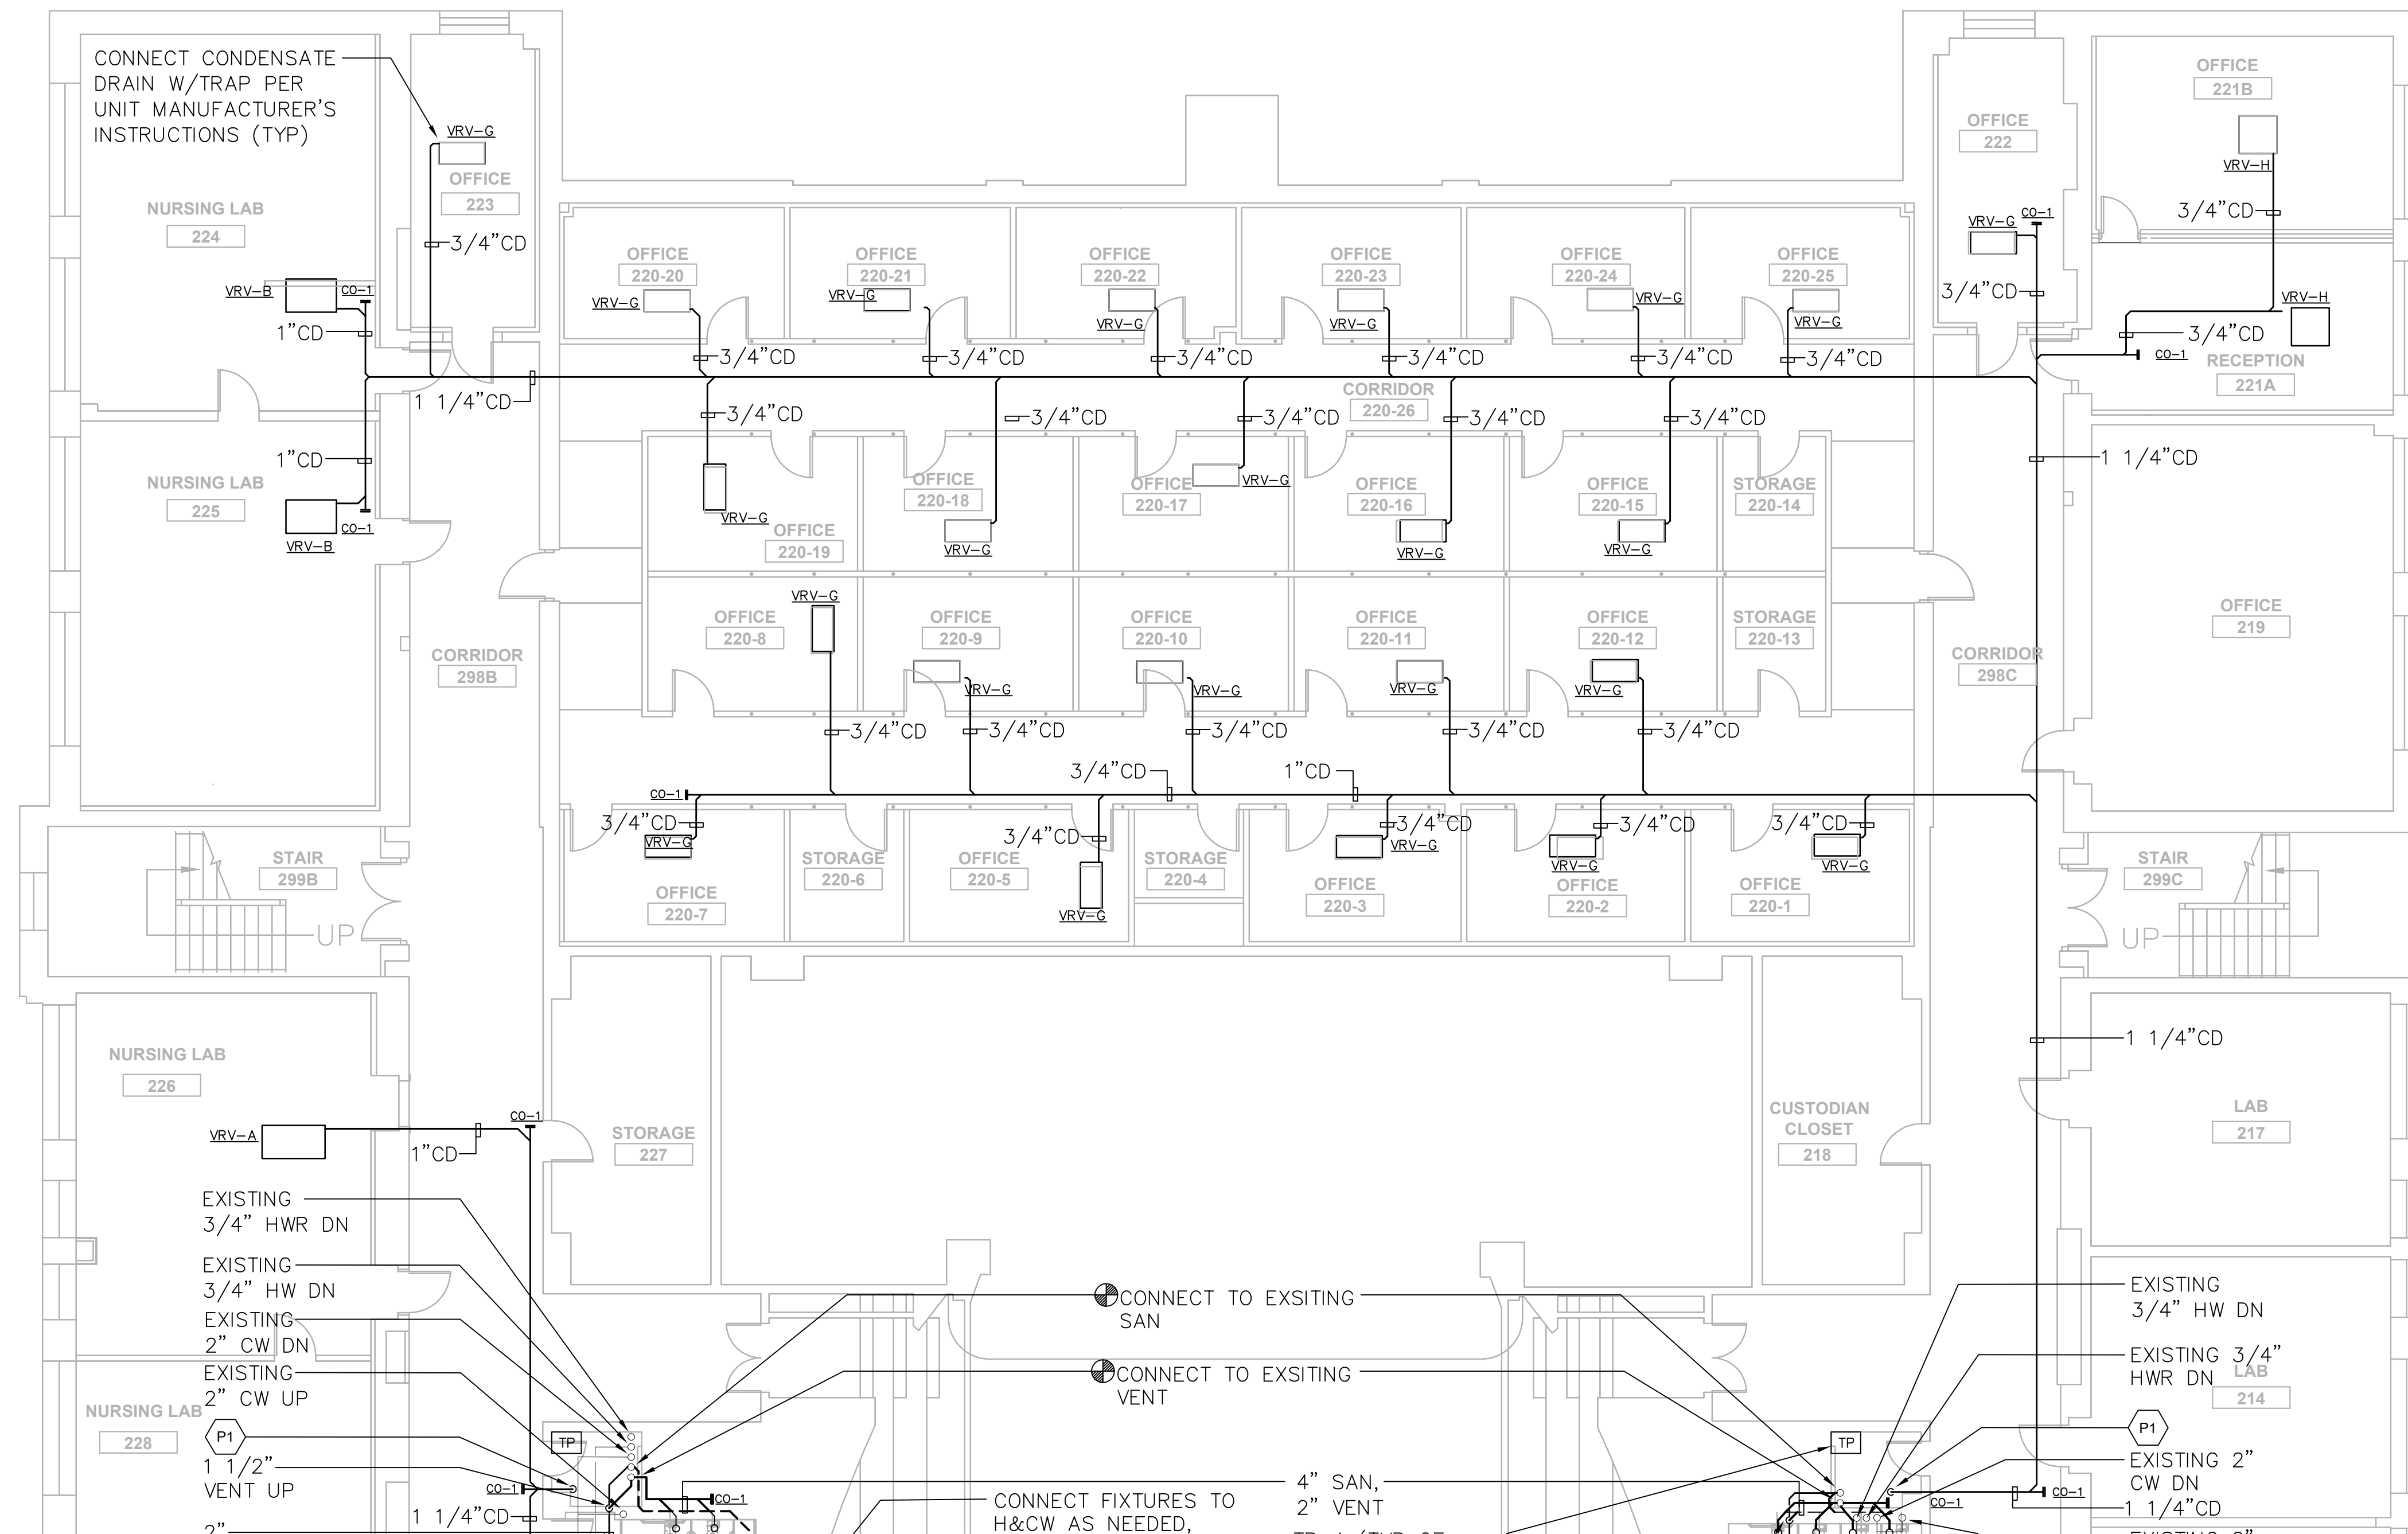PLUMBING KEY NOTES

P1 CONDENSATE DRAIN (CD) DOWN TO INDIRECT DRAIN INTO EXISTING JANITOR'S SINK

1 SECOND FLOOR PARTIAL PLUMBING NORTH
 1/8" = 1' 0"

| | | | | |
|--|---------|-------------------------------|---|--------------------------|
| drawing title PLUMBING SECOND FLOOR - NORTH PARTIAL PLAN | | | STATE OF CONNECTICUT DEPARTMENT OF ADMINISTRATIVE SERVICES | |
| REVISIONS | | | | |
| mark | date | description | drawing prepared by | date |
| | 8/4/17 | SCHEMATIC DESIGN SUBMISSION | CONSULTING ENGINEERING SERVICES, INC. 811 MIDDLE STREET MIDDLETOWN, CT | 07/25/18 |
| | 1/15/18 | DESIGN DEVELOPMENT SUBMISSION | | scale AS NOTED |
| | 4/16/18 | CONSTRUCTION DOCUMENTS | project WESTERN CT STATE UNIVERSITY WHITE HALL 2ND AND 3RD FLOOR RENOVATIONS DANBURY, CONNECTICUT | drawn by MDP |
| | 5/23/18 | | | approved by PMA |
| | 7/25/18 | | | drawing no. |
| | 1/21/19 | | | P1.01 |
| | | | CAD no. | project no. 61-RD-299 |




PLUMBING KEY NOTES

P1 CONDENSATE DRAIN (CD) DOWN TO INDIRECT DRAIN INTO EXISTING JANITOR'S SINK

1 SECOND FLOOR PARTIAL PLUMBING SOUTH
 1/8" = 1' 0"

| drawing title | | | STATE OF CONNECTICUT DEPARTMENT OF ADMINISTRATIVE SERVICES | | |
|--|-------------------------------|-------------------------------|--|---|-----------------------------|
| PLUMBING SECOND FLOOR - SOUTH PARTIAL PLAN | | | | | |
| REVISIONS | | | | | |
| mark | date | description | drawing prepared by | date | |
| | 8/4/17 | SCHEMATIC DESIGN SUBMISSION | CONSULTING ENGINEERING SERVICES, INC. 811 MIDDLE STREET MIDDLETOWN, CT | 07/25/18 | |
| | 1/15/18 | DESIGN DEVELOPMENT SUBMISSION | | scale AS NOTED | |
| | 4/16/18 | CONSTRUCTION DOCUMENTS | | project WESTERN CT STATE UNIVERSITY WHITE HALL 2ND AND 3RD FLOOR RENOVATIONS DANBURY, CONNECTICUT | drawn by MDP |
| | 5/23/18 7/25/18 1/21/19 | | | approved by PMA | drawing no. P1.02 |
| CAD no. | | | project no. 61-RD-299 | | |

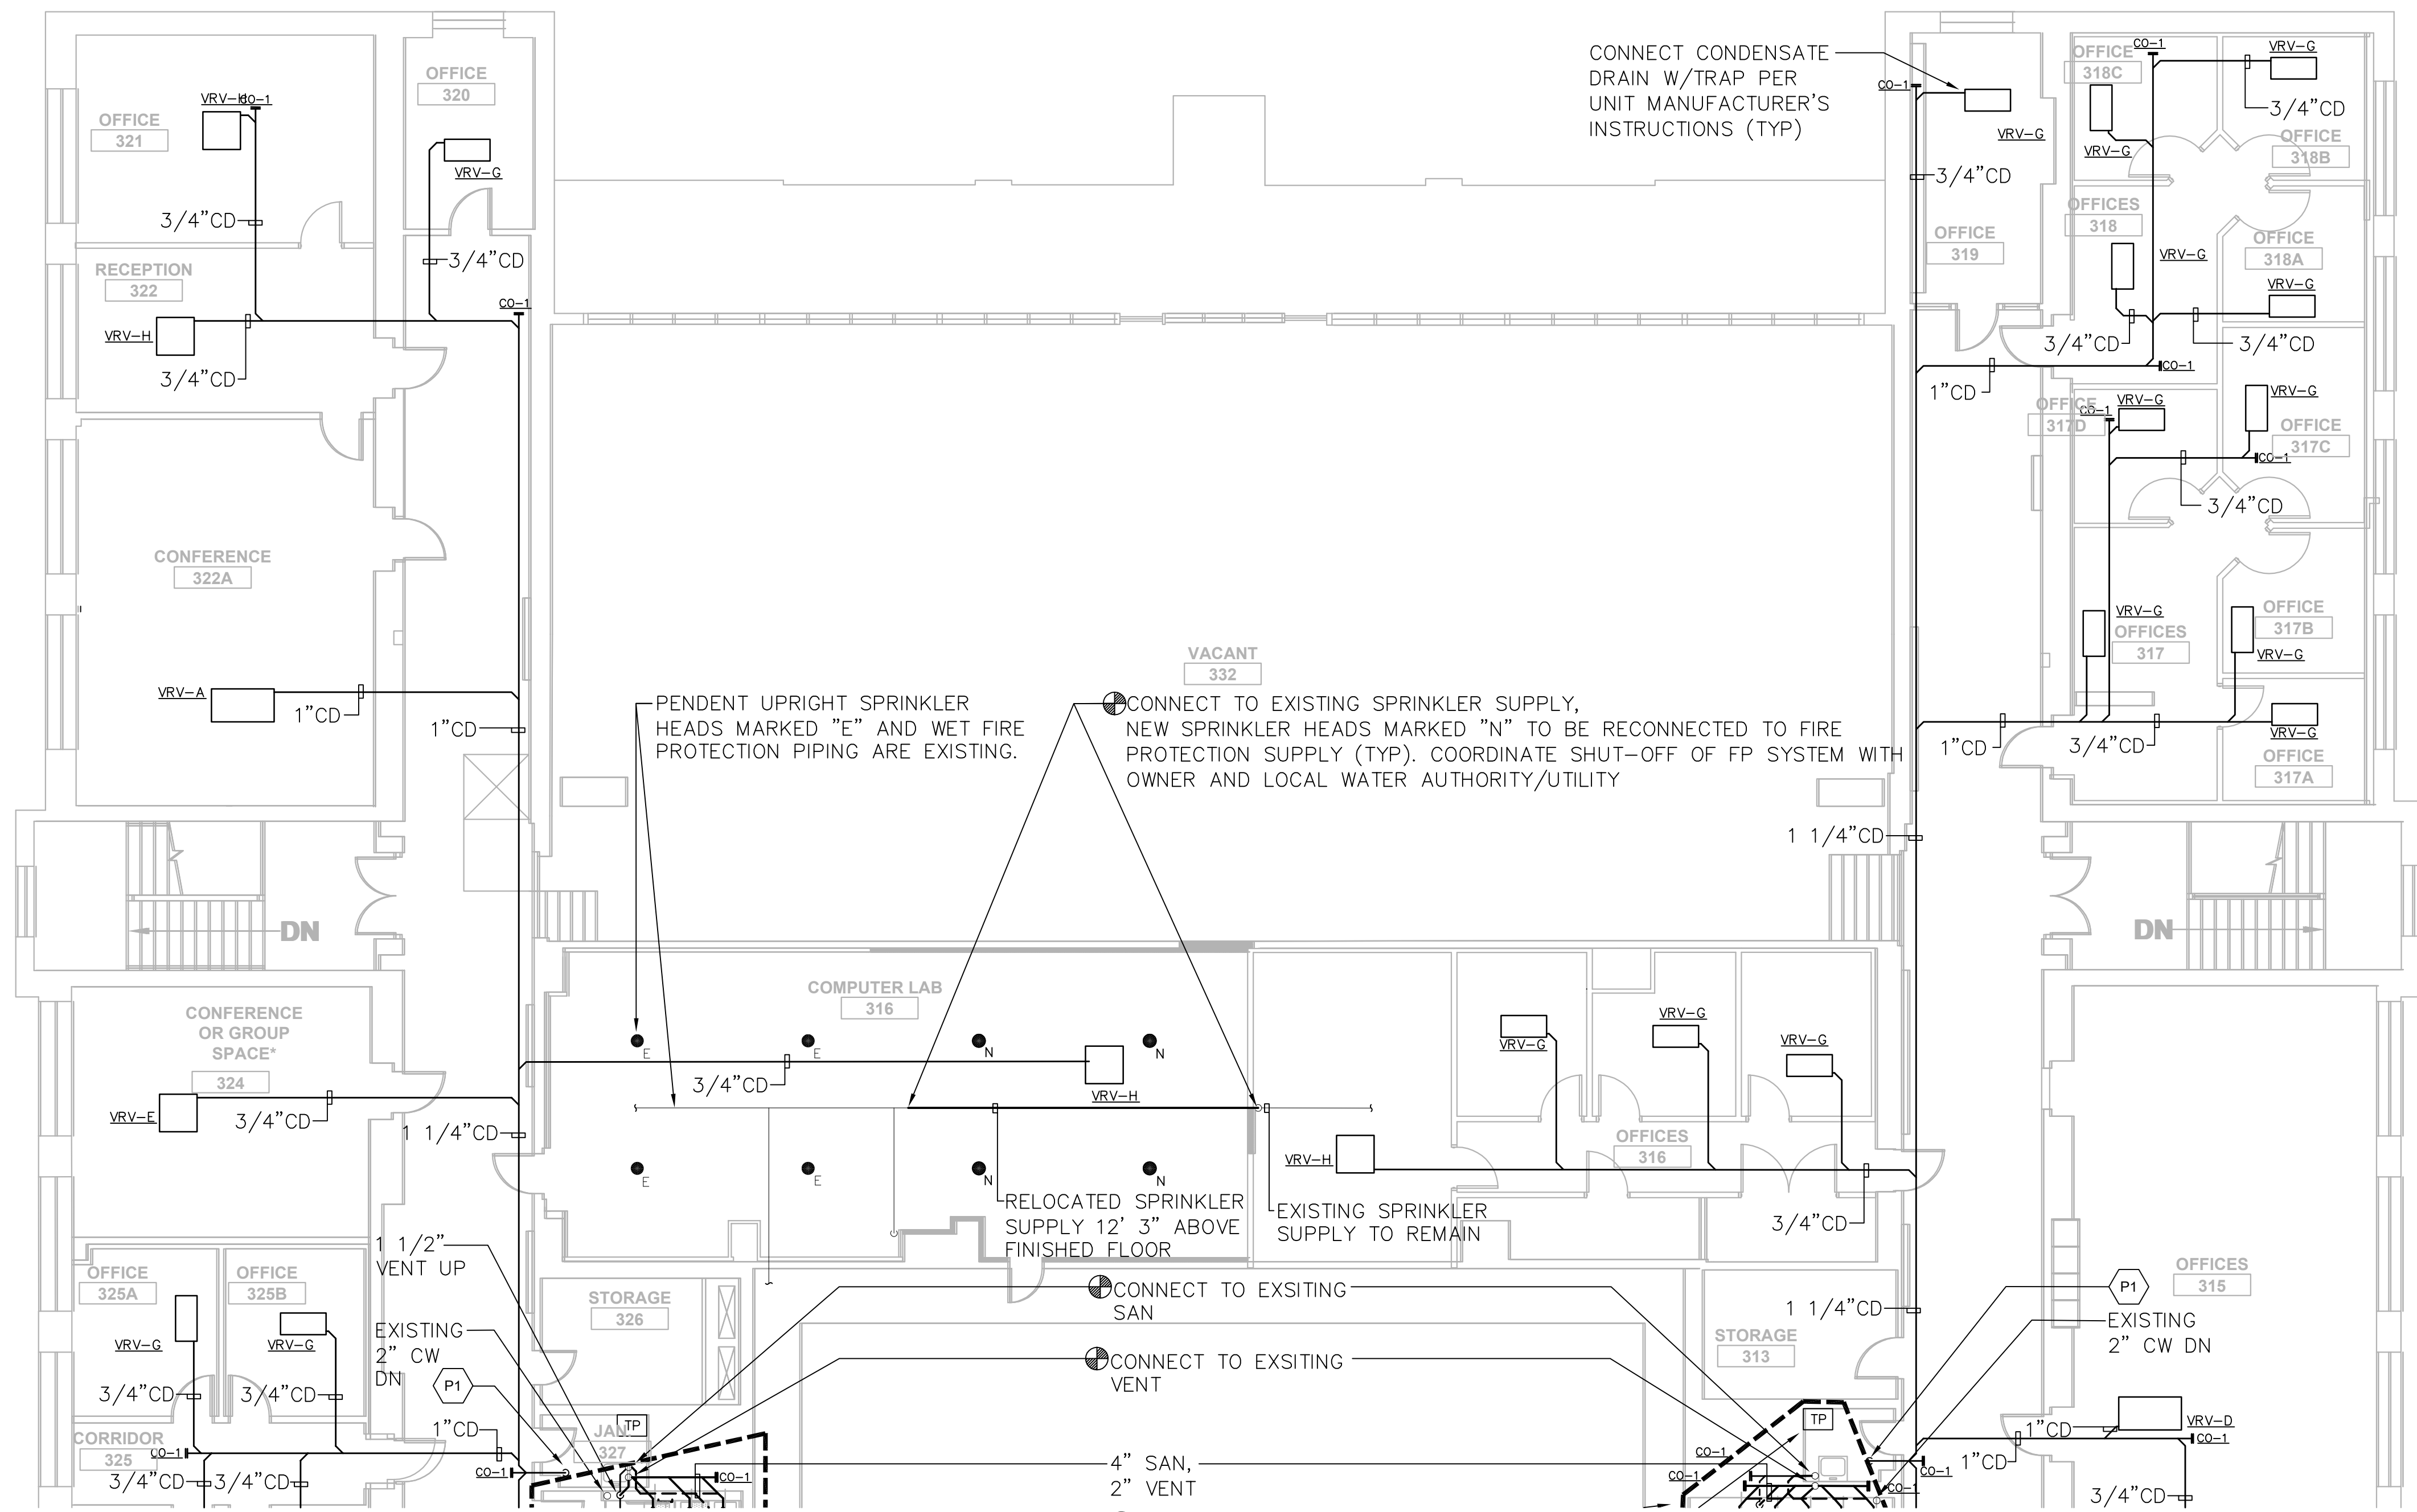


PLUMBING KEY NOTES

P1 CONDENSATE DRAIN (CD) DOWN TO INDIRECT DRAIN INTO EXISTING JANITOR'S SINK

1 THIRD FLOOR PARTIAL FIRE PROTECTION & PLUMBING NORTH
 1/8" = 1' 0"

| REVISIONS | | | STATE OF CONNECTICUT DEPARTMENT OF ADMINISTRATIVE SERVICES | |
|-----------|---------|-------------------------------|---|--------------------|
| mark | date | description | drawing prepared by | date |
| | 8/4/17 | SCHEMATIC DESIGN SUBMISSION | CONSULTING ENGINEERING SERVICES, INC. 811 MIDDLE STREET MIDDLETOWN, CT | 07/25/18 |
| | 1/15/18 | DESIGN DEVELOPMENT SUBMISSION | | scale AS NOTED |
| | 4/16/18 | CONSTRUCTION DOCUMENTS | project WESTERN CT STATE UNIVERSITY WHITE HALL 2ND AND 3RD FLOOR RENOVATIONS DANBURY, CONNECTICUT | drawn by MDP |
| | 5/23/18 | | | approved by PMA |
| | 7/25/18 | | | drawing no. |
| | 1/21/19 | | | P1.03 |
| CAD no. | | project no. 61-RD-299 | | |

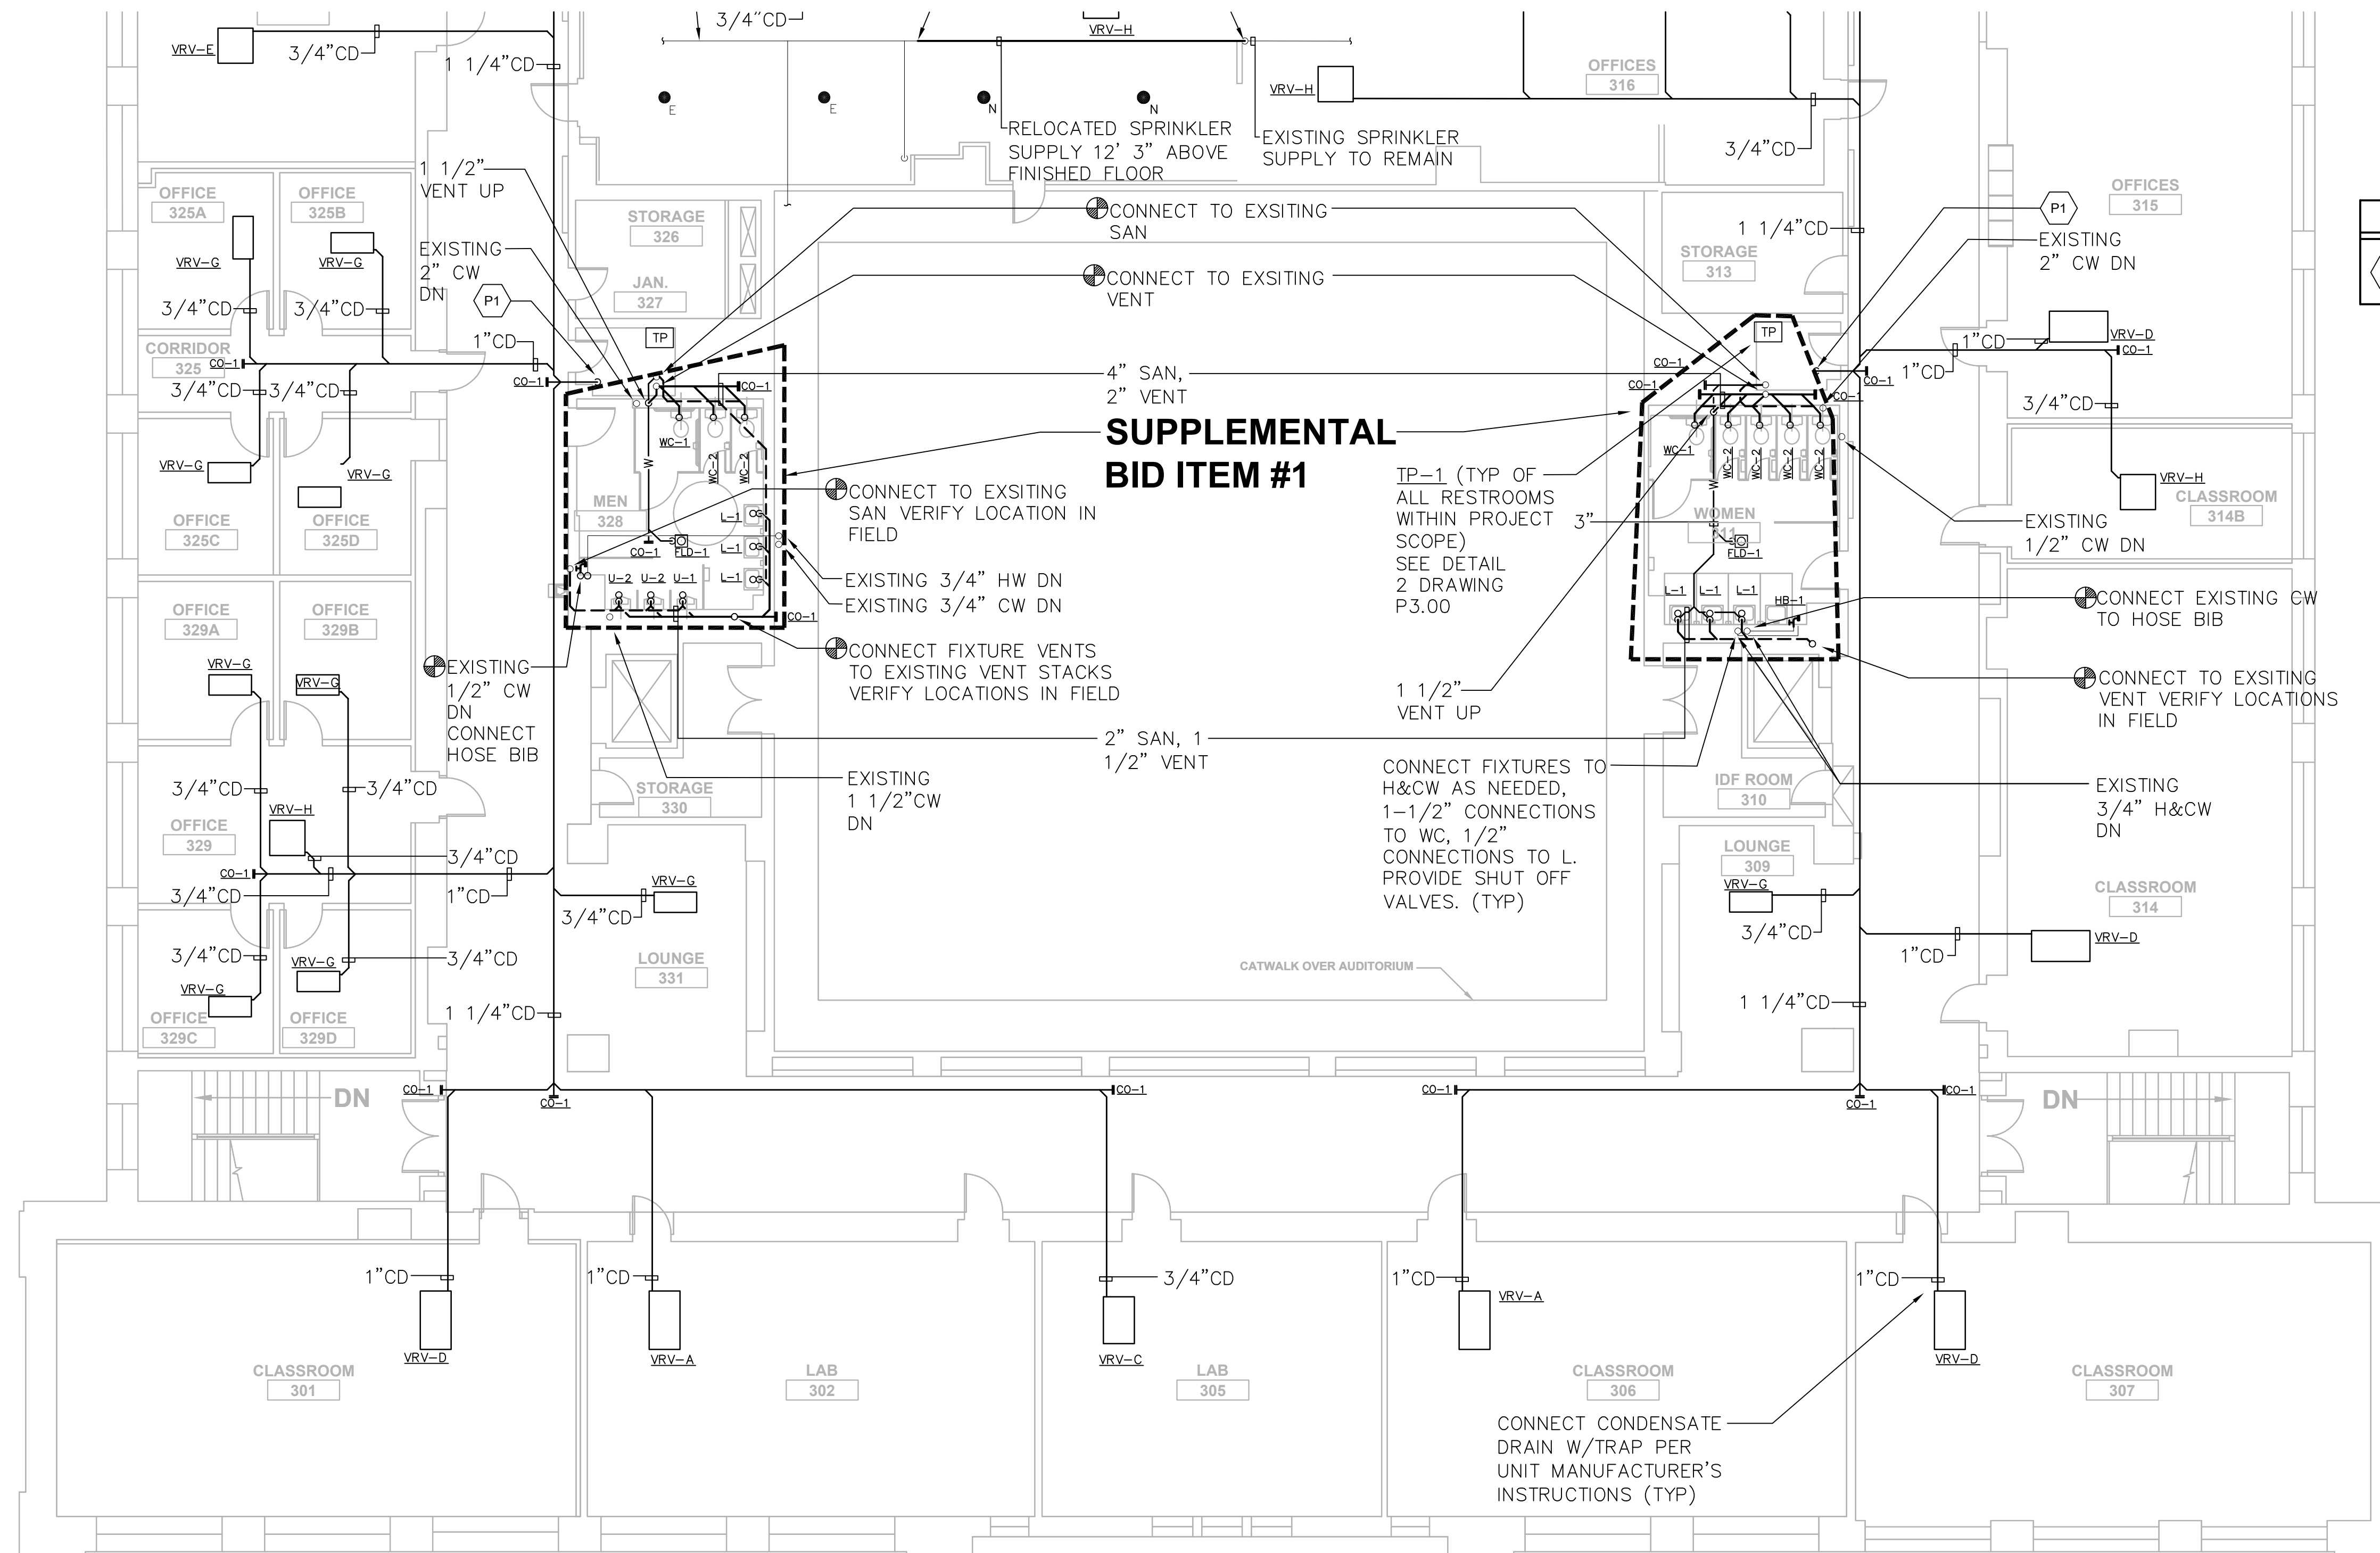

| PLUMBING KEY NOTES | |
|--------------------|---|
| | CONDENSATE DRAIN (CD) DOWN TO INDIRECT DRAIN INTO EXISTING JANITOR'S SINK |

SUPPLEMENTAL BID ITEM #1

TP-1 (TYP OF ALL RESTROOMS WITHIN PROJECT SCOPE) SEE DETAIL 2 DRAWING P.3.00

CONNECT FIXTURES TO H&CW AS NEEDED, 1-1/2" CONNECTIONS TO WC, 1/2" CONNECTIONS TO L. PROVIDE SHUT OFF VALVES. (TYP)

1 THIRD FLOOR PARTIAL PLUMBING SOUTH
1/8" = 1' 0"

| drawing title | | | STATE OF CONNECTICUT | |
|--|---------|-------------------------------|--|--------------------|
| FIRE PROTECTION & PLUMBING | | | DEPARTMENT OF ADMINISTRATIVE SERVICES | |
| PARTIAL THIRD FLOOR - NORTH PARTIAL PLAN | | | | |
| REVISIONS | | | | |
| mark | date | description | drawing prepared by | date |
| | 8/4/17 | SCHEMATIC DESIGN SUBMISSION | CONSULTING ENGINEERING SERVICES, INC. 811 MIDDLE STREET MIDDLETOWN, CT | 07/25/18 |
| | 1/15/18 | DESIGN DEVELOPMENT SUBMISSION | | scale AS NOTED |
| | 4/16/18 | CONSTRUCTION DOCUMENTS | project | drawn by MDP |
| | 5/23/18 | | WESTERN CT STATE UNIVERSITY | approved by PMA |
| | 7/25/18 | | WHITE HALL | drawing no. |
| | 1/21/19 | | 2ND AND 3RD FLOOR RENOVATIONS | |
| | | | DANBURY, CONNECTICUT | |
| | | | CAD no. | P1.04 |
| | | | project no. 61-RD-299 | |

FIRE PROTECTION GENERAL NOTES

- THESE GENERAL NOTES ARE APPLICABLE TO ALL FIRE PROTECTION DRAWINGS.
- DRAWINGS ARE DIAGRAMMATIC AND SHOW GENERAL INTENT OF WORK. SEE DETAILS, SCHEDULES AND SPECIFICATIONS FOR ADDITIONAL INFORMATION.
- FIRE PROTECTION CONTRACTOR MUST REVIEW DRAWINGS OF THE OTHER TRADES AS PART OF THIS CONTRACT FOR ADDITIONAL WORK REQUIRED AND OR COORDINATION OF HIS WORK FOR OPERATIONS OR CONNECTIONS TO OTHER SYSTEMS.
- THE FIRE PROTECTION CONTRACTOR IS RESPONSIBLE FOR COORDINATING SHUTOFF OF SYSTEM WITH BUILDING OWNER AND LOCAL AUTHORITY HAVING JURISDICTION.
- THE FIRE PROTECTION CONTRACTOR IS RESPONSIBLE FOR COORDINATION WITH STRUCTURAL MEMBERS. NEW PIPING SHALL NOT BE INSTALLED WHERE IT WILL REQUIRE MODIFICATION OF STRUCTURE. NEW PIPING SHALL BE OFF-SET OR ROUTED AROUND STRUCTURE.

PLUMBING GENERAL NOTES

- THESE GENERAL NOTES ARE APPLICABLE TO ALL PLUMBING DRAWINGS.
- DRAWINGS ARE DIAGRAMMATIC AND SHOW GENERAL INTENT OF WORK. SEE DETAILS, SCHEDULES AND SPECIFICATIONS FOR ADDITIONAL INFORMATION.
- PLUMBING CONTRACTOR MUST REVIEW DRAWINGS OF THE OTHER TRADES AS PART OF THIS CONTRACT FOR ADDITIONAL WORK REQUIRED AND OR COORDINATION OF HIS WORK FOR OPERATIONS OR CONNECTIONS TO OTHER SYSTEMS.
- THE PLUMBING CONTRACTOR IS RESPONSIBLE FOR PROVIDING & INSTALLING ALL SERVICES TO HVAC EQUIPMENT INCLUDING BUT NOT LIMITED TO: GAS SUPPLY PIPING CONDENSATE PIPING, COLD WATER MAKE-UP PIPING DRAINS, & CONNECTIONS TO AIR HANDLING UNITS, FAN COIL UNITS, UNIT HEATERS, BOILERS, CHILLERS, ETC. ALSO, DEVICES REQUIRED INCLUDE BACKFLOW PREVENTERS, REGULATORS, UNIONS, TRAPS, & SHUT-OFF VALVES REQUIRED FOR THIS EQUIPMENT. REFER TO HVAC DWGS. FOR ADDITIONAL INFORMATION AND COORDINATION.
- THE PLUMBING CONTRACTOR SHALL PROVIDE PIPE EXPANSION JOINTS ON PIPING PASSING THRU ALL BUILDING EXPANSION JOINT LOCATIONS AS REQUIRED PER BUILDING CODES WHETHER OR NOT SHOWN ON DRAWINGS. REVIEW ARCHITECTURAL AND STRUCTURAL DRAWINGS FOR EXACT BUILDING EXPANSION JOINT LOCATIONS AND EXPANSION DIMENSIONS.
- THE PLUMBING CONTRACTOR IS RESPONSIBLE FOR PROVIDING NEW DOMESTIC WATER SUPPLY (HOT & COLD), WASTE, AND VENT PIPING TO ALL FIXTURES, THROUGHOUT THE PROJECT.
- THE PLUMBING CONTRACTOR IS RESPONSIBLE FOR COORDINATION WITH STRUCTURAL MEMBERS. NEW PIPING SHALL NOT BE INSTALLED WHERE IT WILL REQUIRE MODIFICATION OF STRUCTURE. NEW PIPING SHALL BE OFF-SET OR ROUTED AROUND STRUCTURE.

PLUMBING PIPING LEGEND

| SYMBOL | DESCRIPTION |
|--------|---------------------------------|
| --- | COLD WATER |
| --- | HOT WATER (110°F) |
| --- | HOT WATER RECIRCULATION (110°F) |
| --- | VENT |
| 1 W | SANITARY WASTE ABOVE FLOOR |
| 1 W | SANITARY WASTE BURIED |
| ST | STORM ABOVE FLOOR (PRIMARY) |
| CD | CONDENSATE DRAIN |
| 90° | ELBOW DOWN |
| 90° | ELBOW UP |
| + | TEE UP |
| - | TEE DOWN |
| ○ | DROP AND RUN |
| + | TEE OFF TOP OF PIPE |
| - | TEE OFF BOTTOM OF PIPE |
| ○ | CONCENTRIC REDUCER |
| ○ | ECCENTRIC REDUCER |
| + | UNION |
| + | FLANGE |
| + | END CAP |
| + | CLEANOUT |
| + | HOSE BIBB |
| + | PIPE GUIDES |
| X | PIPE ANCHORS |

PLUMBING SYMBOL LEGEND

| SYMBOL | DESCRIPTION |
|--------|--|
| + | OS&Y GATE VALVE |
| + | GATE VALVE |
| + | CHECK VALVE |
| + | BALL VALVE |
| + | BALANCING VALVE |
| + | THERMOSTATIC MIXING VALVE |
| + | GLOBE VALVE |
| + | BUTTERFLY VALVE |
| + | FLOOR DRAIN/FLOOR SINK/AREA DRAIN WITH PIPE TRAP |
| TP | TRAP PRIMER |
| L-1 | FIXTURE TYPE |
| + | CONNECT NEW TO EXISTING |
| + | GATE VALVE ON RISE |
| ○ | PIPE TRAP |
| + | ADA ACCESSIBLE FIXTURE |

PLUMBING SPECIALTIES SCHEDULE

| SYMBOL | MANUFACTURER/ MODEL NUMBER | DESCRIPTION | COMPONENTS AND ACCESSORIES | MOUNTING HEIGHT | REMARKS |
|--------|--|--|--|-----------------|---------|
| CO-1 | JR. SMITH MODEL # 4532S-U | CLEANOUT: CAST IRON TEE WITH TAPER THREAD-BRONZE PLUG. | VANDAL PROOF SCREWS. | - | # 3, 6 |
| FLD-1 | JR. SMITH MODEL # 2010C-U-P050 | FLOOR DRAIN: CAST IRON BODY, ROUND ADJUSTABLE NICKEL BRONZE STRAINER, FLASHING COLLAR AND TRAP PRIMER CONNECTION AND SEDIMENT BUCKET | VANDAL PROOF GRATE | - | # 3, 5 |
| HB-1 | WOODFORD MODEL # B22 | HOSE BIBB: BACKFLOW PROTECTED BRONZE BODY | 3/4" THREADED HOSE CONNECTION | 18" ABOVE FLOOR | - |
| TP-1 | PRECISION PLUMBING "PRIME-RITE" MODEL # PR-500 | TRAP PRIMER: INTERNAL VACUUM BREAKER AND BACKFLOW PREVENTER UNIT. 1/2" INLET AND OUTLET | DISTRIBUTION UNITS MODEL #DU-U AS REQUIRED FOR THE NUMBER OF FLOOR DRAINS SHOWN ON THE DRAWINGS. | - | # 1, 2 |
| WCO-1 | JR. SMITH MODEL # 4402C-U | WALL CLEANOUT: DUCO CAST IRON, SPIGOT FERRULE CAST BRONZE THREADED PLUG, STAINLESS STEEL ROUND COVER AND SCREW. | VANDAL PROOF SCREWS. | - | # 3, 7 |
| WHA-1 | PRECISION PLUMBING MODEL # SC-500 THRU # SC-1500 | WATER HAMMER ARRESTOR: BARREL FABRICATED OF TYPE "K" HARD DRAIN, COPPER, W/ "O" RING SEALS. | BRASS PISTON & THREADED ADAPTER | - | # 4 |

- REMARKS:**
- THE TRAP PRIMER SHALL BE INSTALLED A MINIMUM OF 1 FOOT ABOVE FINISHED FLOOR FOR EVERY 20 FEET OF PRIMER LINE.
 - PROVIDE ISOLATION VALVES AT THE SUPPLY PIPE CONNECTIONS.
 - REFER TO FLOOR PLANS FOR SIZES.
 - INSTALL SIZED PER LOAD (WSFU) RECOMMENDED BY PDI & MANUFACTURER.
 - FURNISH WITH TRAP PRIMER CONNECTION AND TRAP PRIMER TP-1.
 - PROVIDE CLEAN OUT AT ALL HORIZONTAL TURNS GREATER THAN 45 DEGREES FOR ALL STORM & SANITARY PIPING.
 - PROVIDE WCO AT BASE OF ALL SANITARY & STORM STACKS. FURNISH WITH ACCESS DOOR OR COVER.
 - MANUFACTURERS LISTED ARE THE BASIS OF DESIGN. SEE SPECIFICATIONS FOR OTHER ACCEPTABLE MANUFACTURERS.

PLUMBING FIXTURE SCHEDULE

| SYMBOL | MANUFACTURER/ MODEL NUMBER | DESCRIPTION OF FIXTURE | TRIM AND ACCESSORIES | REMARKS |
|------------|------------------------------------|---|--|--------------|
| L-1 | KOHLER "PINOIR" MODEL # K-2035-4-0 | LAVATORY: ACCESSIBLE, WALL MOUNTED, 4" SPACED FAUCET HOLES, VITREOUS CHINA, FRONT OVERFLOW (COLOR SELECTION BY ARCHITECT) | T&S MODEL # B-0892-VF05 FAUCET, CHROME PLATED GRID STRAINER, INCLUDED W/LAVATORY K-2037 SHROUD | #1,2,3,4 |
| U-1 U-2 | KOHLER MODEL # K-4918 | URINAL: ACCESSIBLE, WALL HUNG, VITREOUS CHINA | 2" OUTLET SPUD, HANGERS (2 REQUIRED), UNIVERSAL MOUNTING BRACKET, REMOVABLE STRAINER, SEALING LIQUID | #1,3,7 |
| WC-1 | KOHLER MODEL # K-4386 | WATER CLOSET: ACCESSIBLE, FLOOR MOUNTED, ELONGATED BOWL, VITREOUS CHINA, 1/2" TOP SPUD, 1.6 MAX GPF. | SLOAN MODEL# 111-1.28-ES-S-TWO CONCEALED, SENSOR FLUSH VALVE WITH INTEGRAL STOP MECHANICAL OVERRIDE AND VACUUM BREAKER, BEMIS #1955CT OPEN FRONT, COVERLESS, WHITE SEAT. | #1,3,4,5,6,8 |
| WC-2 | KOHLER MODEL # K-4386 | WATER CLOSET: STANDARD FLOOR MOUNTED, ELONGATED BOWL, VITREOUS CHINA, 1/2" TOP SPUD, 1.6 MAX GPF. | SLOAN ROYAL FLUSHMETER MODEL# 111 1.28 SF5M WITH EBV-89-A SIDE MOUNT OPERATOR, VACUUM BREAKER AND BEMIS #1955CT OPEN FRONT, COVERLESS, WHITE SEAT. | #1,3,4,5,6,8 |

REMARKS:


- COLOR SHALL BE WHITE.
- INSTALL TRUEBRO INC. MODEL #102, HANDI LAV-GUARD PROTECTOR ON THE HOT, COLD, AND DRAIN PIPING UNDER FIXTURE.
- FIXTURES AND TRIM AS NOTED SHALL BE "ACCESSIBLE" AND SHALL BE INSTALLED TO ADA / ANSI A117 AND FEDERAL 504 REQUIREMENTS.
- PROVIDE ISOLATION VALVES AT THE PIPE CONNECTIONS.
- PROVIDE WATER HAMMER ARRESTORS AT THE PIPE CONNECTIONS.
- SENSOR SHALL BE ADJUSTABLE. PROVIDE WITH SOLENOID VALVE, CHROME PLATED WALL PLATE AND MODEL EL-154 TRANSFORMER (120VAC/24VAC) SENSOR SHALL BE ADJUSTABLE. PROVIDE WITH FILTERED SOLENOID VALVE, CONTROL MODULE AND MODEL EL-208 TRANSFORMER (120 VAC/ 24VAC).
- FIXTURE U-1 SHALL BE ACCESSIBLE. U-2 SHALL BE MOUNTED AT A STANDARD HEIGHT. REFER TO ARCHITECTURAL DRAWINGS FOR MOUNTING HEIGHTS.
- CONTRACTOR SHALL ADJUST FLUSH VALVE HEIGHT AS REQUIRED FOR ADA COMPLIANT INSTALLATION OF GRAB BARS. REFER TO ARCHITECTURAL DRAWINGS FOR MOUNTING HEIGHTS OF GRAB BARS.

PLUMBING FIXTURE CONNECTION SCHEDULE

| FIXTURE TYPE | WASTE CONNECTION | VENT CONNECTION | COLD WATER CONNECTION | HOT WATER CONNECTION |
|----------------------------|------------------|-----------------|-----------------------|----------------------|
| ELECTRIC WATER COOLER | 1 1/2" | 1 1/2" | 1/2" | - |
| JANITORS MOP BASIN | 3" | 1 1/2" | 1/2" | 1/2" |
| LAVATORY | 1 1/2" | 1 1/2" | 1/2" | 1/2" |
| SHOWER | 3" | 1 1/2" | 1/2" | 1/2" |
| SINK | 1 1/2" | 1 1/2" | 1/2" | 1/2" |
| URINAL | 2" | 1 1/2" | 3/4" | - |
| WATER CLOSET (FLUSH VALVE) | 4" | 2" | 1" | - |


NOTES:

- REFER TO ARCHITECTURAL DRAWINGS FOR ALL PLUMBING FIXTURE MOUNTING HEIGHTS.

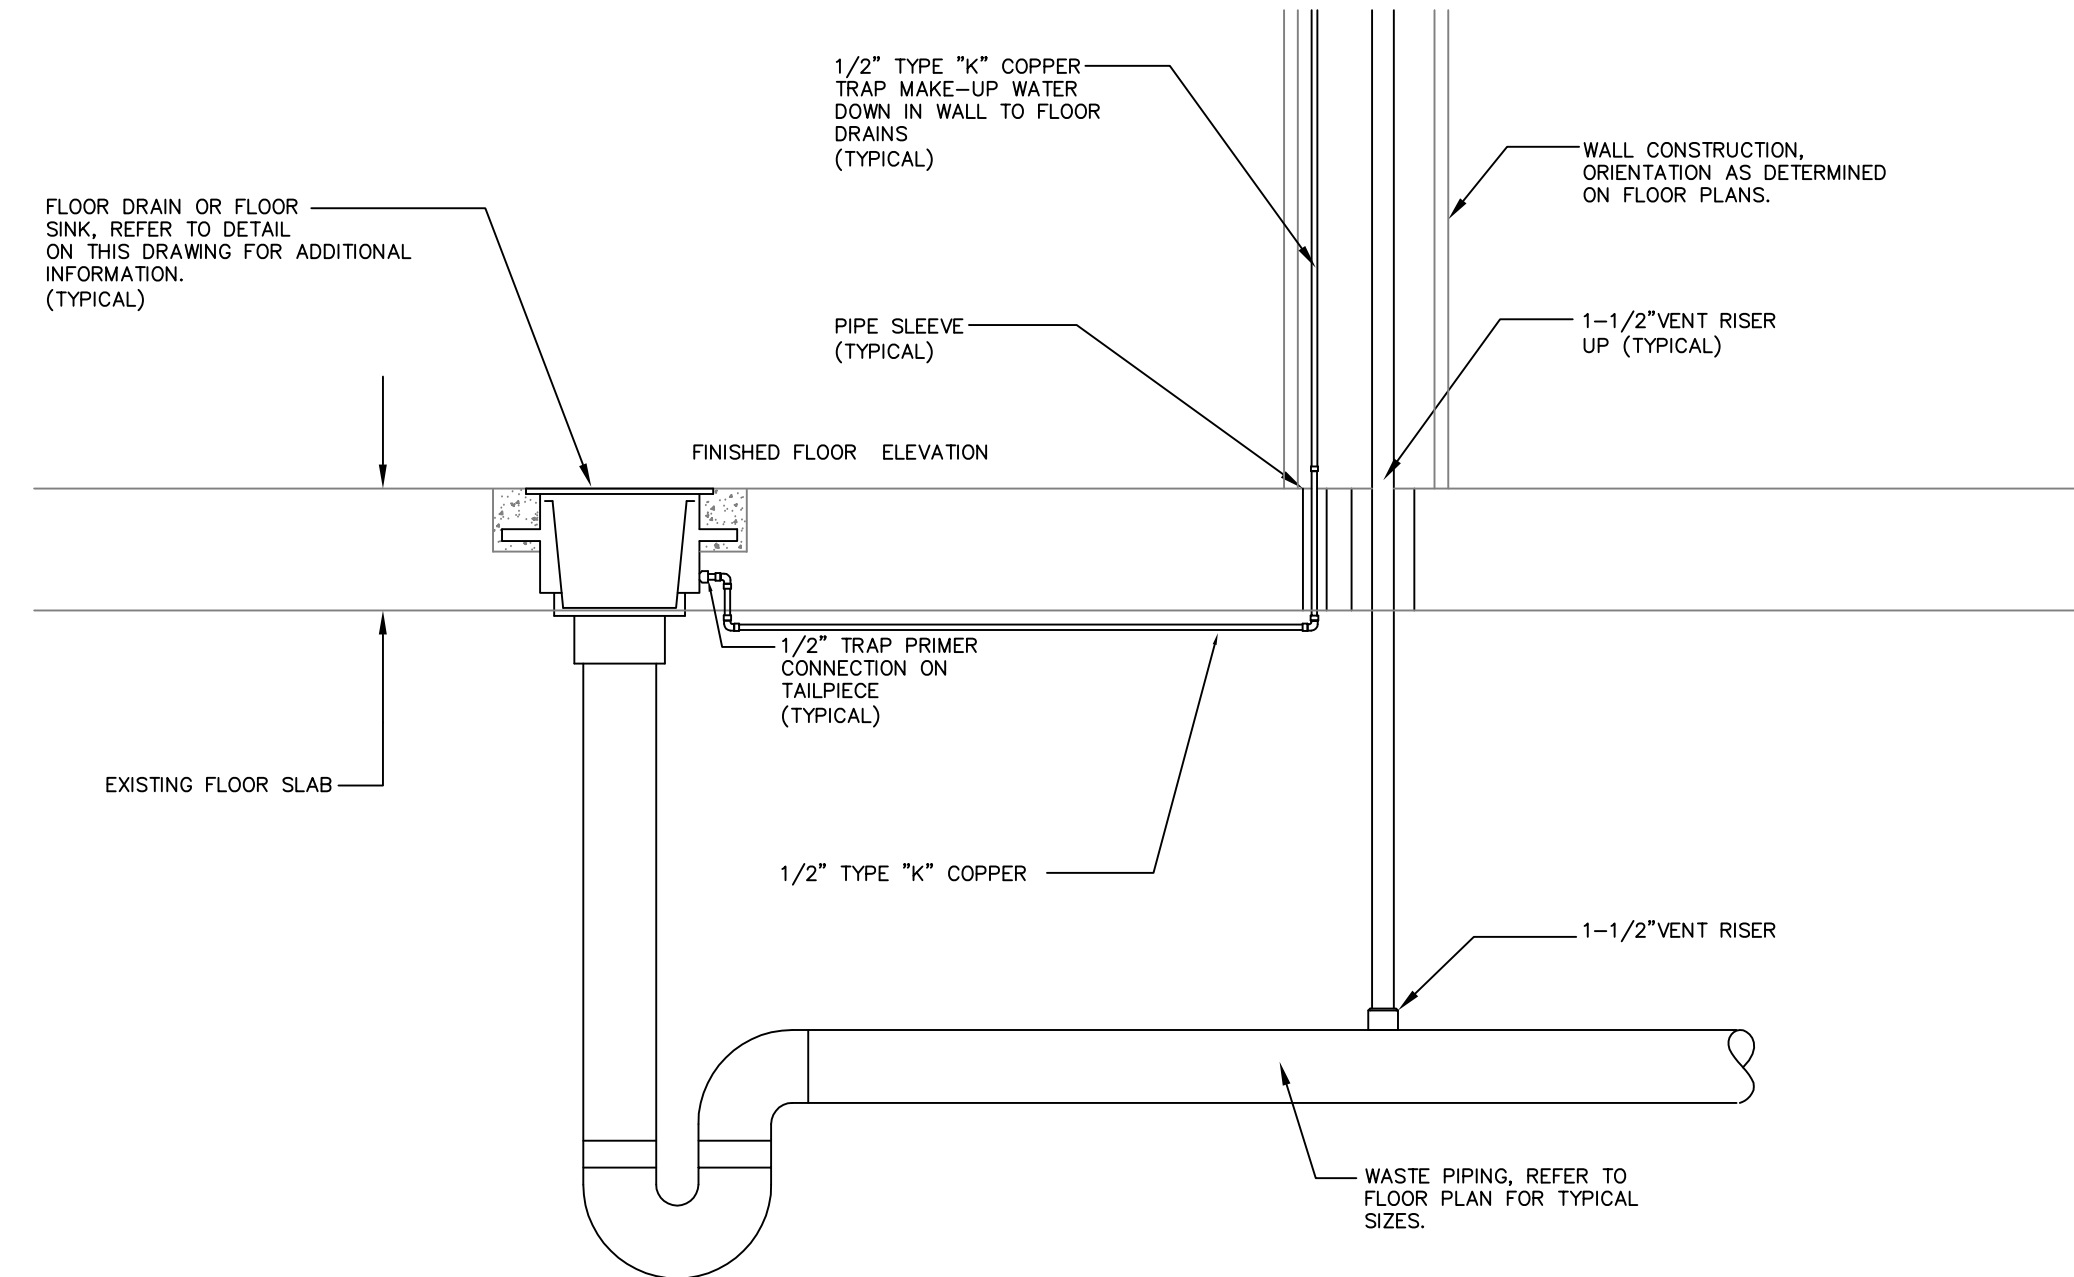

1 FLOOR DRAIN PIPING INSTALLATION DETAIL


SCALE: NTS

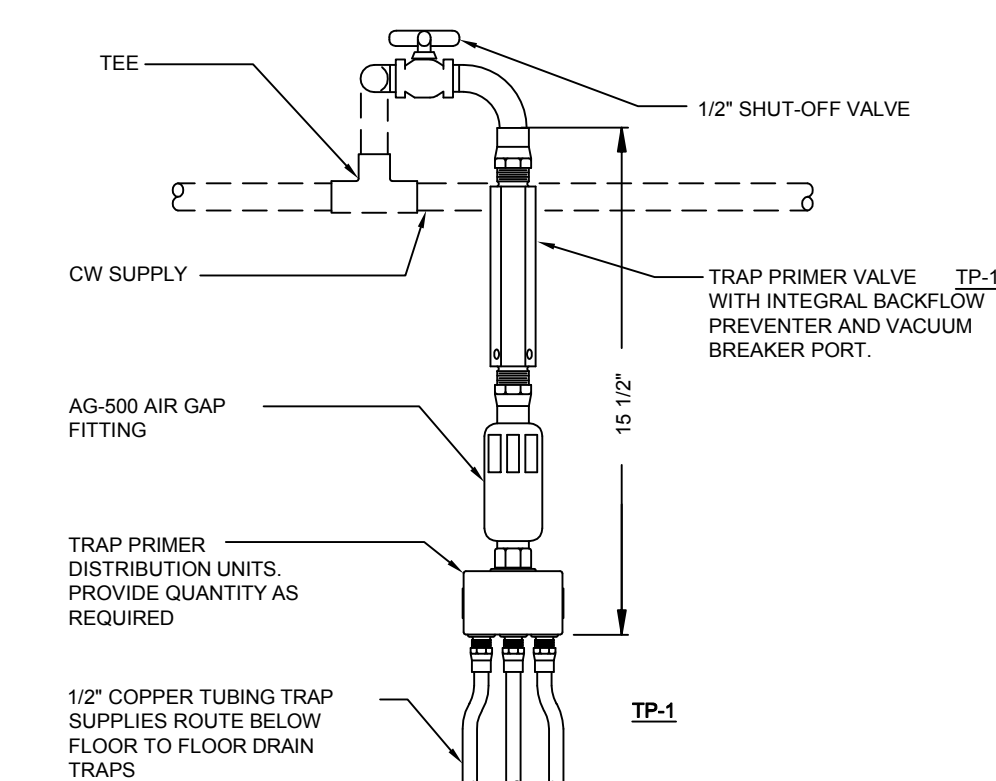

- NOTES:**
- TRAP PRIMER SHALL BE LOCATED ABOVE AN ACCESSIBLE CEILING OR OTHER ACCESSIBLE LOCATION. PROVIDE ACCESS PANEL WHERE REQUIRED.
 - PROVIDE TRAP PRIMERS AT ALL FLOOR DRAIN LOCATIONS. REFER TO FLOOR PLANS FOR ALL FLOOR DRAINS.
 - CONTRACTOR SHALL BE RESPONSIBLE FOR WATER PIPE ROUTING FROM DISTRIBUTION UNIT TO FLOOR DRAIN.


2 TRAP PRIMER DETAIL - TP-1

SCALE: NTS

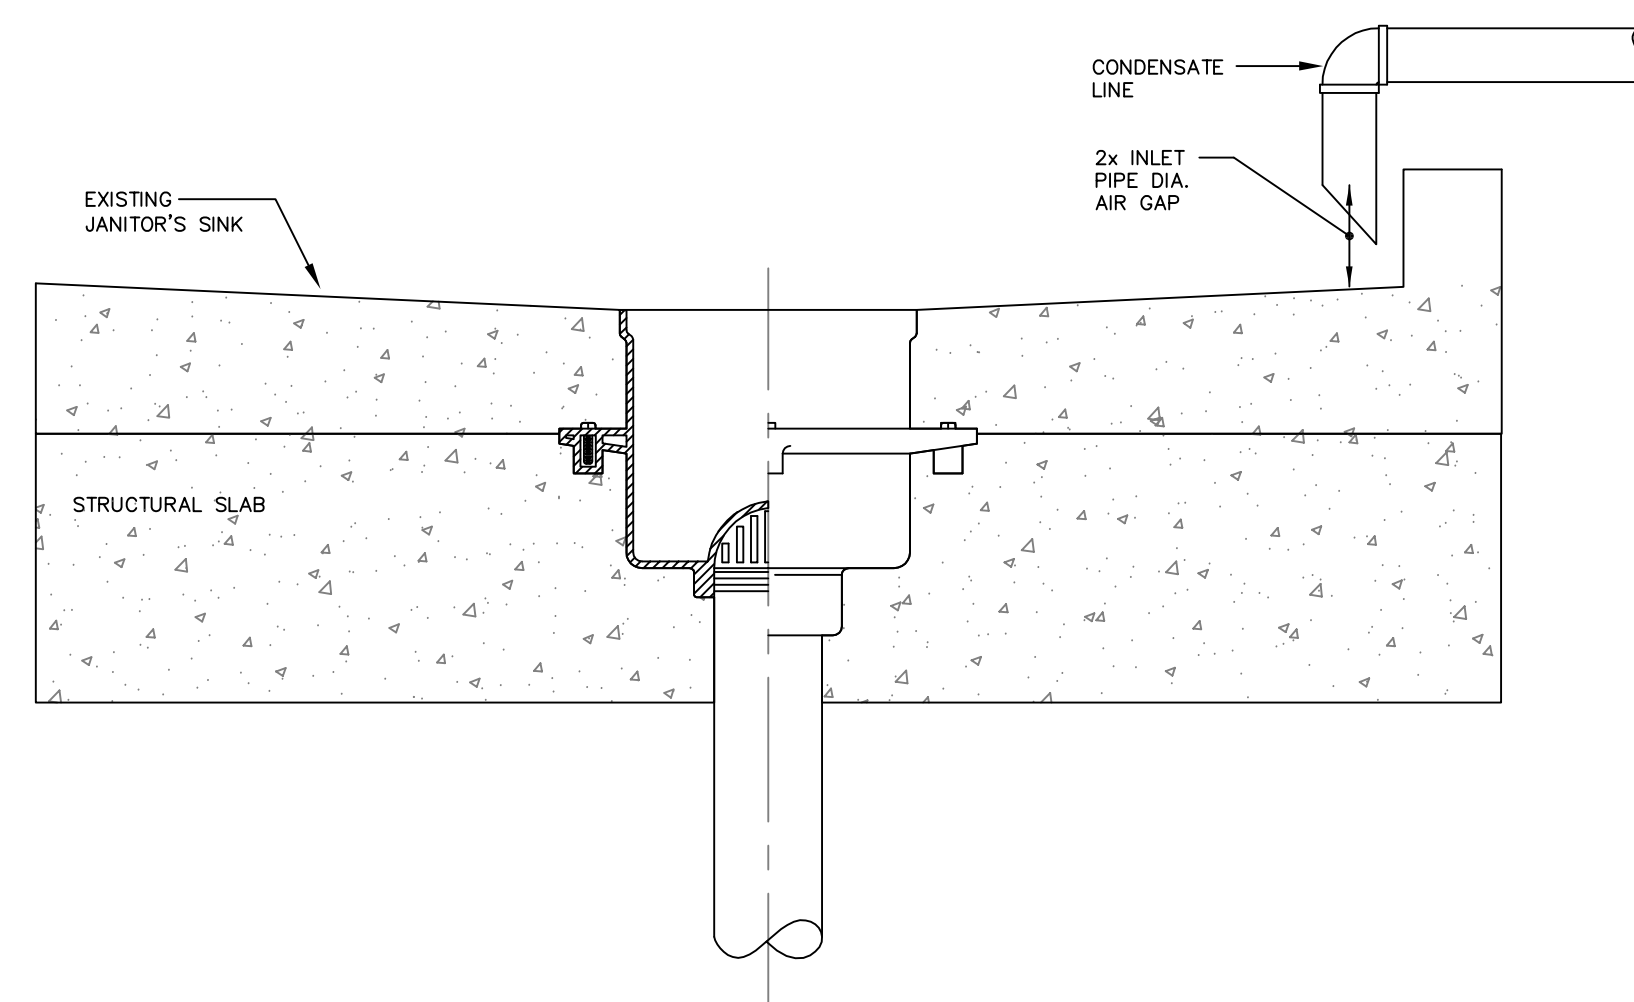

3 CONDENSATE TO EXISTING JANITOR SINK DETAIL


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4 HOSE BIB DETAIL

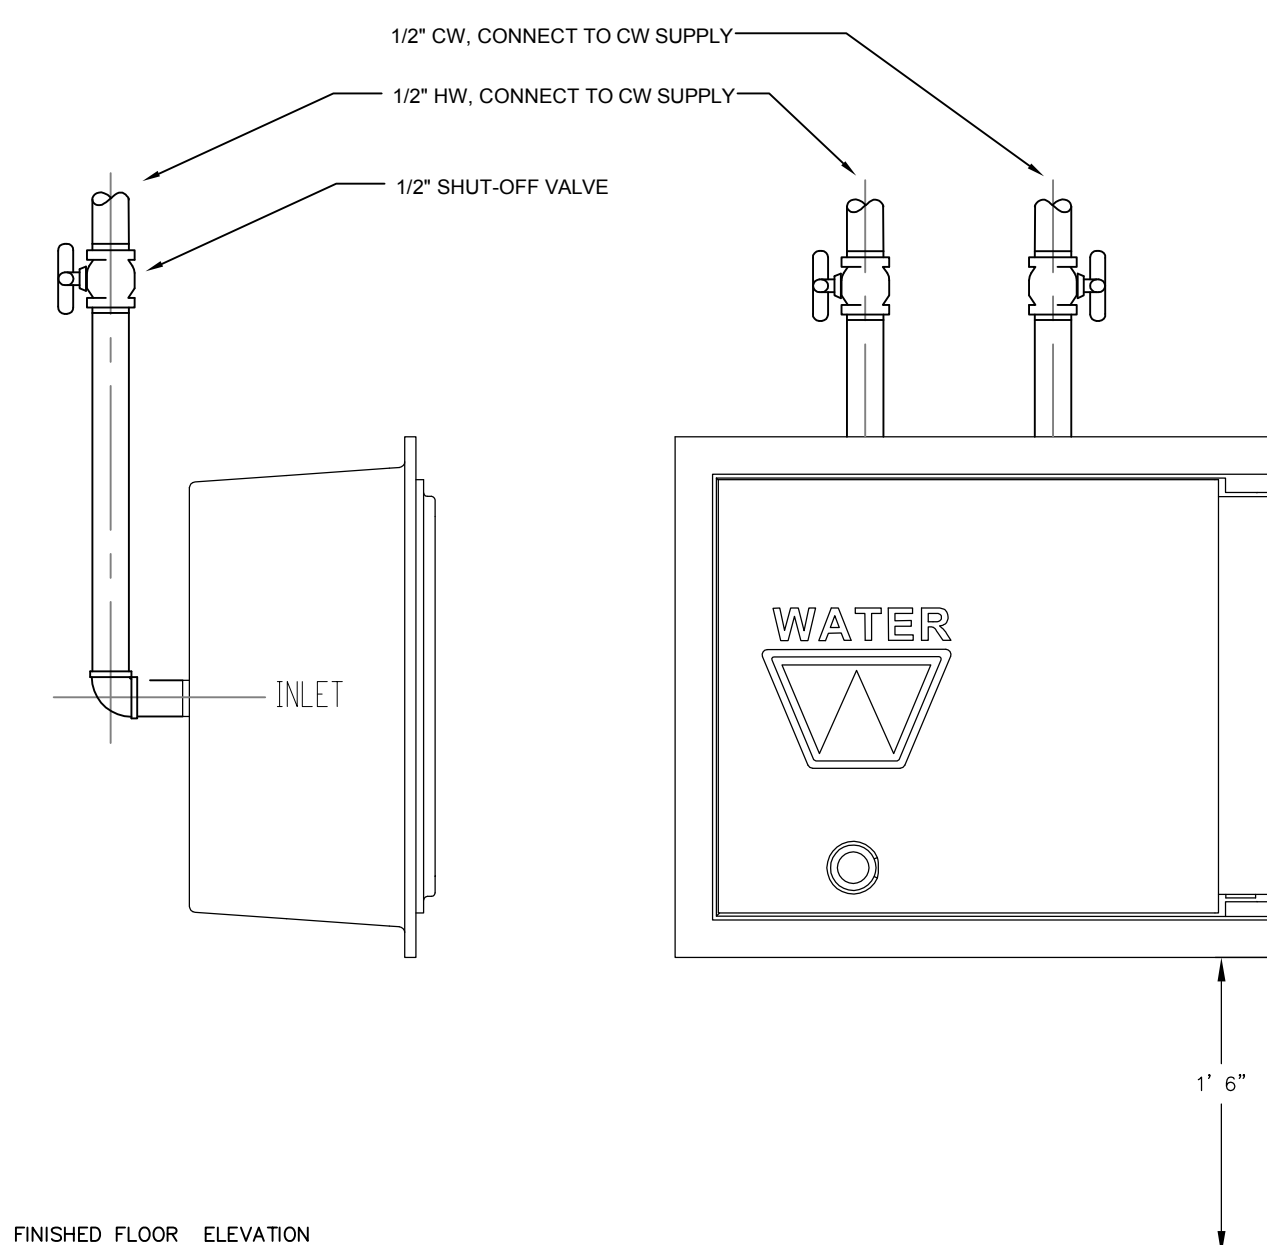SCALE: NTS


| drawing title | | | STATE OF CONNECTICUT DEPARTMENT OF ADMINISTRATIVE SERVICES | | | |
|------------------------------|-------------------------------|-------------------------------|--|--|--------------|--|
| PLUMBING SCHEDULES & LEGENDS | | | REVISIONS | | | |
| mark | date | description | drawing prepared by | date | scale | |
| | 8/4/17 | SCHEMATIC DESIGN SUBMISSION | CONSULTING ENGINEERING SERVICES, INC. 811 MIDDLE STREET MIDDLETOWN, CT | 07/25/18 | AS NOTED | |
| | 1/15/18 | DESIGN DEVELOPMENT SUBMISSION | | | | |
| | 4/16/18 | CONSTRUCTION DOCUMENTS | | | | |
| | 5/23/18 7/25/18 1/21/19 | | | | | |
| project | | | WESTERN CT STATE UNIVERSITY WHITE HALL 2ND AND 3RD FLOOR RENOVATIONS DANBURY, CONNECTICUT | drawn by JVC approved by PMA drawing no. | | |
| CAD no. | | | project no. BI-RD-299 | | P3.00 | |



DEMO MECHANICAL KEY NOTES

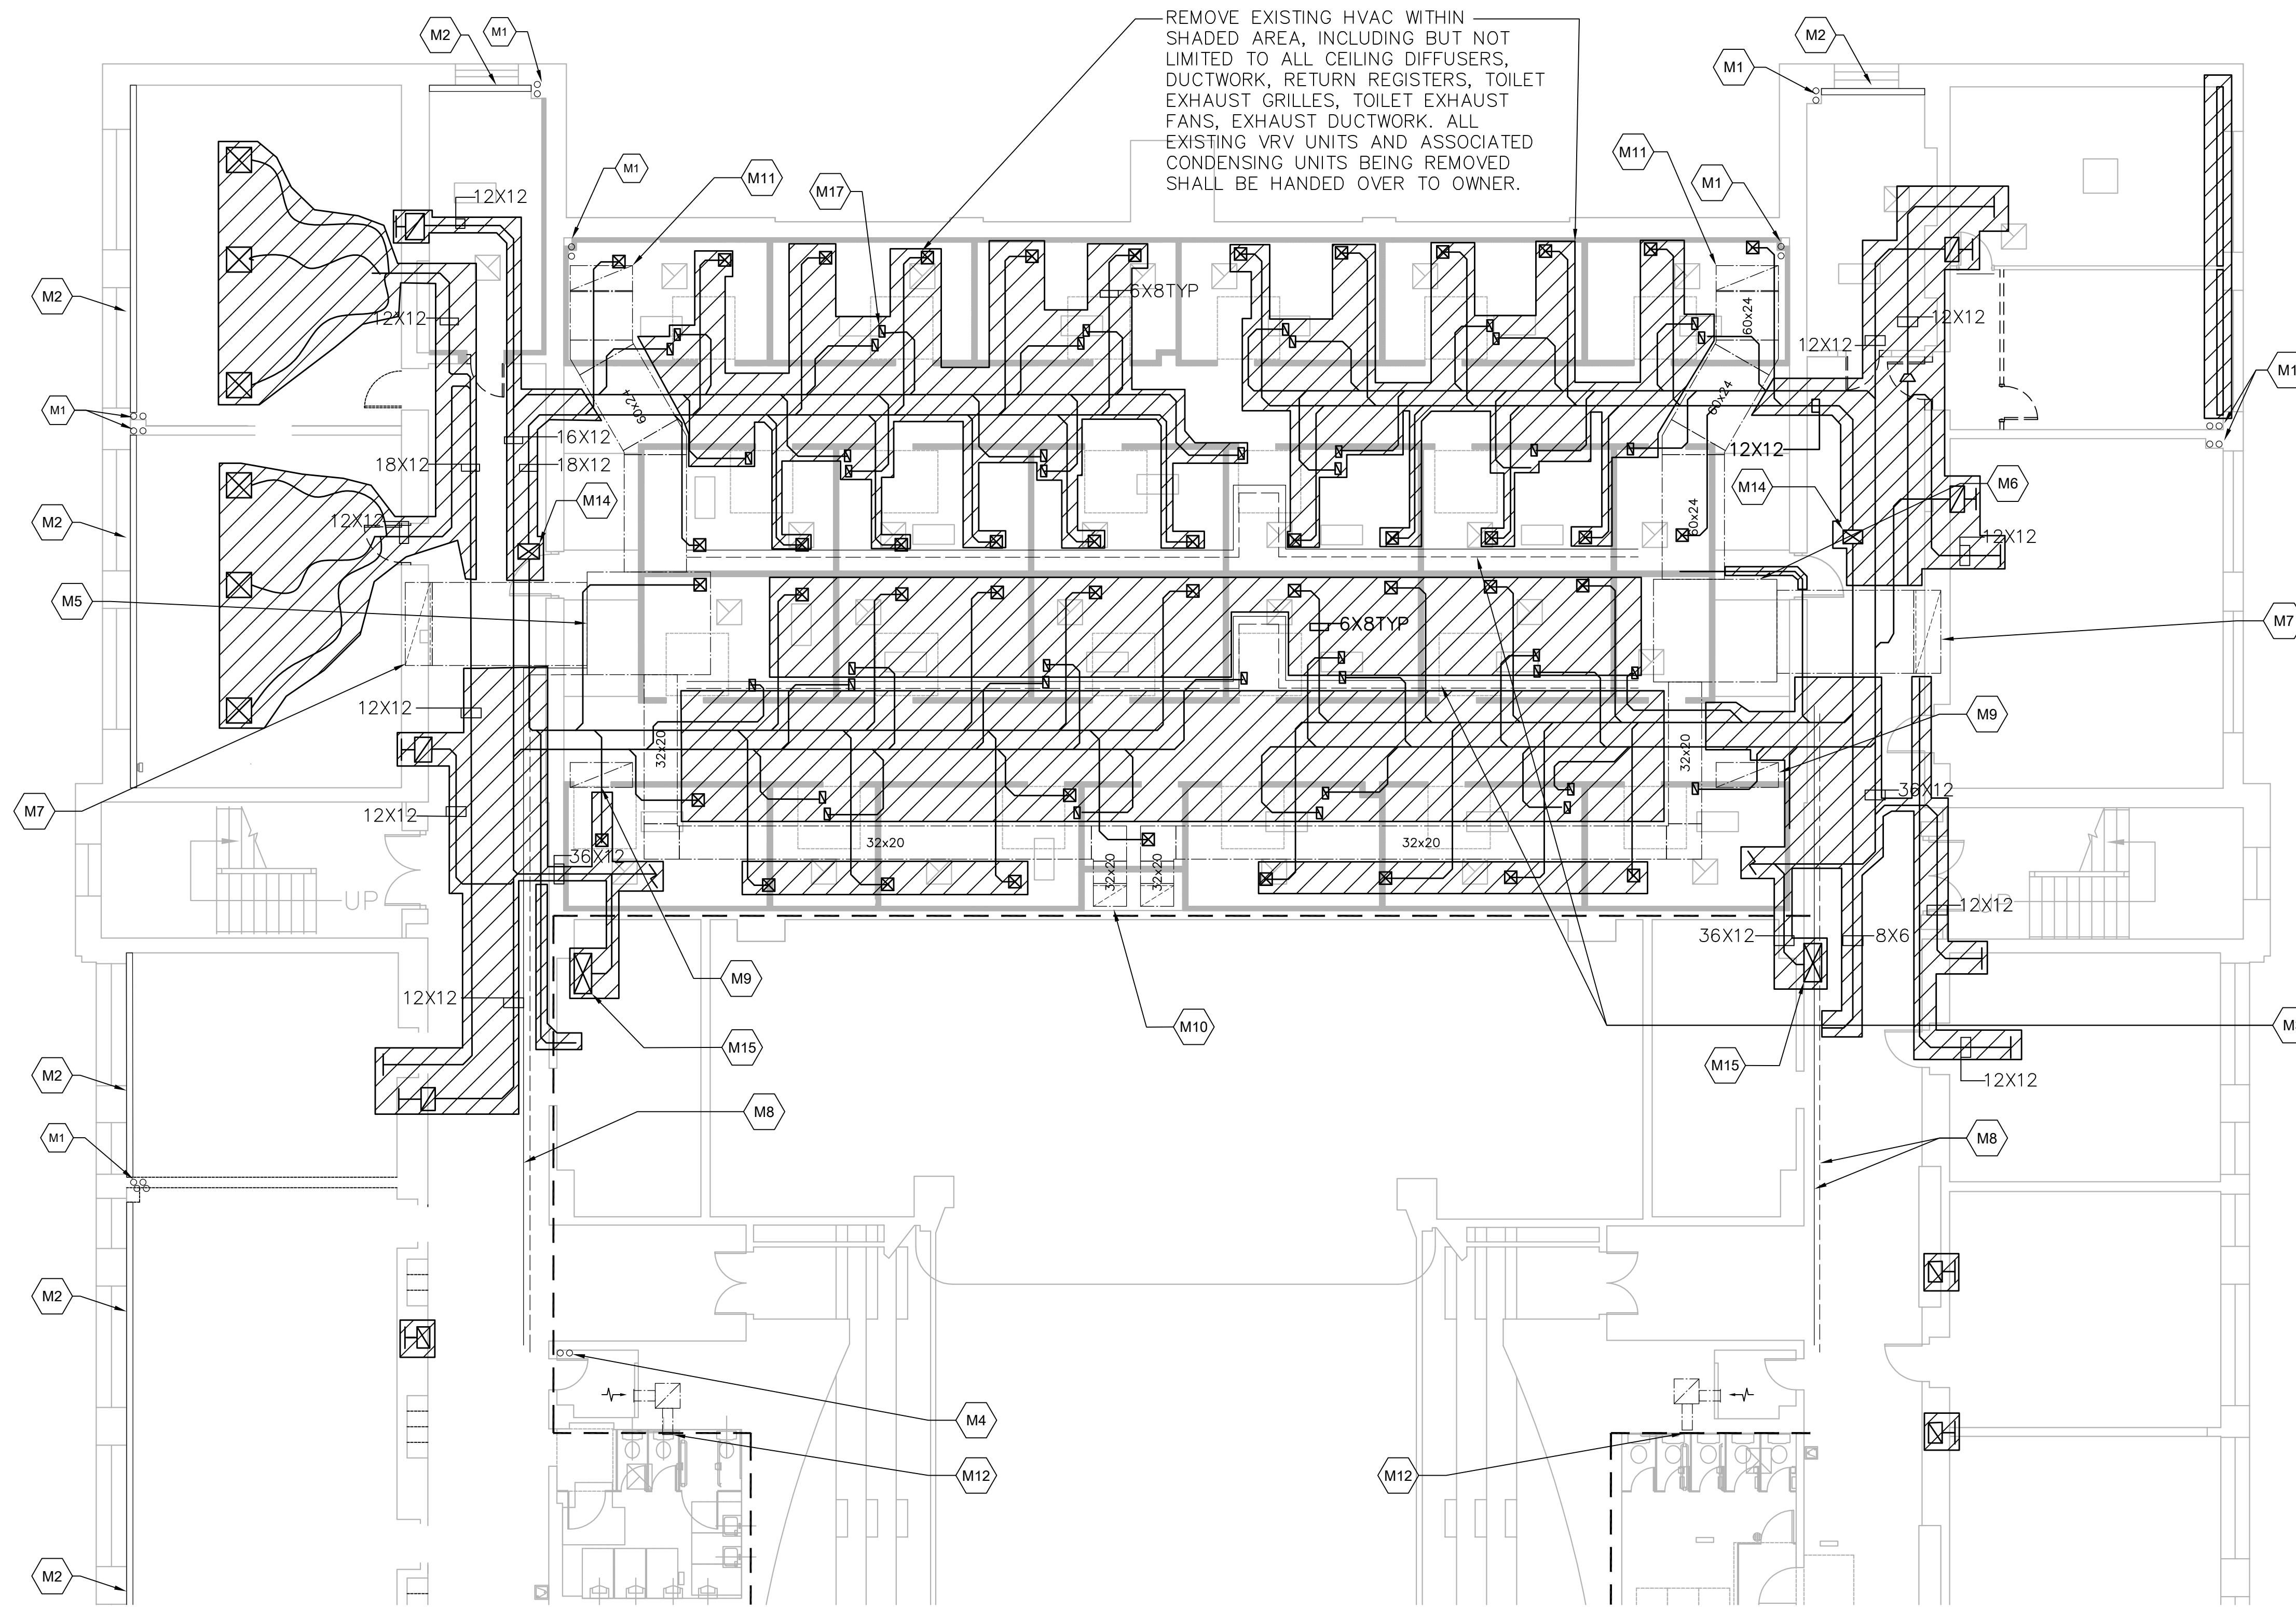- M1 EXISTING HWS&R RISER TO REMAIN
- M2 EXISTING FIN TUBE ELEMENT TO REMAIN, REMOVE EXISTING ENCLOSURE, VALVES (ISOLATION AND CONTROL) AND HYDRONIC SPECIALTIES (STRAINER).
- M3 EXISTING CHILLED WATER SUPPLY AND RETURN, EXISTING HOT WATER SUPPLY AND RETURN REMAIN
- M4 EXISTING 3" HWS&R RISER UP & DOWN TO REMAIN
- M5 FCU NO. 1 AND ASSOCIATED PIPING TO REMAIN. EXISTING SUPPLY, RETURN AND OUTDOOR AIR DUCTS TO REMAIN UNLESS OTHERWISE NOTED
- M6 FCU NO. 2 AND ASSOCIATED PIPING TO REMAIN. EXISTING SUPPLY, RETURN AND OUTDOOR AIR DUCTS TO REMAIN UNLESS OTHERWISE NOTED
- M7 EXISTING SUPPLY DN TO REMAIN, CAP EXISTING BRANCH DUCTS BEING REMOVED.
- M8 EXISTING HOT WATER SUPPLY AND RETURN REMAIN
- M9 EXISTING 60X24 UP TO REMAIN
- M10 (2) EXISTING 30X20 RA DN TO REMAIN
- M11 EXISTING 60X24 OA UP TO REMAIN (TYP FOR 2)
- M12 EXISTING TOILET EXHAUST TO BE REMOVE BACK TO RISER, CAP AND SEAL.
- M13 SEE ARCHITECTURAL DRAWINGS FOR SCOPE OF WORK
- M14 14X20 DUCT UP
- M15 36X12 DUCT DN
- M16 EXISTING 10X8 VERTICAL RISER UP AND DN TO REMAIN
- M17 REMOVE EXISTING RETURN DUCT EXTENDING TO FLOOR LEVEL AND ASSOCIATED GRILLE.


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| drawing title MECHANICAL DEMO SECOND FLOOR- NORTH PARTIAL PLAN | | | STATE OF CONNECTICUT DEPARTMENT OF ADMINISTRATIVE SERVICES | |
| REVISIONS | | | drawing prepared by CONSULTING ENGINEERING SERVICES, INC. 811 MIDDLE STREET MIDDLETOWN, CT | |
| mark | date | description | date | scale |
| | 8/4/17 | SCHEMATIC DESIGN SUBMISSION | 07/25/18 | AS NOTED |
| | 1/15/18 | DESIGN DEVELOPMENT SUBMISSION | | |
| | 4/16/18 | CONSTRUCTION DOCUMENTS | | |
| | 5/23/18 | | | |
| | 7/25/18 | | | |
| | 12/1/19 | | | |
| project WESTERN CT STATE UNIVERSITY WHITE HALL 2ND AND 3RD FLOOR RENOVATIONS DANBURY, CONNECTICUT | | | drawn by AJS | approved by PMA |
| drawing no. MD1.01 | | | drawing no. | |
| CAD no. xxxxxxxxx.dwg | | | project no. 61-RD-299 | |

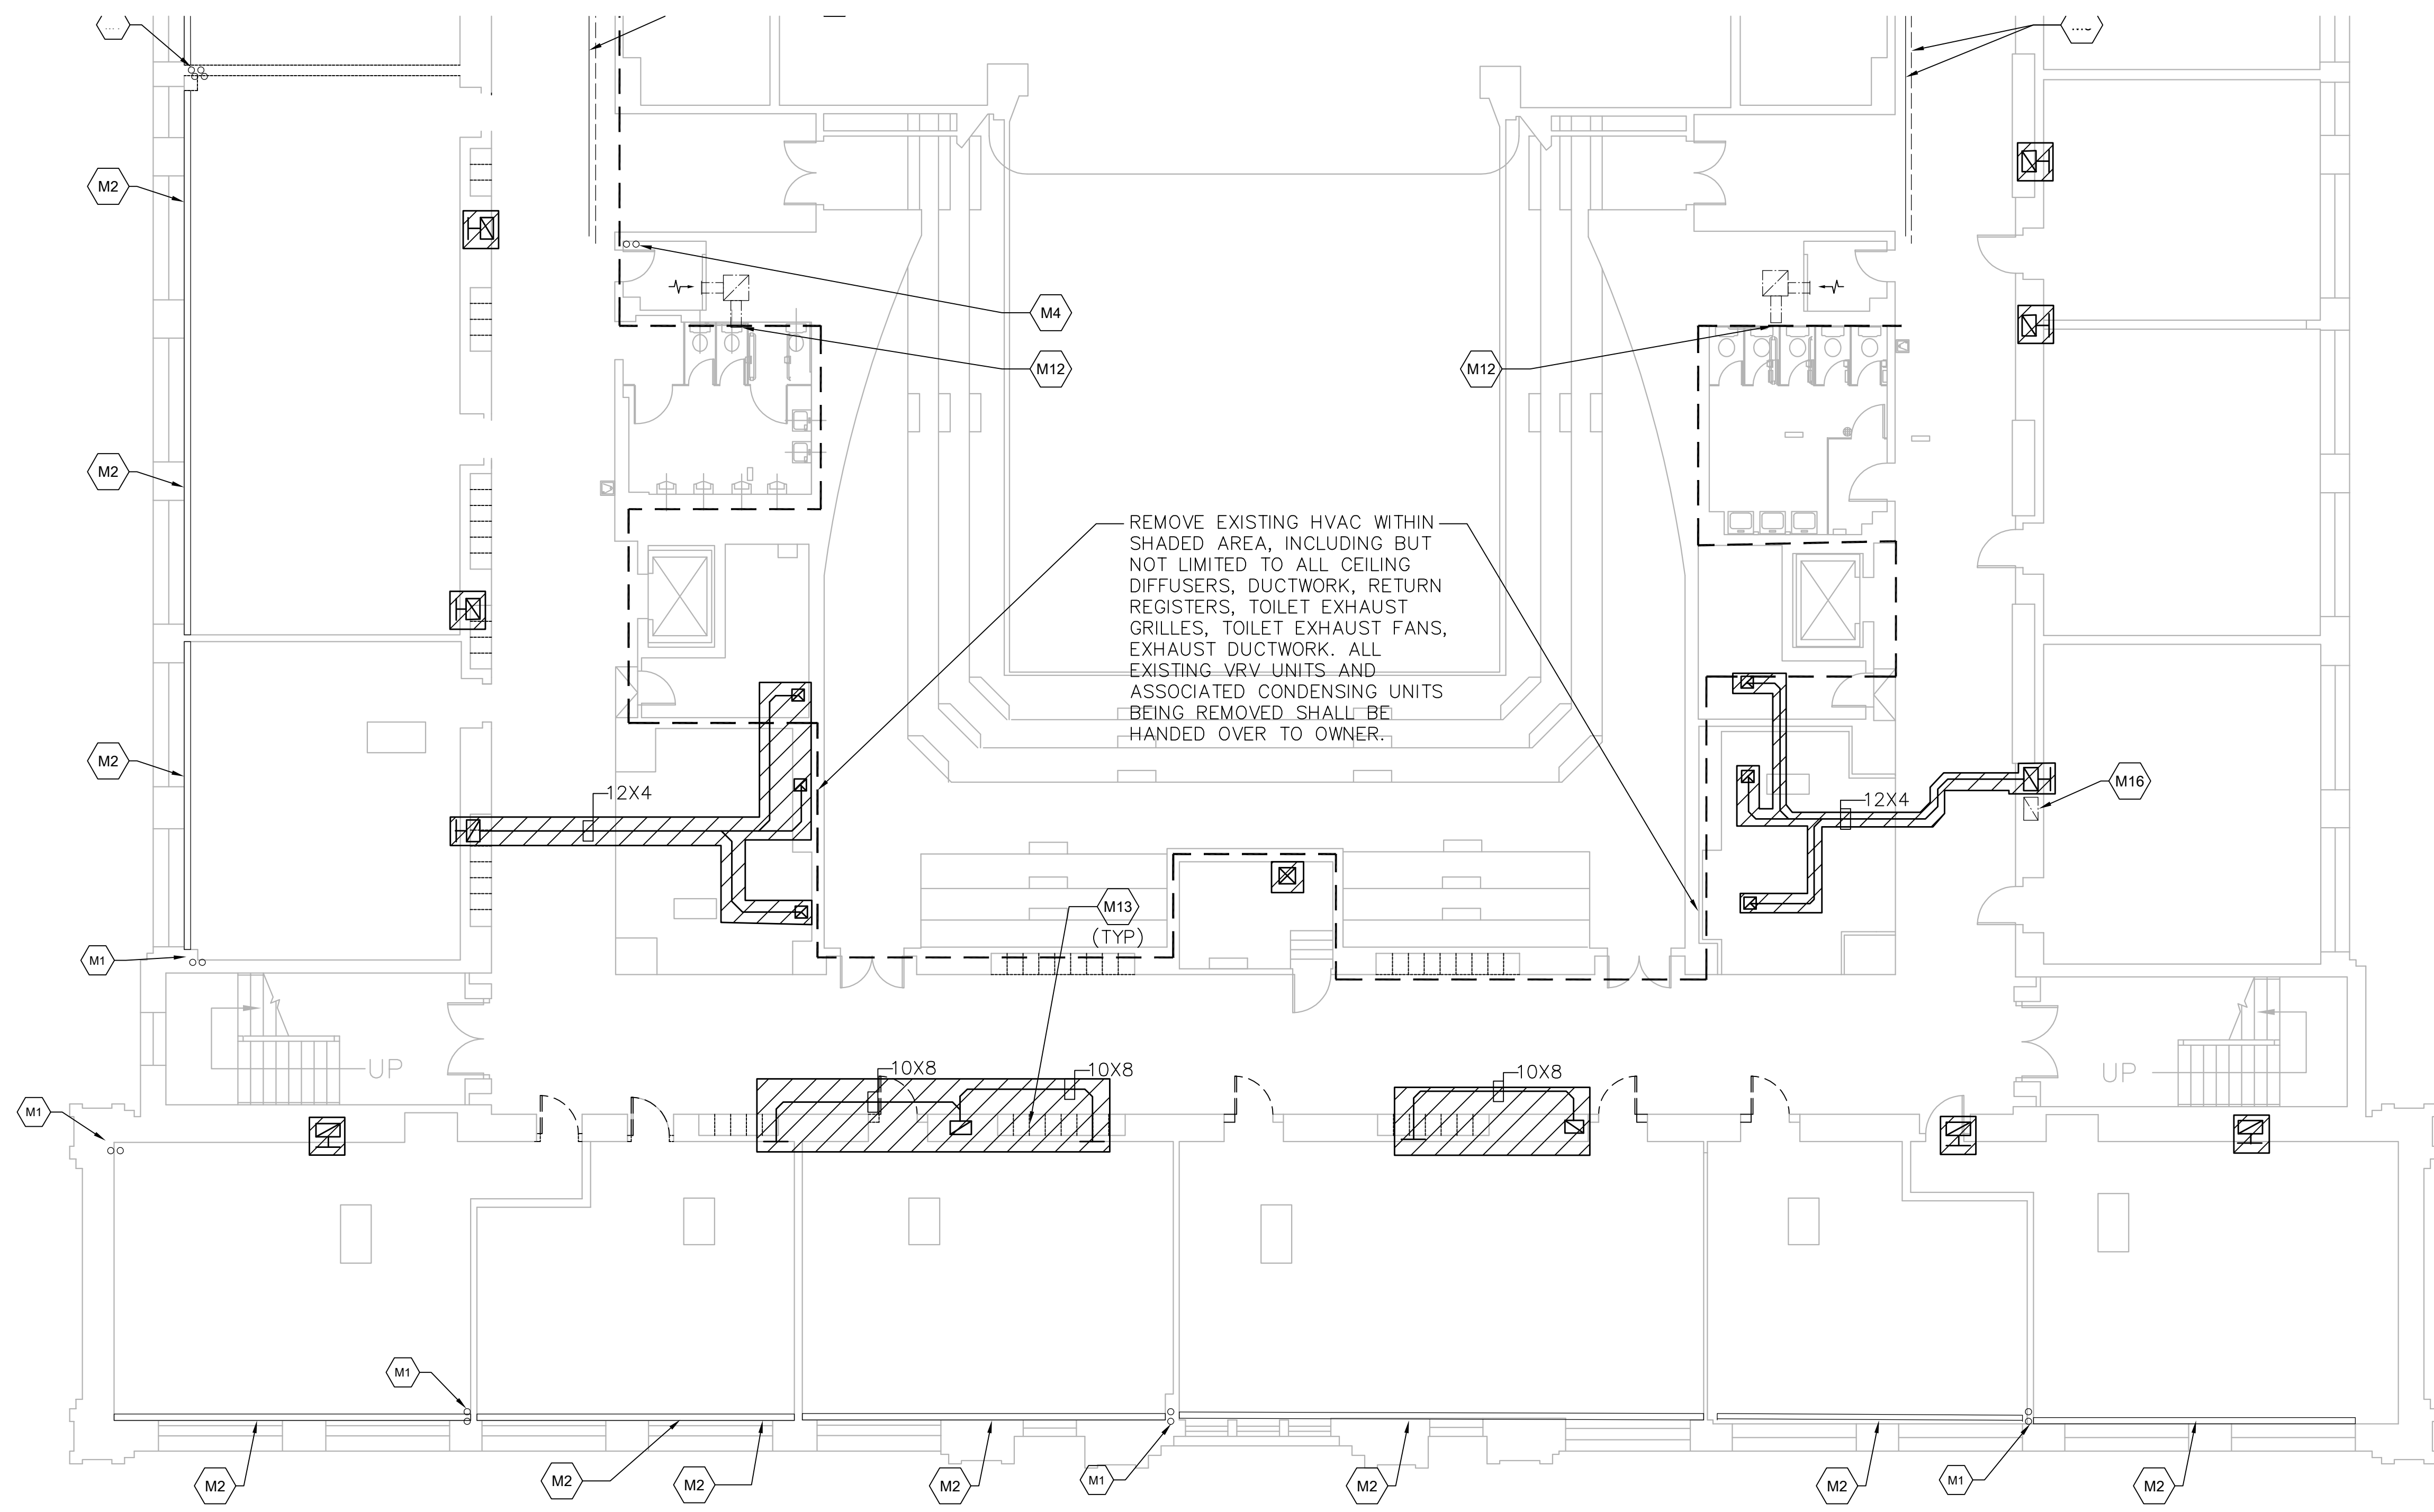

DEMO MECHANICAL KEY NOTES


- M1 EXISTING HWS&R RISER TO REMAIN
- M2 EXISTING FIN TUBE ELEMENT TO REMAIN, REMOVE EXISTING ENCLOSURE, VALVES (ISOLATION AND CONTROL) AND HYDRONIC SPECIALTIES (STRAINER).
- M3 EXISTING CHILLED WATER SUPPLY AND RETURN, EXISTING HOT WATER SUPPLY AND RETURN REMAIN
- M4 EXISTING 3" HWS&R RISER UP & DOWN TO REMAIN
- M5 FCU NO. 1 AND ASSOCIATED PIPING TO REMAIN. EXISTING SUPPLY, RETURN AND OUTDOOR AIR DUCTS TO REMAIN UNLESS OTHER WISE NOTED
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- M7 EXISTING SUPPLY DN TO REMAIN, CAP EXISTING BRANCH DUCTS BEING REMOVED.
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- M14 14X20 DUCT UP
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- M17 REMOVE EXISTING RETURN DUCT EXTENDING TO FLOOR LEVEL AND ASSOCIATED GRILLE.

| | | | | |
|--|-------------|-------------------------------|---|-------------------|
| drawing title | | | STATE OF CONNECTICUT | |
| MECHANICAL DEMO SECOND FLOOR- SOUTH PARTIAL PLAN | | | DEPARTMENT OF ADMINISTRATIVE SERVICES | |
| REVISIONS | | | | |
| mark | date | description | drawing prepared by | date |
| | 8/4/17 | SCHEMATIC DESIGN SUBMISSION | CONSULTING ENGINEERING SERVICES, INC. 811 MIDDLE STREET MIDDLETOWN, CT | 07/25/18 |
| | 1/15/18 | DESIGN DEVELOPMENT SUBMISSION | | scale AS NOTED |
| | 4/16/18 | CONSTRUCTION DOCUMENTS | project | drawn by |
| | 5/23/18 | DOCUMENTS | WESTERN CT STATE UNIVERSITY WHITE HALL 2ND AND 3RD FLOOR RENOVATIONS DANBURY, CONNECTICUT | AJS |
| | 7/25/18 | | | approved by |
| | 1/21/19 | | | PMA |
| | | | drawing no. | MD1.02 |
| CAD no. | project no. | drawing no. | | |
| xxxxxxxx.dwg | BI-RD-299 | | | |

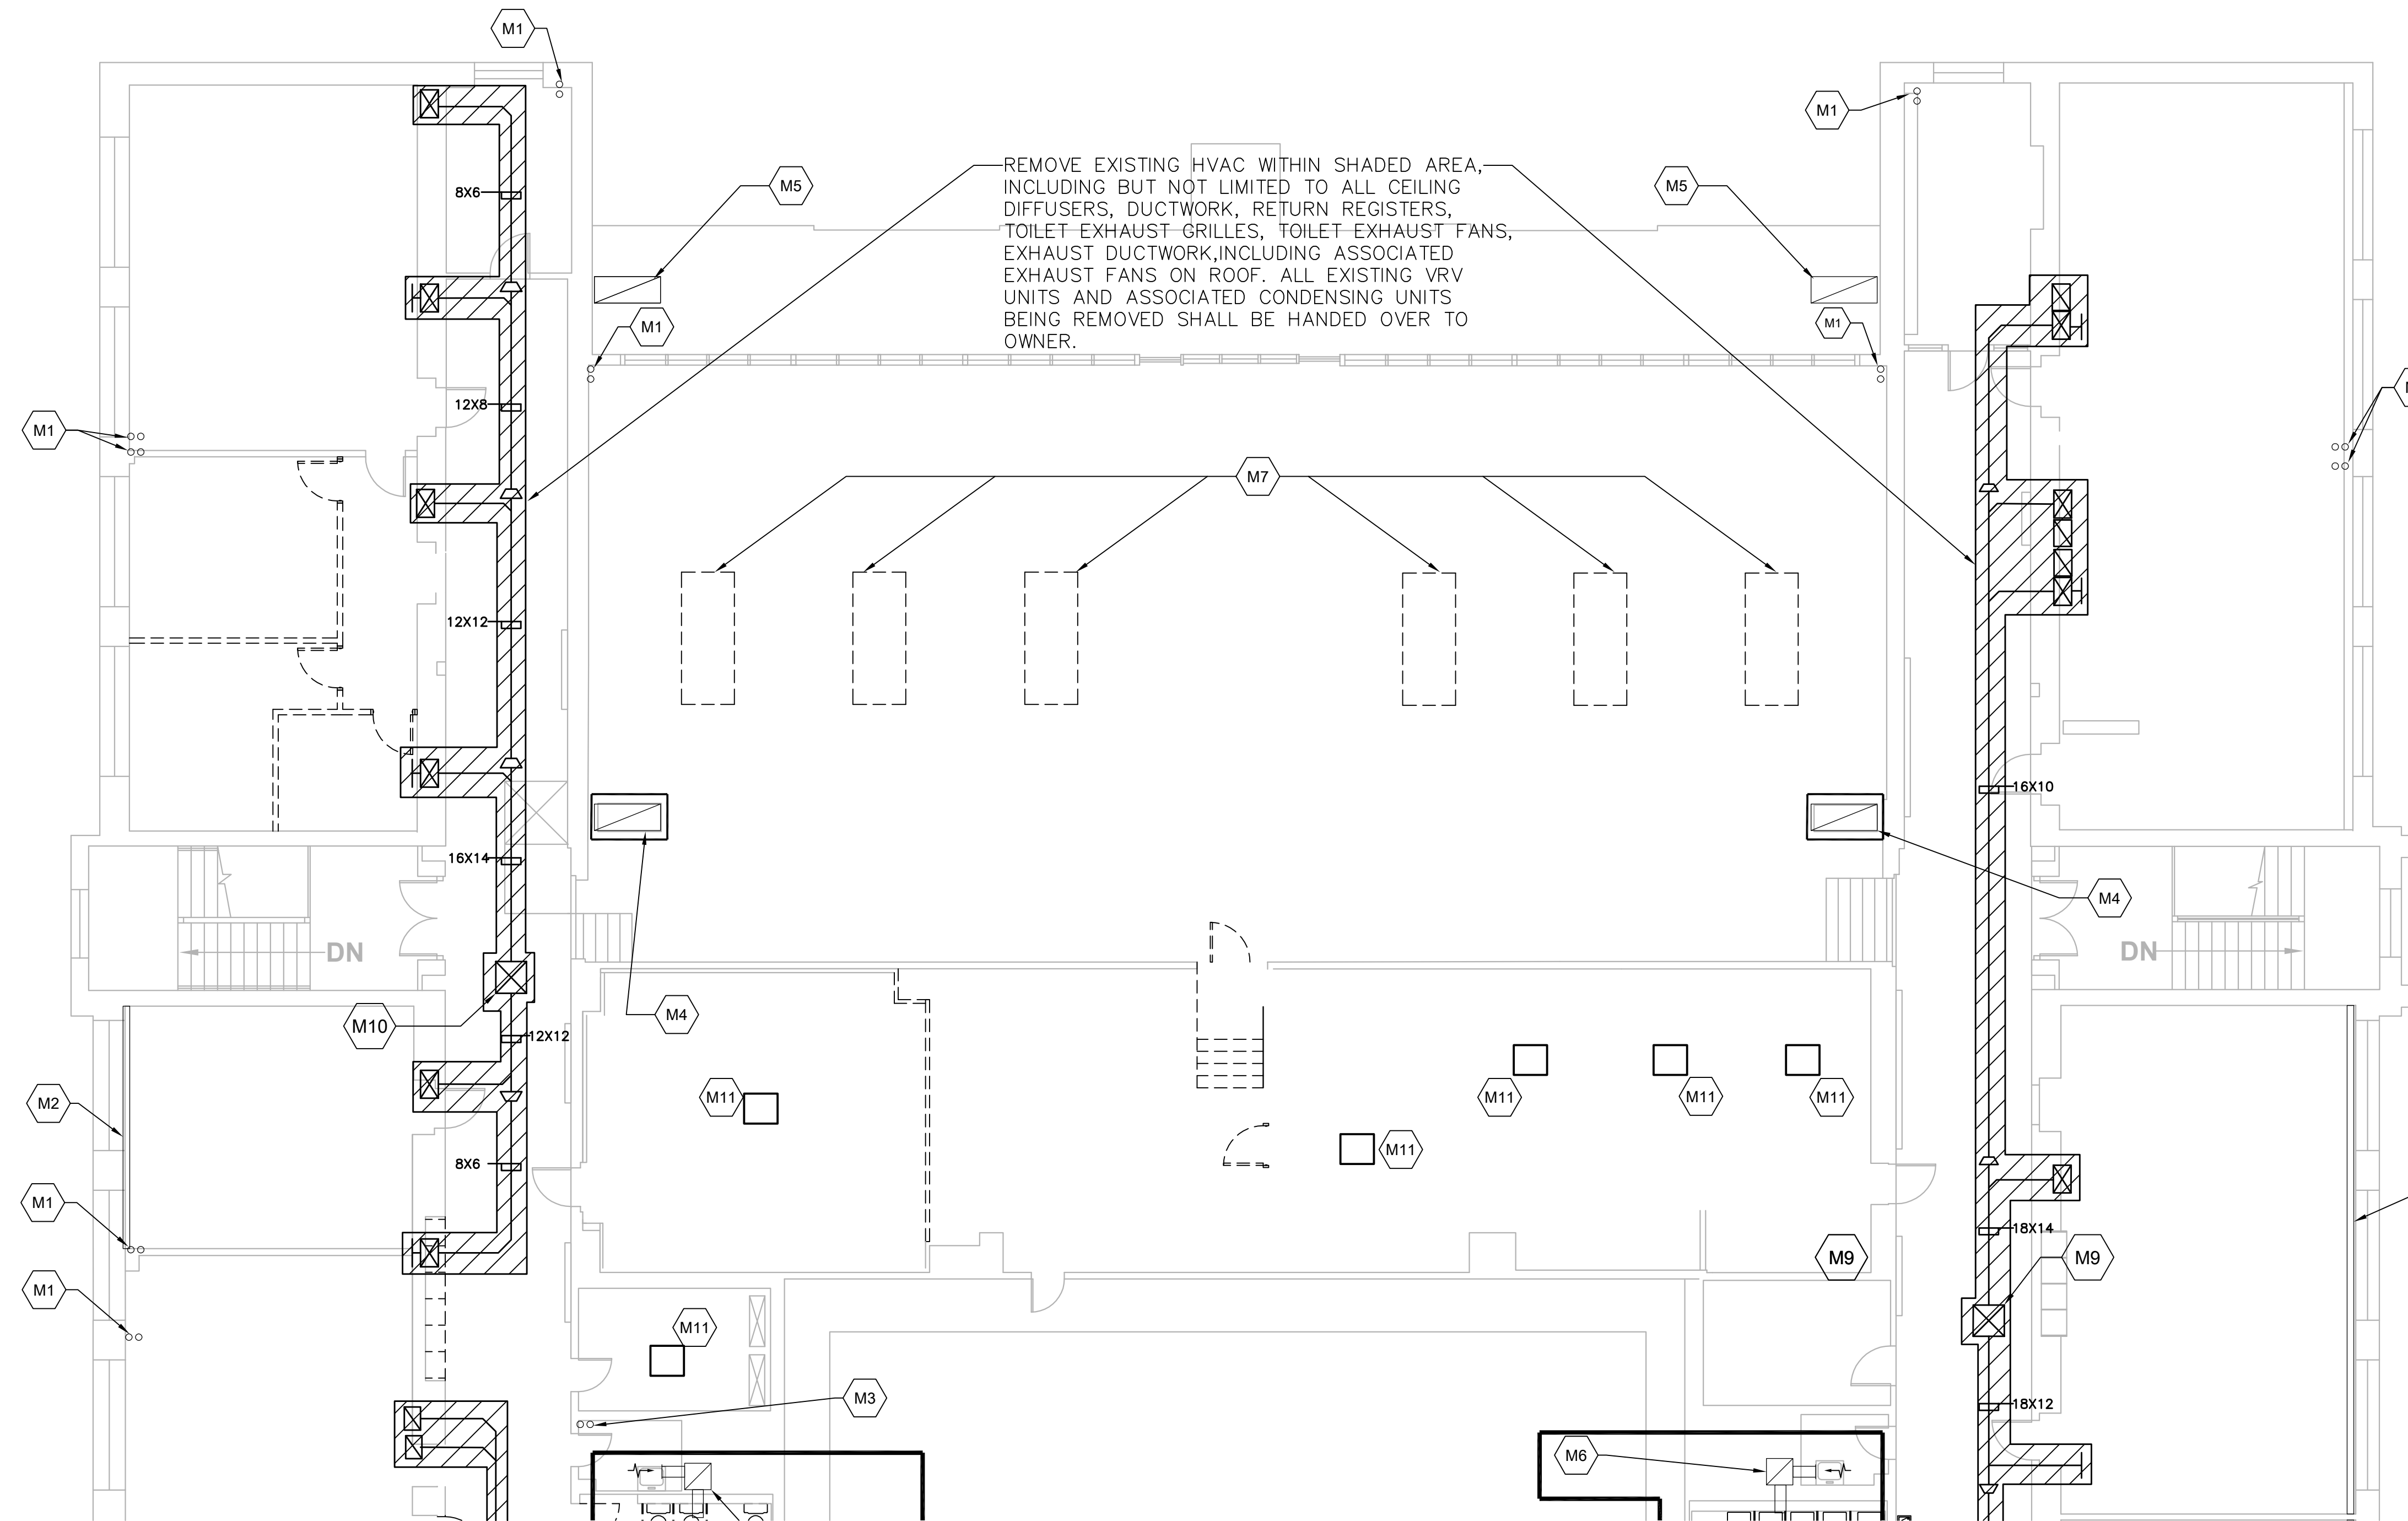

- DEMO MECHANICAL KEY NOTES**
- M1 EXISTING HWS&R RISER TO REMAIN
 - M2 EXISTING FIN TUBE ELEMENT TO REMAIN, REMOVE EXISTING ENCLOSURE, VALVES (ISOLATION AND CONTROL) AND HYDRONIC SPECIALTIES (STRAINER).
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 - M6 EXISTING TOILET EXHAUST RISER TO REMAIN, REMOVE EXISTING DUCT WITH TOILET ROOM BACK TO RISER, CAP AND SEAL.
 - M7 SEE ARCHITECTURAL DRAWINGS FOR SCOPE OF WORK
 - M8 REMOVE EXISTING 42X42 EA UP TO ROOF FAN. REMOVE FAN ON ROOF ABOVE.
 - M9 REMOVE EXISTING 34X34 EA UP TO ROOF FAN. REMOVE FAN ON ROOF ABOVE.
 - M10 REMOVE EXISTING 28X28 EA UP TO ROOF FAN. REMOVE FAN ON ROOF ABOVE.
 - M11 REMOVE EXISTING INDOOR CEILING MOUNTED CASSETTE UNIT & ASSOCIATED OUTDOOR ROOF MOUNTED CONDENSING UNIT; REMOVE ALL REFRIGERANT PIPING; ALL REMOVED EQUIPMENT SHALL BE RETURNED TO OWNER'S REPRESENTATIVE.
 - M12 EXISTING 10x8 EXHAUST DUCT DOWN TO FIRST FLOOR TO REMAIN.

| | | | | | |
|---|--------------------------|-------------------------------|--|--------------------|------------------------------|
| drawing title MECHANICAL DEMO THIRD FLOOR - NORTH PARTIAL PLAN | | | STATE OF CONNECTICUT DEPARTMENT OF ADMINISTRATIVE SERVICES | | |
| REVISIONS | | | drawing prepared by CONSULTING ENGINEERING SERVICES, INC. 811 MIDDLE STREET MIDDLETOWN, CT | | |
| mark | date | description | date | scale | AS NOTED |
| | 8/4/17 | SCHEMATIC DESIGN SUBMISSION | 07/25/18 | | |
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| | 4/16/18 | CONSTRUCTION DOCUMENTS | | | |
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| | 7/25/18 | | | | |
| | 1/21/19 | | | | |
| project WESTERN CT STATE UNIVERSITY WHITE HALL 2ND AND 3RD FLOOR RENOVATIONS DANBURY, CONNECTICUT | | | drawn by AJS | approved by PMA | drawing no. MD1.03 |
| CAD no. xxxxxxxxx.dwg | project no. 61-RD-299 | | | | |

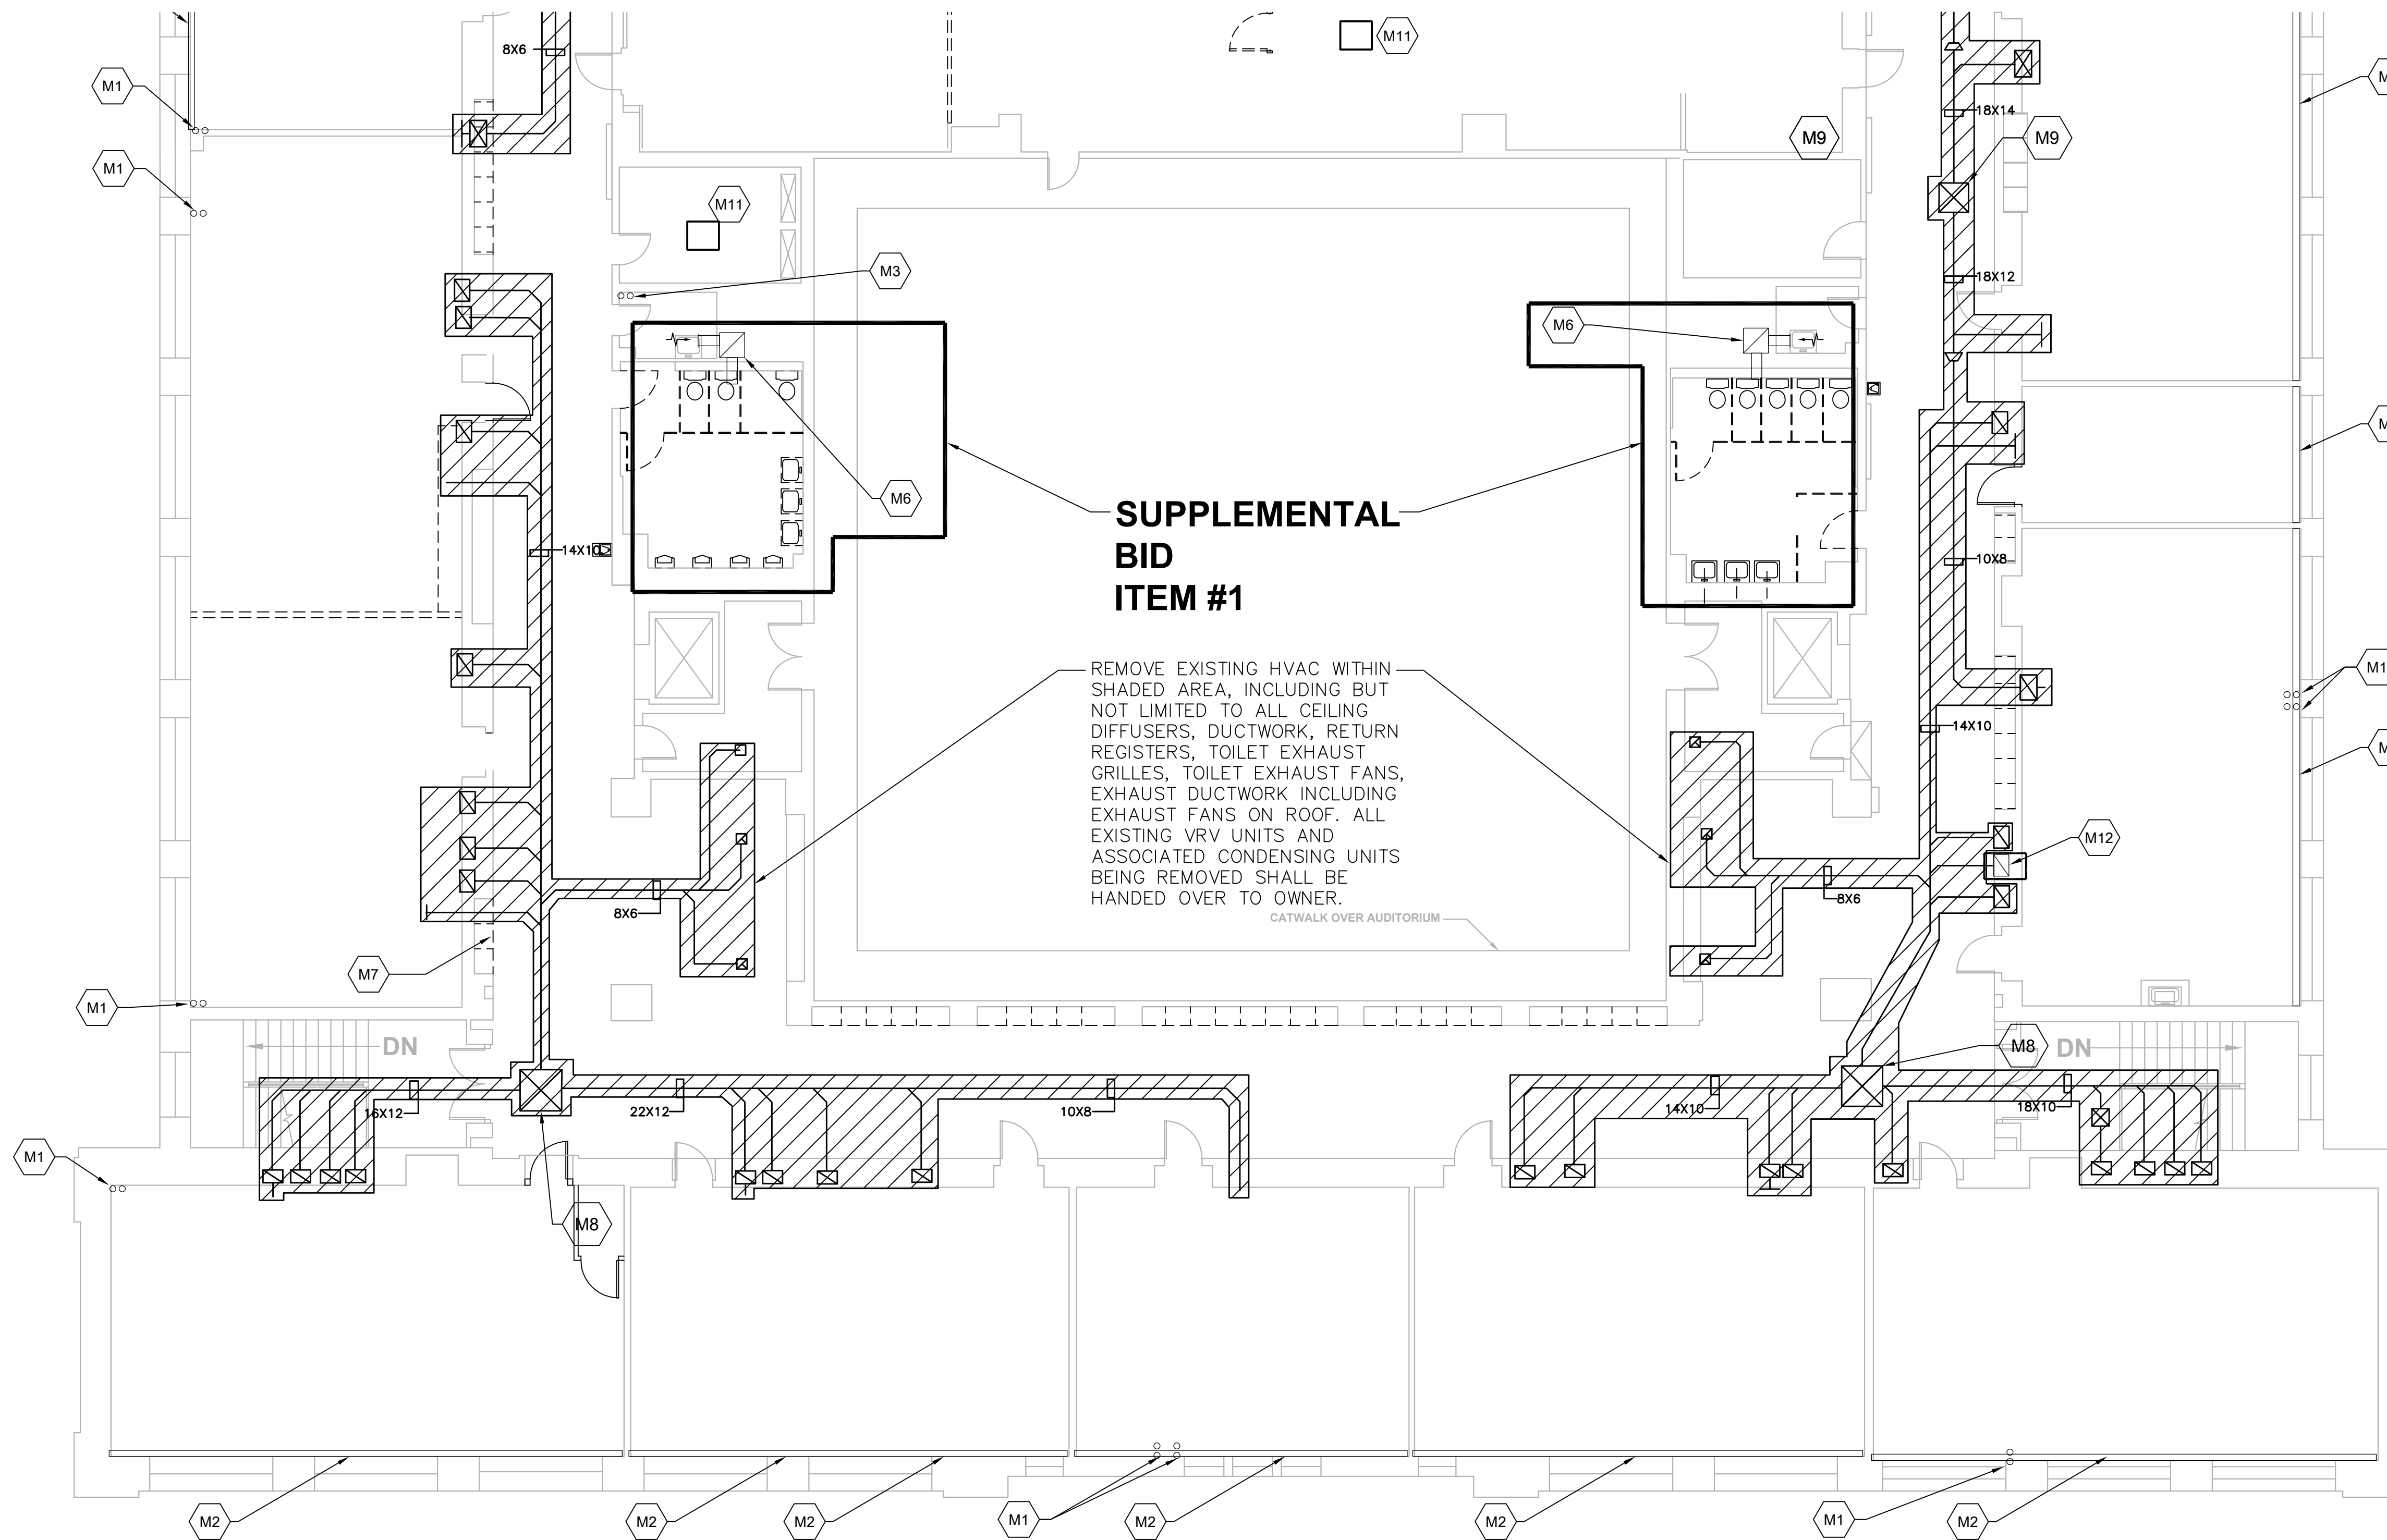

DEMO MECHANICAL KEY NOTES


- M1 EXISTING HWS&R RISER TO REMAIN
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- M11 REMOVE EXISTING INDOOR CEILING MOUNTED CASSETTE UNIT & ASSOCIATED OUTDOOR ROOF MOUNTED CONDENSING UNIT; REMOVE ALL REFRIGERANT PIPING; ALL REMOVED EQUIPMENT SHALL BE RETURNED TO OWNER'S REPRESENTATIVE.
- M12 EXISTING 10x8 EXHAUST DUCT DOWN TO FIRST FLOOR TO REMAIN.

SUPPLEMENTAL BID ITEM #1

REMOVE EXISTING HVAC WITHIN SHADED AREA, INCLUDING BUT NOT LIMITED TO ALL CEILING DIFFUSERS, DUCTWORK, RETURN REGISTERS, TOILET EXHAUST FANS, EXHAUST DUCTWORK INCLUDING EXHAUST FANS ON ROOF. ALL EXISTING VRV UNITS AND ASSOCIATED CONDENSING UNITS BEING REMOVED SHALL BE HANDED OVER TO OWNER.

CATWALK OVER AUDITORIUM

| | | | | | |
|---|--------------------------|-------------------------------|--|--------------------|------------------------------|
| drawing title MECHANICAL DEMO THIRD FLOOR - SOUTH PARTIAL PLAN | | | STATE OF CONNECTICUT DEPARTMENT OF ADMINISTRATIVE SERVICES | | |
| REVISIONS | | | drawing prepared by CONSULTING ENGINEERING SERVICES, INC. 811 MIDDLE STREET MIDDLETOWN, CT | | |
| mark | date | description | date | scale | AS NOTED |
| | 8/4/17 | SCHEMATIC DESIGN SUBMISSION | 07/25/18 | | |
| | 1/15/18 | DESIGN DEVELOPMENT SUBMISSION | | | |
| | 4/16/18 | CONSTRUCTION DOCUMENTS | | | |
| | 5/23/18 | | | | |
| | 7/25/18 | | | | |
| | 1/21/19 | | | | |
| project WESTERN CT STATE UNIVERSITY WHITE HALL 2ND AND 3RD FLOOR RENOVATIONS DANBURY, CONNECTICUT | | | drawn by AJS | approved by PMA | drawing no. MD1.04 |
| CAD no. xxxxxxxxx.dwg | project no. 61-RD-299 | | | | |

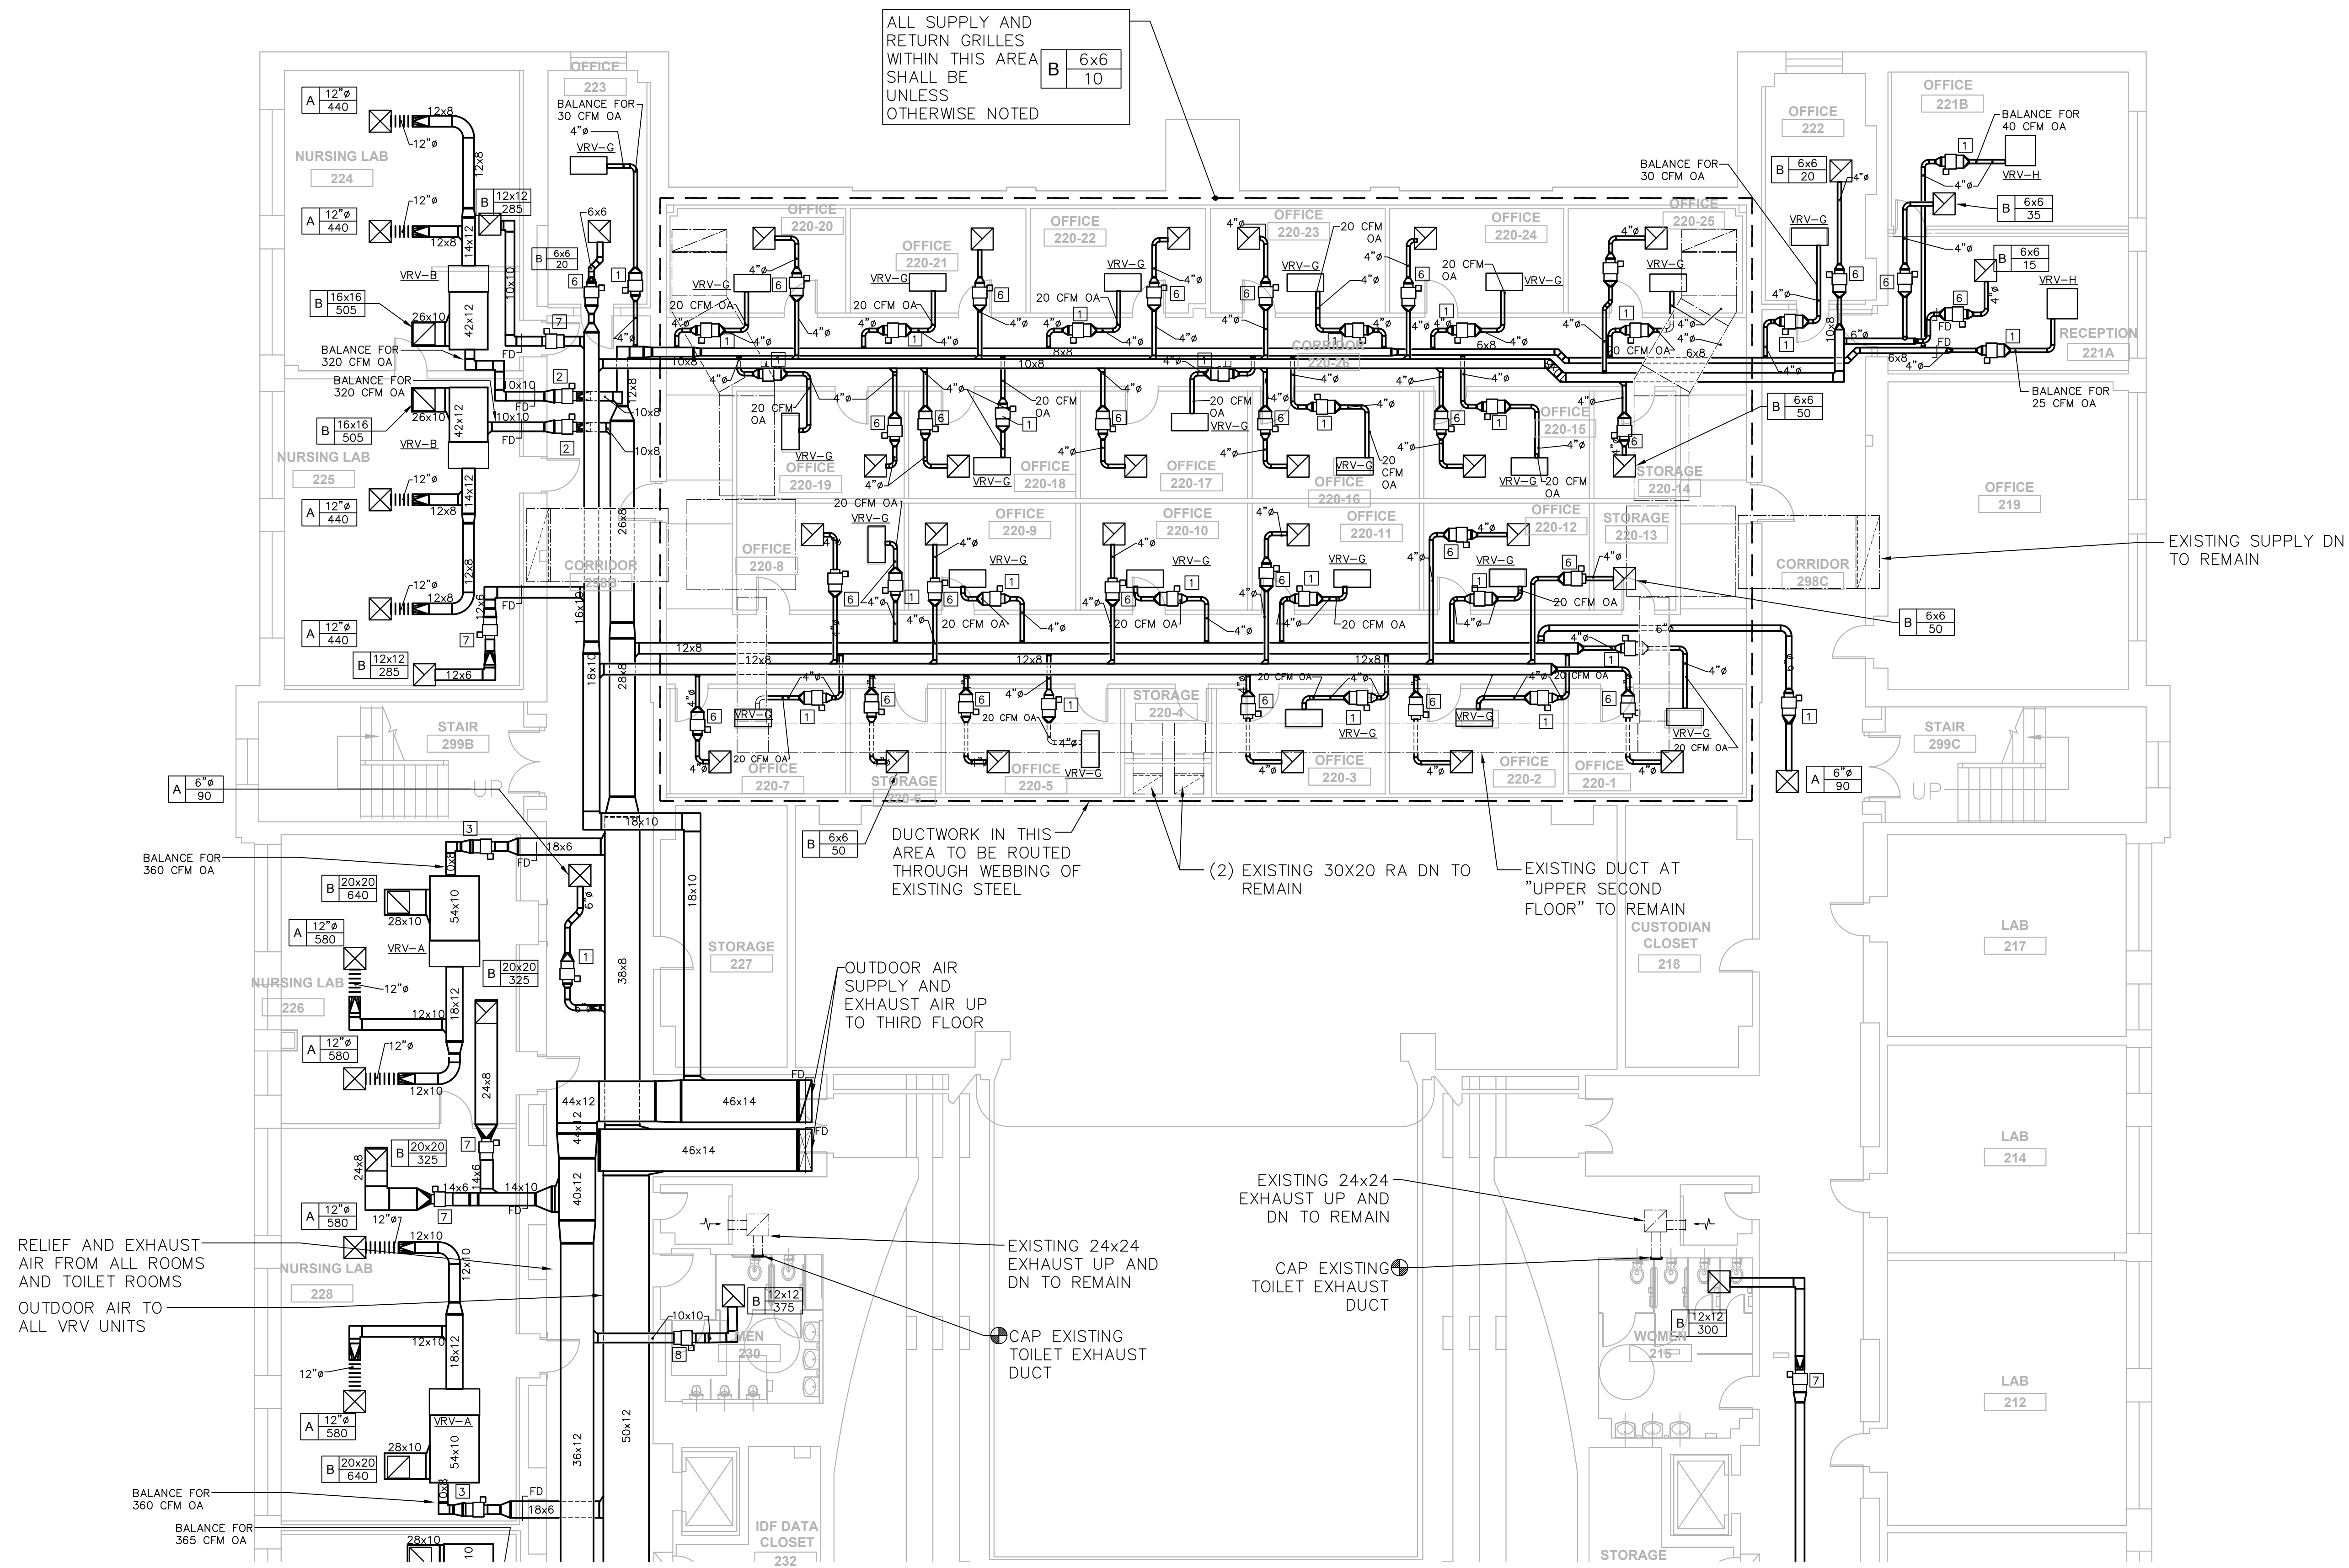

ALL SUPPLY AND RETURN GRILLES WITHIN THIS AREA SHALL BE UNLESS OTHERWISE NOTED

| | | |
|---|------|-----|
| A | 12"ø | 440 |
| B | 6x6 | 10 |

DUCTWORK IN THIS AREA TO BE ROUTED THROUGH WEBBING OF EXISTING STEEL

(2) EXISTING 30x20 RA DN TO REMAIN

EXISTING DUCT AT "UPPER SECOND FLOOR" TO REMAIN

OUTDOOR AIR SUPPLY AND EXHAUST AIR UP TO THIRD FLOOR

EXISTING 24x24 EXHAUST UP AND DN TO REMAIN

EXISTING 24x24 EXHAUST UP AND DN TO REMAIN

CAP EXISTING TOILET EXHAUST DUCT

CAP EXISTING TOILET EXHAUST DUCT


RELIEF AND EXHAUST AIR FROM ALL ROOMS AND TOILET ROOMS
OUTDOOR AIR TO ALL VRV UNITS

EXISTING SUPPLY DN TO REMAIN

MECHANICAL NOTES

1. FLEXIBLE CONNECTIONS TO DIFFUSERS SHALL NOT EXCEED 5'-0" IN LENGTH.
2. DUCTWORK AND PIPING LAYOUTS DO NOT SHOW ALL TRANSITIONS AND OFFSETS THAT WILL BE REQUIRED. PROVIDE COORDINATION DRAWINGS AND OFFSET DUCTWORK AND PIPING AS REQUIRED.
3. ALL PENETRATIONS THROUGH FULL HEIGHT CORRIDOR WALLS SHALL BE SEALED AND FIRESTOPPED.
4. FINNED TUBE RADIATION SHALL BE CONNECTED TO EXISTING HWS&R RISERS.
5. HOT WATER SUPPLY & RETURN BRANCH PIPING TO FINNED TUBE RADIATION SHALL BE MINIMUM 3/4" UNLESS NOTED OTHERWISE. PROVIDE TRANSITION AS REQUIRED FOR FINNED TUBE BASEBOARD RADIATION CONNECTIONS
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9. PROVIDE VOLUME DAMPERS AT ALL BRANCH DUCTS SERVING RDG'S AND/OR VAV'S. PROVIDE 12x12 ACCESS DOORS AT ALL DAMPERS ABOVE HARD CEILINGS. COORDINATE WITH ARCHITECT'S PLAN FOR LOCATION.
10. SEE VAV SCHEDULE FOR DUCT INLET SIZE.
11. PROVIDE THERMOSTAT AND CARBON DIOXIDE SENSOR AT ALL ROOMS WITH A SUPPLY AIR VAV BOX TO COORDINATE WITH DEMAND CONTROL VENTILATION OPERATION.


| drawing title | | STATE OF CONNECTICUT DEPARTMENT OF ADMINISTRATIVE SERVICES | |
|--|------|---|--|
| MECHANICAL SECOND FLOOR - NORTH PARTIAL PLAN | | | |
| REVISIONS | | | |
| mark | date | description | drawing prepared by |
| | | | CONSULTING ENGINEERING SERVICES, INC. |
| | | | 811 MIDDLE STREET MIDDLETOWN, CT |
| | | | project |
| | | | WESTERN CT STATE UNIVERSITY WHITE HALL 2ND AND 3RD FLOOR RENOVATIONS DANBURY, CONNECTICUT |
| | | | CAD no. xxxxxxxxxx.dwg |
| | | | project no. BI-RD-299 |
| | | | date 07/25/18 |
| | | | scale AS NOTED |
| | | | drawn by AJS |
| | | | approved by PMA |
| | | | drawing no. M1.01 |

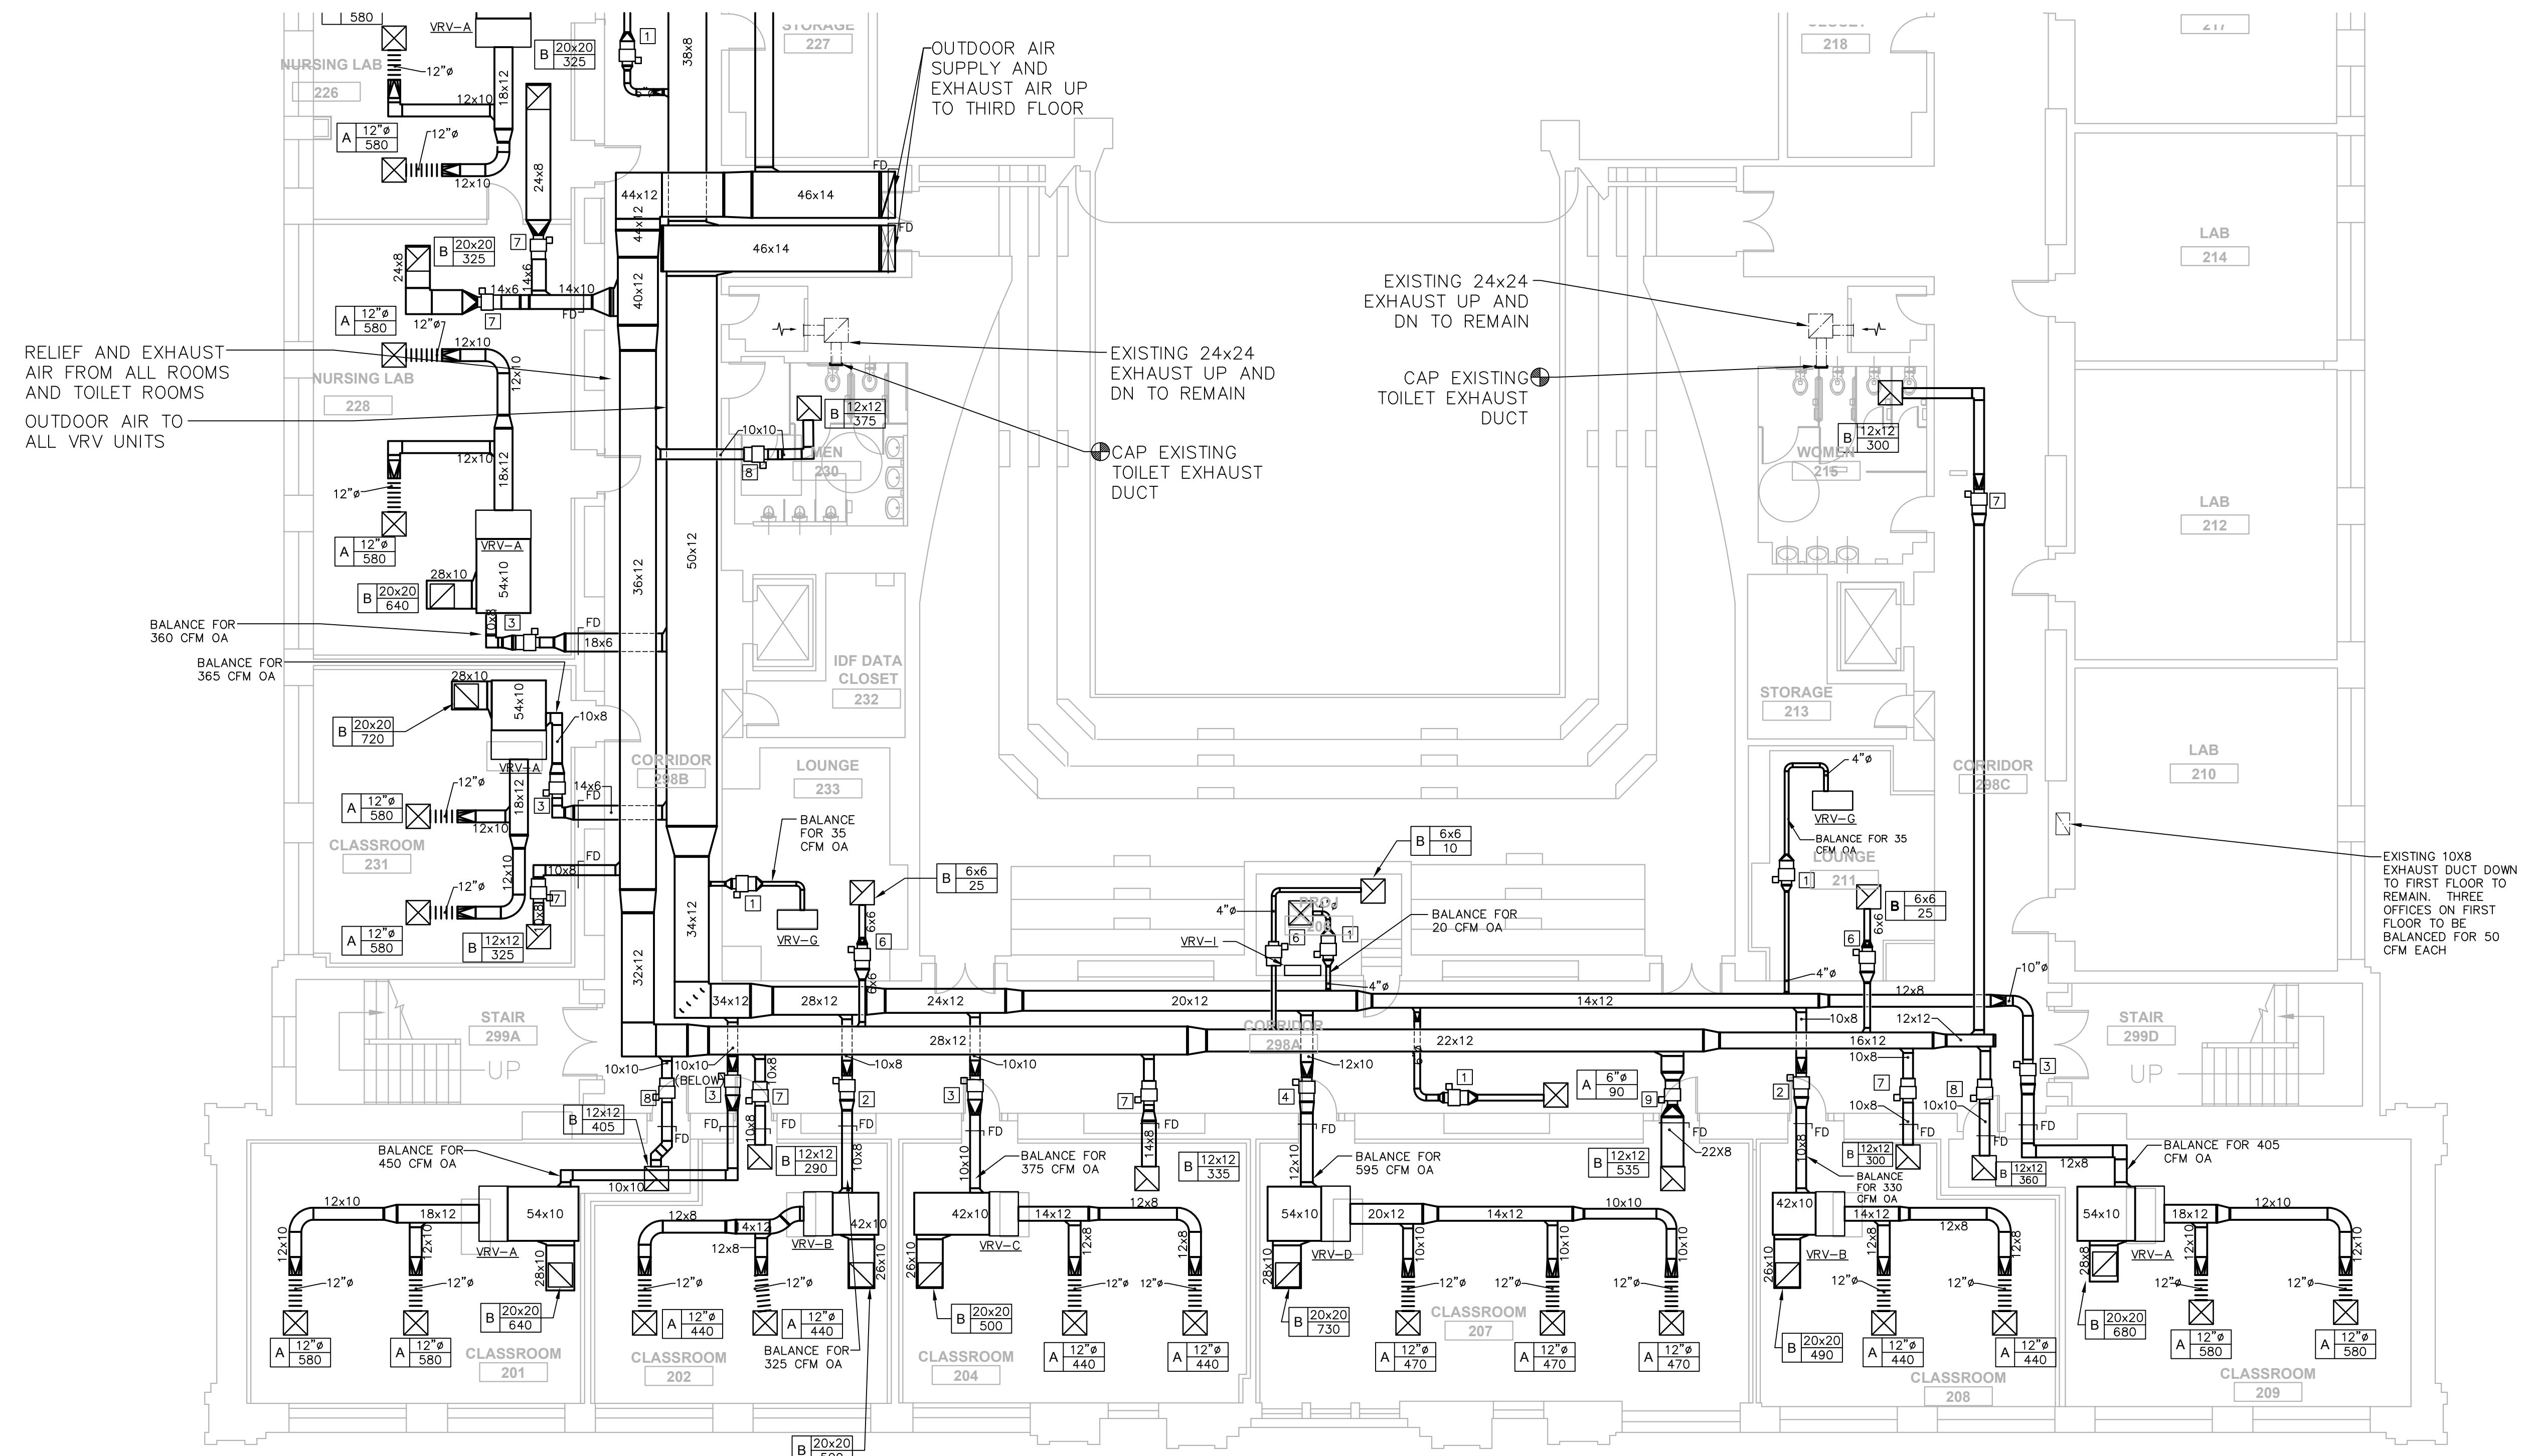

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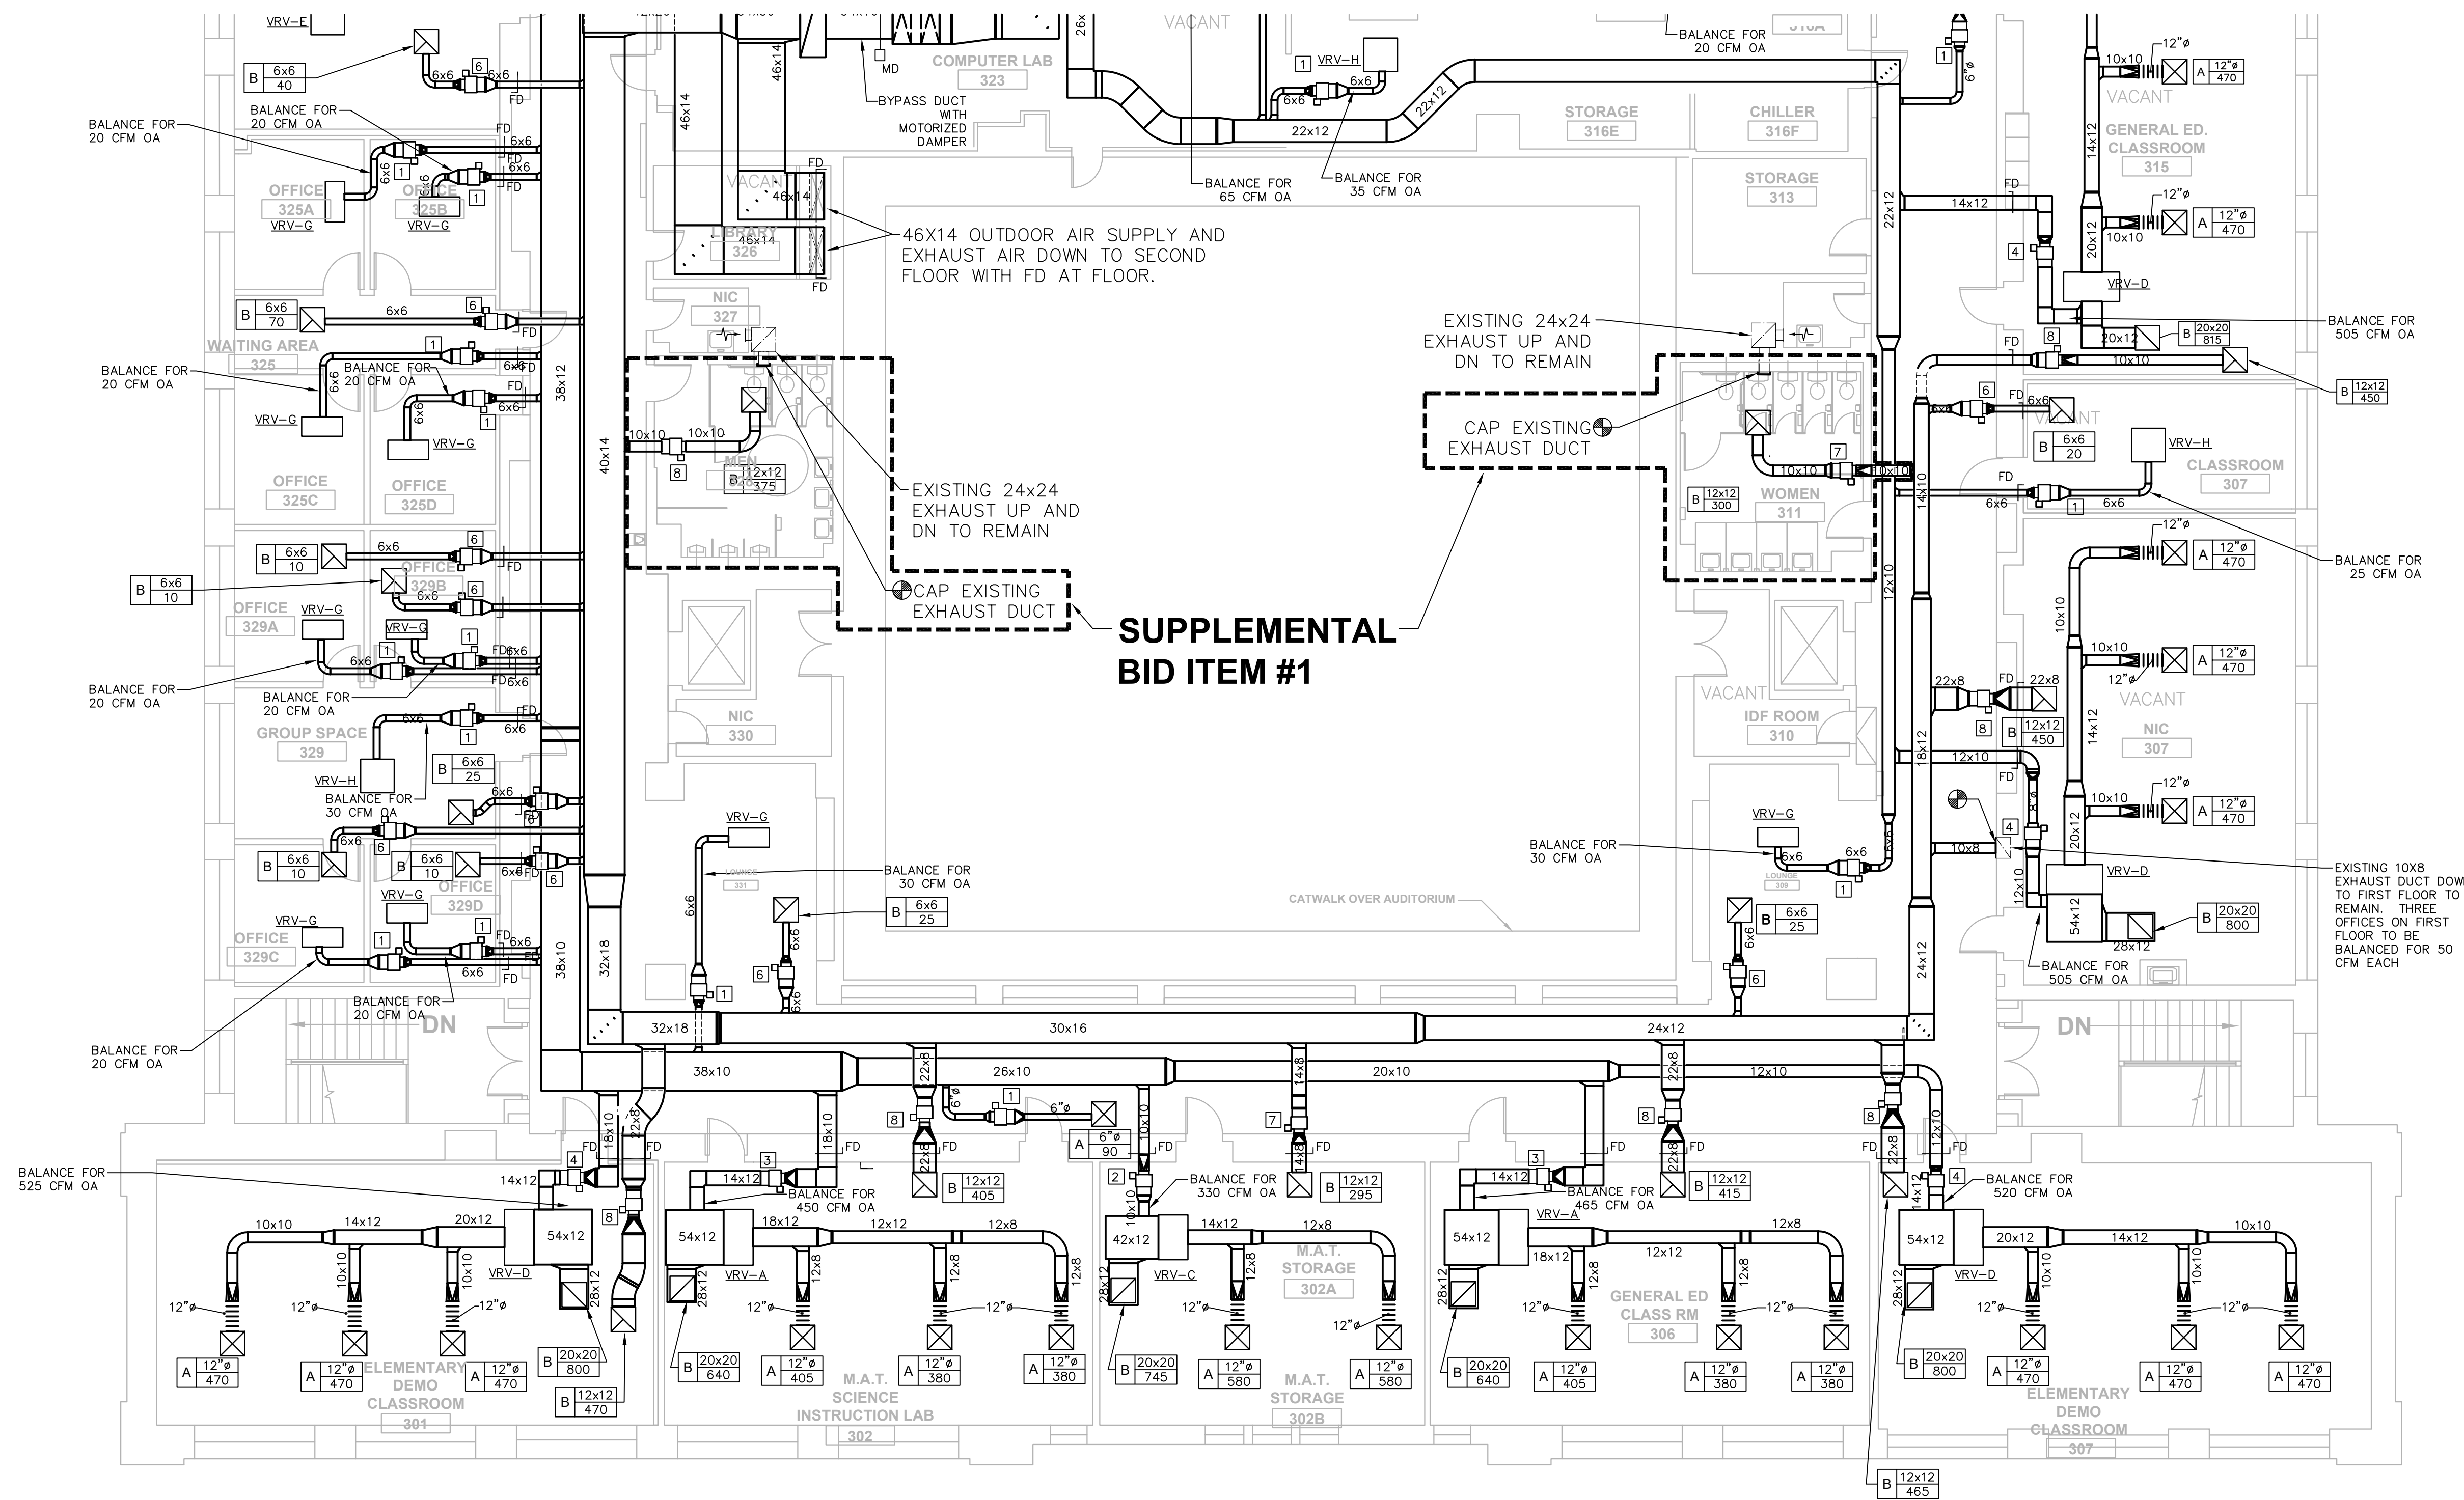
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|--|--------------------------|--|---|
| drawing title MECHANICAL SECOND FLOOR - SOUTH PARTIAL PLAN | | STATE OF CONNECTICUT DEPARTMENT OF ADMINISTRATIVE SERVICES | |
| REVISIONS | | drawing prepared by CONSULTING ENGINEERING SERVICES, INC. 811 MIDDLE STREET MIDDLETOWN, CT | date 07/25/18 scale AS NOTED |
| mark | date | description | project WESTERN CT STATE UNIVERSITY WHITE HALL 2ND AND 3RD FLOOR RENOVATIONS DANBURY, CONNECTICUT |
| | 8/4/17 | SCHEMATIC DESIGN SUBMISSION | drawn by AJS |
| | 1/15/18 | DESIGN DEVELOPMENT SUBMISSION | approved by PMA |
| | 4/16/18 | CONSTRUCTION DOCUMENTS | drawing no. M1.02 |
| | 5/23/18 | | |
| | 7/25/18 | | |
| | 12/21/19 | | |
| CAD no. xxxxxxxxx.dwg | project no. BI-RD-299 | | |



MECHANICAL NOTES

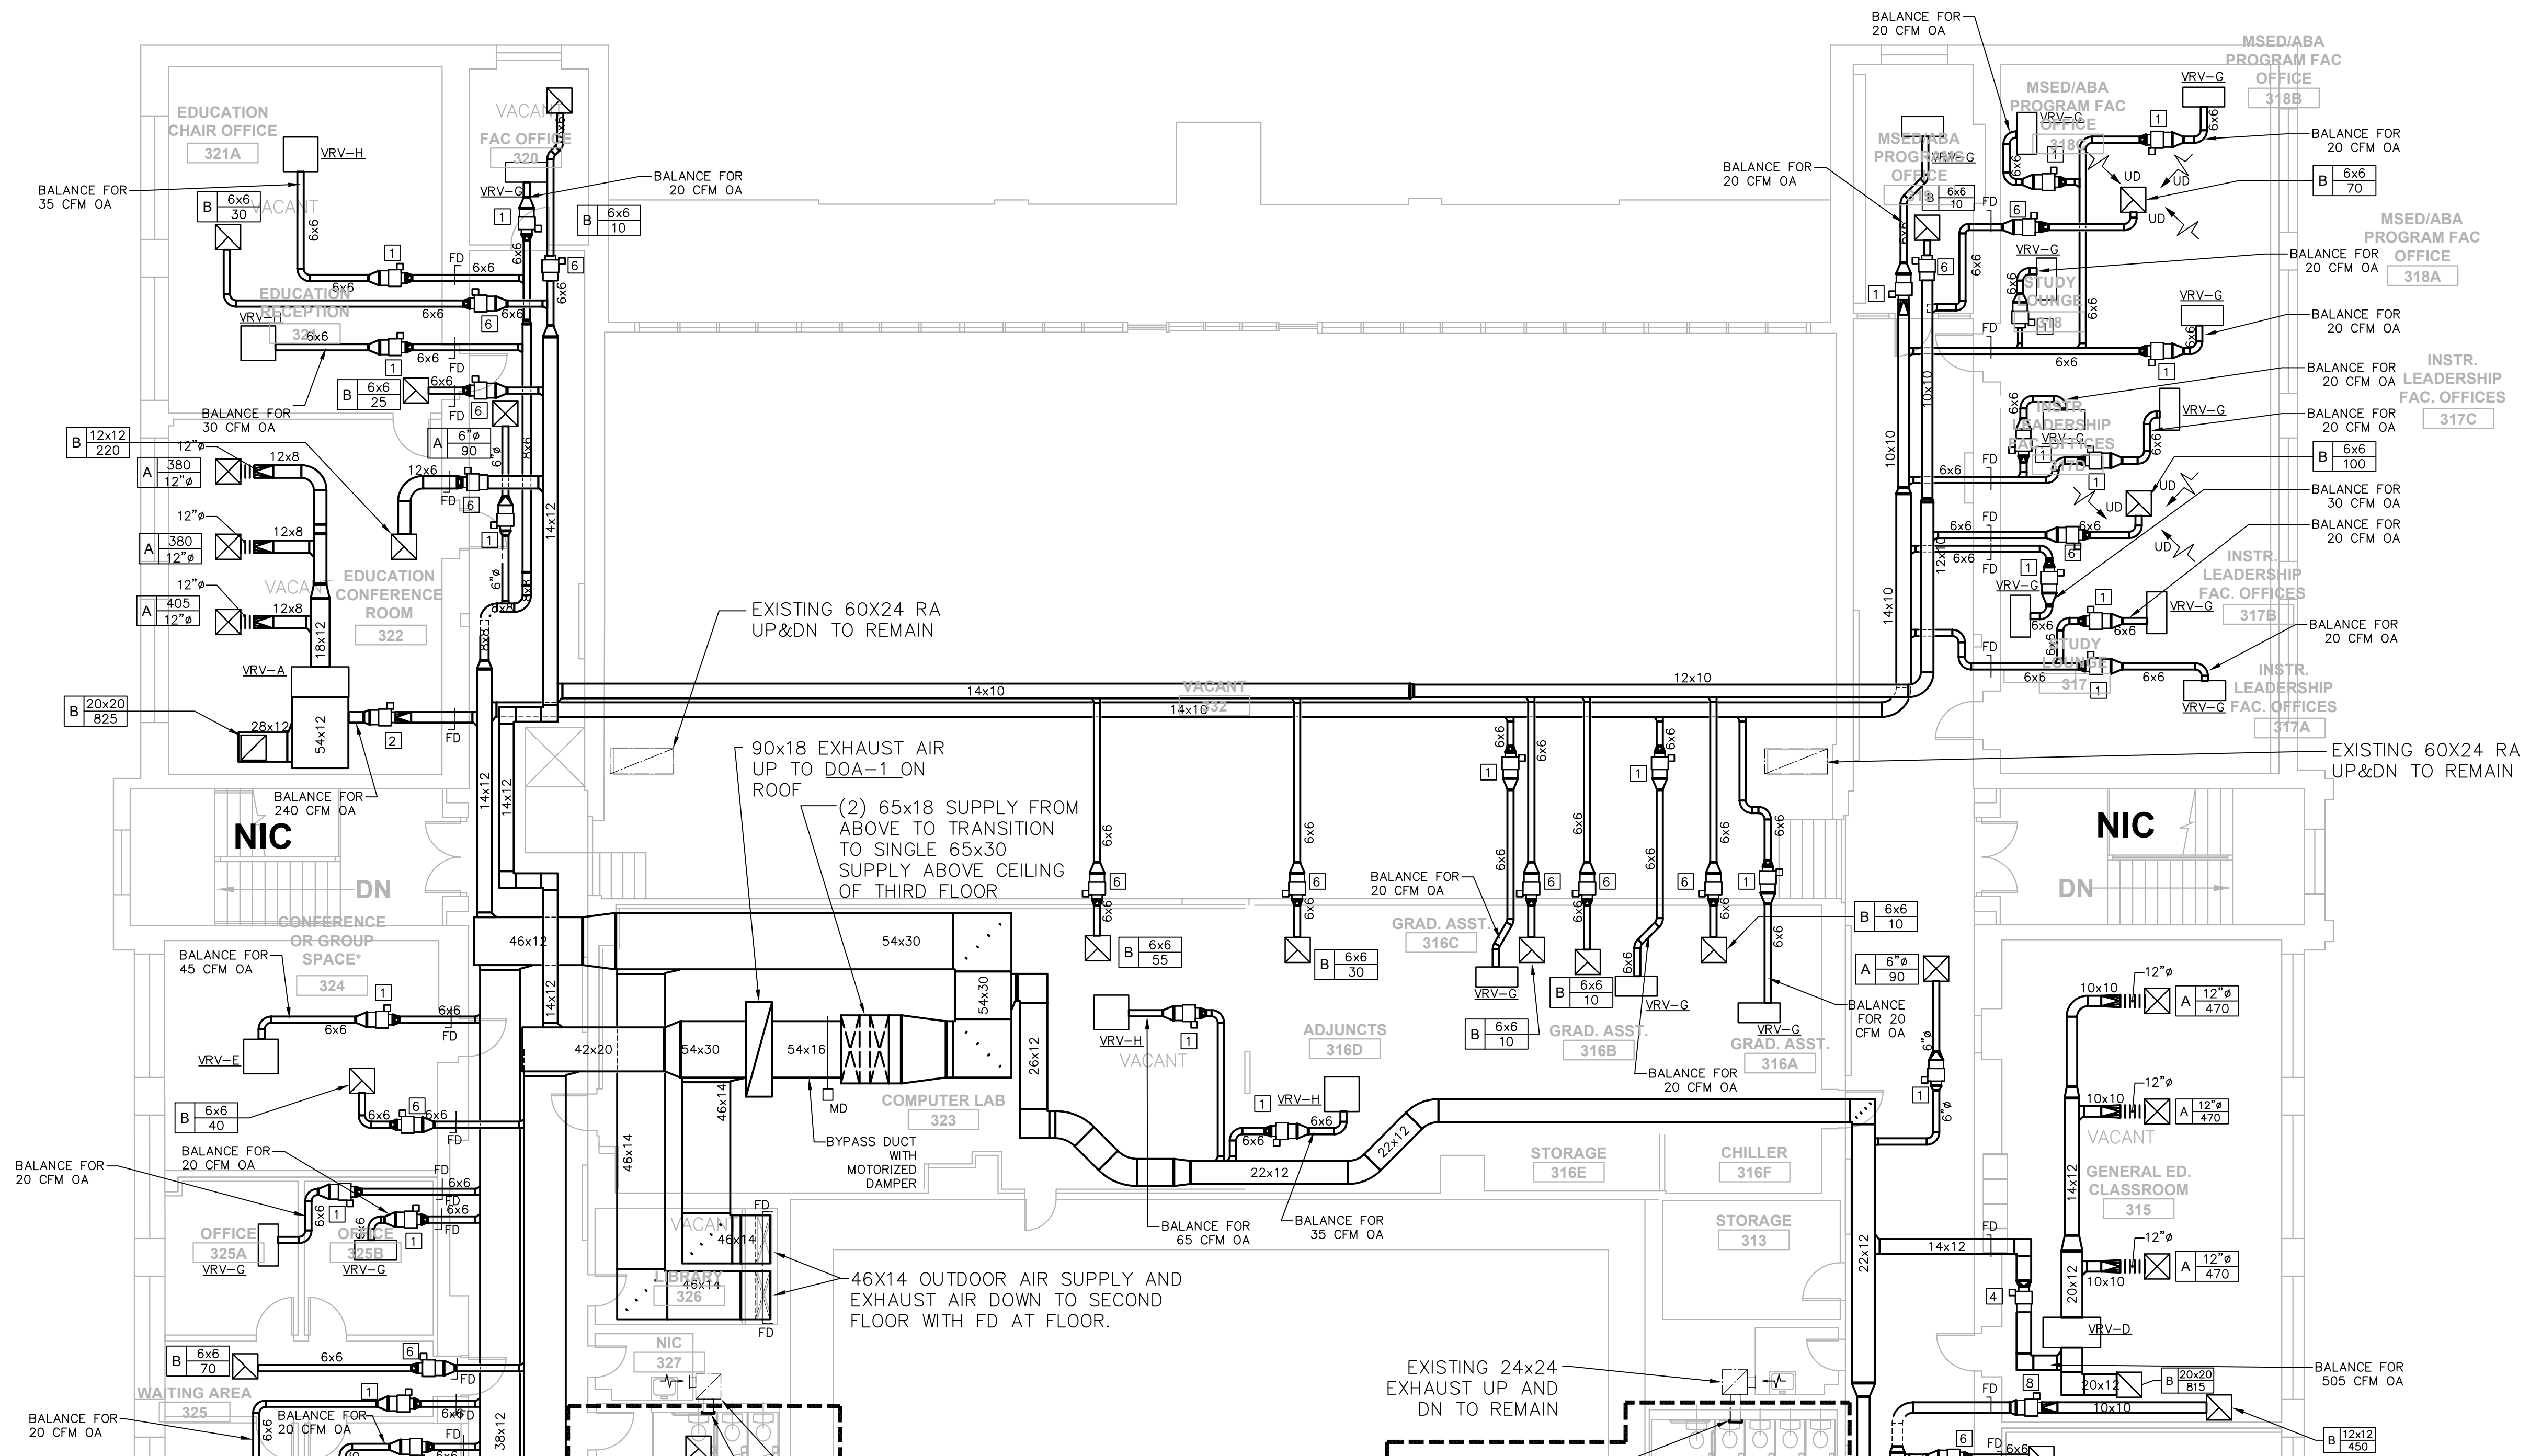
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- SEE VAV SCHEDULE FOR DUCT INLET SIZE.
- PROVIDE THERMOSTAT AND CARBON DIOXIDE SENSOR AT ALL ROOMS WITH A SUPPLY AIR VAV BOX TO COORDINATE WITH DEMAND CONTROL VENTILATION OPERATION.

| drawing title | | | STATE OF CONNECTICUT DEPARTMENT OF ADMINISTRATIVE SERVICES | |
|---|---------|-------------------------------|---|--------------------|
| MECHANICAL THIRD FLOOR - NORTH PARTIAL PLAN | | | | |
| REVISIONS | | | | |
| mark | date | description | drawing prepared by | date |
| | 8/4/17 | SCHEMATIC DESIGN SUBMISSION | CONSULTING ENGINEERING SERVICES, INC. 811 MIDDLE STREET MIDDLETOWN, CT | 07/25/18 |
| | 1/15/18 | DESIGN DEVELOPMENT SUBMISSION | | scale AS NOTED |
| | 4/16/18 | CONSTRUCTION DOCUMENTS | project WESTERN CT STATE UNIVERSITY WHITE HALL 2ND AND 3RD FLOOR RENOVATIONS DANBURY, CONNECTICUT | drawn by AJS |
| | 5/23/18 | | | approved by PMA |
| | 7/25/18 | | | drawing no. |
| | 12/1/19 | | | M1.03 |
| CAD no. xxxxxxxxx.dwg | | project no. BI-RD-299 | | |



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|---|---------|-------------------------------|---|--|
| MECHANICAL THIRD FLOOR - SOUTH PARTIAL PLAN | | | drawing prepared by CONSULTING ENGINEERING SERVICES, INC. 811 MIDDLE STREET MIDDLETOWN, CT | |
| REVISIONS | | | date 07/25/18 | |
| mark | date | description | scale AS NOTED | |
| | 8/4/17 | SCHEMATIC DESIGN SUBMISSION | project WESTERN CT STATE UNIVERSITY WHITE HALL 2ND AND 3RD FLOOR RENOVATIONS DANBURY, CONNECTICUT | |
| | 1/15/18 | DESIGN DEVELOPMENT SUBMISSION | drawn by AJS | |
| | 4/16/18 | CONSTRUCTION DOCUMENTS | approved by PMA | |
| | 5/23/18 | | drawing no. M1.04 | |
| | 7/25/18 | | CAD no. xxxxxxxxx.dwg | |
| | 1/21/19 | | project no. 61-RD-299 | |

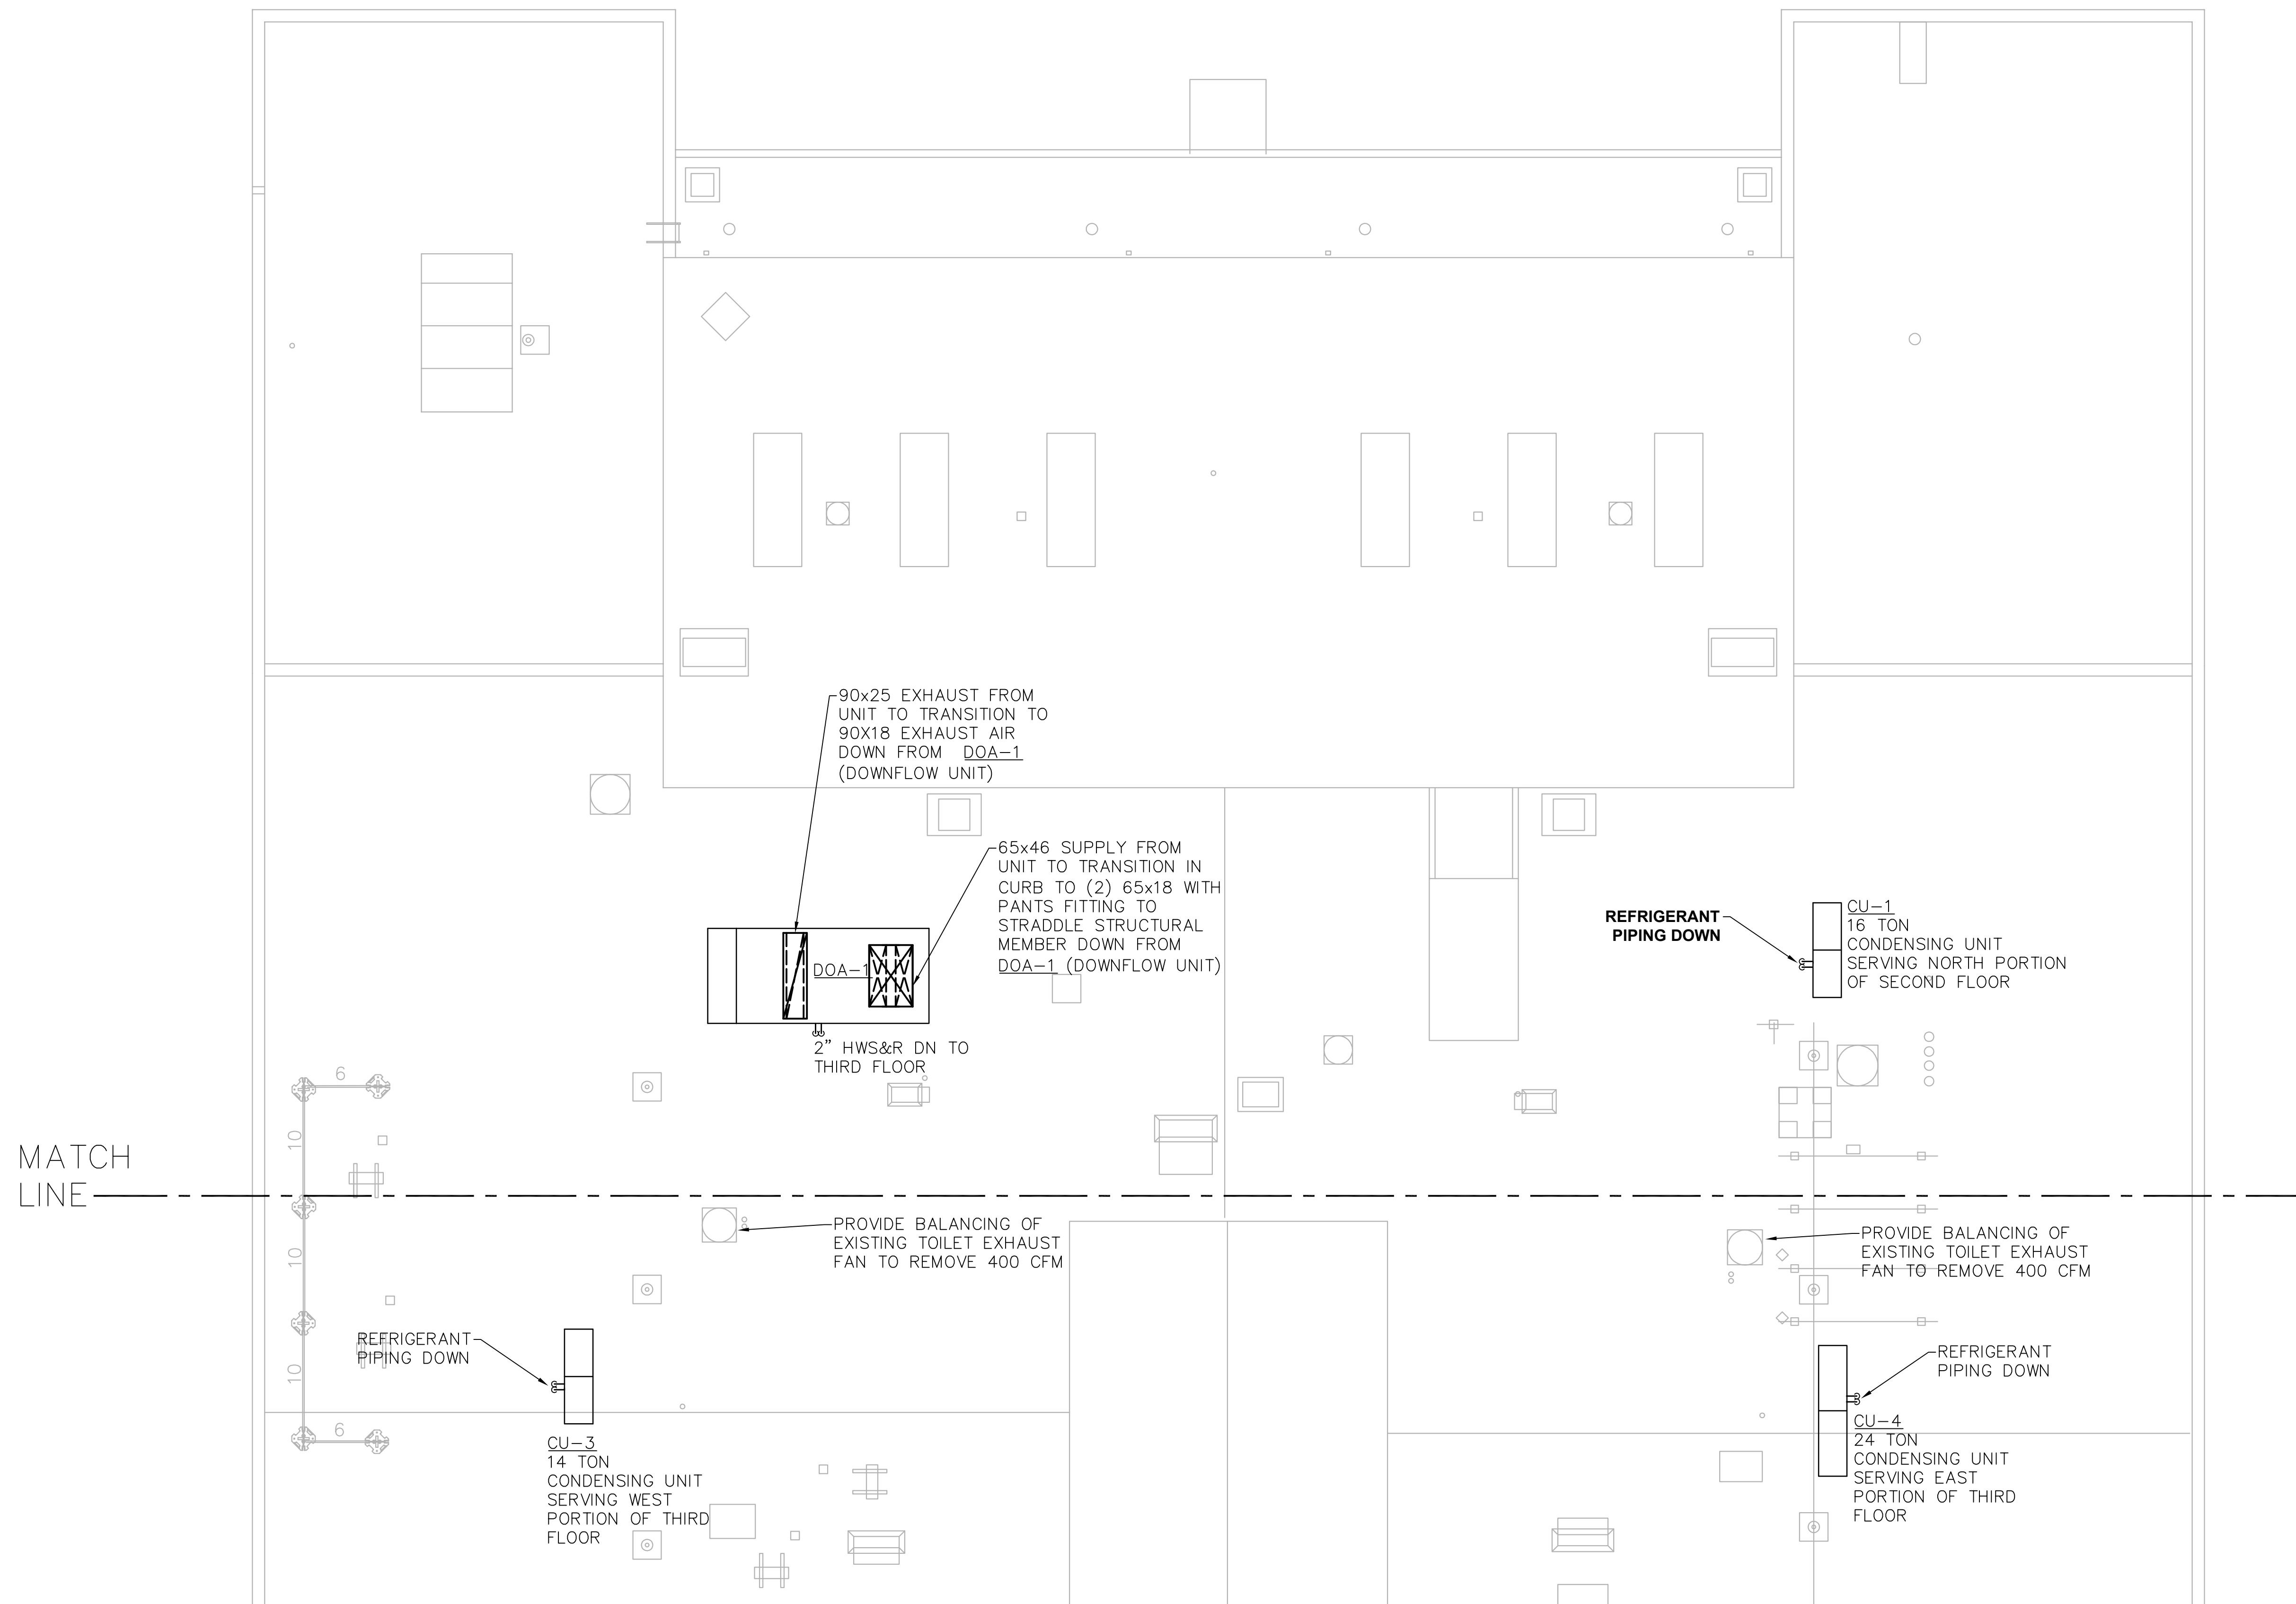


MECHANICAL ROOF NOTES

- COORDINATE ROOFTOP HVAC EQUIPMENT WITH ROOF RE-COATING AND REPAIR.
- DUCTWORK AND PIPING LAYOUTS DO NOT SHOW ALL TRANSITIONS AND OFFSETS THAT WILL BE REQUIRED. PROVIDE COORDINATION DRAWINGS AND OFFSET DUCTWORK AND PIPING AS REQUIRED.
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| | | | | |
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| drawing title MECHANICAL ROOF - NORTH PARTIAL PLAN | | | STATE OF CONNECTICUT DEPARTMENT OF ADMINISTRATIVE SERVICES | |
| REVISIONS | | | drawing prepared by CONSULTING ENGINEERING SERVICES, INC. 811 MIDDLE STREET MIDDLETOWN, CT | date 07/25/18 scale AS NOTED |
| mark | date | description | project WESTERN CT STATE UNIVERSITY WHITE HALL 2ND AND 3RD FLOOR RENOVATIONS DANBURY, CONNECTICUT | drawn by AJS approved by PMA drawing no. M1.05 |
| | 8/4/17 | SCHEMATIC DESIGN SUBMISSION | | |
| | 1/15/18 | DESIGN DEVELOPMENT SUBMISSION | | |
| | 4/16/18 | CONSTRUCTION DOCUMENTS | | |
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| | 7/25/18 | | | |
| | 1/21/19 | | | |
| CAD no. xxxxxxxxx.dwg | | | project no. BI-RD-299 | |


MATCH LINE

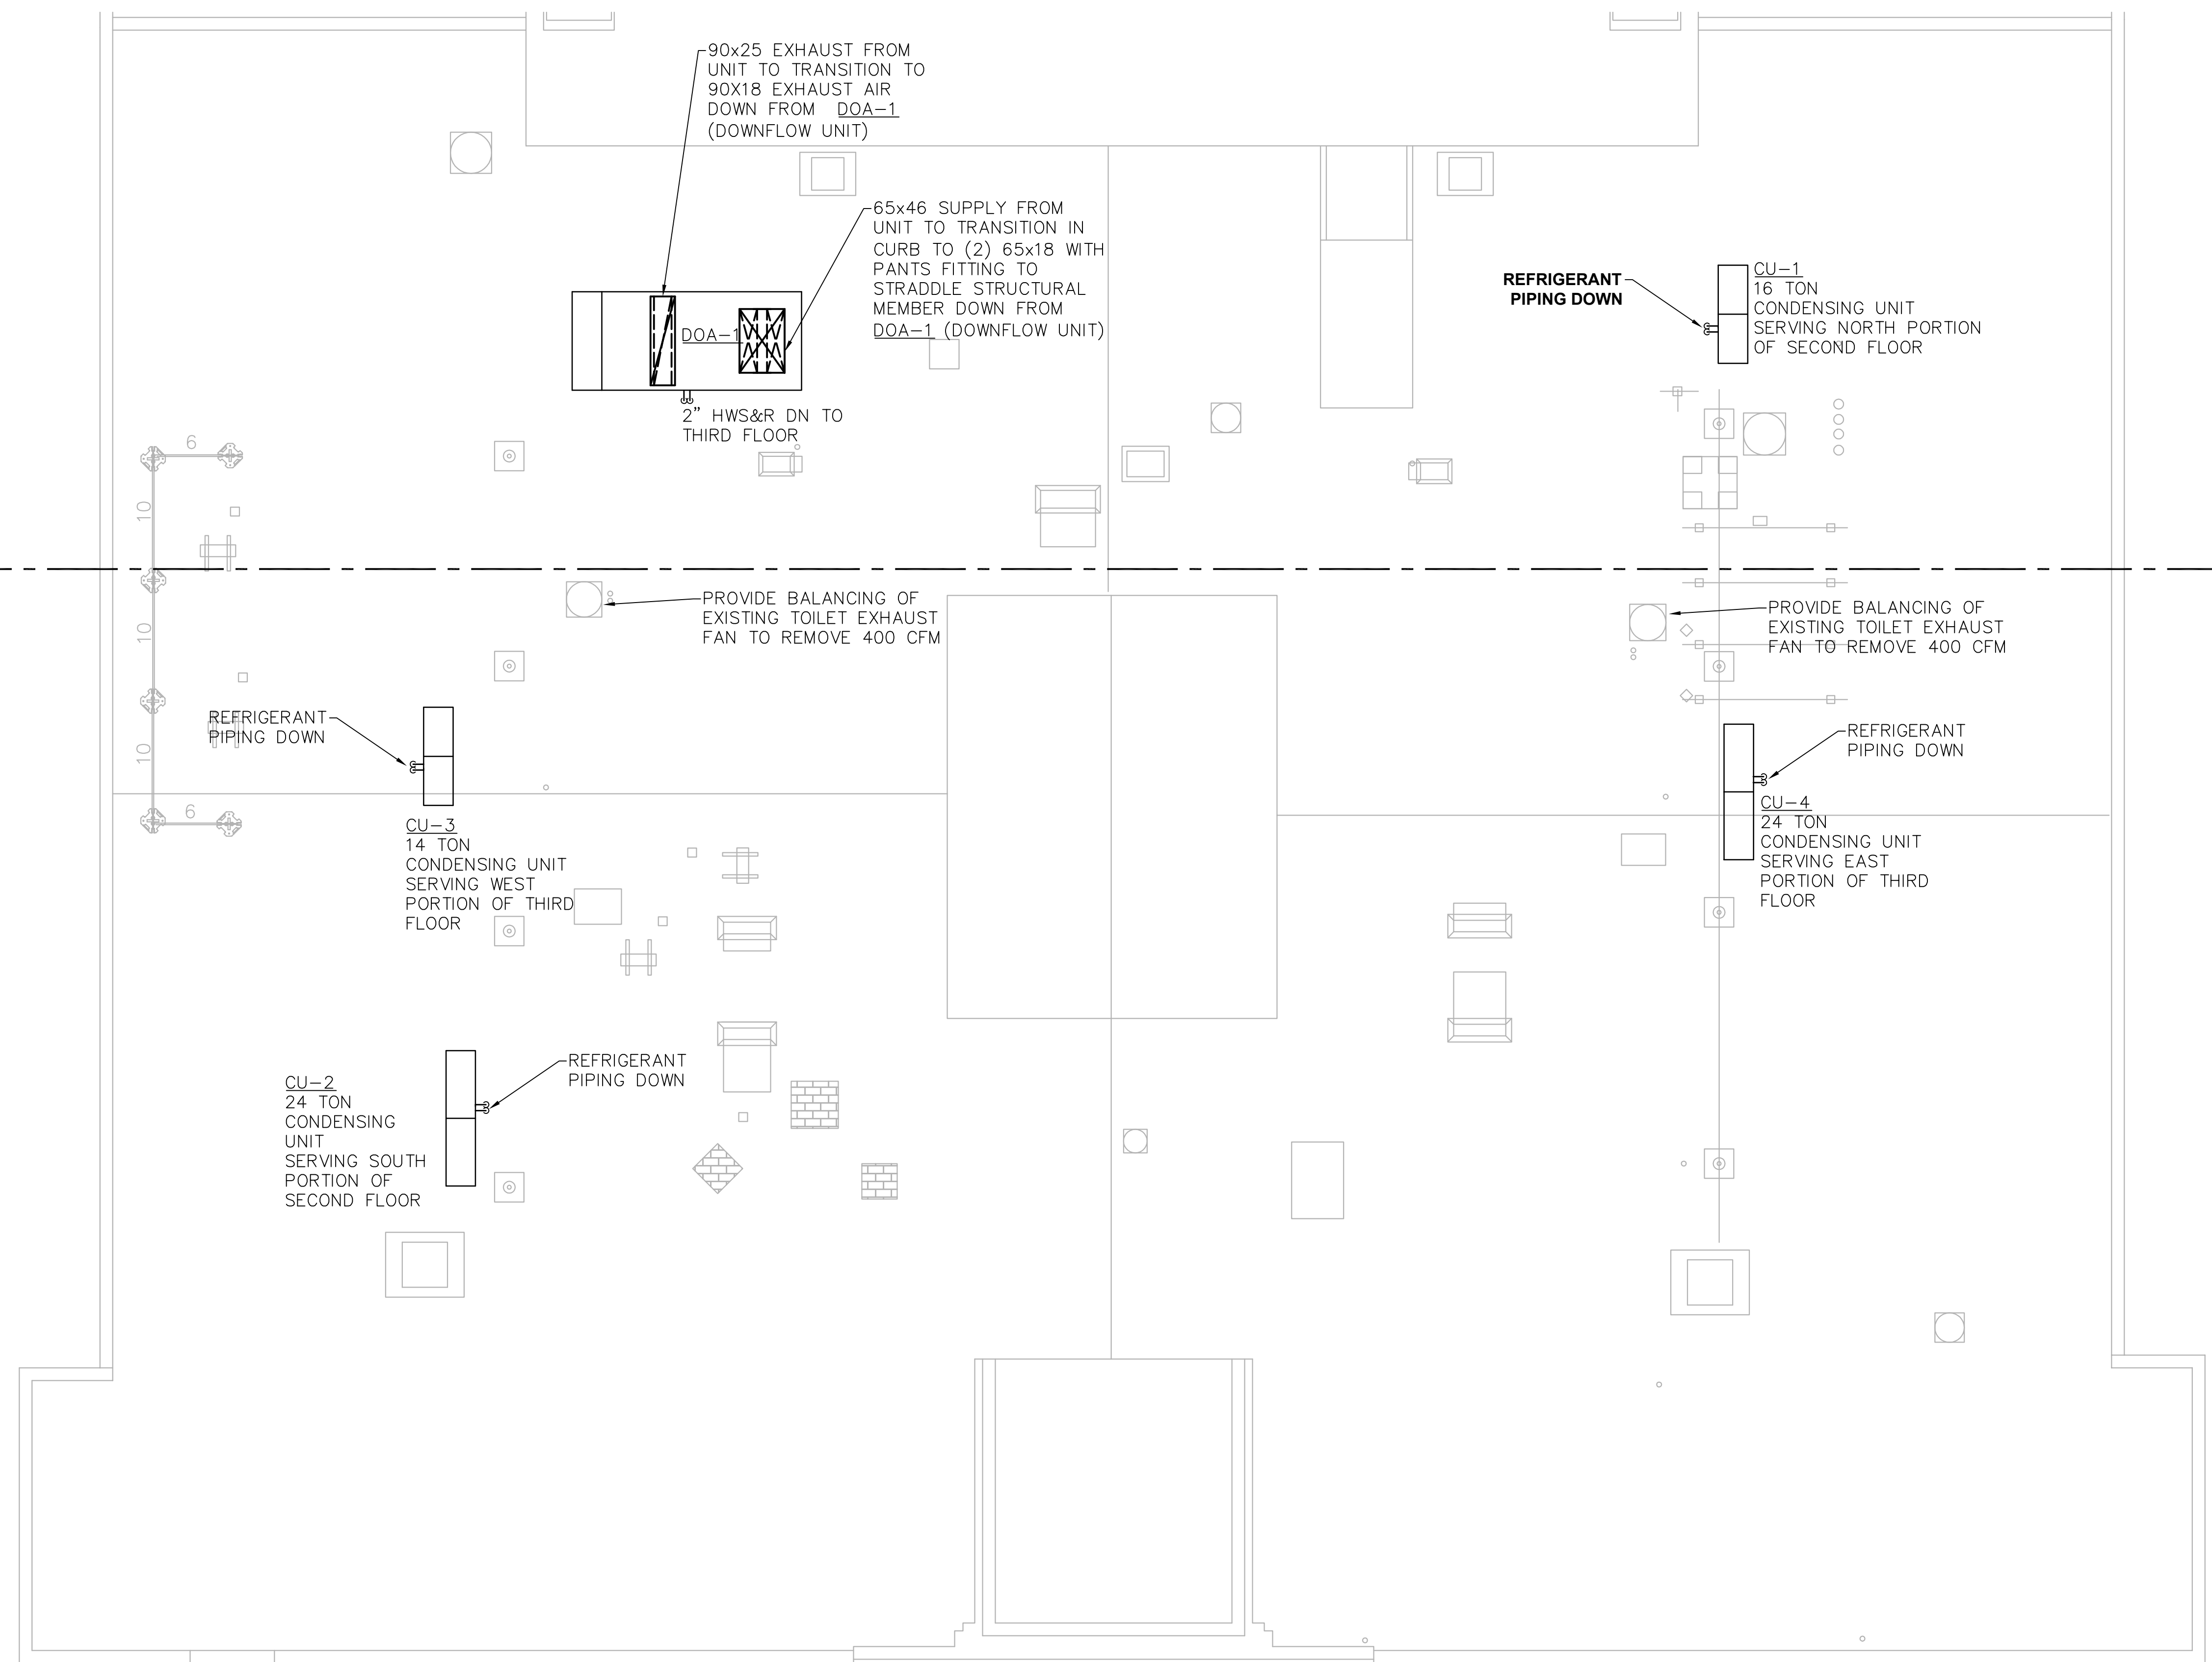

MECHANICAL ROOF NOTES

1. COORDINATE ROOFTOP HVAC EQUIPMENT WITH ROOF RE-COATING AND REPAIR.
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| | | | | |
|---|---------|-------------------------------|--|--------------------------|
| drawing title MECHANICAL ROOF- SOUTH PARTIAL PLAN | | | STATE OF CONNECTICUT DEPARTMENT OF ADMINISTRATIVE SERVICES | |
| REVISIONS | | | drawing prepared by CONSULTING ENGINEERING SERVICES, INC. 811 MIDDLE STREET MIDDLETOWN, CT | |
| mark | date | description | date | scale |
| | 8/4/17 | SCHEMATIC DESIGN SUBMISSION | 07/25/18 | AS NOTED |
| | 1/15/18 | DESIGN DEVELOPMENT SUBMISSION | | |
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| | 5/23/18 | | | |
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| | 1/21/19 | | | |
| project WESTERN CT STATE UNIVERSITY WHITE HALL 2ND AND 3RD FLOOR RENOVATIONS DANBURY, CONNECTICUT | | | drawn by AJS | approved by PMA |
| drawing no. M1.06 | | | CAD no. xxxxxxxxx.dwg | project no. BI-RD-299 |

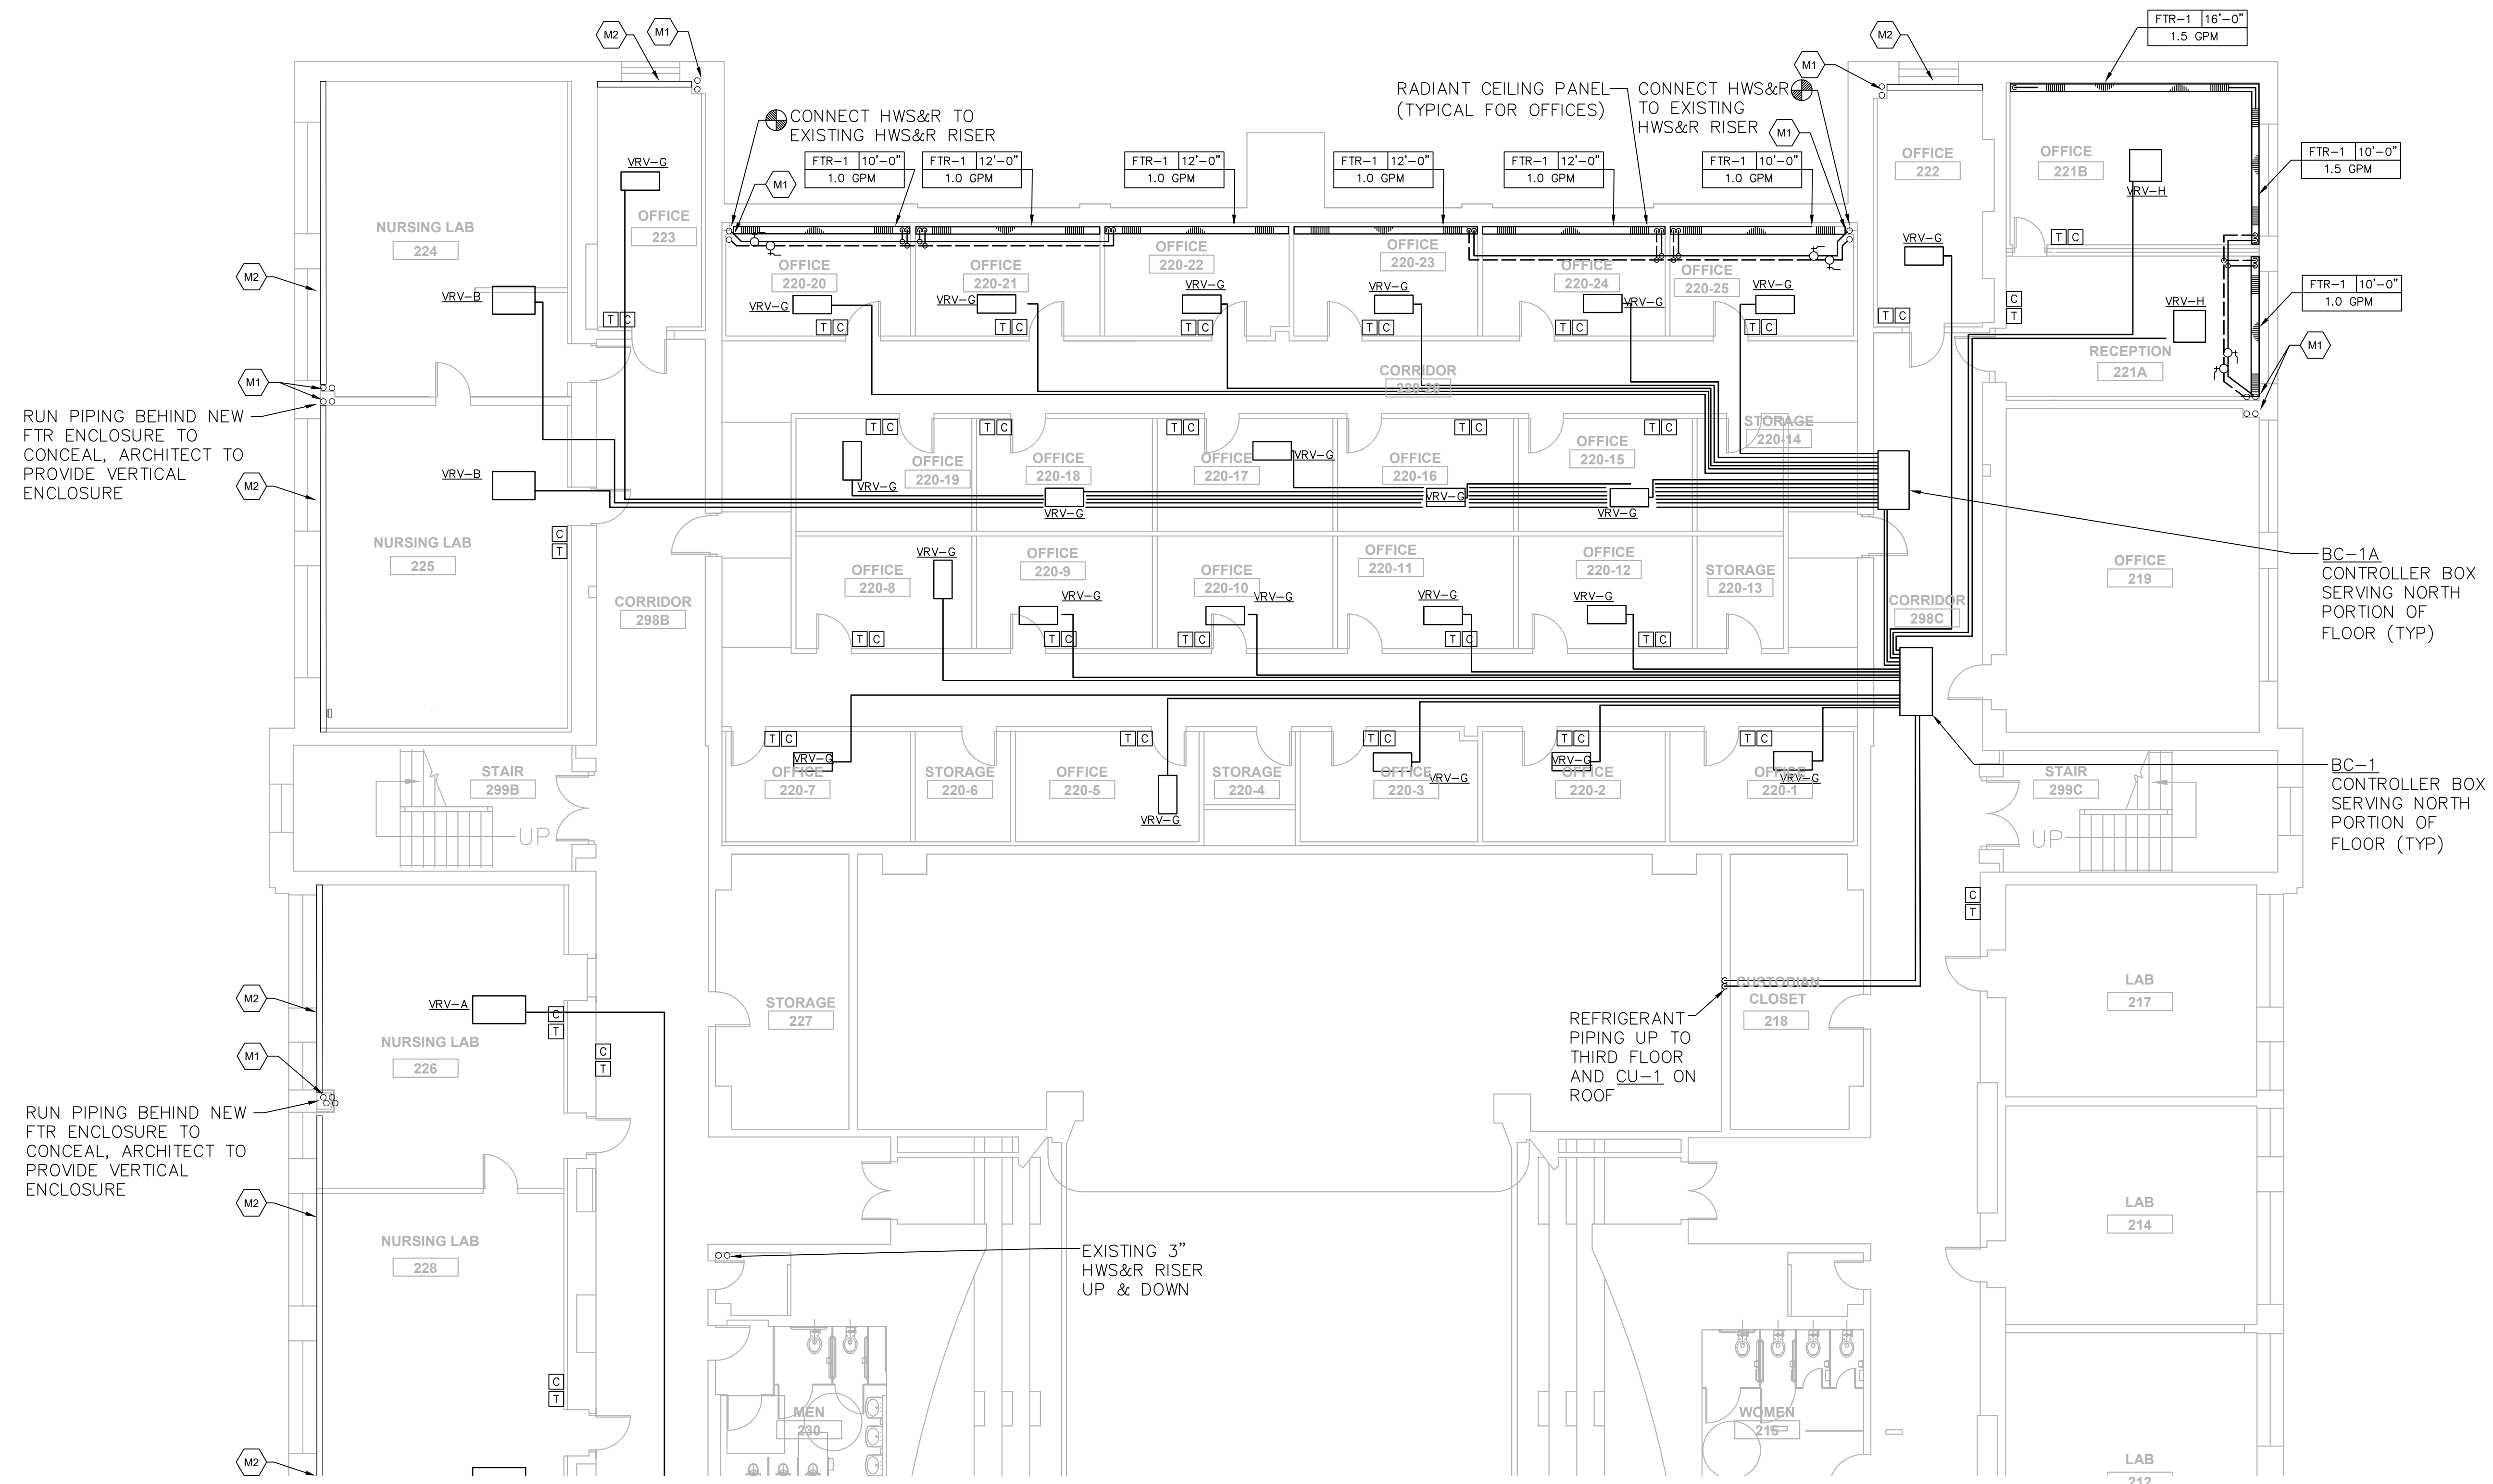


MECHANICAL KEY NOTES

- M1 CONNECT TO EXISTING HWS&R RISER.
- M2 EXISTING FIN TUBE RADIATION, PROVIDE NEW ENCLOSURE, ELECTRIC DDC CONTROL VALVE, ISOLATION VALVE, BALANCING VALVE AND STRAINER, NEW ENCLOSURE SHALL BE RITTLING MODEL IBGHLS, DIMENSIONS 24" HIGH X 5-3/8" DEEP, LENGTH SHALL BE WALL TO WALL.

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| | | | | | |
|----------------------|--|--|--|---|--|
| drawing title | | MECHANICAL PIPING SECOND FLOOR - NORTH PARTIAL PLAN | | STATE OF CONNECTICUT DEPARTMENT OF ADMINISTRATIVE SERVICES | |
| mark | | date | | description | |
| mark | | date | | description | |
| 8/4/17 | | 1/15/18 | | SCHEMATIC DESIGN SUBMISSION | |
| 1/15/18 | | 4/16/18 | | DESIGN DEVELOPMENT SUBMISSION | |
| 5/23/18 | | 7/25/18 | | CONSTRUCTION DOCUMENTS | |
| 1/21/19 | | | | | |
| drawing prepared by | | CONSULTING ENGINEERING SERVICES, INC. | | date 07/25/18 | |
| 811 MIDDLE STREET | | MIDDLETOWN, CT | | scale AS NOTED | |
| project | | WESTERN CT STATE UNIVERSITY | | drawn by AJS | |
| WHITE HALL | | 2ND AND 3RD FLOOR RENOVATIONS | | approved by PMA | |
| DANBURY, CONNECTICUT | | drawing no. | | MP1.01 | |
| CAD no. xxxxxxxx.dwg | | project no. BI-RD-299 | | | |



RUN PIPING BEHIND NEW FTR ENCLOSURE TO CONCEAL, ARCHITECT TO PROVIDE VERTICAL ENCLOSURE

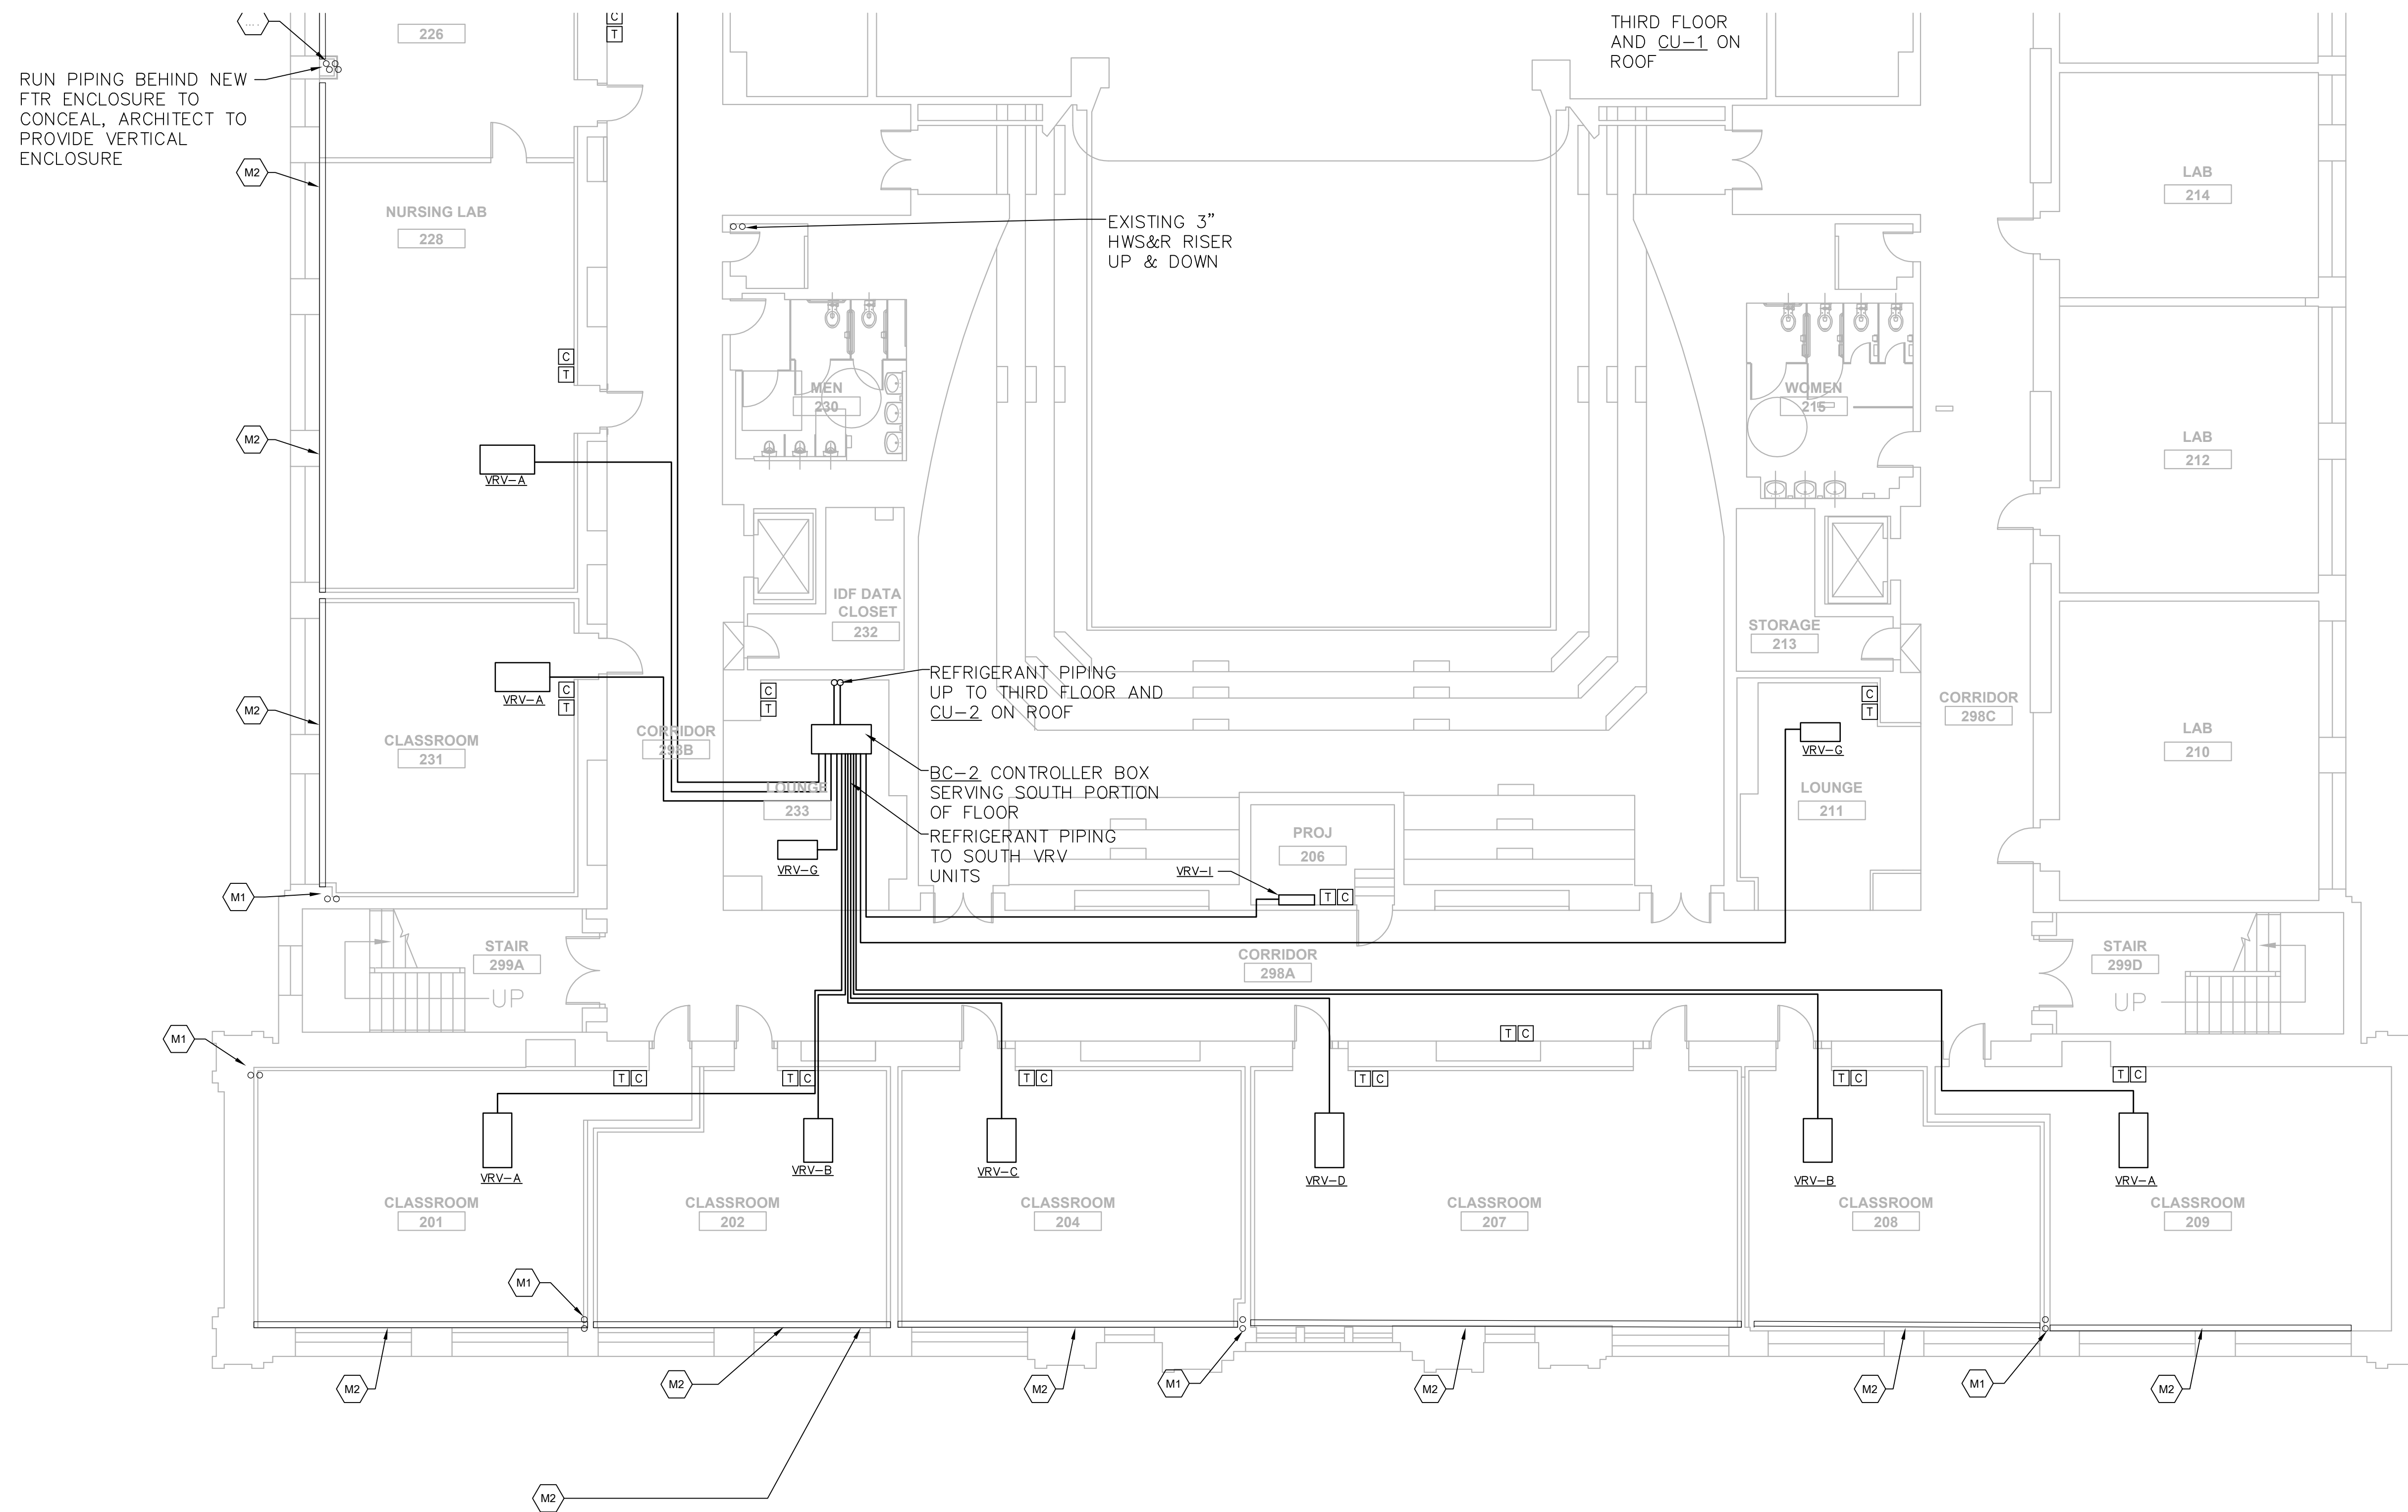EXISTING 3" HWS&R RISER UP & DOWN

REFRIGERANT PIPING UP TO THIRD FLOOR AND CU-2 ON ROOF

BC-2 CONTROLLER BOX SERVING SOUTH PORTION OF FLOOR

REFRIGERANT PIPING TO SOUTH VRV UNITS

THIRD FLOOR AND CU-1 ON ROOF


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|--|---------|-------------------------------|---|--|
| drawing title | | | STATE OF CONNECTICUT DEPARTMENT OF ADMINISTRATIVE SERVICES | |
| MECHANICAL PIPING SECOND FLOOR - SOUTH PARTIAL PLAN | | | drawing prepared by CONSULTING ENGINEERING SERVICES, INC. 811 MIDDLE STREET MIDDLETOWN, CT | |
| REVISIONS | | | date 07/25/18 | |
| mark | date | description | scale AS NOTED | |
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| project | | | drawn by AJS | |
| WESTERN CT STATE UNIVERSITY WHITE HALL 2ND AND 3RD FLOOR RENOVATIONS DANBURY, CONNECTICUT | | | approved by PMA | |
| drawing no. | | | drawing no. | |
| CAD no. xxxxxxxx.dwg | | | project no. 61-RD-299 | |
| | | | MP1.02 | |




MECHANICAL KEY NOTES

- M1 CONNECT TO EXISTING HWS&R RISER.
- EXISTING FIN TUBE RADIATION, PROVIDE NEW ENCLOSURE, ELECTRIC DDC CONTROL VALVE, ISOLATION VALVE, BALANCING VALVE AND STRAINER. NEW ENCLOSURE SHALL BE RITTLING MODEL IBGHLS, DIMENSIONS 24" HIGH X 5-3/8" DEEP, LENGTH SHALL BE WALL TO WALL.
- M2

MECHANICAL NOTES

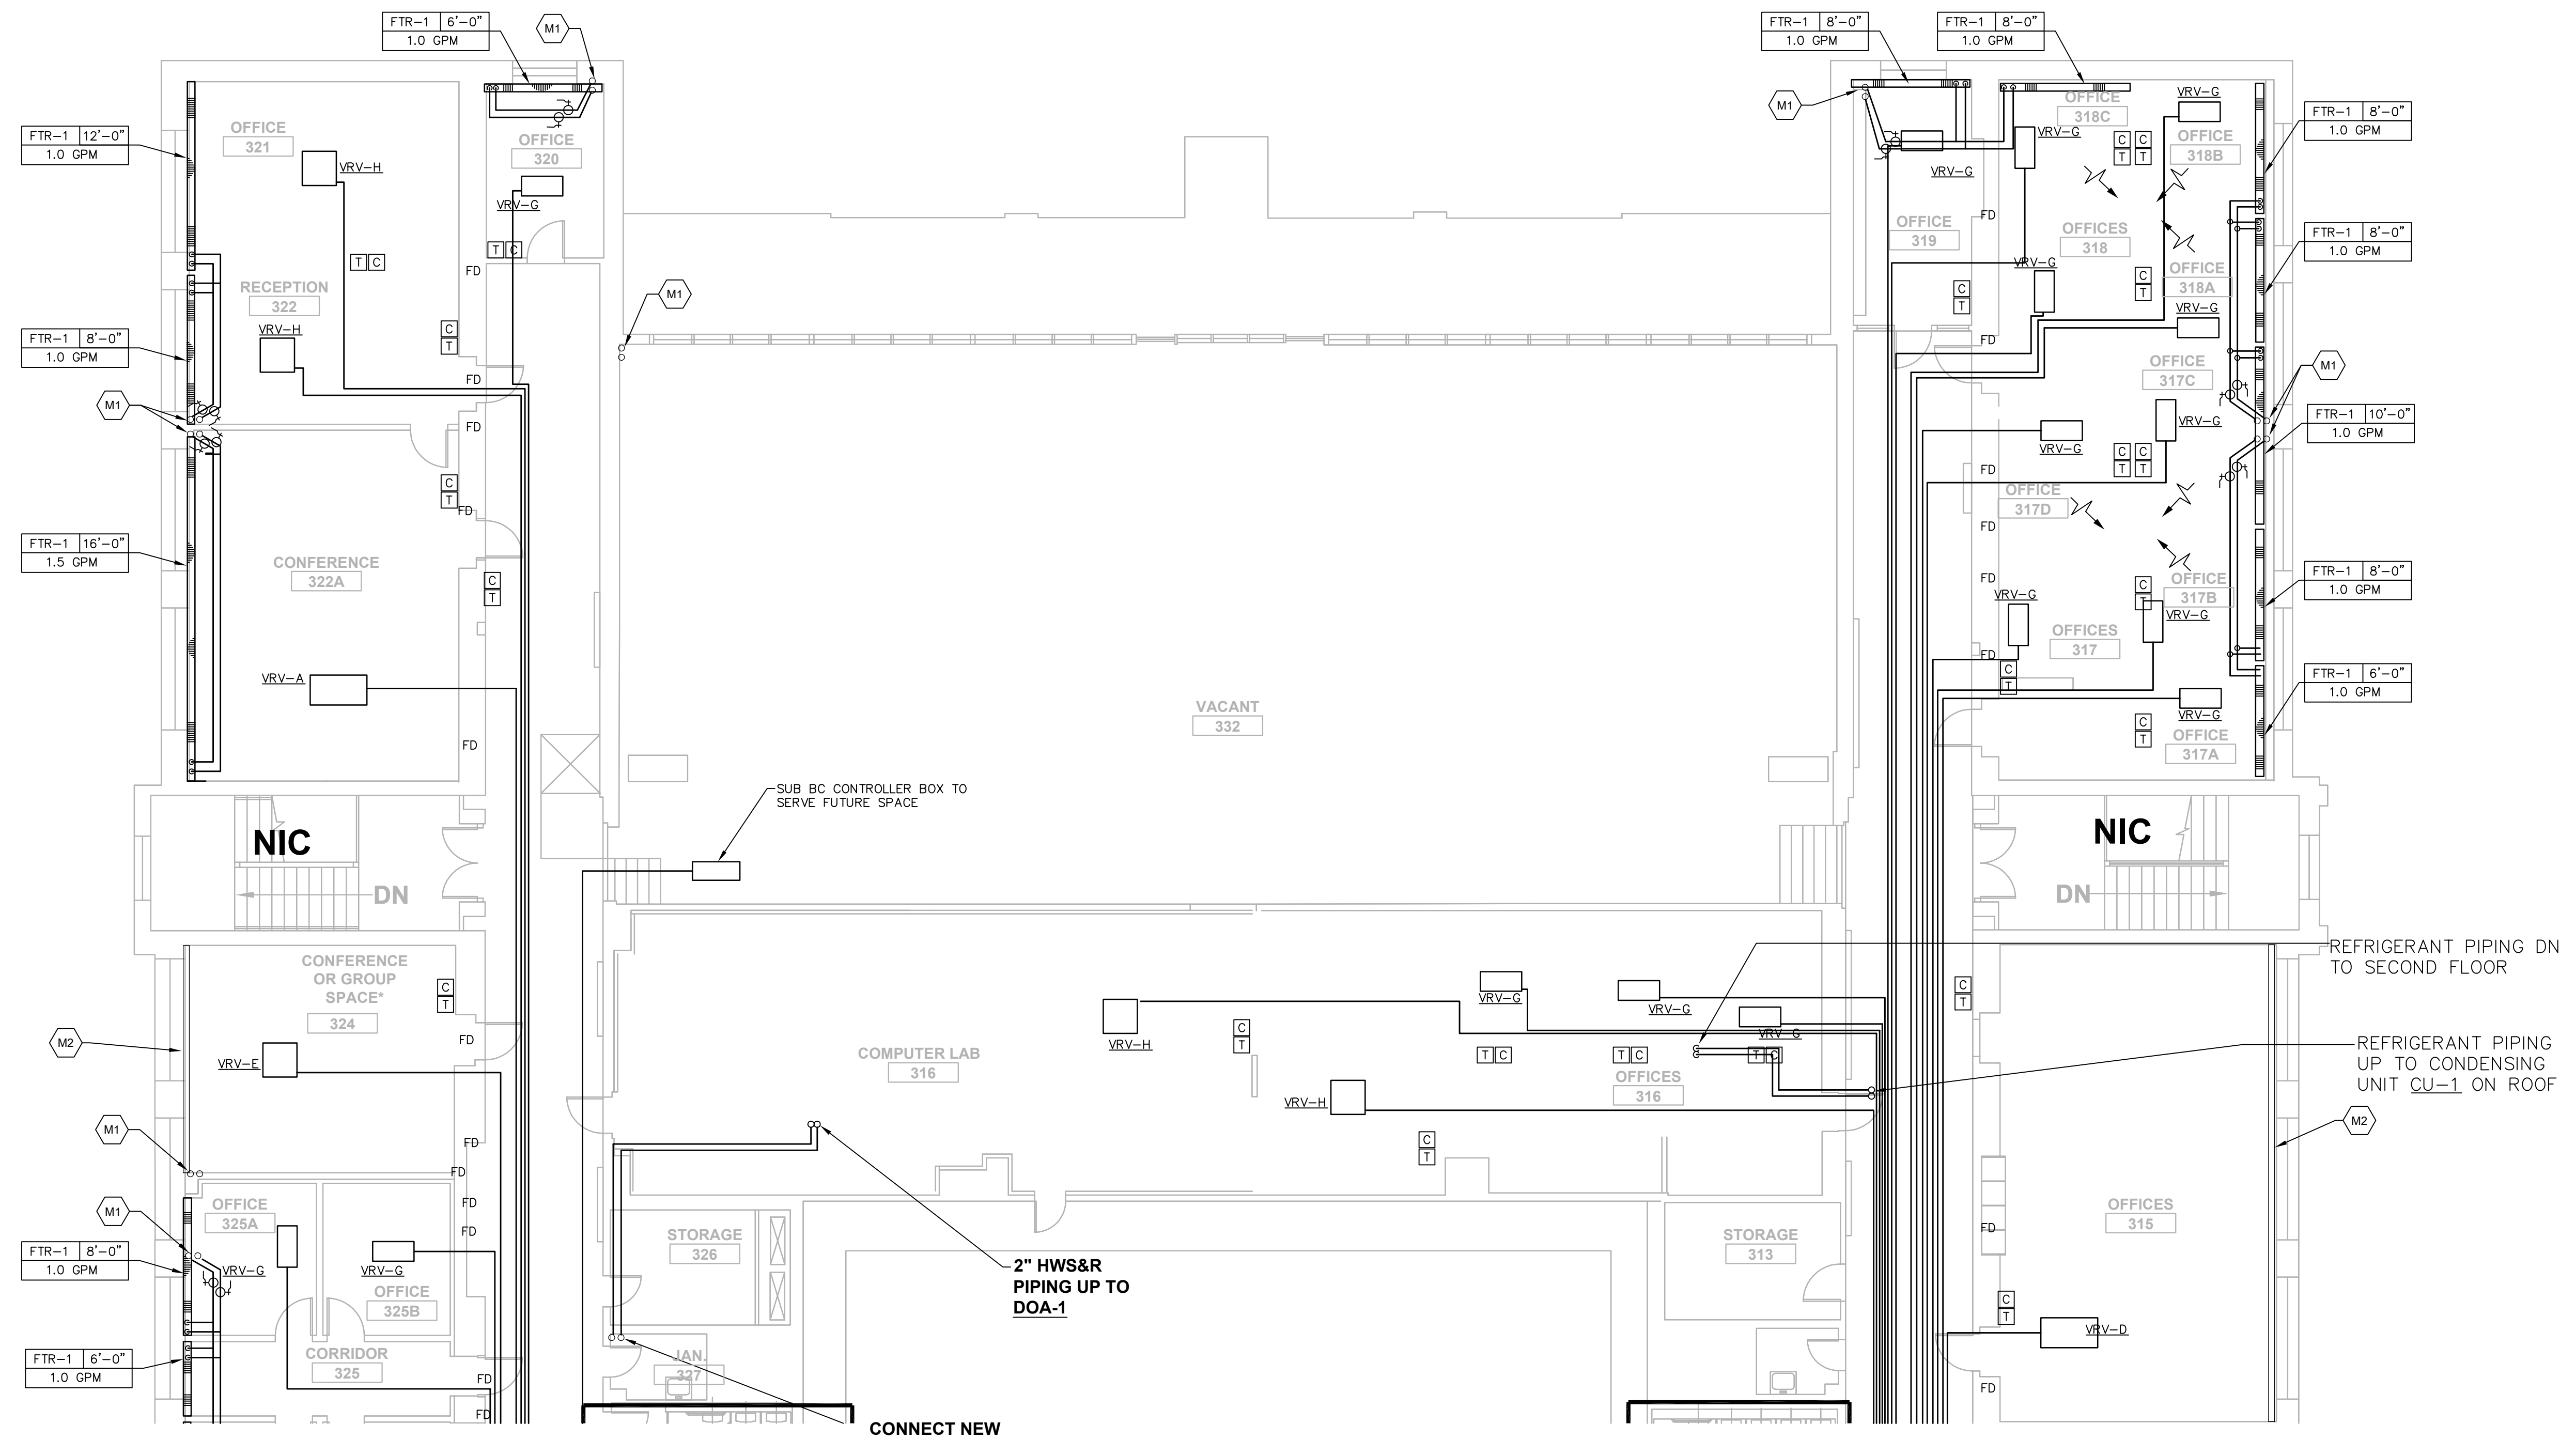1. FLEXIBLE CONNECTIONS TO DIFFUSERS SHALL NOT EXCEED 5'-0" IN LENGTH.
2. DUCTWORK AND PIPING LAYOUTS DO NOT SHOW ALL TRANSITIONS AND OFFSETS THAT WILL BE REQUIRED. PROVIDE COORDINATION DRAWINGS AND OFFSET DUCTWORK AND PIPING AS REQUIRED.
3. ALL PENETRATIONS THROUGH FULL HEIGHT CORRIDOR WALLS SHALL BE SEALED AND FIRESTOPPED.
4. FINNED TUBE RADIATION SHALL BE CONNECTED TO EXISTING HWS&R RISERS.
5. HOT WATER SUPPLY & RETURN BRANCH PIPING TO FINNED TUBE RADIATION SHALL BE MINIMUM 3/4" UNLESS NOTED OTHERWISE. PROVIDE TRANSITION AS REQUIRED FOR FINNED TUBE BASEBOARD RADIATION CONNECTIONS.
6. CLEAN INTERIOR OF ALL NEW DUCTWORK, REFER TO SPECIFICATIONS.
7. REFER TO SPECIFICATIONS FOR ADDITIONAL DETAILS ON GENERAL CONDITIONS, MATERIAL SPECIFICATIONS AND INSTALLATION.
8. PROVIDE CLEARANCE ADJACENT TO EQUIPMENT PER MANUFACTURER'S RECOMMENDATIONS AND AS REQUIRED TO PROPERLY MAINTAIN EQUIPMENT. PROVIDE MINIMUM 42" CLEARANCE IN FRONT OF EQUIPMENT, PIPE DROPS, ETC. CLEARANCES SHALL BE IDENTIFIED ON COORDINATION SHOP DRAWINGS.
9. PROVIDE VOLUME DAMPERS AT ALL BRANCH DUCTS SERVING RDG'S AND/OR VAV'S. PROVIDE 12x12 ACCESS DOORS AT ALL DAMPERS ABOVE HARD CEILINGS. COORDINATE WITH ARCHITECT'S PLAN FOR LOCATION.
10. SEE VAV SCHEDULE FOR DUCT INLET SIZE.
11. PROVIDE THERMOSTAT AND CARBON DIOXIDE SENSOR AT ALL ROOMS WITH A SUPPLY AIR VAV BOX TO COORDINATE WITH DEMAND CONTROL VENTILATION OPERATION.

| | | | |
|---|-------------|--|---|
| drawing title MECHANICAL THIRD FLOOR - NORTH PARTIAL PLAN | | STATE OF CONNECTICUT DEPARTMENT OF ADMINISTRATIVE SERVICES | |
| REVISIONS | | | |
| mark | date | description | drawing prepared by |
| | 8/4/17 | SCHEMATIC DESIGN SUBMISSION | CONSULTING ENGINEERING SERVICES, INC. 811 MIDDLE STREET MIDDLETOWN, CT |
| | 1/15/18 | DESIGN DEVELOPMENT SUBMISSION | |
| | 4/16/18 | CONSTRUCTION DOCUMENTS | project |
| | 5/23/18 | | WESTERN CT STATE UNIVERSITY |
| | 7/25/18 | | WHITE HALL |
| | 12/1/19 | | 2ND AND 3RD FLOOR RENOVATIONS |
| | | | DANBURY, CONNECTICUT |
| CAD no. | project no. | date | scale |
| xxxxxxx.dwg | BI-RD-299 | 07/25/18 | AS NOTED |
| | | drawn by | approved by |
| | | AJS | PMA |
| | | drawing no. | |
| | | | MP1.03 |

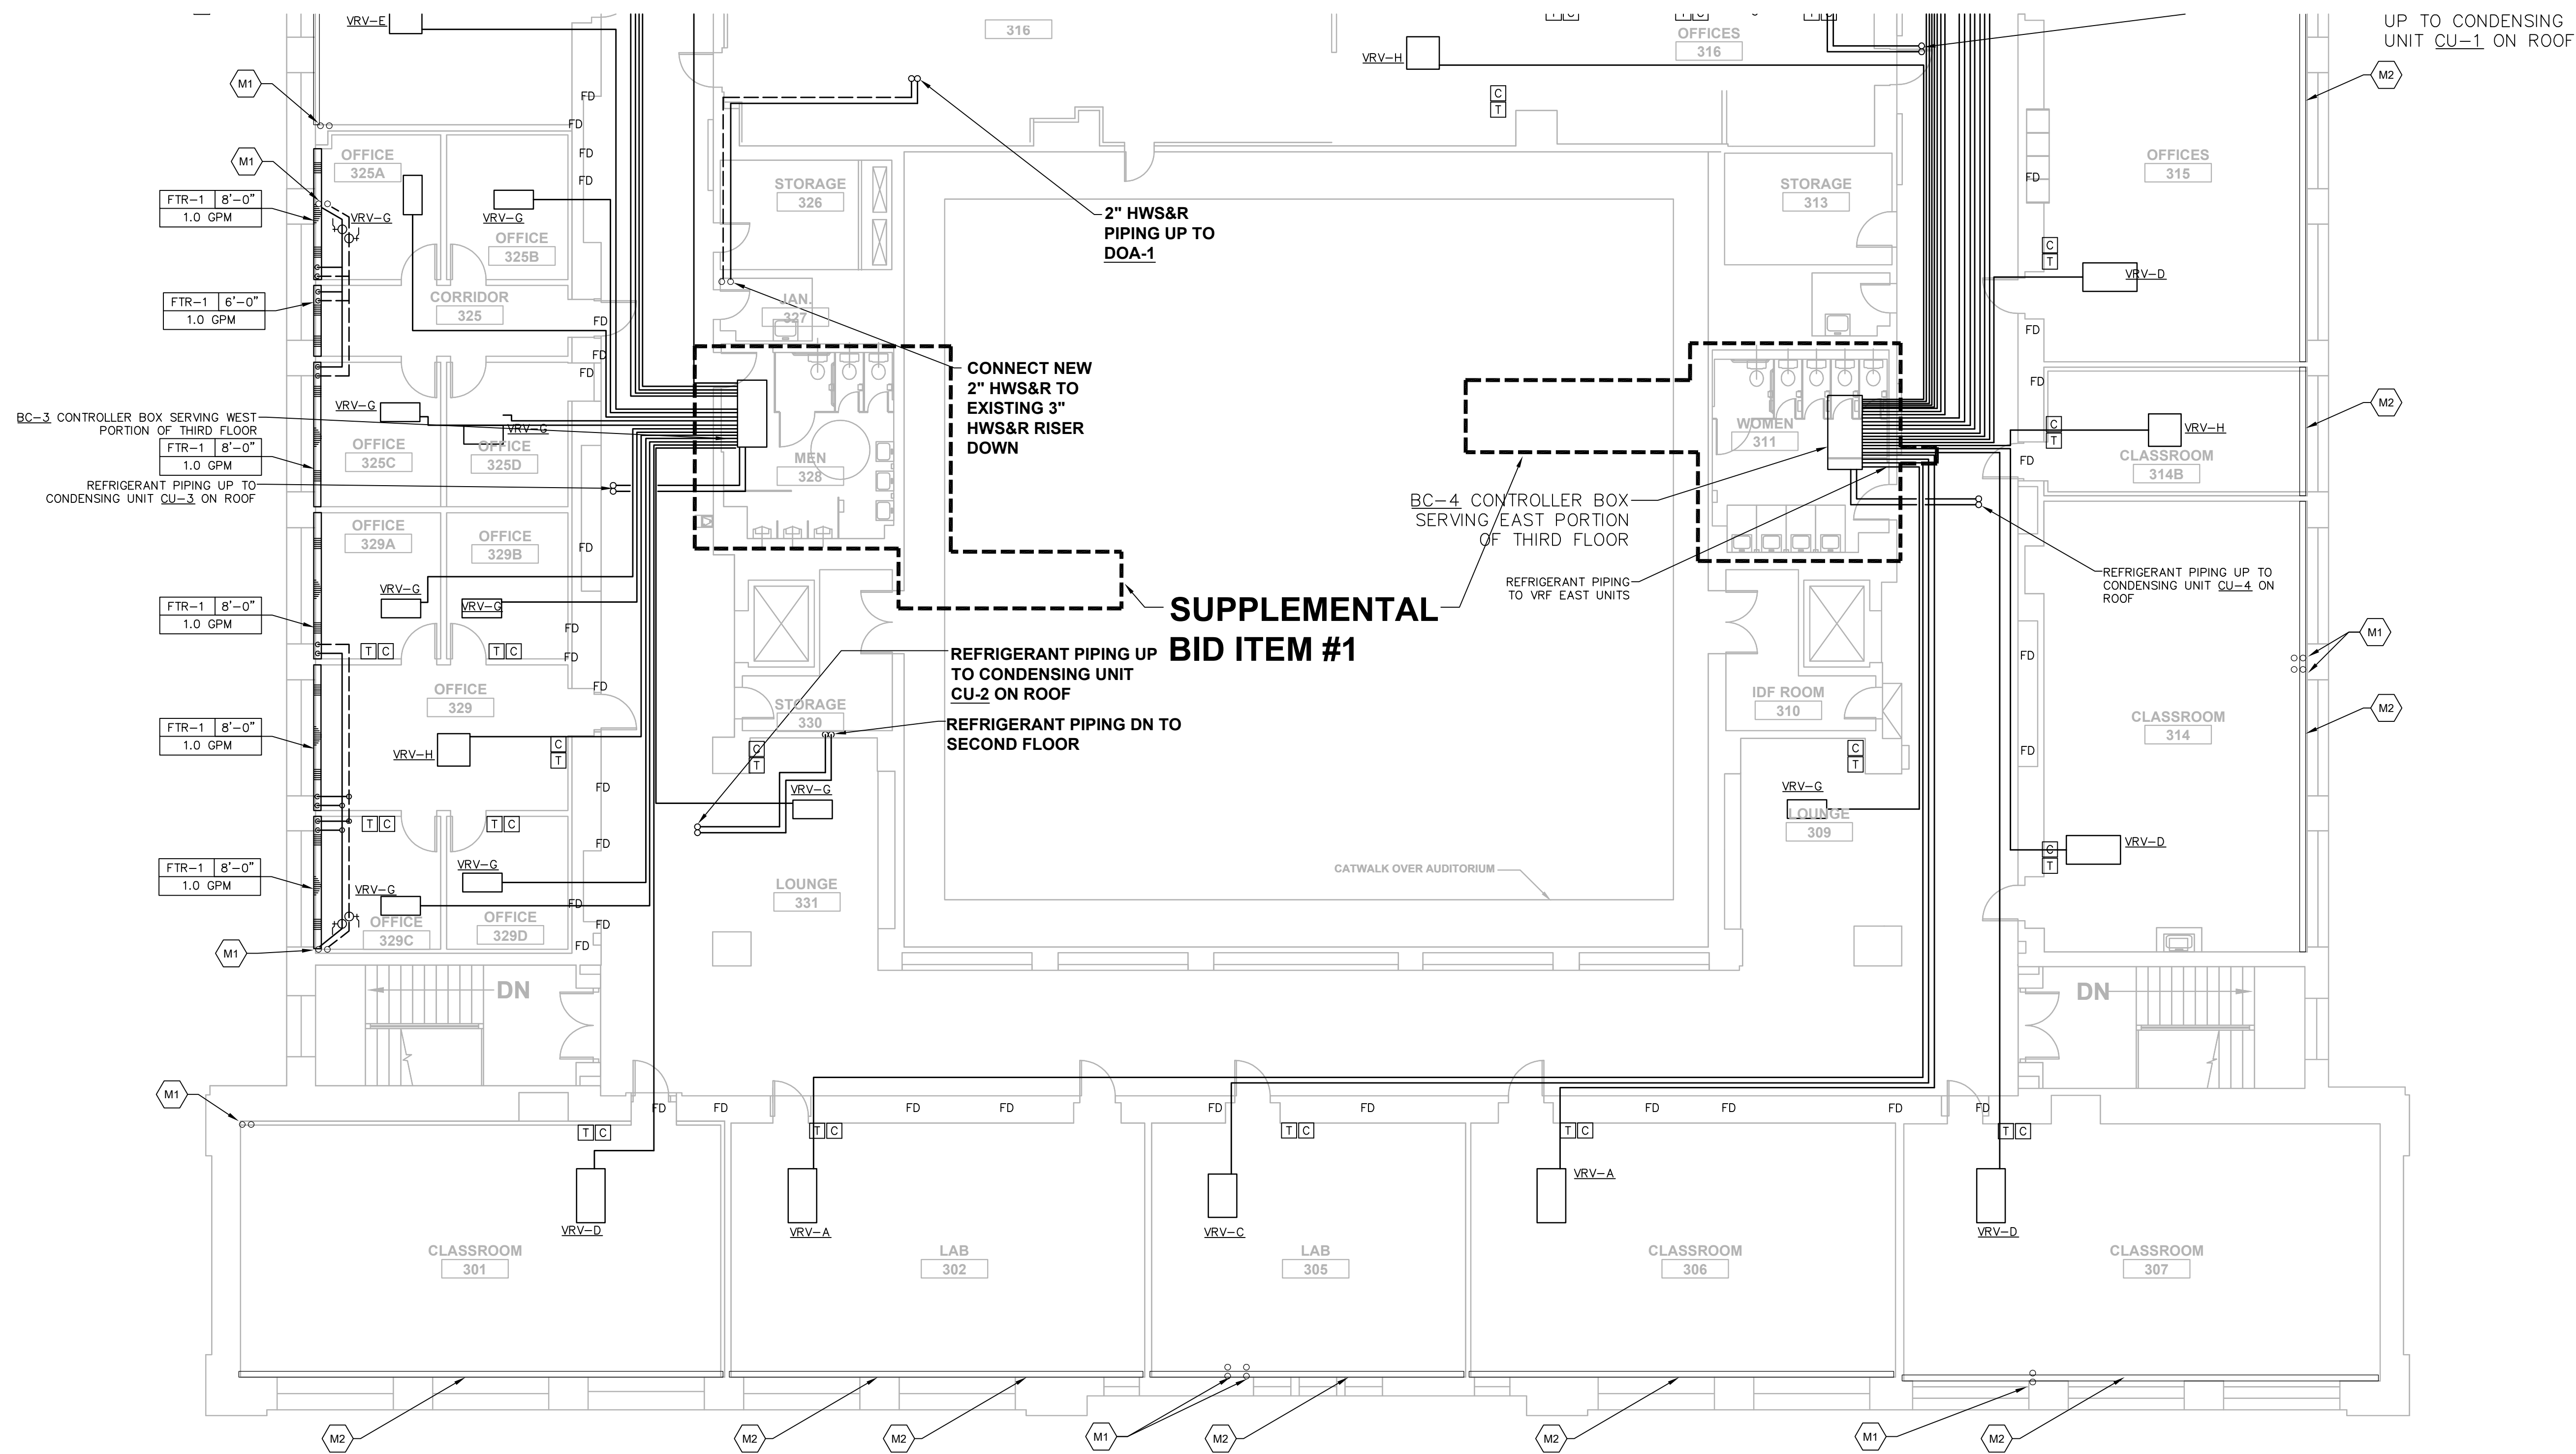

MECHANICAL KEY NOTES

- M1 CONNECT TO EXISTING HWS&R RISER.
- M2 EXISTING FIN TUBE RADIATION, PROVIDE NEW ENCLOSURE, ELECTRIC DDC CONTROL VALVE, ISOLATION VALVE, BALANCING VALVE AND STRAINER, NEW ENCLOSURE SHALL BE RITLING MODEL IBCHLS, DIMENSIONS 24" HIGH X 5-3/8" DEEP, LENGTH SHALL BE WALL TO WALL.

MECHANICAL NOTES

1. FLEXIBLE CONNECTIONS TO DIFFUSERS SHALL NOT EXCEED 5'-0" IN LENGTH.
2. DUCTWORK AND PIPING LAYOUTS DO NOT SHOW ALL TRANSITIONS AND OFFSETS THAT WILL BE REQUIRED, PROVIDE COORDINATION DRAWINGS AND OFFSET DUCTWORK AND PIPING AS REQUIRED.
3. ALL PENETRATIONS THROUGH FULL HEIGHT CORRIDOR WALLS SHALL BE SEALED AND FIRESTOPPED.
4. FINNED TUBE RADIATION SHALL BE CONNECTED TO EXISTING HWS&R RISERS.
5. HOT WATER SUPPLY & RETURN BRANCH PIPING TO FINNED TUBE RADIATION SHALL BE MINIMUM 3/4" UNLESS NOTED OTHERWISE. PROVIDE TRANSITION AS REQUIRED FOR FINNED TUBE BASEBOARD RADIATION CONNECTIONS.
6. CLEAN INTERIOR OF ALL NEW DUCTWORK, REFER TO SPECIFICATIONS.
7. REFER TO SPECIFICATIONS FOR ADDITIONAL DETAILS ON GENERAL CONDITIONS, MATERIAL SPECIFICATIONS AND INSTALLATION.
8. PROVIDE CLEARANCE ADJACENT TO EQUIPMENT PER MANUFACTURER'S RECOMMENDATIONS AND AS REQUIRED TO PROPERLY MAINTAIN EQUIPMENT. PROVIDE MINIMUM 42" CLEARANCE IN FRONT OF EQUIPMENT, PIPE DROPS, ETC. CLEARANCES SHALL BE IDENTIFIED ON COORDINATION SHOP DRAWINGS.
9. PROVIDE VOLUME DAMPERS AT ALL BRANCH DUCTS SERVING RDG'S AND/OR VAV'S. PROVIDE 12X12 ACCESS DOORS AT ALL DAMPERS ABOVE HARD CEILINGS, COORDINATE WITH ARCHITECT'S PLAN FOR LOCATION.
10. SEE VAV SCHEDULE FOR DUCT INLET SIZE.
11. PROVIDE THERMOSTAT AND CARBON DIOXIDE SENSOR AT ALL ROOMS WITH A SUPPLY AIR VAV BOX TO COORDINATE WITH DEMAND CONTROL VENTILATION OPERATION.

| | | | | | |
|---|---------|-------------------------------|--|-------|----------|
| drawing title MECHANICAL PIPING THIRD FLOOR - SOUTH PARTIAL PLAN | | | STATE OF CONNECTICUT DEPARTMENT OF ADMINISTRATIVE SERVICES | | |
| REVISIONS | | | drawing prepared by CONSULTING ENGINEERING SERVICES, INC. 811 MIDDLE STREET MIDDLETOWN, CT | | |
| mark | date | description | date | scale | AS NOTED |
| | 8/4/17 | SCHEMATIC DESIGN SUBMISSION | 07/25/18 | | |
| | 1/15/18 | DESIGN DEVELOPMENT SUBMISSION | | | |
| | 4/16/18 | CONSTRUCTION DOCUMENTS | | | |
| | 5/23/18 | | | | |
| | 7/25/18 | | | | |
| | 1/21/19 | | | | |
| project WESTERN CT STATE UNIVERSITY WHITE HALL 2ND AND 3RD FLOOR RENOVATIONS DANBURY, CONNECTICUT | | | drawn by AJS approved by PMA drawing no. MP1.04 | | |
| CAD no. xxxxxxxxx.dwg | | | project no. 61-RD-299 | | |

DEDICATED OUTDOOR AIR UNIT W/ ENERGY RECOVERY SCHEDULE

Table with columns: SYMBOL, MANUFACTURER/MODEL NUMBER, LOCATION, UNIT SIZE, SUPPLY FAN DATA, VFD REQ'D, DX COIL DATA, HOT WATER HEATING COIL DATA, REHEAT DATA, RETURN/EXHAUST FAN DATA, ELECTRICAL, OPERATING WEIGHT, REMARKS.

- REMARKS:
1. SEE DETAIL ON 3/M3.01
2. PROVIDE NEMA COMPLIANT MOTORS
3. PROVIDE VFD FACTORY INSTALLED AND PREWIRED TO DISCONNECT. POWER AND CIRCUITING FOR VFD SHALL BE DONE AS PART OF WORK OF DIVISION 26.
4. PRE-FILTERS SHALL BE 2" PLEATED, 30% EFFICIENCY, UNIT FILTER 4" PLEATED - 85% EFFICIENCY-MERV 13.
5. FACE AND BYPASS SECTION SHALL BE INTERNAL CONFIGURATION.
6. PROVIDE WITH STAINLESS STEEL DRAIN PANS.
7. STARTER AND DISCONNECTS FURNISHED BY DIV. 23 AND WIRED BY DIV. 26.
8. AIR HANDLING PERFORMANCE DATA IN ACCORDANCE WITH ARI 430
9. PROVIDE 14" CURB, AUX BOB 2" VIBRATION ISOLATION BY KCC INTERNATIONAL.
13. 100% OUTSIDE AIR UNIT WITH ROTARY TYPE TOTAL HEAT RECOVERY WHEEL (ENTHALPY)
14. SEE ENERGY RECOVERY WHEEL SCHEDULE THIS SHEET FOR ENERGY RECOVERY WHEEL PERFORMANCE
15. PROVIDE RETURN AIR BYPASS DAMPER, OUTSIDE AIR DAMPER, AND EXHAUST AIR DAMPER.
16. UNIT SHALL BE SUPPLIED WITH DDC CONTROLS & END DEVICES FROM TEMPERATURE CONTROL CONTRACTOR.
17. PROVIDE HOT GAS REHEAT COIL.

ENERGY RECOVERY SCHEDULE (INTEGRAL TO DOA-1)


Table with columns: GENERAL, PERFORMANCE - GENERAL, PERFORMANCE - WINTER, PERFORMANCE - SUMMER, ELECTRICAL.

VRV SYSTEM - INDOOR AIR HANDLER SCHEDULE

Table with columns: SYMBOL, MANUFACTURER, MODEL, TYPE, LOCATION, NOM. TONS, FAN, CAPACITIES, REFRIGERANT PIPING FROM BC CONTROLLER TO AIR HANDLER, ELECTRICAL, SOUND (DB) @MED, REMARKS.

- TYPE:
A. 4-WAY CEILING RECESSED CASSETTE.
B. HIGH WALL.
C. CEILING SUSPENDED.
D. DUCTED CONCEALED.
E. ONE-WAY CEILING RECESSED CASSETTE.


- REMARKS:
1. COOLING CAPACITY AT 80° EDB, 67° EWB, & 95° ODB. HEATING CAPACITY AT 70° EDB, 47° ODB & 43° OWB.
2. FURNISH AND INSTALL MANUFACTURER'S WIRE REMOTE TEMPERATURE SENSOR.
3. FURNISH AND INSTALL ALL CONTROL WIRING NECESSARY FROM OUTDOOR UNIT, INDOOR UNIT, AND ALL OTHER CONTROLS ASSOCIATED WITH SYSTEM.
4. PROVIDED WITH INTERNAL CONDENSATE PUMP.

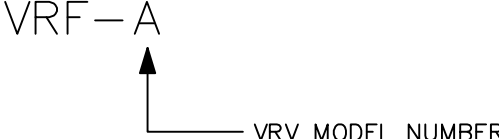

DIFFUSER AND REGISTER SCHEDULE

Table with columns: SYMBOL, MANUFACTURER/MODEL NUMBER, DUTY, TYPE, BORDER TYPE, CONSTRUCTION, MAX NC, REMARKS.

- TYPES:
DD - DIRECTIONAL DIFFUSER
HD - HEAVY DUTY
LF - LOUVERED FACE
LD - LINEAR DIFFUSER
DR - DRUM LOUVER
FR - FACTORY PROVIDED FILTER FRAMING
INDICATES DIFFUSER

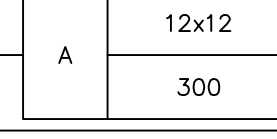

- REMARKS:
1. SQUARE TO ROUND TRANSITION. ALSO SEE FLEXIBLE DUCT SCHEDULE.
2. PROVIDE 24X24 PANEL FOR ACOUSTIC CEILING TILE APPLICATION; PROVIDE SURFACE MOUNT FOR GYPSUM OR PLASTER CEILING APPLICATION.
3. 6" NECK = 6X6 NECK SIZE APPLICATION; 8" NECK = 9X9 NECK SIZE APPLICATION; 12" NECK = 12X12 NECK SIZE APPLICATION; 14" NECK = 15X15 NECK SIZE APPLICATION, 16" NECK = 18X18 NECK SIZE APPLICATION.
4. PROVIDE DOUBLE DEFLECTION WITH 0.75" GRILLE SPACING.
5. 4 FT LONG HORIZONTAL THROW LINEAR DIFFUSER WITH TWO (2) SLOT. EACH SLOT IS 1.5" WIDE. PROVIDE WITH FACTORY FURNISHED PLENUM WITH 8" INLET.
6. 4 FT LONG HORIZONTAL THROW LINEAR DIFFUSER WITH TWO (2) SLOT. EACH SLOT IS 2.5" WIDE. PROVIDE WITH FACTORY FURNISHED PLENUM WITH 12" INLET.
7. PROVIDE LAY-IN FRAME FOR ACOUSTIC CEILING TILE APPLICATION; PROVIDE SURFACE MOUNTED FRAME FOR GYPSUM OR PLASTER CEILING APPLICATION.
8. PROVIDE WITH 35° DEFLECTION AND 0.75" GRILLE SPACING.
9. PROVIDE WITH FRAMING FOR A 2" FILTER.
10. PROVIDE 14 GAUGE HEAVY DUTY GRILL WITH 38° DEFLECTION AND 0.5" GRILLE SPACING.
11. PROVIDE WITH 1/4 TURN HINGED ACCESS.
12. 20x20 NECK SIZE INDICATED ON PLAN SHALL BE PROVIDED WITH EXTENDED FACE PANEL AS REQUIRED TO FIT IN 2FT X 2FT CEILING GRID. CUTTING OR MODIFYING CEILING TILE OR CEILING GRID WILL NOT BE ALLOWED.
13. 22x22 NECK SIZE INDICATED ON PLAN SHALL FIT IN 2FT X 2FT CEILING GRID. CUTTING OR MODIFYING CEILING TILE OR CEILING GRID WILL NOT BE ALLOWED.

VRV OUTDOOR CONDENSING UNIT SCHEDULE

Table with columns: SYMBOL, MANUFACTURER, MODEL, LOCATION, NOMINAL TONS, CAPACITIES, ELECTRICAL, WEIGHT (LBS), REMARKS, UNITS SERVED.

- REMARKS:
1. R410A REFRIGERANT. CAPACITY RATINGS AT ARI CONDITIONS. COOLING - 80° EDB, 67° EWB, 95° ODB. HEATING - 70° EDB, 47° ODB, 43° OWB.
2. DIVISION 26 TO PROVIDE DISCONNECT PER "a" MODULE AND "b" MODULE.
3. PROVIDE WITH ALL REQUIRED EQUIPMENT FOR LOW AMBIENT OPERATION.

VRV SYSTEM COOLING UNIT GENERAL NOTES


- A. FOR THE MAIN REFRIGERANT LINES FROM THE ROOFTOP HEAT PUMP UNITS TO THE BRANCH SELECTOR BOXES, EACH LINE ON PLAN REPRESENTS THREE LINES A LIQUID, HIGH PRESSURE GAS & LOW PRESSURE GAS REFRIGERANT PIPE. FOR THE BRANCH LINES FROM THE BRANCH SELECTOR BOX TO THE AIR HANDLERS, EACH LINE ON PLAN REPRESENTS TWO LINES A GAS & A LIQUID REFRIGERANT PIPE. FOR REFRIGERANT PIPE SIZES CONSULT MANUFACTURE, REFRIGERANT PIPE RISERS INCLUDED IN DRAWINGS SHALL BE REVIEWED AND CONFIRMED BY MANUFACTURE PRIOR TO PURCHASING ANY AND ALL EQUIPMENT.
B. A LOW VOLTAGE SOLID STATE MOISTURE SENSOR (DIVERSATECH MODEL WS-1). PROVIDE TRANSFORMER AS REQUIRED TO OPERATE THE MOISTURE SENSOR. CONNECT MOISTURE SENSOR TO ASSOCIATED AIR HANDLER INPUT. FOR AIR HANDLERS, UPON DETECTION OF MOISTURE BY THE MOISTURE SENSOR, THE RESPECTIVE SPLIT SYSTEM AIR HANDLER SHALL SHUT DOWN AND SHALL CAUSE AN ALARM CONDITION AT CENTRALIZED CONTROLLER. FOR SPLIT SYSTEM CONTROLLERS, UPON DETECTION OF MOISTURE BY THE MOISTURE SENSOR, THE RESPECTIVE HEAT PUMP SHALL SHUT DOWN AND SHALL CAUSE AN ALARM CONDITION. MOISTURE SENSOR SHALL BE INSTALLED IN THE EQUIPMENT SUPPLIED DRAIN PAN, LOCATED AT A POINT BETWEEN THE PRIMARY DRAIN LINE CONNECTION AND OVER FLOW LINE.
C. PROVIDE SPLIT SYSTEM REFRIGERANT PIPING BETWEEN THE INDOOR UNIT, BRANCH SELECTOR BOX AND THE OUTDOOR UNIT, INSTALL PER MANUFACTURERS INSTRUCTIONS.
D. PROVIDE BACnet GATEWAY OR APPROVED EQUAL. GATEWAY SHALL BE USED FOR INTEGRATION OF VRV SYSTEM TO BUILDING AUTOMATION SYSTEM.
E. SYSTEM SHALL BE PROVIDED WITH MANUFACTURER START-UP AND FULL DAY OF TRAINING (8 HOURS, TO TAKE PLACE OVER TWO DAYS).

BRANCH CONTROLLER BOX SCHEDULE


Table with columns: SYMBOL, MANUFACTURER, MODEL, LIQUID (BC TO CU), SUCTION (BC TO CU), MAXIMUM INDOOR UNITS SERVED, WEIGHT (LBS), ELECTRICAL, REMARKS/ASSOCIATED CONDENSING UNIT.

- REMARKS:
1. PROVIDE INSULATED FULL PORT BALL VALVES AND SHRAEDER CONNECTION ON ALL PORTS, INCLUDING SPARE PORTS.


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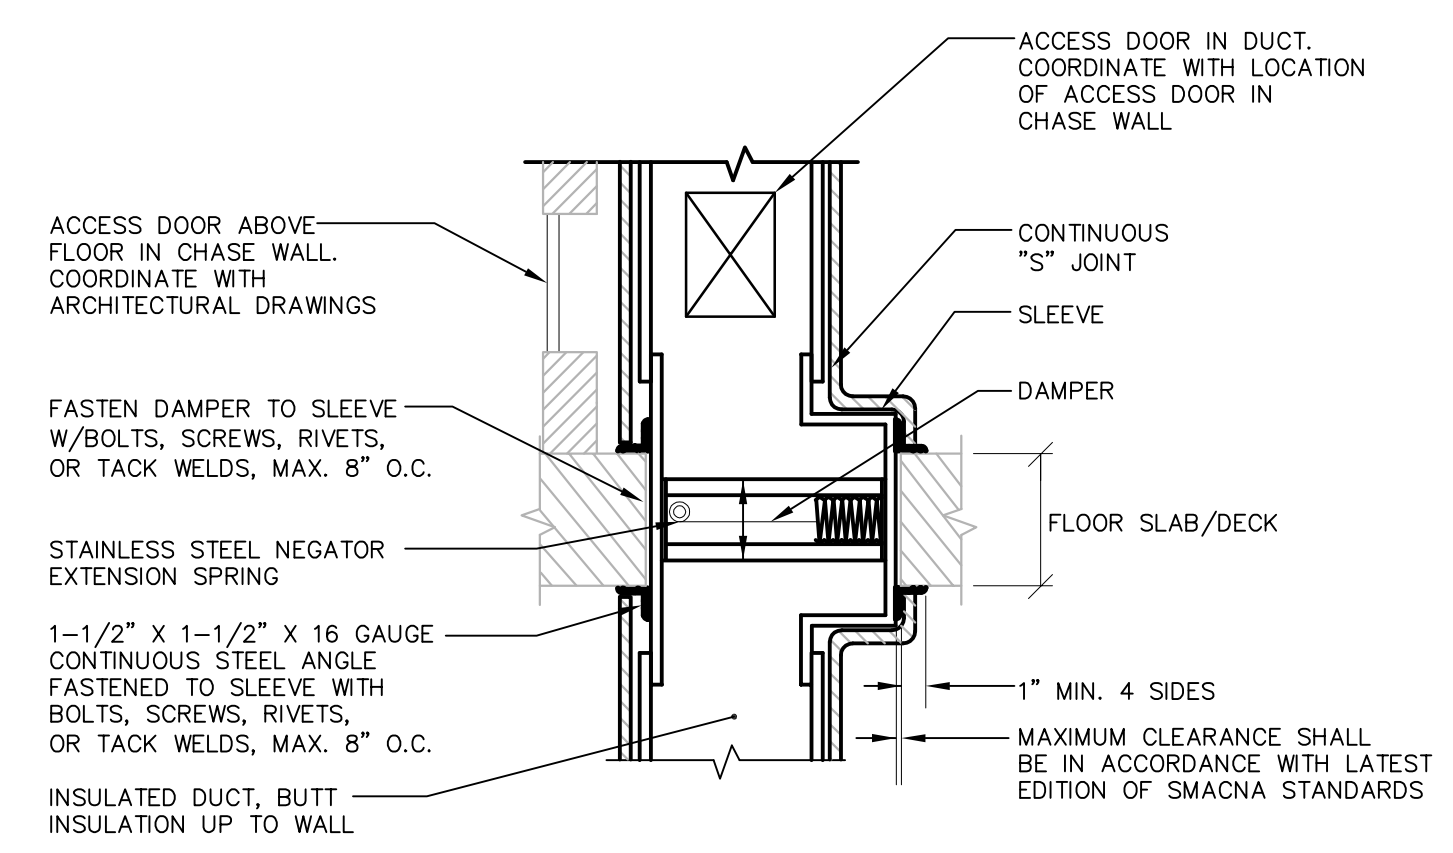
1 TYPICAL DUCT DETAILS
N.T.S.

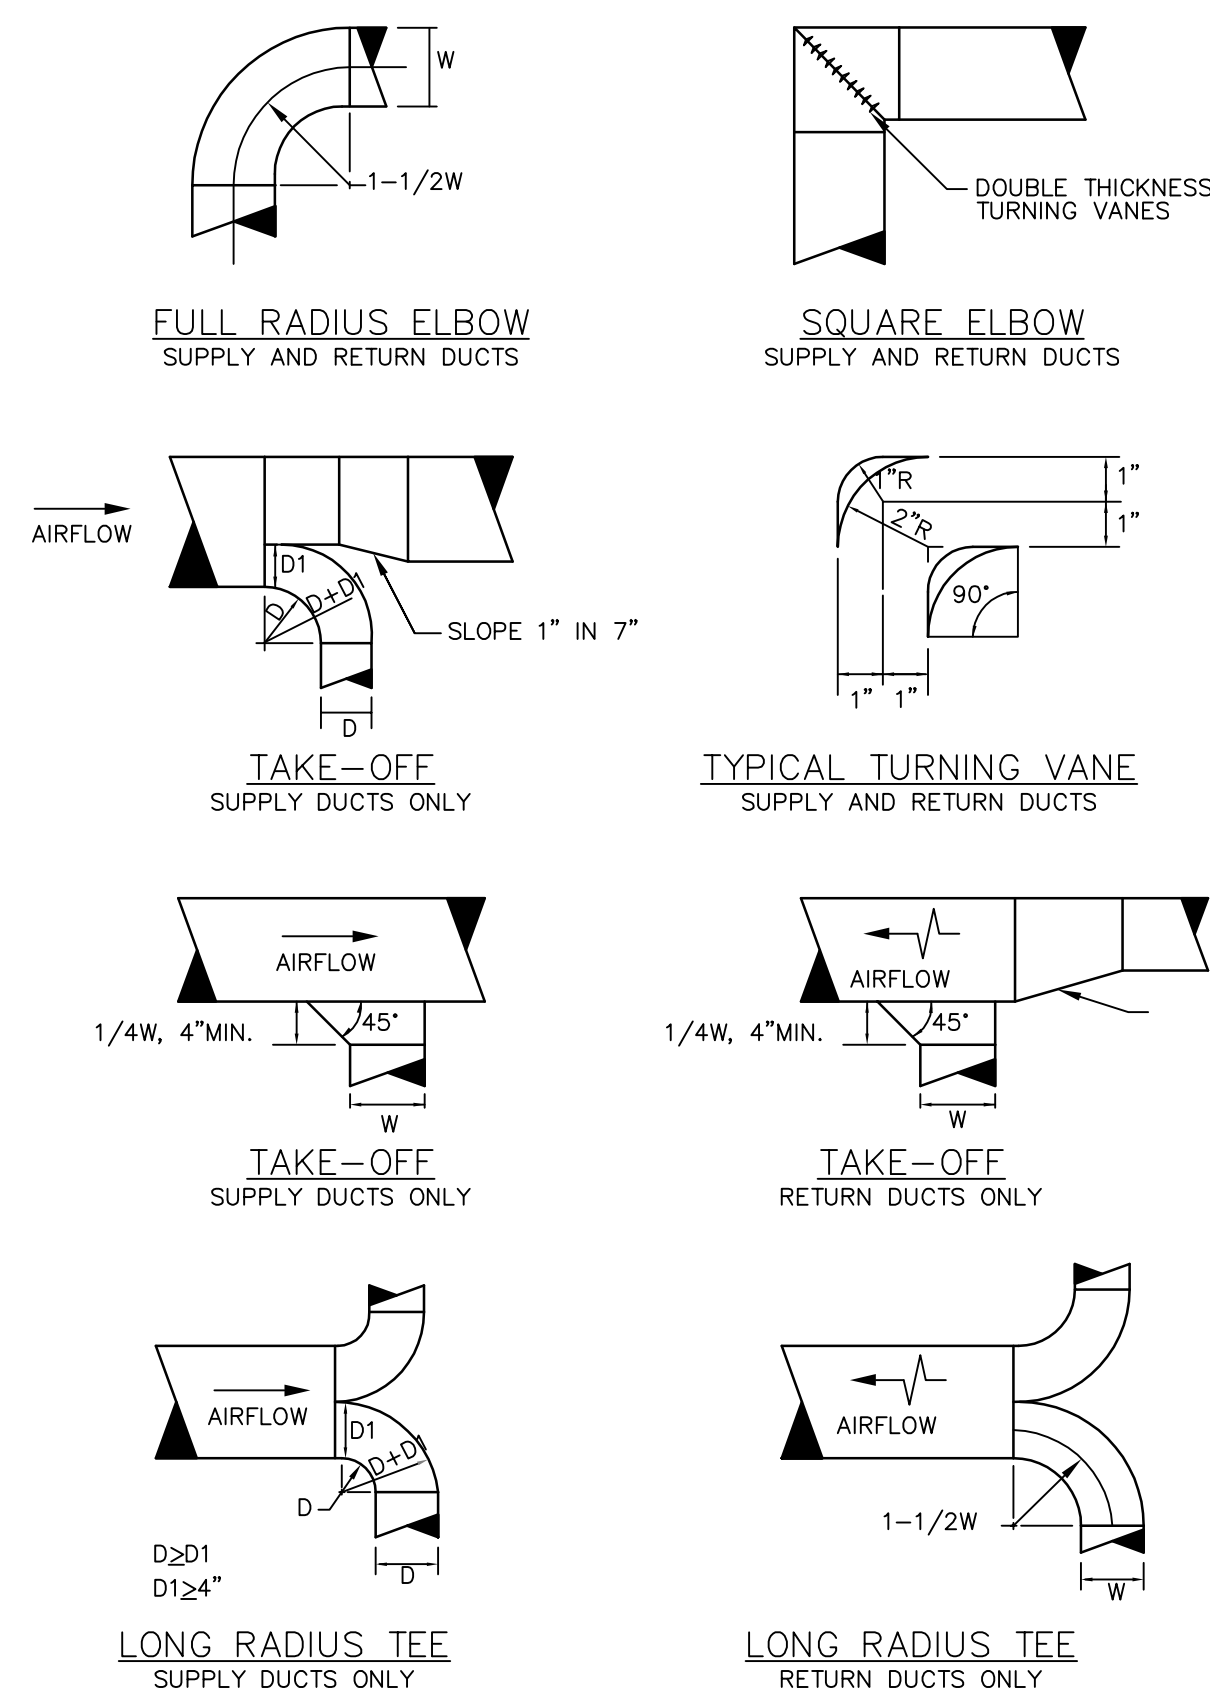

2 AHU/DOAS WATER COIL PIPING DIAGRAM
N.T.S.

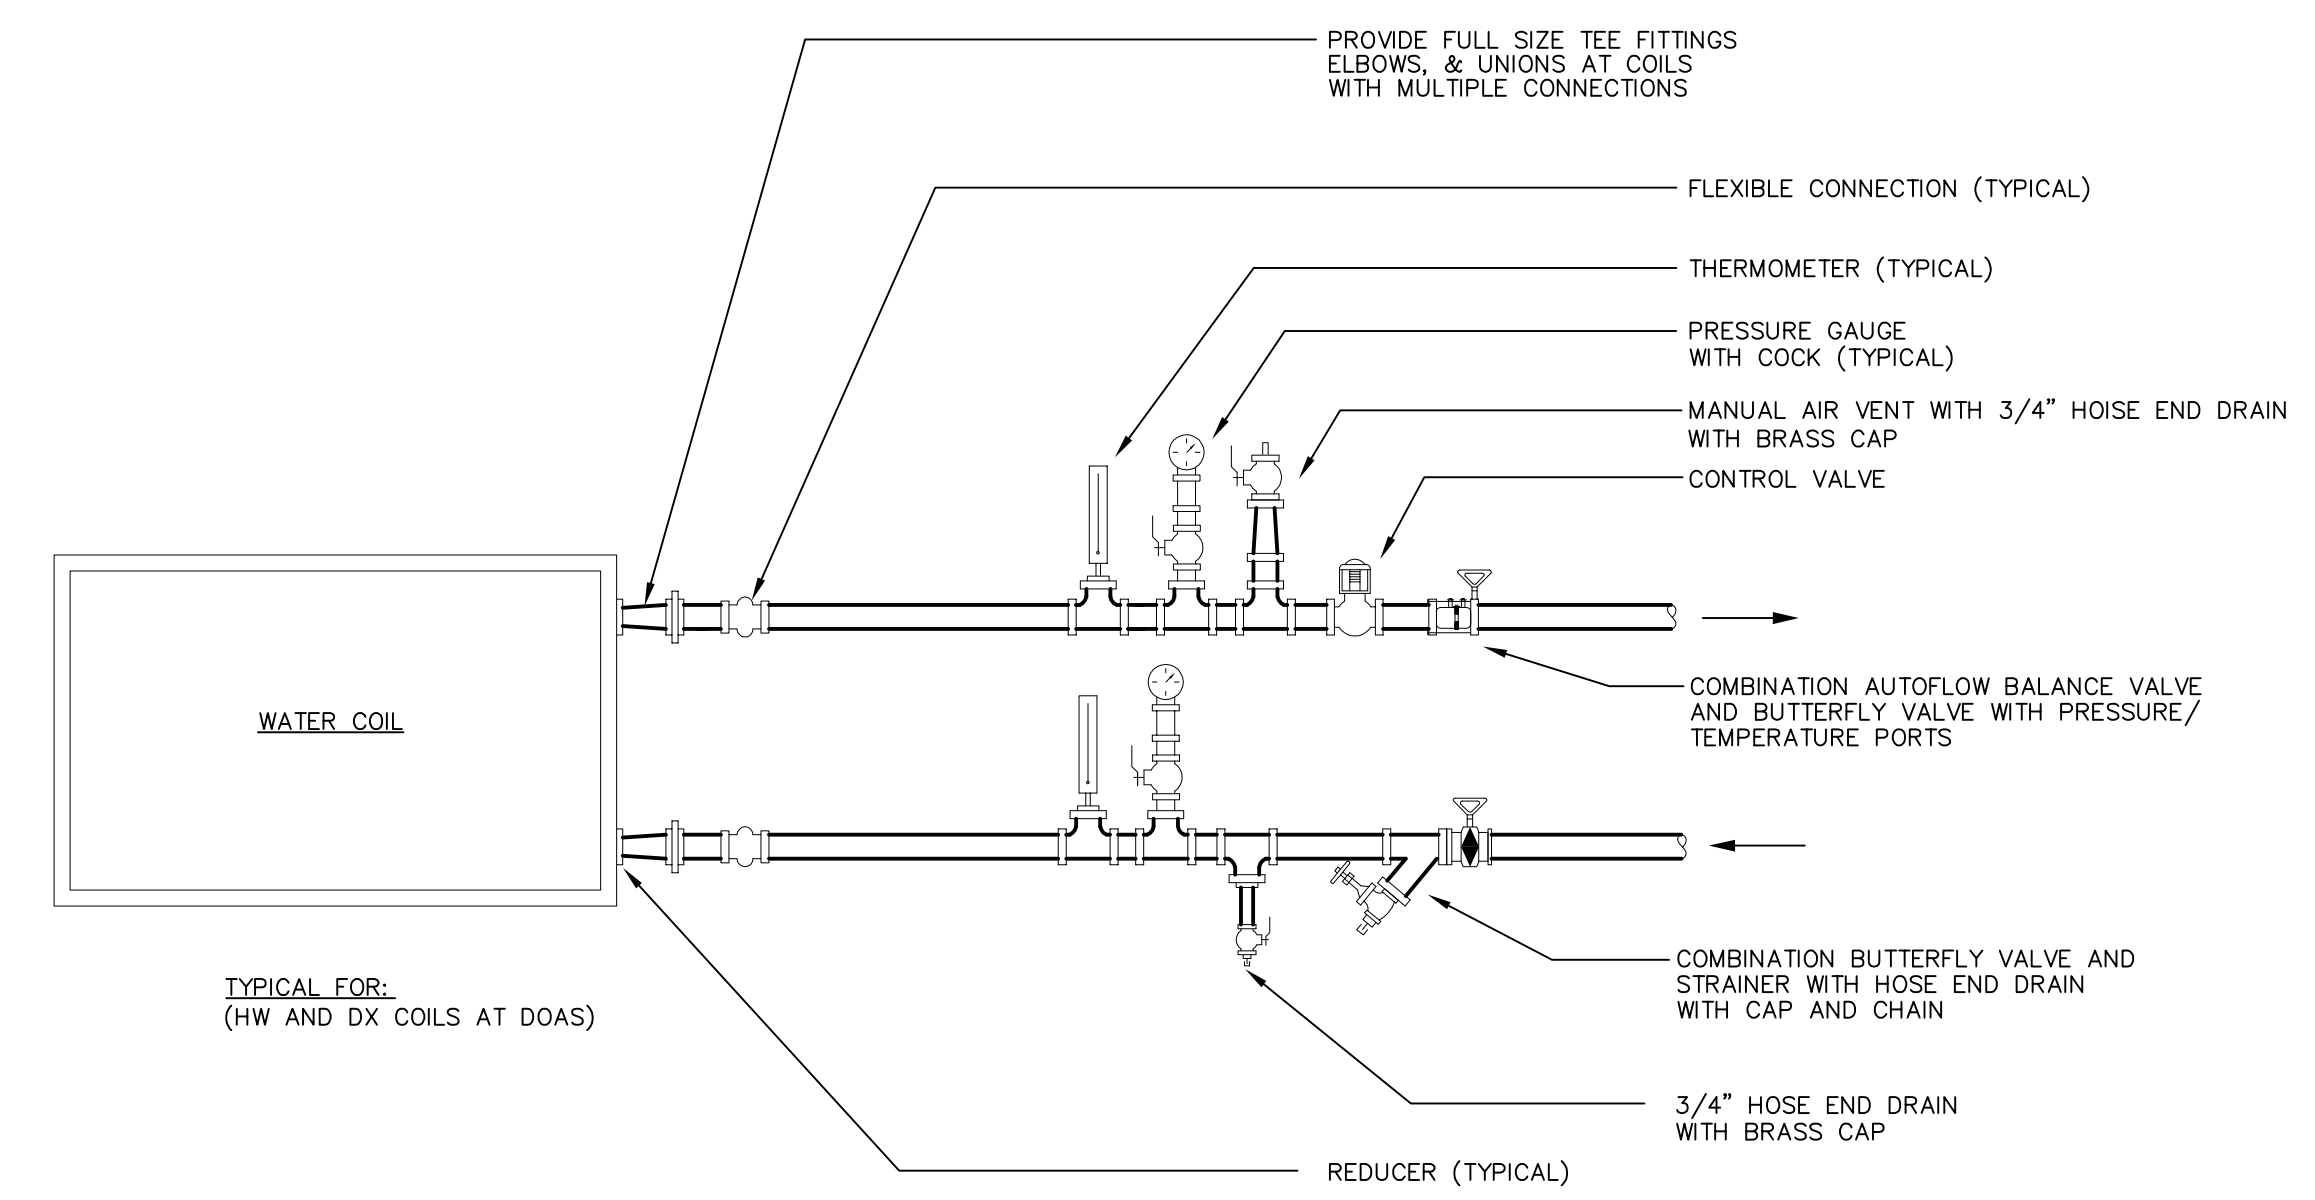


3 DEDICATED OUTDOOR AIR UNIT DETAIL
N.T.S.

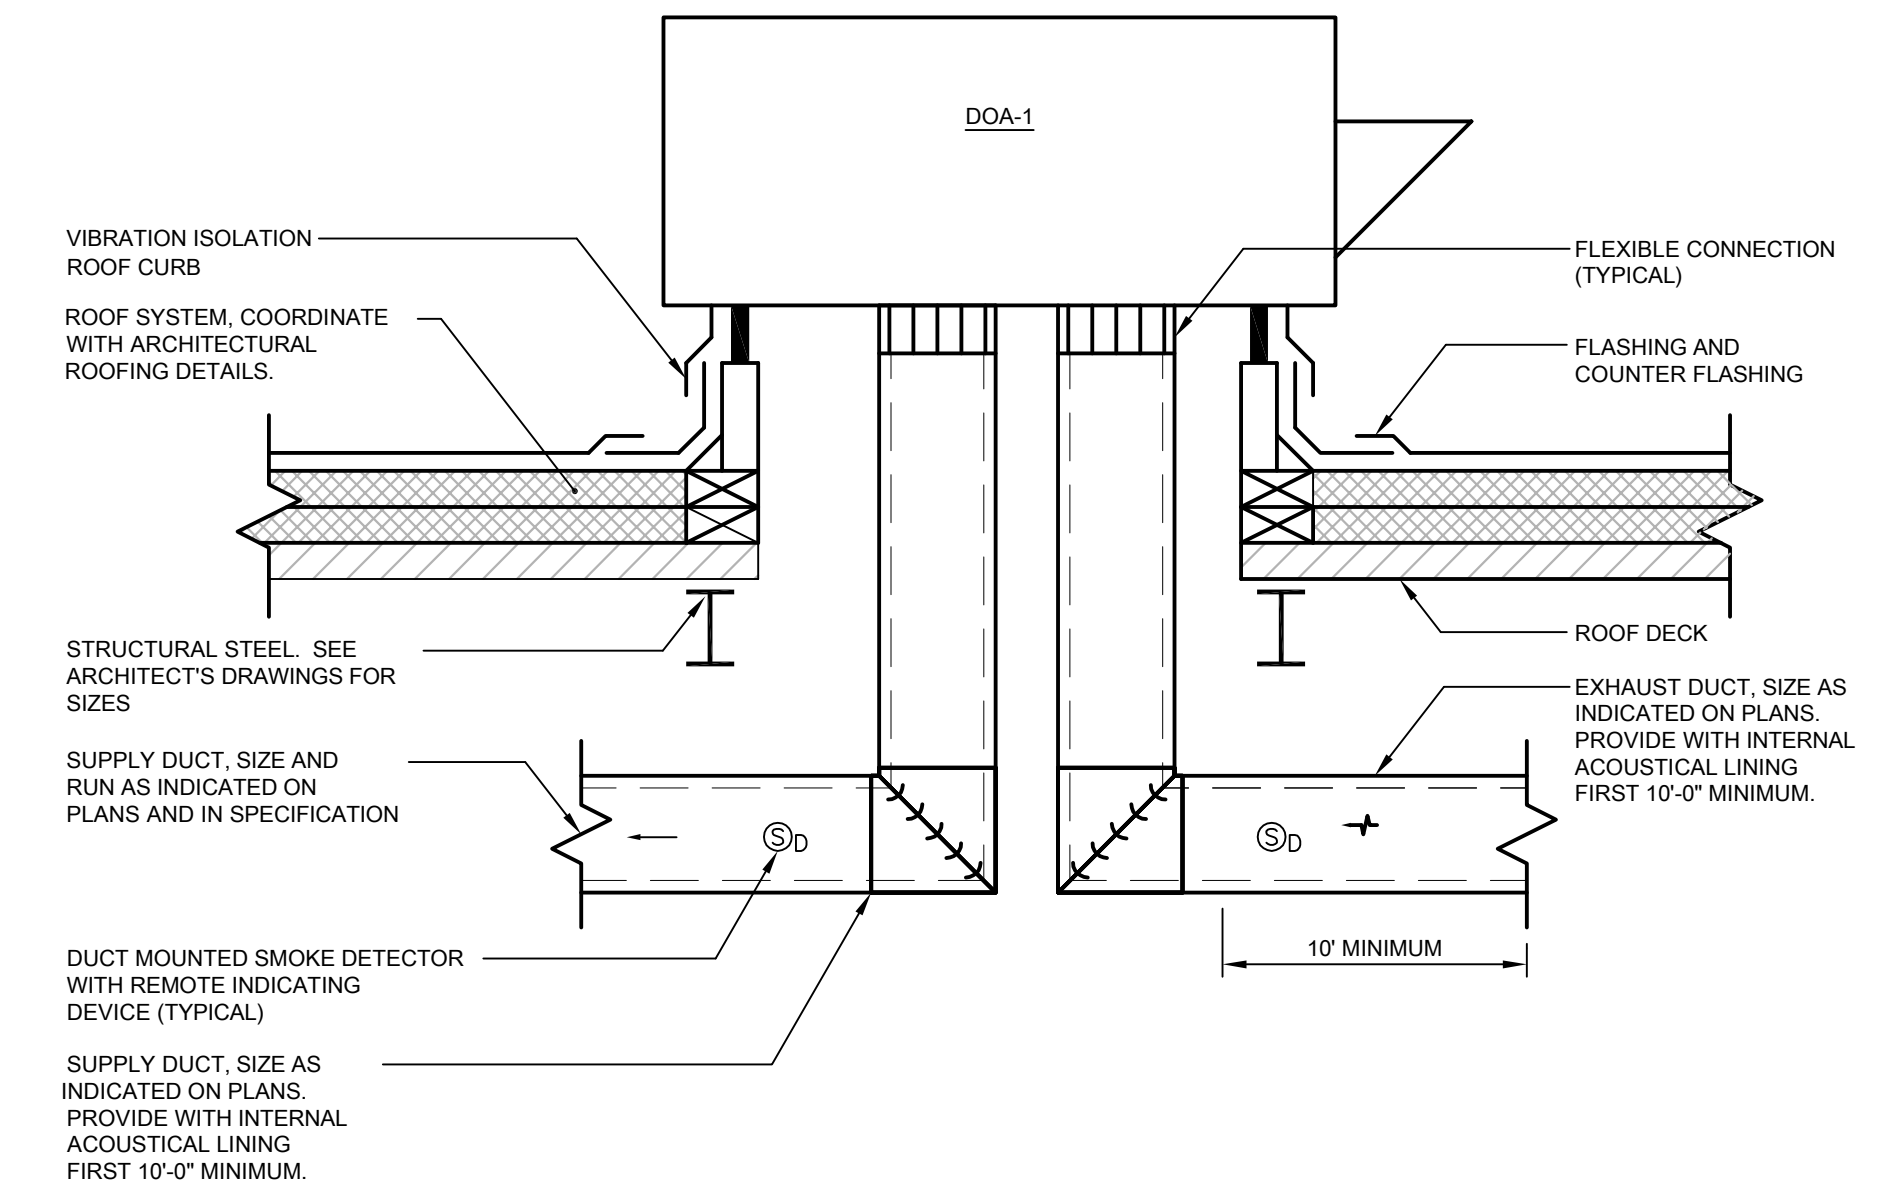


- NOTES:
- DAMPER STYLE & SLEEVE CONFIGURATION IS GOVERNED BY MAINTAINING A MAX. .06 STATIC PRESSURE @ 2500 F.P.M. FACE VELOCITY.
 - DEPTH OF DAMPER TO BE COORDINATED WITH WALL THICKNESS.
 - INSTALLATIONS & MATERIALS PER U.L. 555.
 - DETAIL FOR DAMPER IN FIRE RATED WALL SIMILAR EXCEPT ACCESS TO BE THROUGH CEILING.

4 VERTICAL FIRE DAMPER DETAIL
N.T.S.

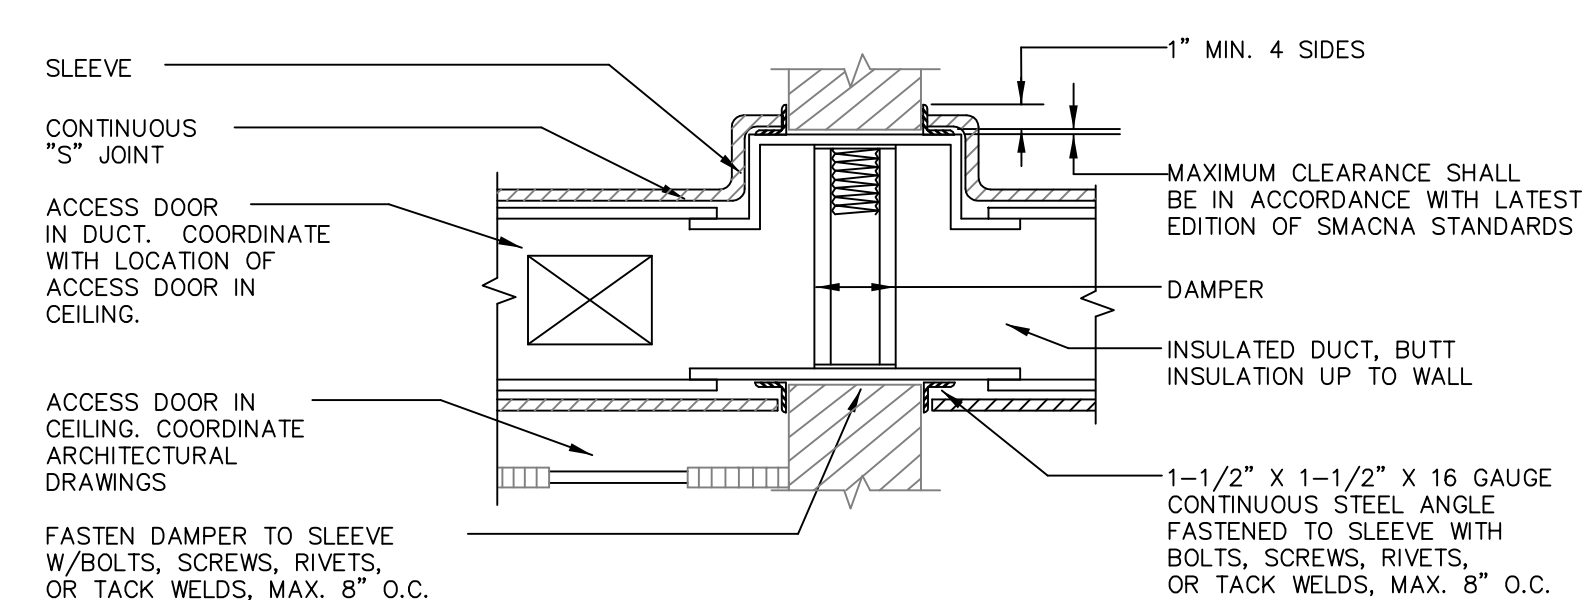

- NOTES:
- DAMPER STYLE & SLEEVE CONFIGURATION IS GOVERNED BY MAINTAINING A MAX. .06 STATIC PRESSURE @ 2500 F.P.M. FACE VELOCITY.
 - DEPTH OF DAMPER TO BE COORDINATED WITH WALL THICKNESS.
 - INSTALLATIONS & MATERIALS PER U.L. 555.


5 HORIZONTAL FIRE DAMPER DETAIL
N.T.S.

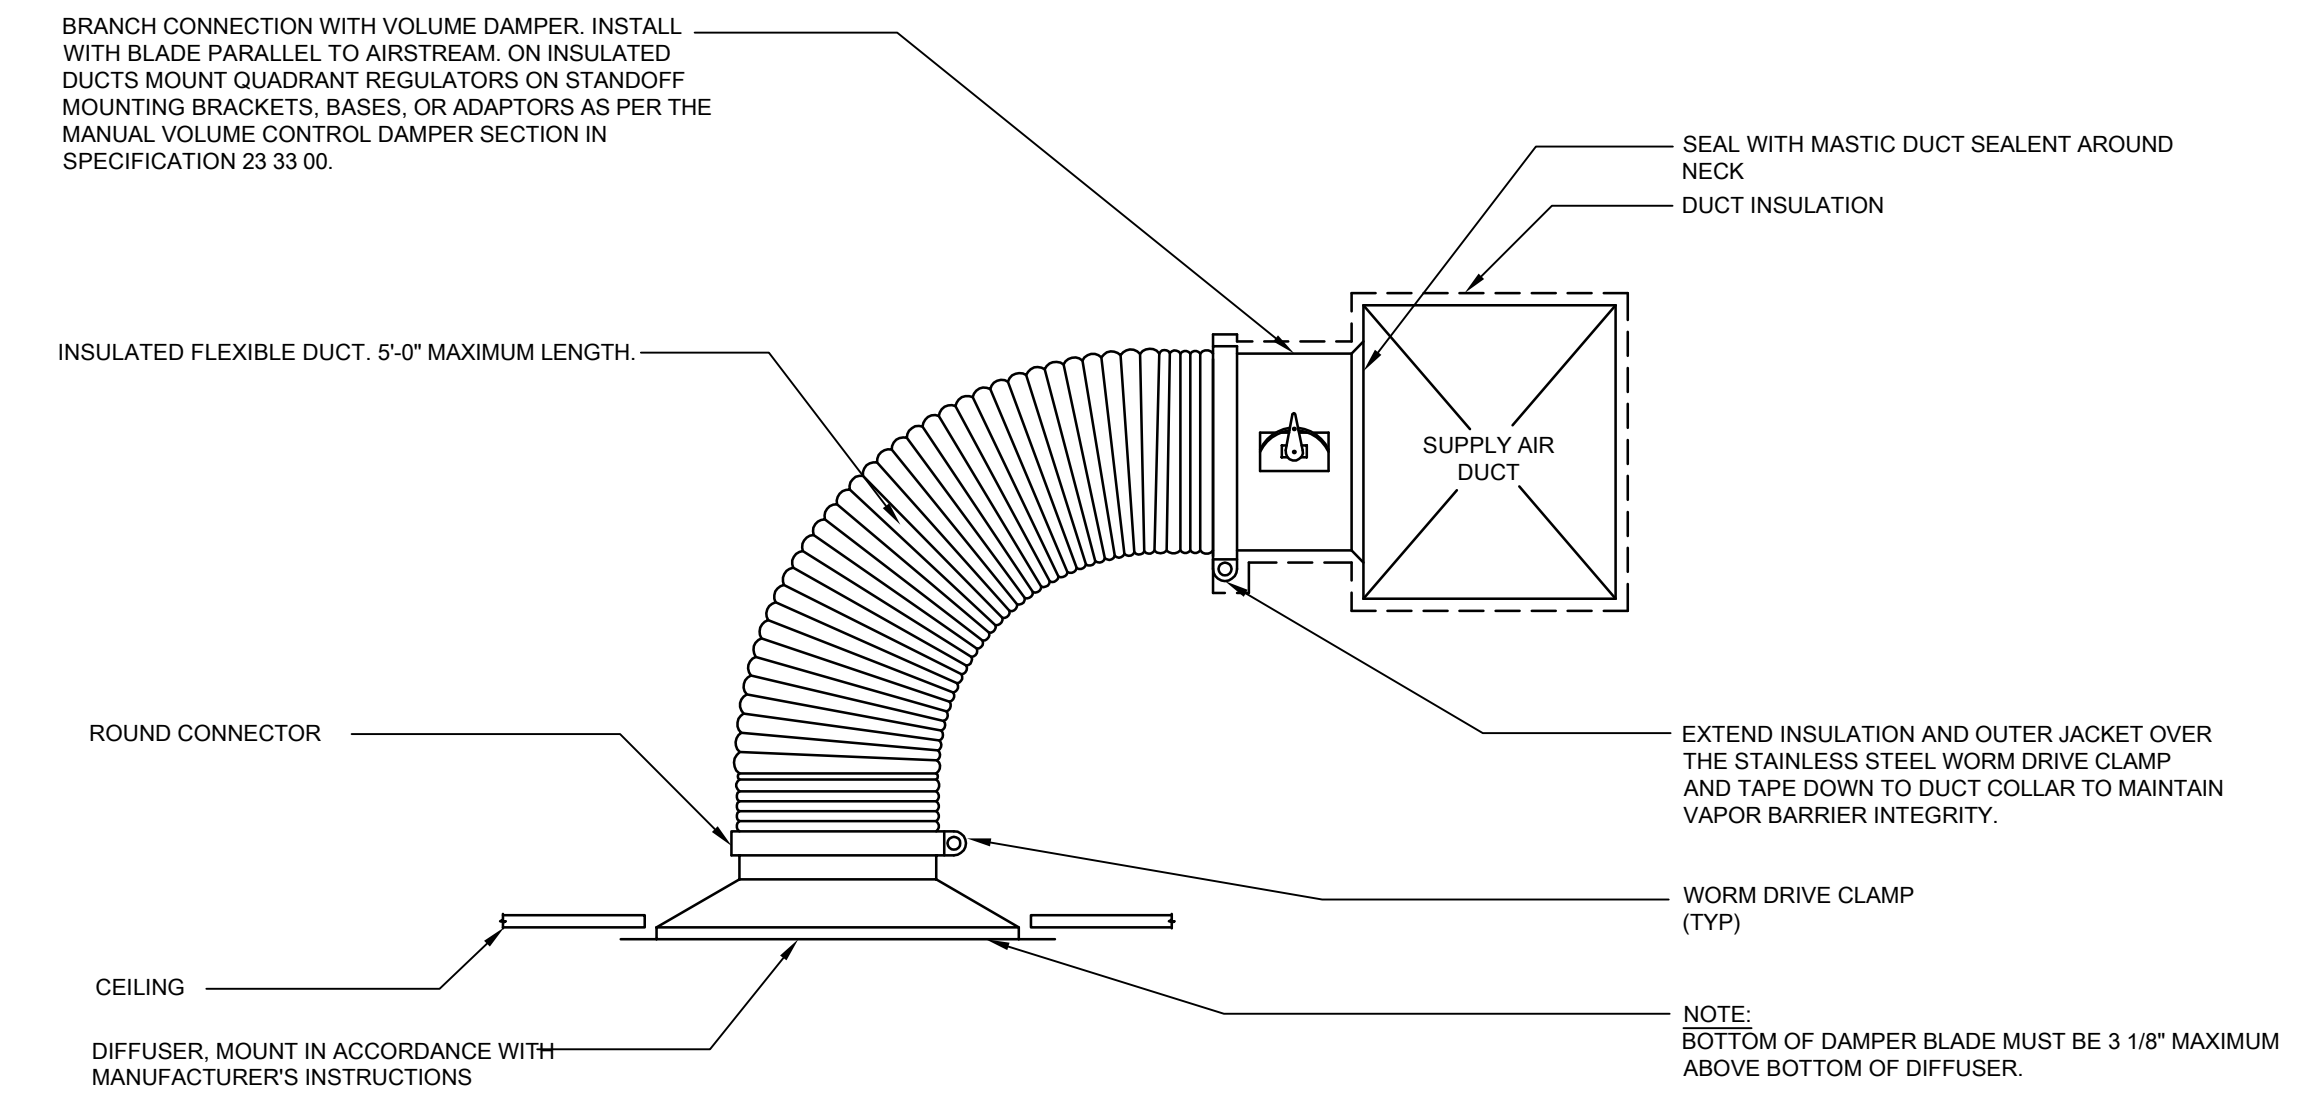


- NOTES:
- SUPPORT FLEXIBLE DUCT FROM STRUCTURE AS SPECIFIED. DUCT SHALL NOT KINK, SAG OR REST ON LIGHT FIXTURES, CEILING SUPPORT TEES OR TILE.
 - PROVIDE REGULATORS WHERE VOLUME DAMPER IS ACCESSIBLE.
 - IN UNCONDITIONED CEILING PLENUMS, INSULATE BACK OF DIFFUSER WITH 1" DUCT WRAP AND SEAL WITH VAPOR BARRIER TAPE.

8 CEILING DIFFUSER WITH FLEXIBLE DUCT DETAIL
N.T.S.


| drawing title | | | STATE OF CONNECTICUT DEPARTMENT OF ADMINISTRATIVE SERVICES | |
|--------------------------|---------|----------------------------------|---|--------------------|
| MECHANICAL DETAILS | | | | |
| REVISIONS | | | | |
| mark | date | description | drawing prepared by | date |
| | 8/4/17 | SCHEMATIC DESIGN SUBMISSION | CONSULTING ENGINEERING SERVICES, INC. 811 MIDDLE STREET MIDDLETOWN, CT | 07/25/18 |
| | 1/15/18 | DESIGN DEVELOPMENT SUBMISSION | | scale AS NOTED |
| | 4/16/18 | CONSTRUCTION DOCUMENTS | project WESTERN CT STATE UNIVERSITY WHITE HALL 2ND AND 3RD FLOOR RENOVATIONS DANBURY, CONNECTICUT | drawn by AJS |
| | 5/23/18 | | | approved by PMA |
| | 7/25/18 | | | drawing no. |
| | 1/21/19 | | | M3.01 |
| CAD no. xxxxxxxxx.dwg | | project no. 61-RD-299 | | |

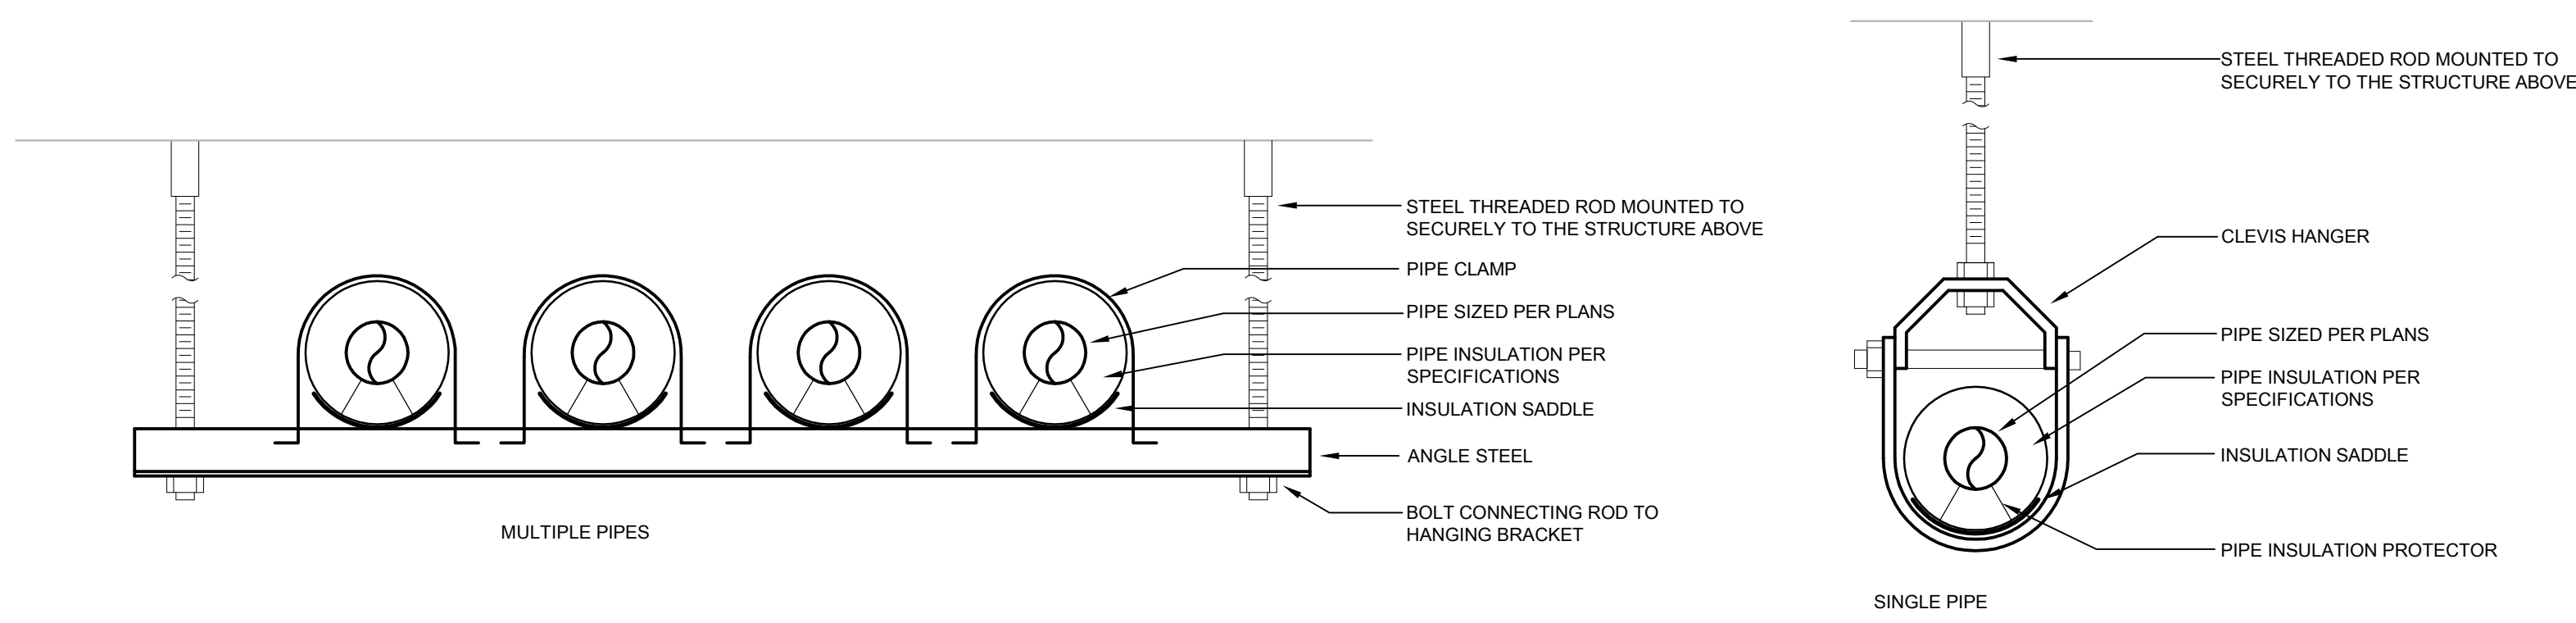


1 TYPICAL PIPE SUPPORT DETAILS
N.T.S.

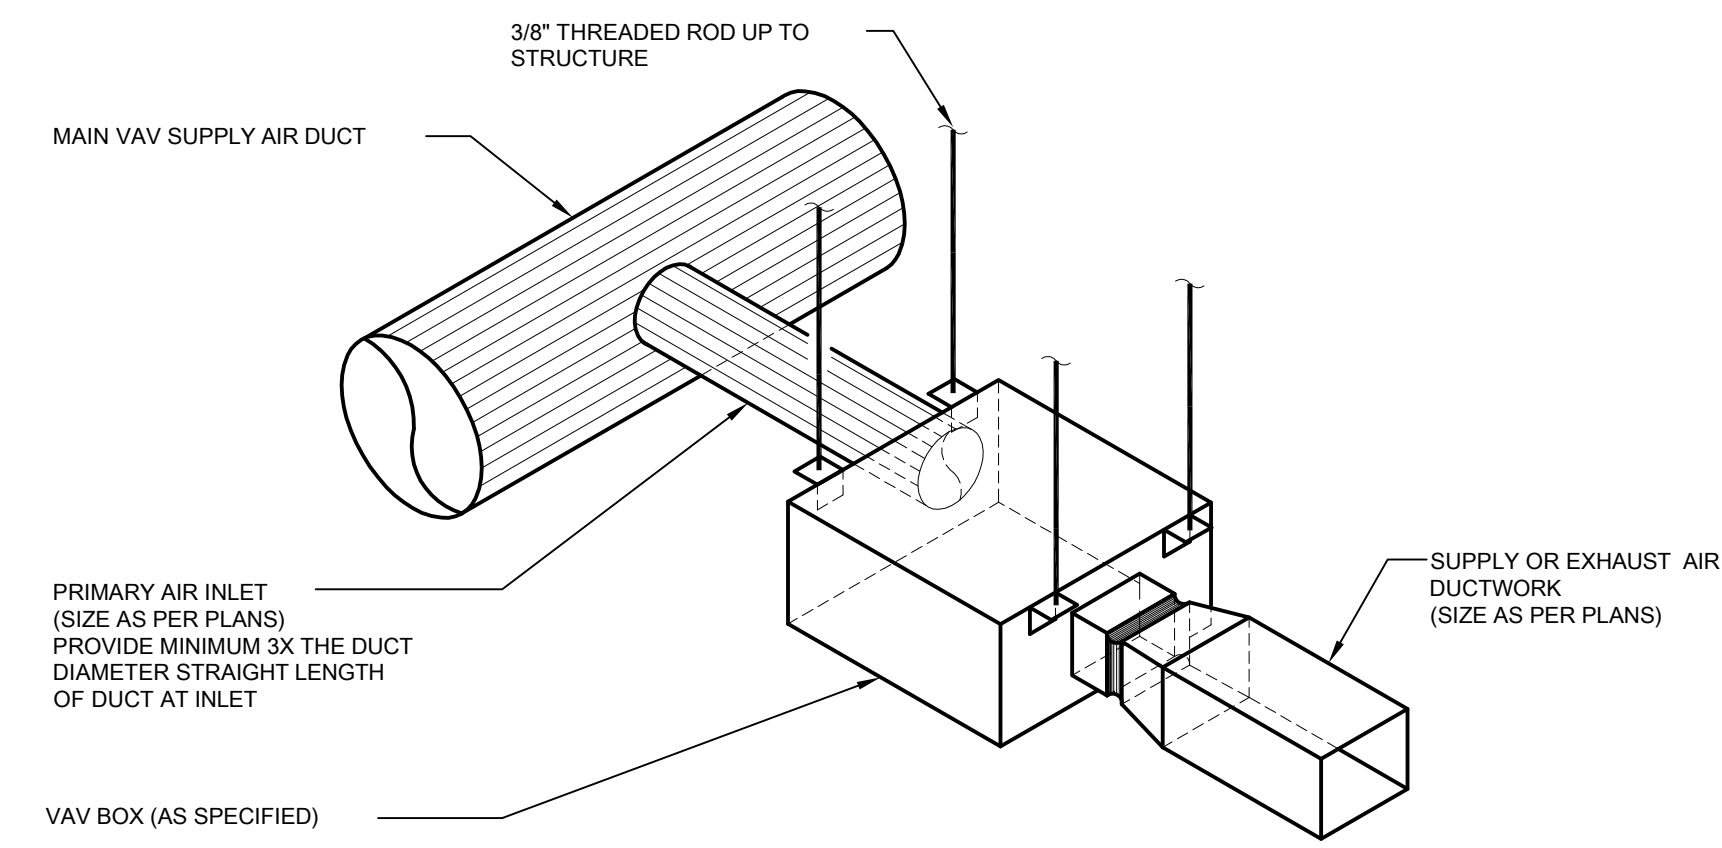

2 VAV INSTALLATION DETAIL
N.T.S.

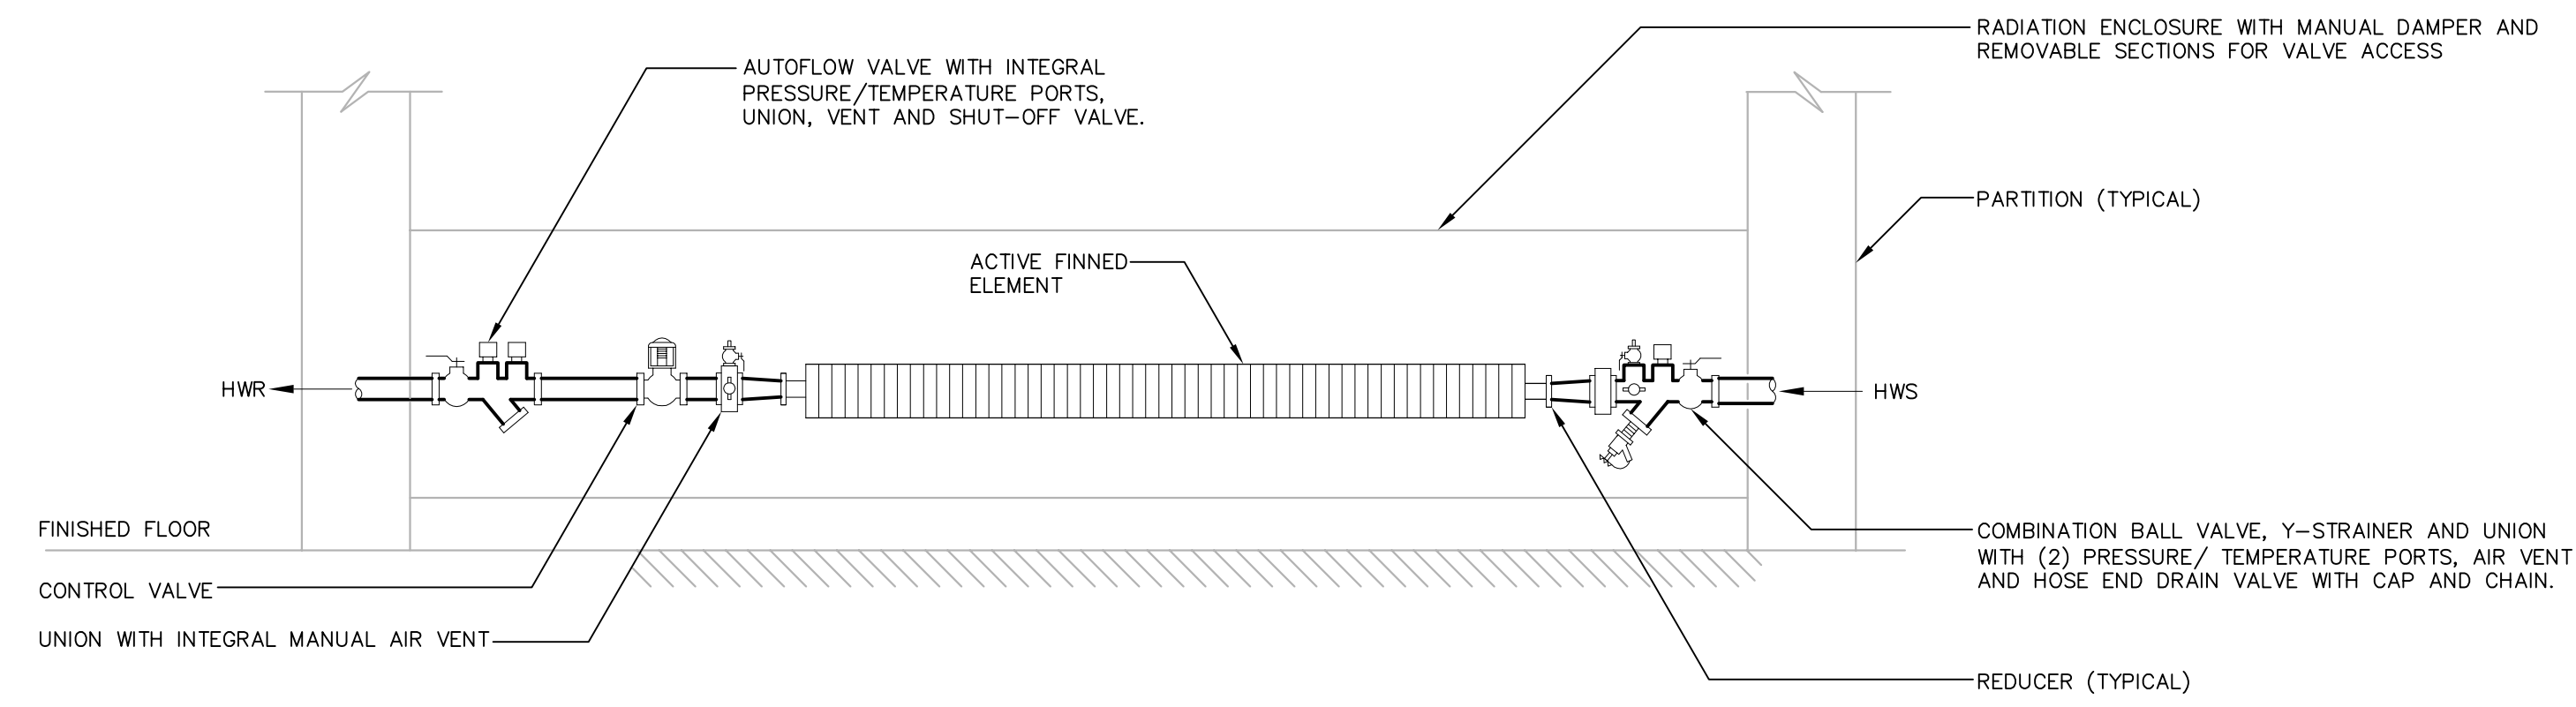

3 HOT WATER FINNED TUBE RADIATION PIPING DIAGRAM
N.T.S.

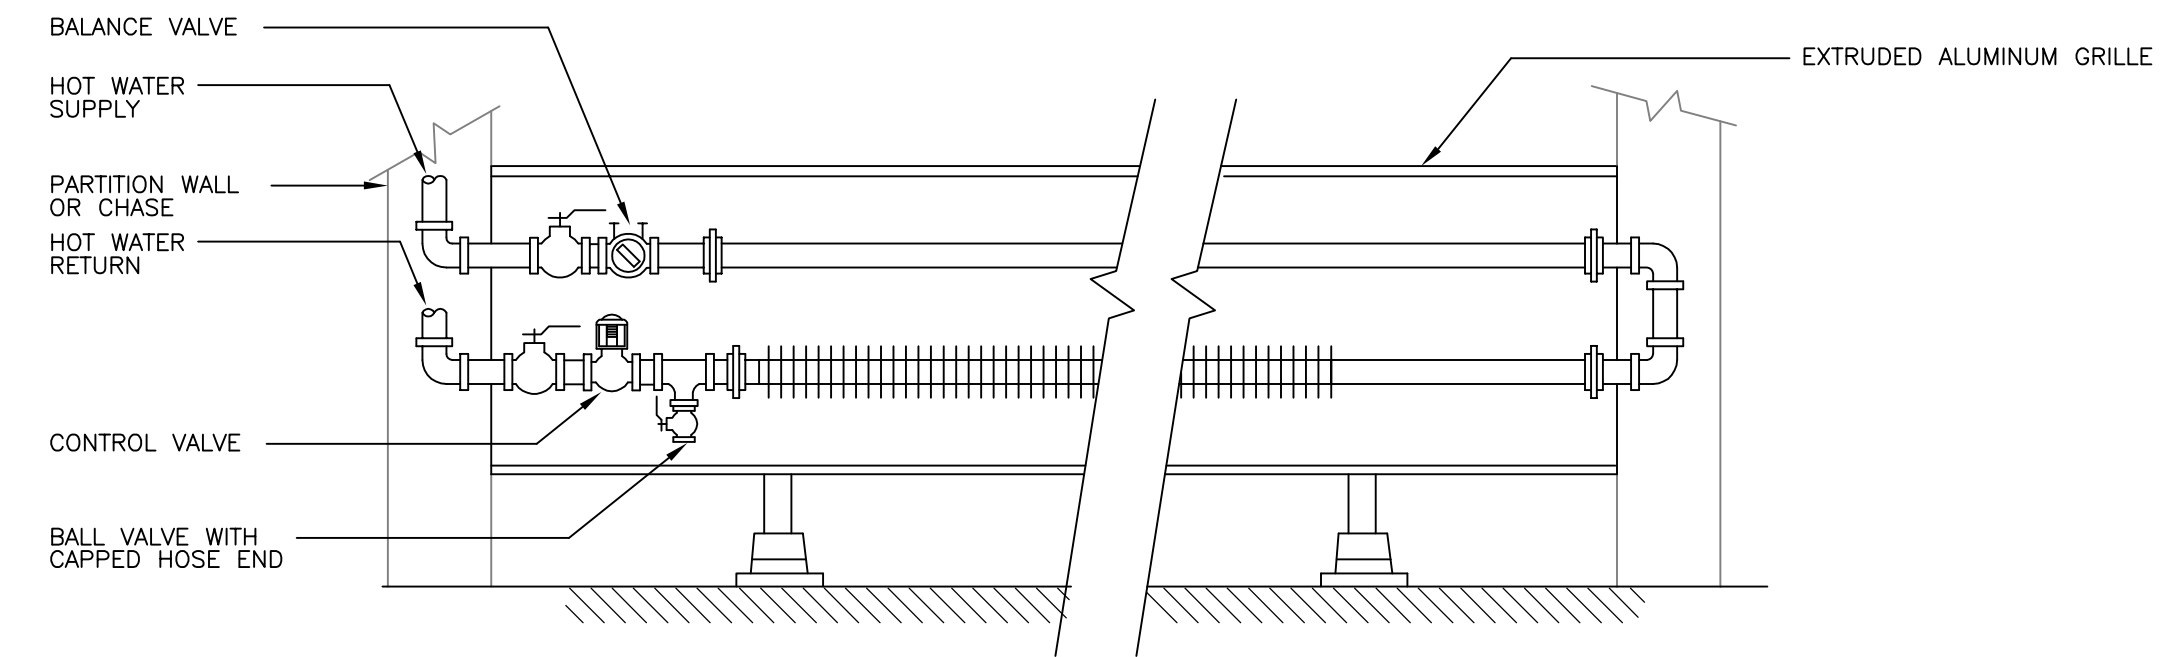


4 HOT WATER FIN TUBE RADIATION PIPING DIAGRAM
N.T.S.

| drawing title | | | STATE OF CONNECTICUT DEPARTMENT OF ADMINISTRATIVE SERVICES | | | |
|--------------------|--------------------|-------------------------------|--|---|-----------------------------|--------------------|
| MECHANICAL DETAILS | | | | | | |
| REVISIONS | | | | | | |
| mark | date | description | drawing prepared by | date | scale | |
| | 8/4/17 | SCHEMATIC DESIGN SUBMISSION | CONSULTING ENGINEERING SERVICES, INC. 811 MIDDLE STREET MIDDLETOWN, CT | 07/25/18 | AS NOTED | |
| | 1/15/18 | DESIGN DEVELOPMENT SUBMISSION | | | | |
| | 4/16/18 | CONSTRUCTION DOCUMENTS | | project | | |
| | 5/23/18 | | | WESTERN CT STATE UNIVERSITY WHITE HALL | | drawn by AJS |
| | 7/25/18 1/21/19 | | | 2ND AND 3RD FLOOR RENOVATIONS DANBURY, CONNECTICUT | | approved by PMA |
| | | | CAD no. xxxxxxxx.dwg | project no. BI-RD-299 | drawing no. M3.02 | |


| TEMPERATURE CONTROL SYMBOLS | |
|-----------------------------|---|
| SYMBOLS | DESCRIPTION |
| | ANALOG INPUT (SUBSCRIPT INDICATES QUANTITY - TYPICAL) |
| | ANALOG INPUT |
| | ANALOG OUTPUT |
| | DIGITAL INPUT |
| | DIGITAL OUTPUT |
| | AQUASTAT |
| | AIR FLOW MONITORING STATION |
| | AIR FLOW SWITCH |
| | AUDIO / VISUAL ALARM |
| | BUILDING MANAGEMENT SYSTEM |
| | CARBON MONOXIDE SENSOR |
| | CARBON DIOXIDE SENSOR |
| | CURRENT SENSING RELAY |
| | DIFFERENTIAL PRESSURE GAUGE WITH CONTACT SWITCH |
| | DIFFERENTIAL PRESSURE TRANSMITTER |
| | ENTHALPY SENSOR |
| | EQUIPMENT CONTACT |
| | END SWITCH |
| | FREEZESTAT |
| | FLOW METER |
| | FLOW SWITCH |
| | HUMIDITY SENSOR |
| | LEAK DETECTOR |
| | MOTORIZED DAMPER |
| | METHANE DETECTOR |
| | OCCUPANCY SENSOR |
| | VERRIDE PUSHBUTTON SWITCH |
| | PRESSURE TRANSMITTER |
| | TOGGLE SWITCH |
| | SWITCH WITH PILOT LIGHT |
| | SWITCH: 0-60 MINUTE TWIST TIMER |
| | SMOKE DAMPER |
| | STATIC PRESSURE SENSOR |
| | SMOKE DETECTOR |
| | THERMOSTAT |
| | LOCAL THERMOSTAT (24 VOLT) |
| | TEMPERATURE SENSOR |
| | AVERAGING TEMPERATURE SENSOR |
| | TEMPERATURE SENSOR WITH OCCUPANCY SENSOR |
| | VARIABLE FREQUENCY DRIVE |
| | STARTER/DISCONNECT |
| | PETCOCK ISOLATION VALVE |
| | MAGNEHELIC PRESSURE GAUGE WITH ISOLATION VALVE |
| | 2 WAY VALVE |
| | 3 WAY VALVE |

MISCELLANEOUS BMS CONTROL NOTES


- REMOVE ALL CONTROL COMPONENTS AND WIRING ASSOCIATED WITH EXHAUST FANS, ROOF TOP UNITS, AHU'S, HVAC SYSTEMS, BOILERS, PUMPS, ETC. BEING REMOVED. REFER TO DEMOLITION DRAWINGS.
- CONTROL OF ALL TEMPERATURE CONTROL DEVICES SHALL BE COMMISSIONED PER SPECIFICATIONS.
- REFER TO FLOOR PLANS AND DETAILS FOR MISCELLANEOUS BMS SCOPE OF WORK.
- 120V, 1 PHASE POWER TO ALL NEW & EXISTING CONTROLS SHALL BE FED FROM NEW DEDICATED CIRCUITS FROM NEW ELECTRICAL PANELS. FOR LOCATION OF 120V PANELS REFER TO THE FLOOR PLANS AND ELECTRICAL DRAWINGS.
- FOR QUANTITY OF SPACE TEMPERATURE SENSORS, DIFFERENTIAL PRESSURE SENSORS, SWITCHES AND OTHER DEVICES, REFER TO FLOOR PLAN DRAWINGS.

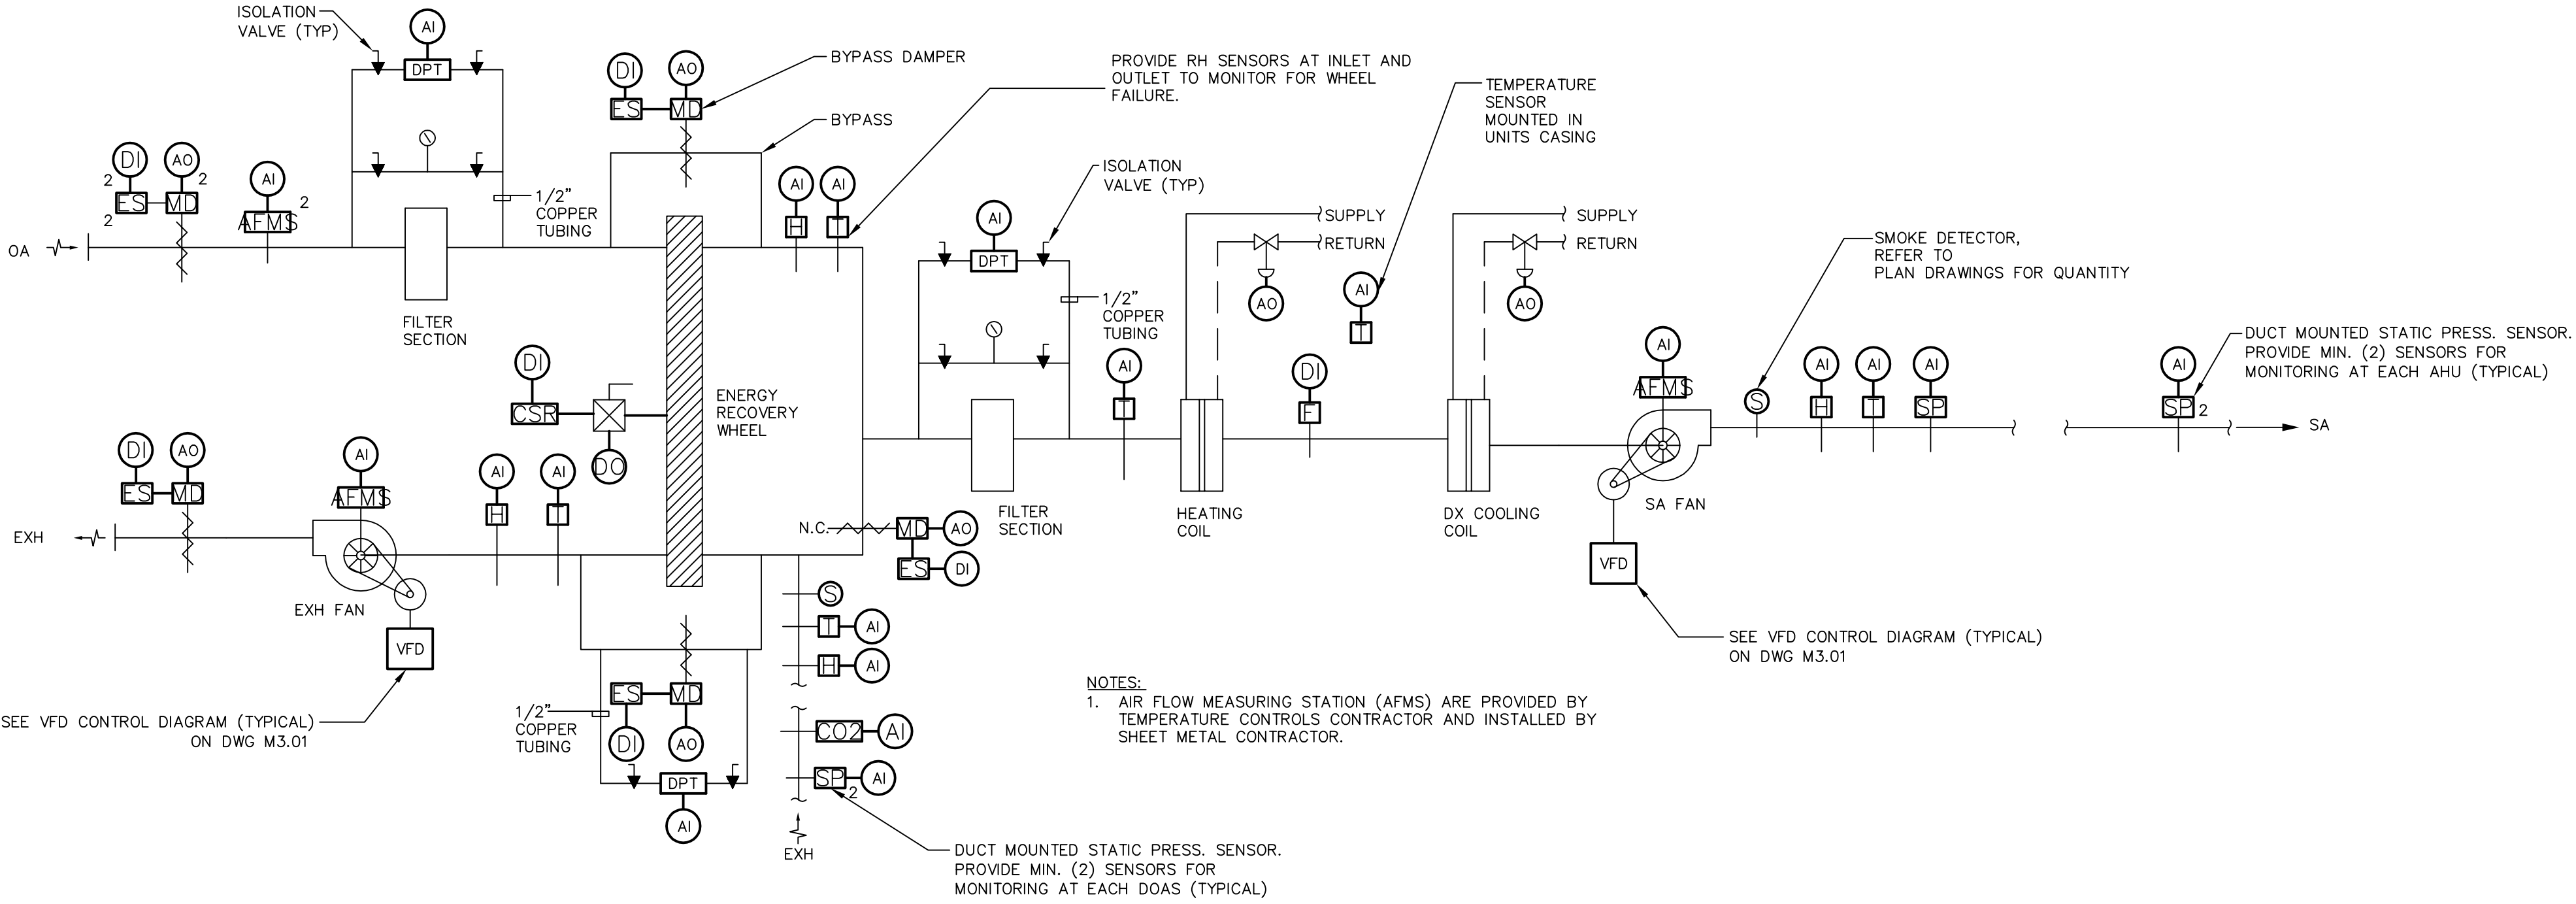

1 DOAS CONTROL DIAGRAM
SCALE: NTS

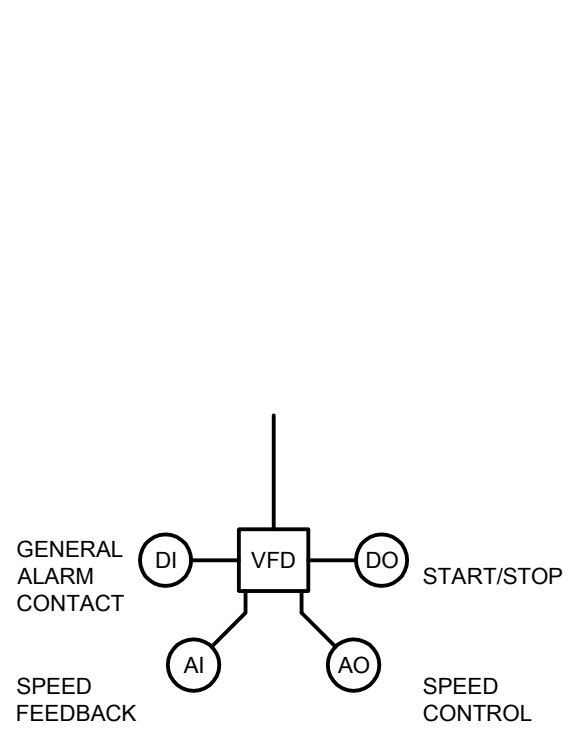


2 VFD CONTROL DIAGRAM
N.T.S.

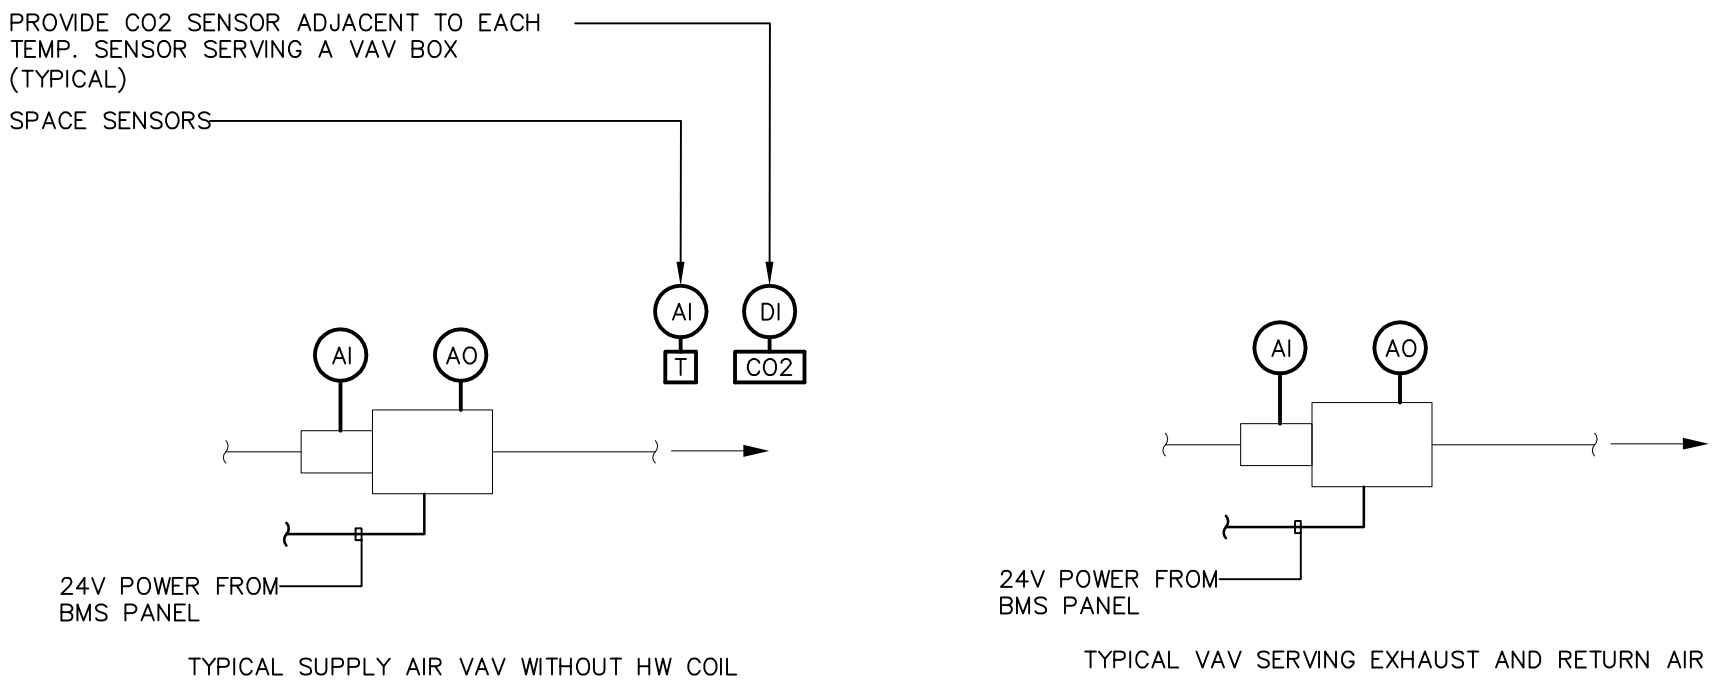

3 VAV CONTROL DIAGRAM
N.T.S.

4 VAV CONTROL DIAGRAM
N.T.S.

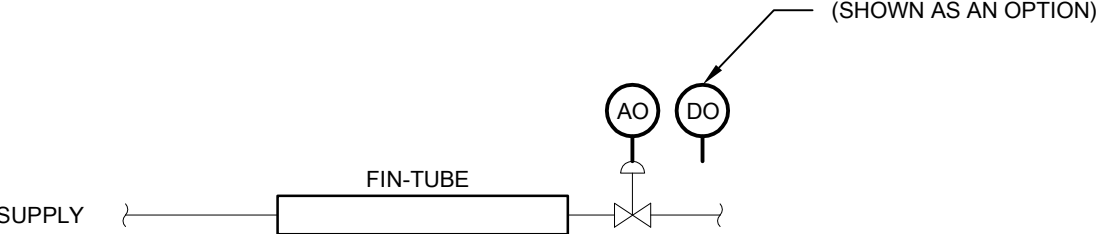


5 RADIATION CONTROL DIAGRAM
N.T.S.

| drawing title | | | STATE OF CONNECTICUT DEPARTMENT OF ADMINISTRATIVE SERVICES | |
|--------------------|---------|-------------------------------|---|----------|
| MECHANICAL DETAILS | | | REVISIONS | |
| mark | date | description | mark | date |
| | 8/4/17 | SCHEMATIC DESIGN SUBMISSION | | 07/25/18 |
| | 1/15/18 | DESIGN DEVELOPMENT SUBMISSION | | AS NOTED |
| | 4/16/18 | CONSTRUCTION DOCUMENTS | | |
| | 5/23/18 | | | |
| | 7/25/18 | | | |
| | 12/1/19 | | | |

| | |
|---|--|
| drawing prepared by CONSULTING ENGINEERING SERVICES, INC. 811 MIDDLE STREET MIDDLETOWN, CT | date 07/25/18 scale AS NOTED |
| project WESTERN CT STATE UNIVERSITY WHITE HALL 2ND AND 3RD FLOOR RENOVATIONS DANBURY, CONNECTICUT | drawn by AJS approved by PMA drawing no. M3.03 |
| CAD no. xxxxxxxx.dwg | project no. BI-RD-299 |

PURY-P287SKMU-A
177,331 BTU/h
121,090 BTU/h


| Pipe Dia. | Liquid / Gas | Model Number | Clg. Total (Sens.) |
|----------------------|--------------|--------------|--------------------|
| 78 / 1-1/8 | | | |
| 34 / 7/8 - 4.0ft (0) | | | |

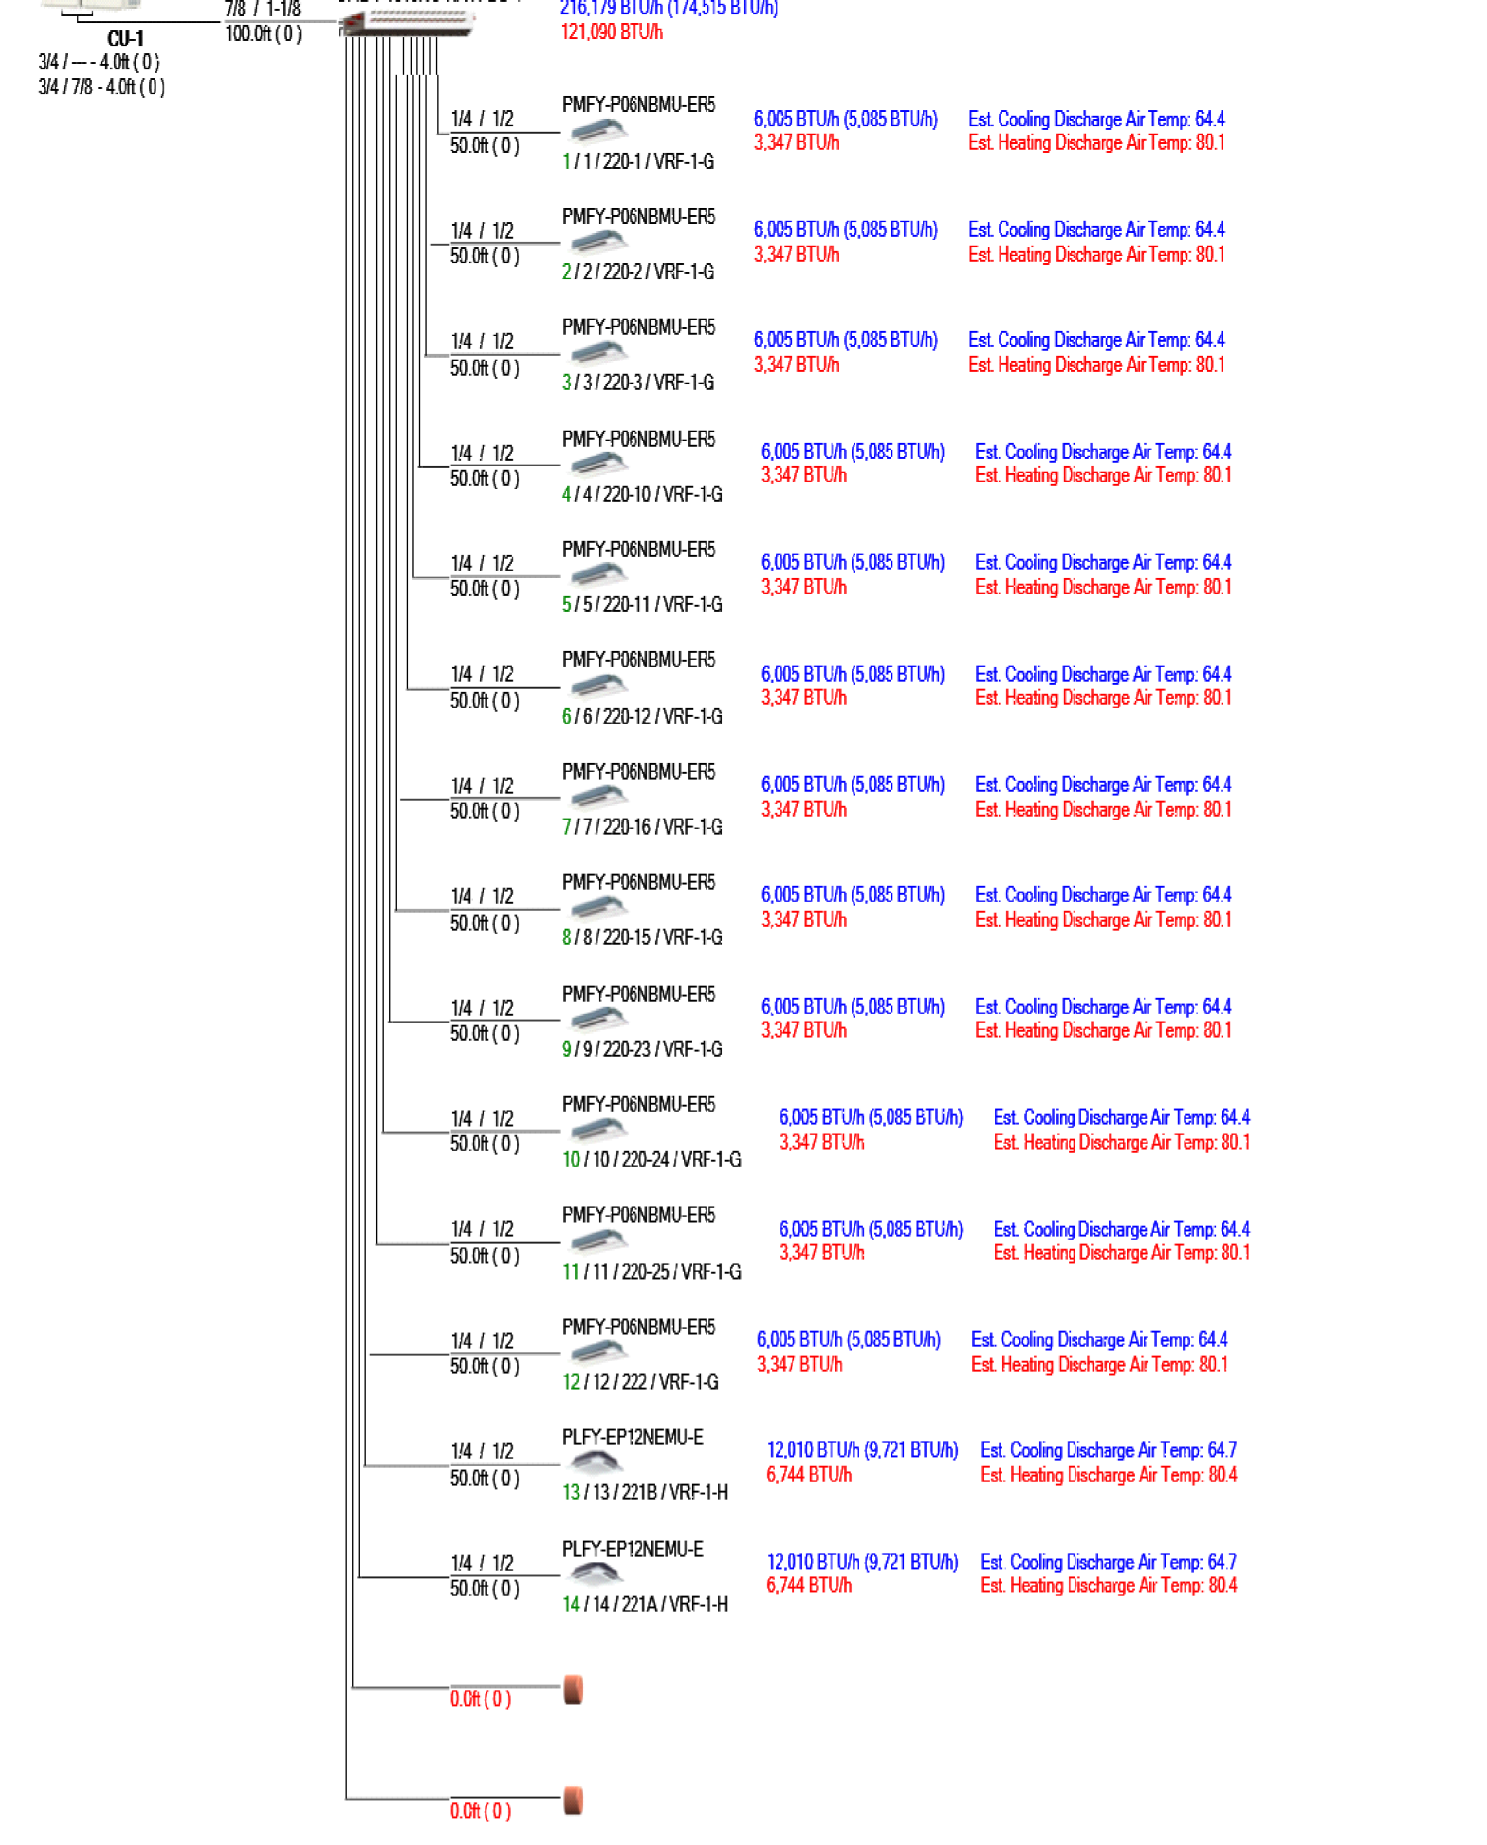

1 CU-1 FLOW DIAGRAM
SCALE: NTS


PURY-P287SKMU-A
276,481 BTU/h
177,839 BTU/h

| Pipe Dia. | Liquid / Gas | Model Number | Clg. Total (Sens.) |
|------------------------|--------------|--------------|--------------------|
| 1-1/8 / 1-3/8 | | | |
| 78 / 1-1/8 - 4.0ft (0) | | | |

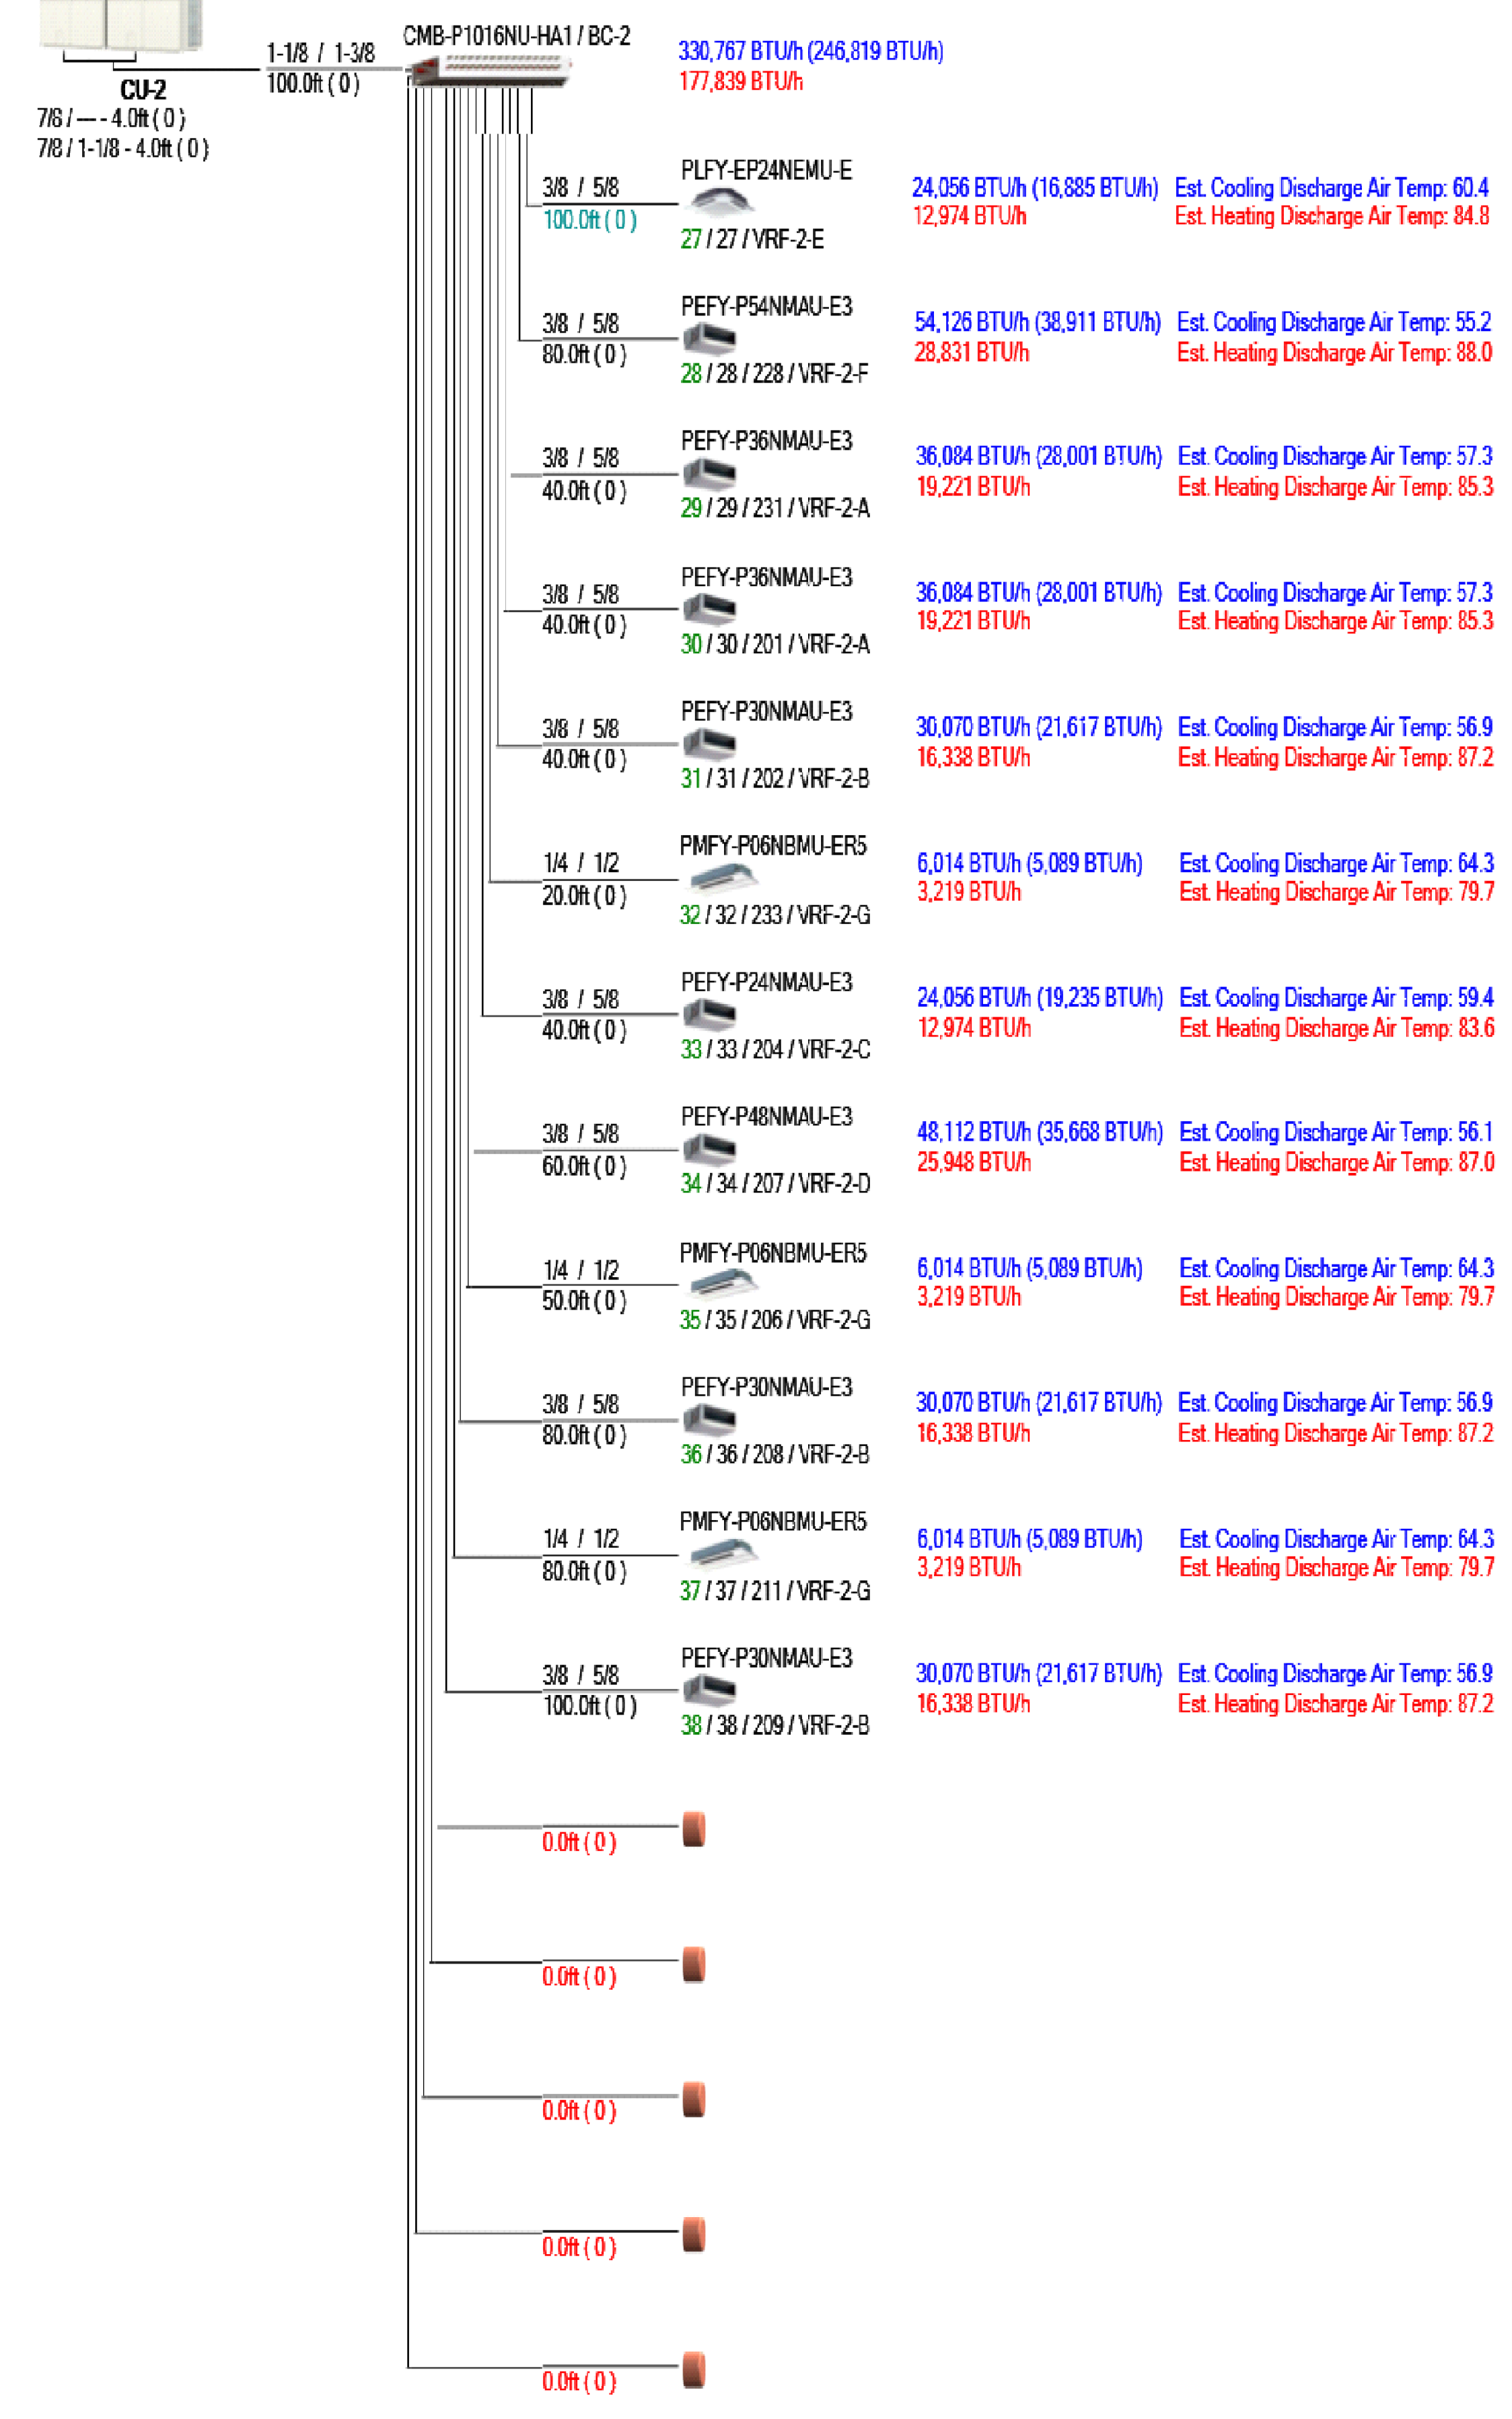


2 CU-2 FLOW DIAGRAM
SCALE: NTS

| drawing title | | | STATE OF CONNECTICUT DEPARTMENT OF ADMINISTRATIVE SERVICES | |
|-----------------------|-------------------------------|-------------------------------|--|---|
| MECHANICAL DETAILS | | | REVISIONS | |
| mark | date | description | drawing prepared by | date |
| | 8/4/17 | SCHEMATIC DESIGN SUBMISSION | CONSULTING ENGINEERING SERVICES, INC. 811 MIDDLE STREET MIDDLETOWN, CT | 07/25/18 |
| | 1/15/18 | DESIGN DEVELOPMENT SUBMISSION | | scale AS NOTED |
| | 4/16/18 | CONSTRUCTION DOCUMENTS | | project WESTERN CT STATE UNIVERSITY WHITE HALL 2ND AND 3RD FLOOR RENOVATIONS DANBURY, CONNECTICUT |
| | 5/23/18 7/25/18 1/21/19 | | | drawn by AJS approved by PMA drawing no. |
| CAD no. xxxxxxxxx.dwg | | | project no. BI-RD-299 | M3.04 |

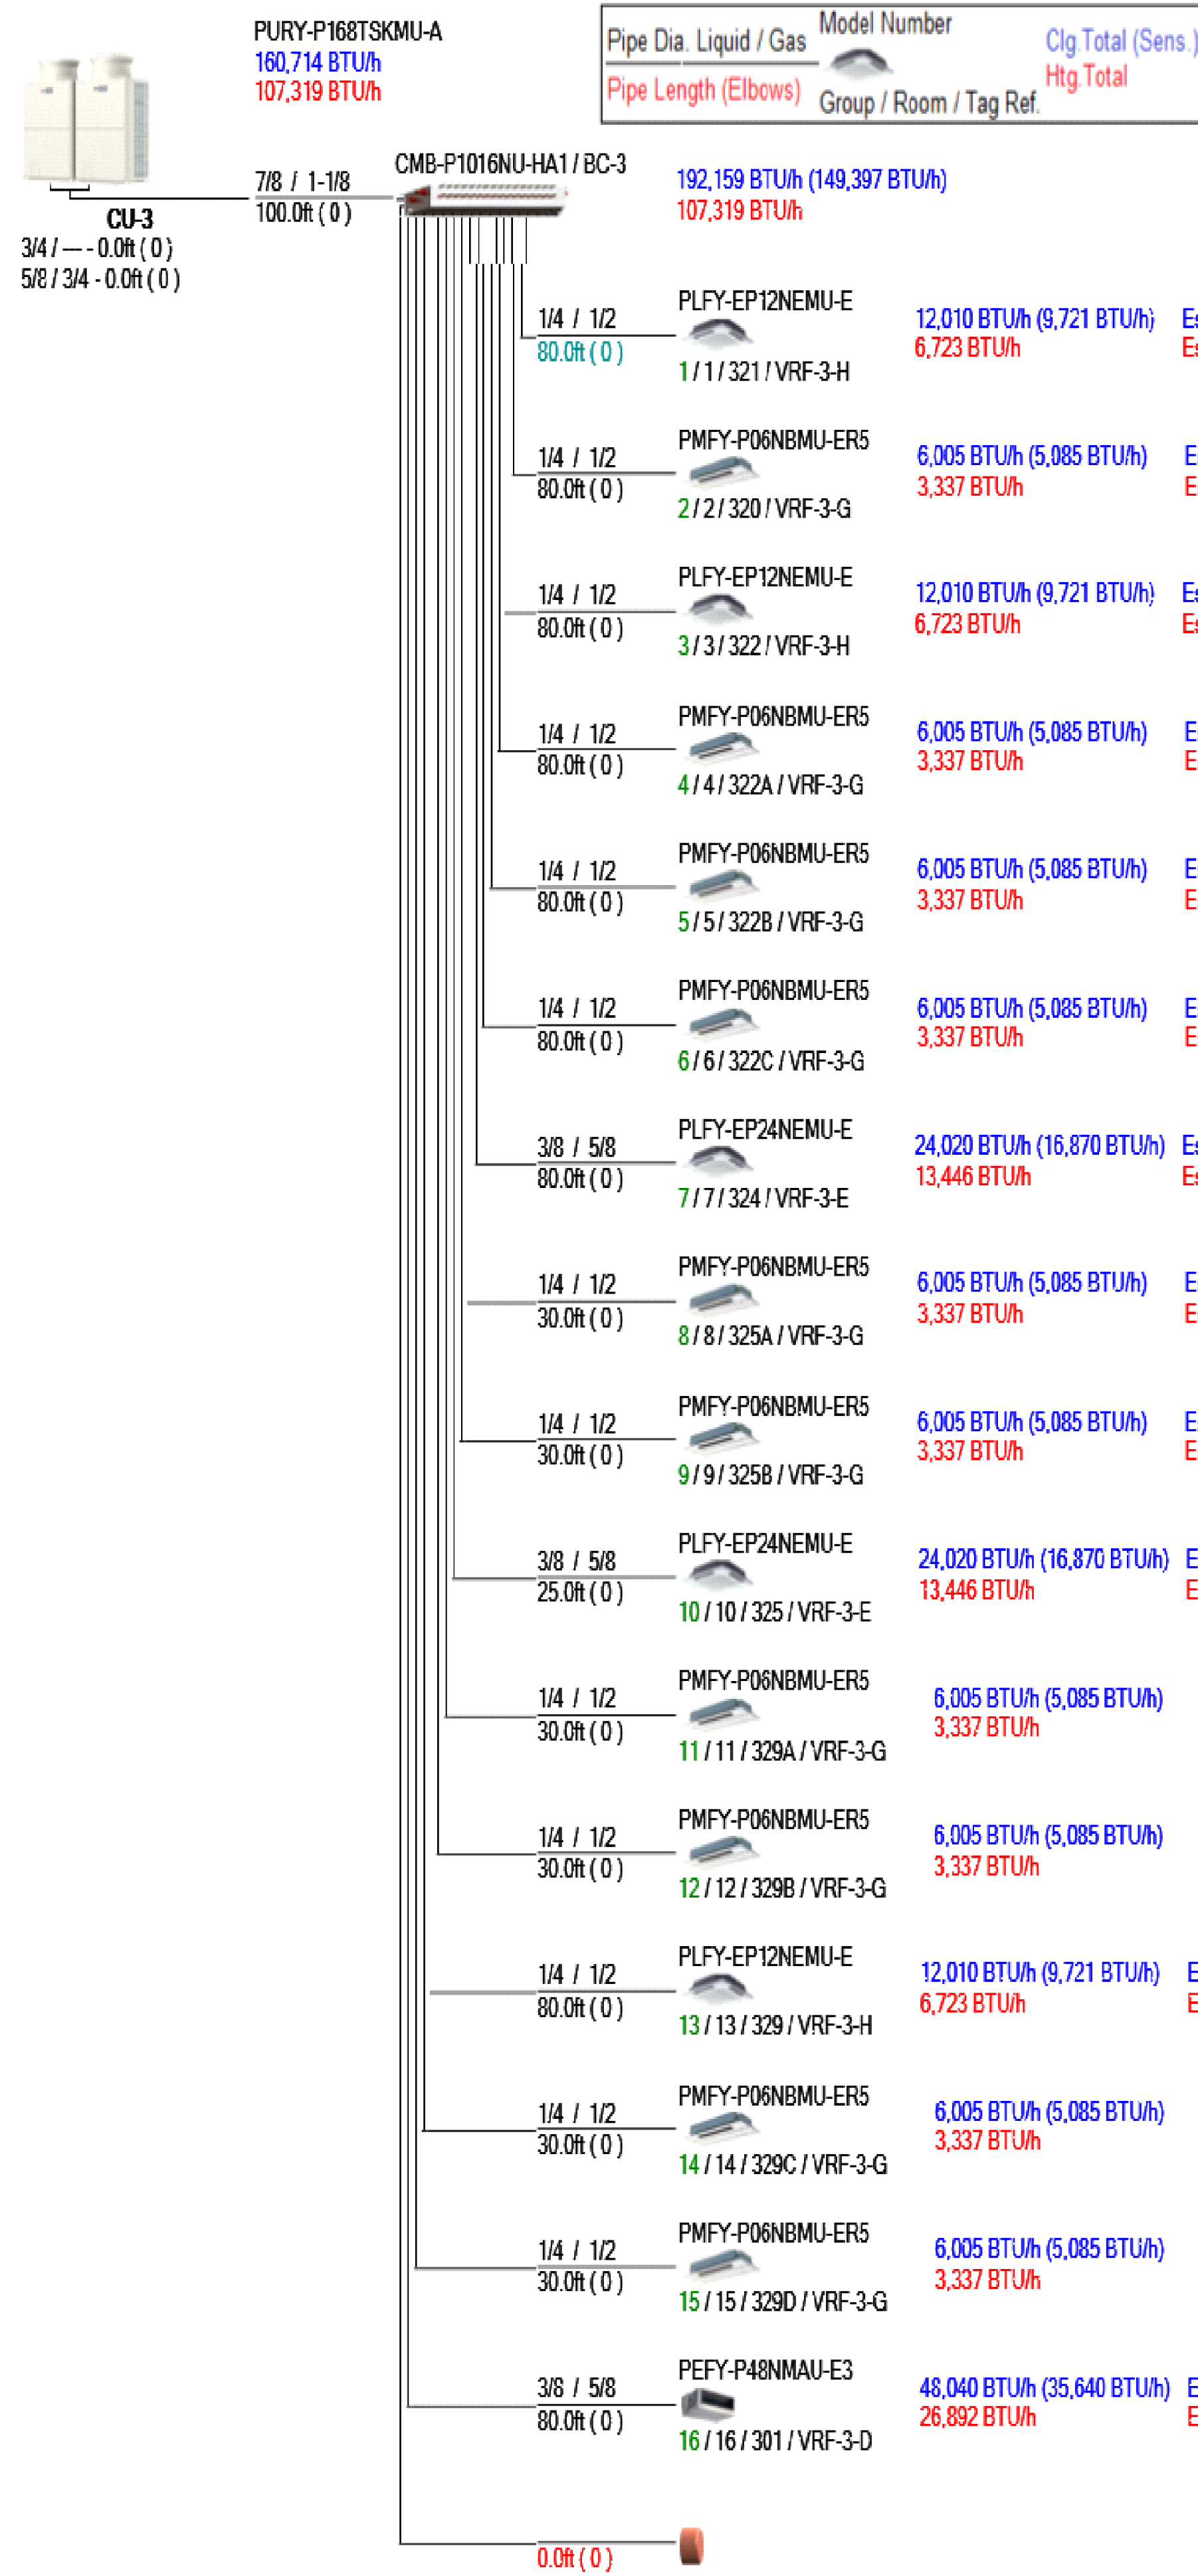


1 CU-3 FLOW DIAGRAM
SCALE: NTS

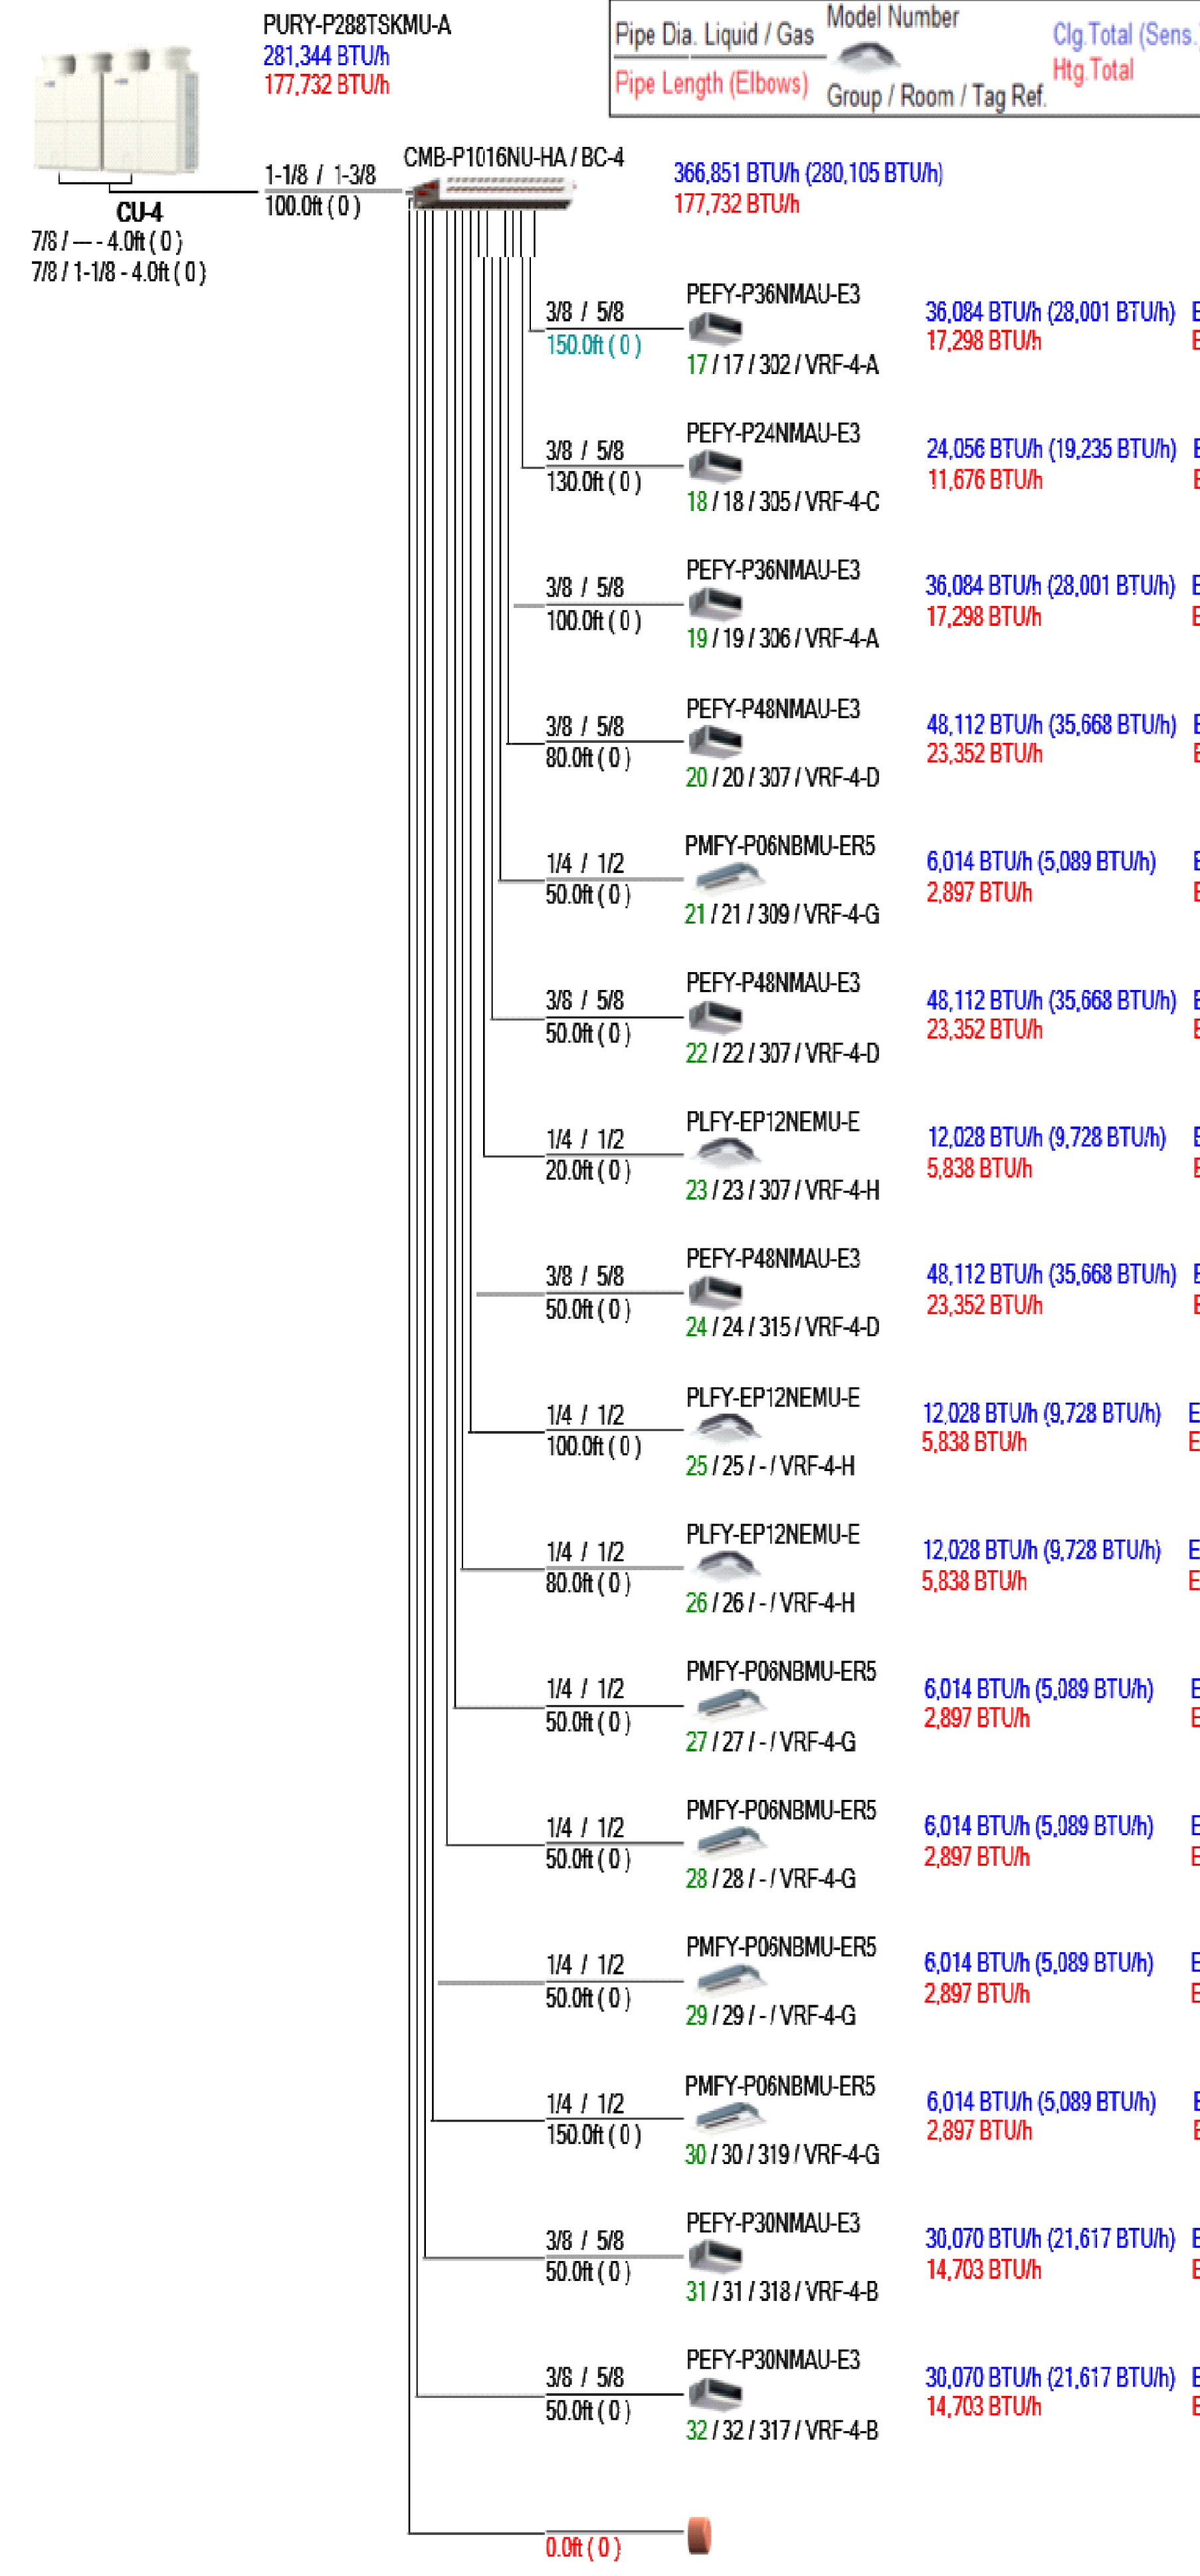


2 CU-4 FLOW DIAGRAM
SCALE: NTS

| drawing title | | | STATE OF CONNECTICUT DEPARTMENT OF ADMINISTRATIVE SERVICES | |
|--------------------------|---------|-------------------------------|---|-----------------------------|
| MECHANICAL DETAILS | | | REVISIONS | |
| mark | date | description | drawing prepared by | date |
| | 8/4/17 | SCHEMATIC DESIGN SUBMISSION | CONSULTING ENGINEERING SERVICES, INC. 811 MIDDLE STREET MIDDLETOWN, CT | 07/25/18 |
| | 1/15/18 | DESIGN DEVELOPMENT SUBMISSION | | scale AS NOTED |
| | 4/16/18 | CONSTRUCTION DOCUMENTS | project WESTERN CT STATE UNIVERSITY WHITE HALL 2ND AND 3RD FLOOR RENOVATIONS DANBURY, CONNECTICUT | drawn by AJS |
| | 5/23/18 | | | approved by PMA |
| | 7/25/18 | | | drawing no. M3.05 |
| | 1/21/19 | | | |
| CAD no. xxxxxxxxx.dwg | | project no. BI-RD-299 | | |

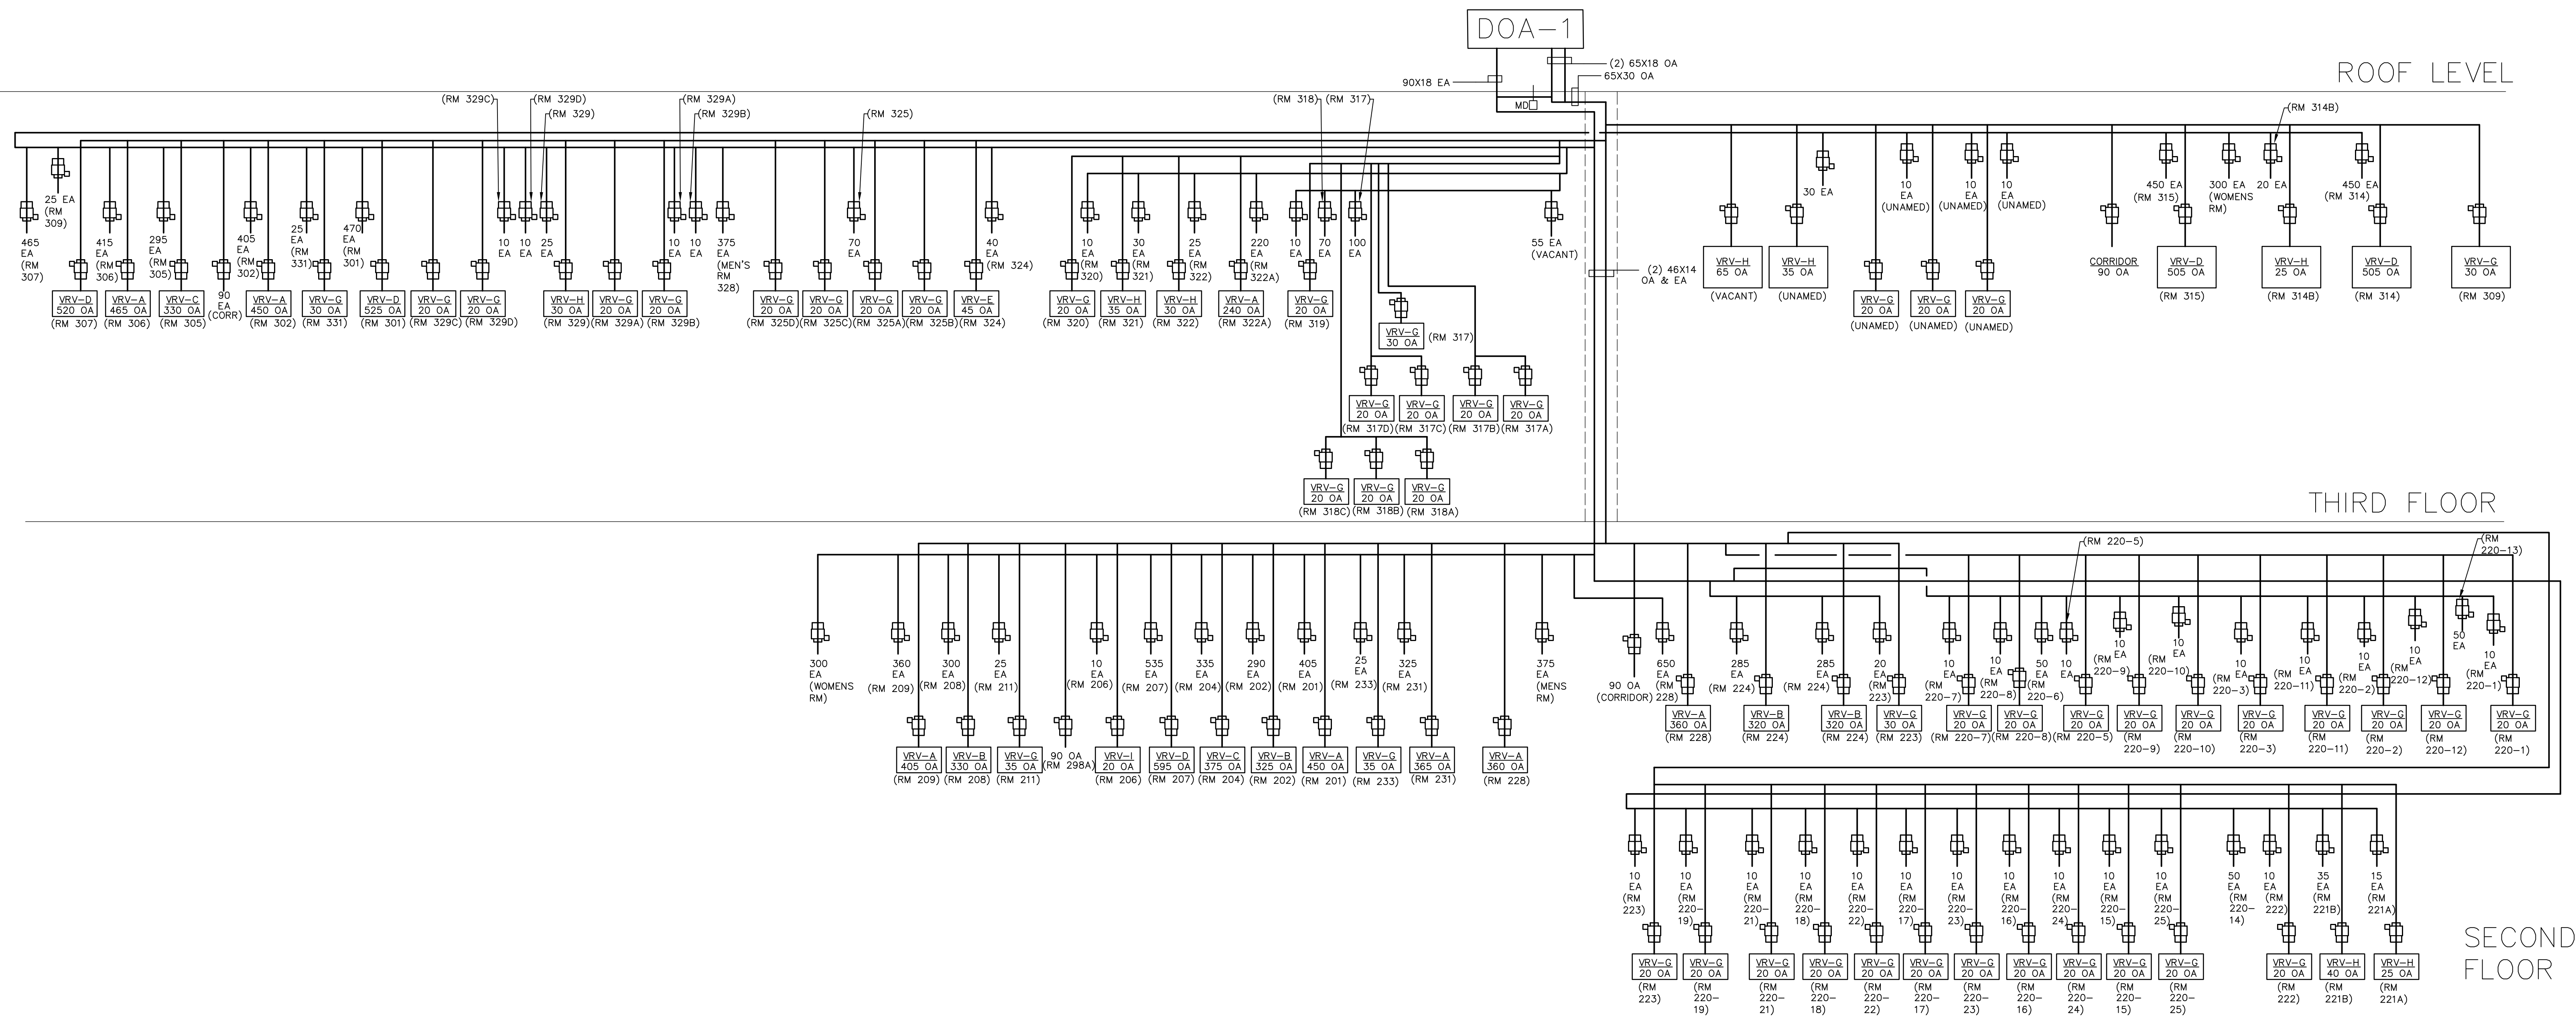

1 DEDICATED OUTDOOR AIR/EXHASUT RISER DIAGRAM-(DOA-1)
SCALE: NTS

| | | | | | |
|---------------|---------------|-------------------------------|-----------|--|-------------|
| drawing title | | MECHANICAL DETAILS | | STATE OF CONNECTICUT DEPARTMENT OF ADMINISTRATIVE SERVICES | |
| REVISIONS | | | | | |
| mark | date | description | | drawing prepared by | date |
| | 8/4/17 | SCHEMATIC DESIGN SUBMISSION | | CONSULTING ENGINEERING SERVICES, INC. 811 MIDDLE STREET MIDDLETOWN, CT | 07/25/18 |
| | 1/15/18 | DESIGN DEVELOPMENT SUBMISSION | | | scale |
| | 4/16/18 | CONSTRUCTION DOCUMENTS | | project | drawn by |
| | 5/23/18 | | | WESTERN CT STATE UNIVERSITY WHITE HALL 2ND AND 3RD FLOOR RENOVATIONS DANBURY, CONNECTICUT | AJS |
| | 7/25/18 | | | | approved by |
| | 1/21/19 | | | drawing no. | |
| CAD no. | xxxxxxxxx.dwg | project no. | 61-RD-299 | M3.06 | |

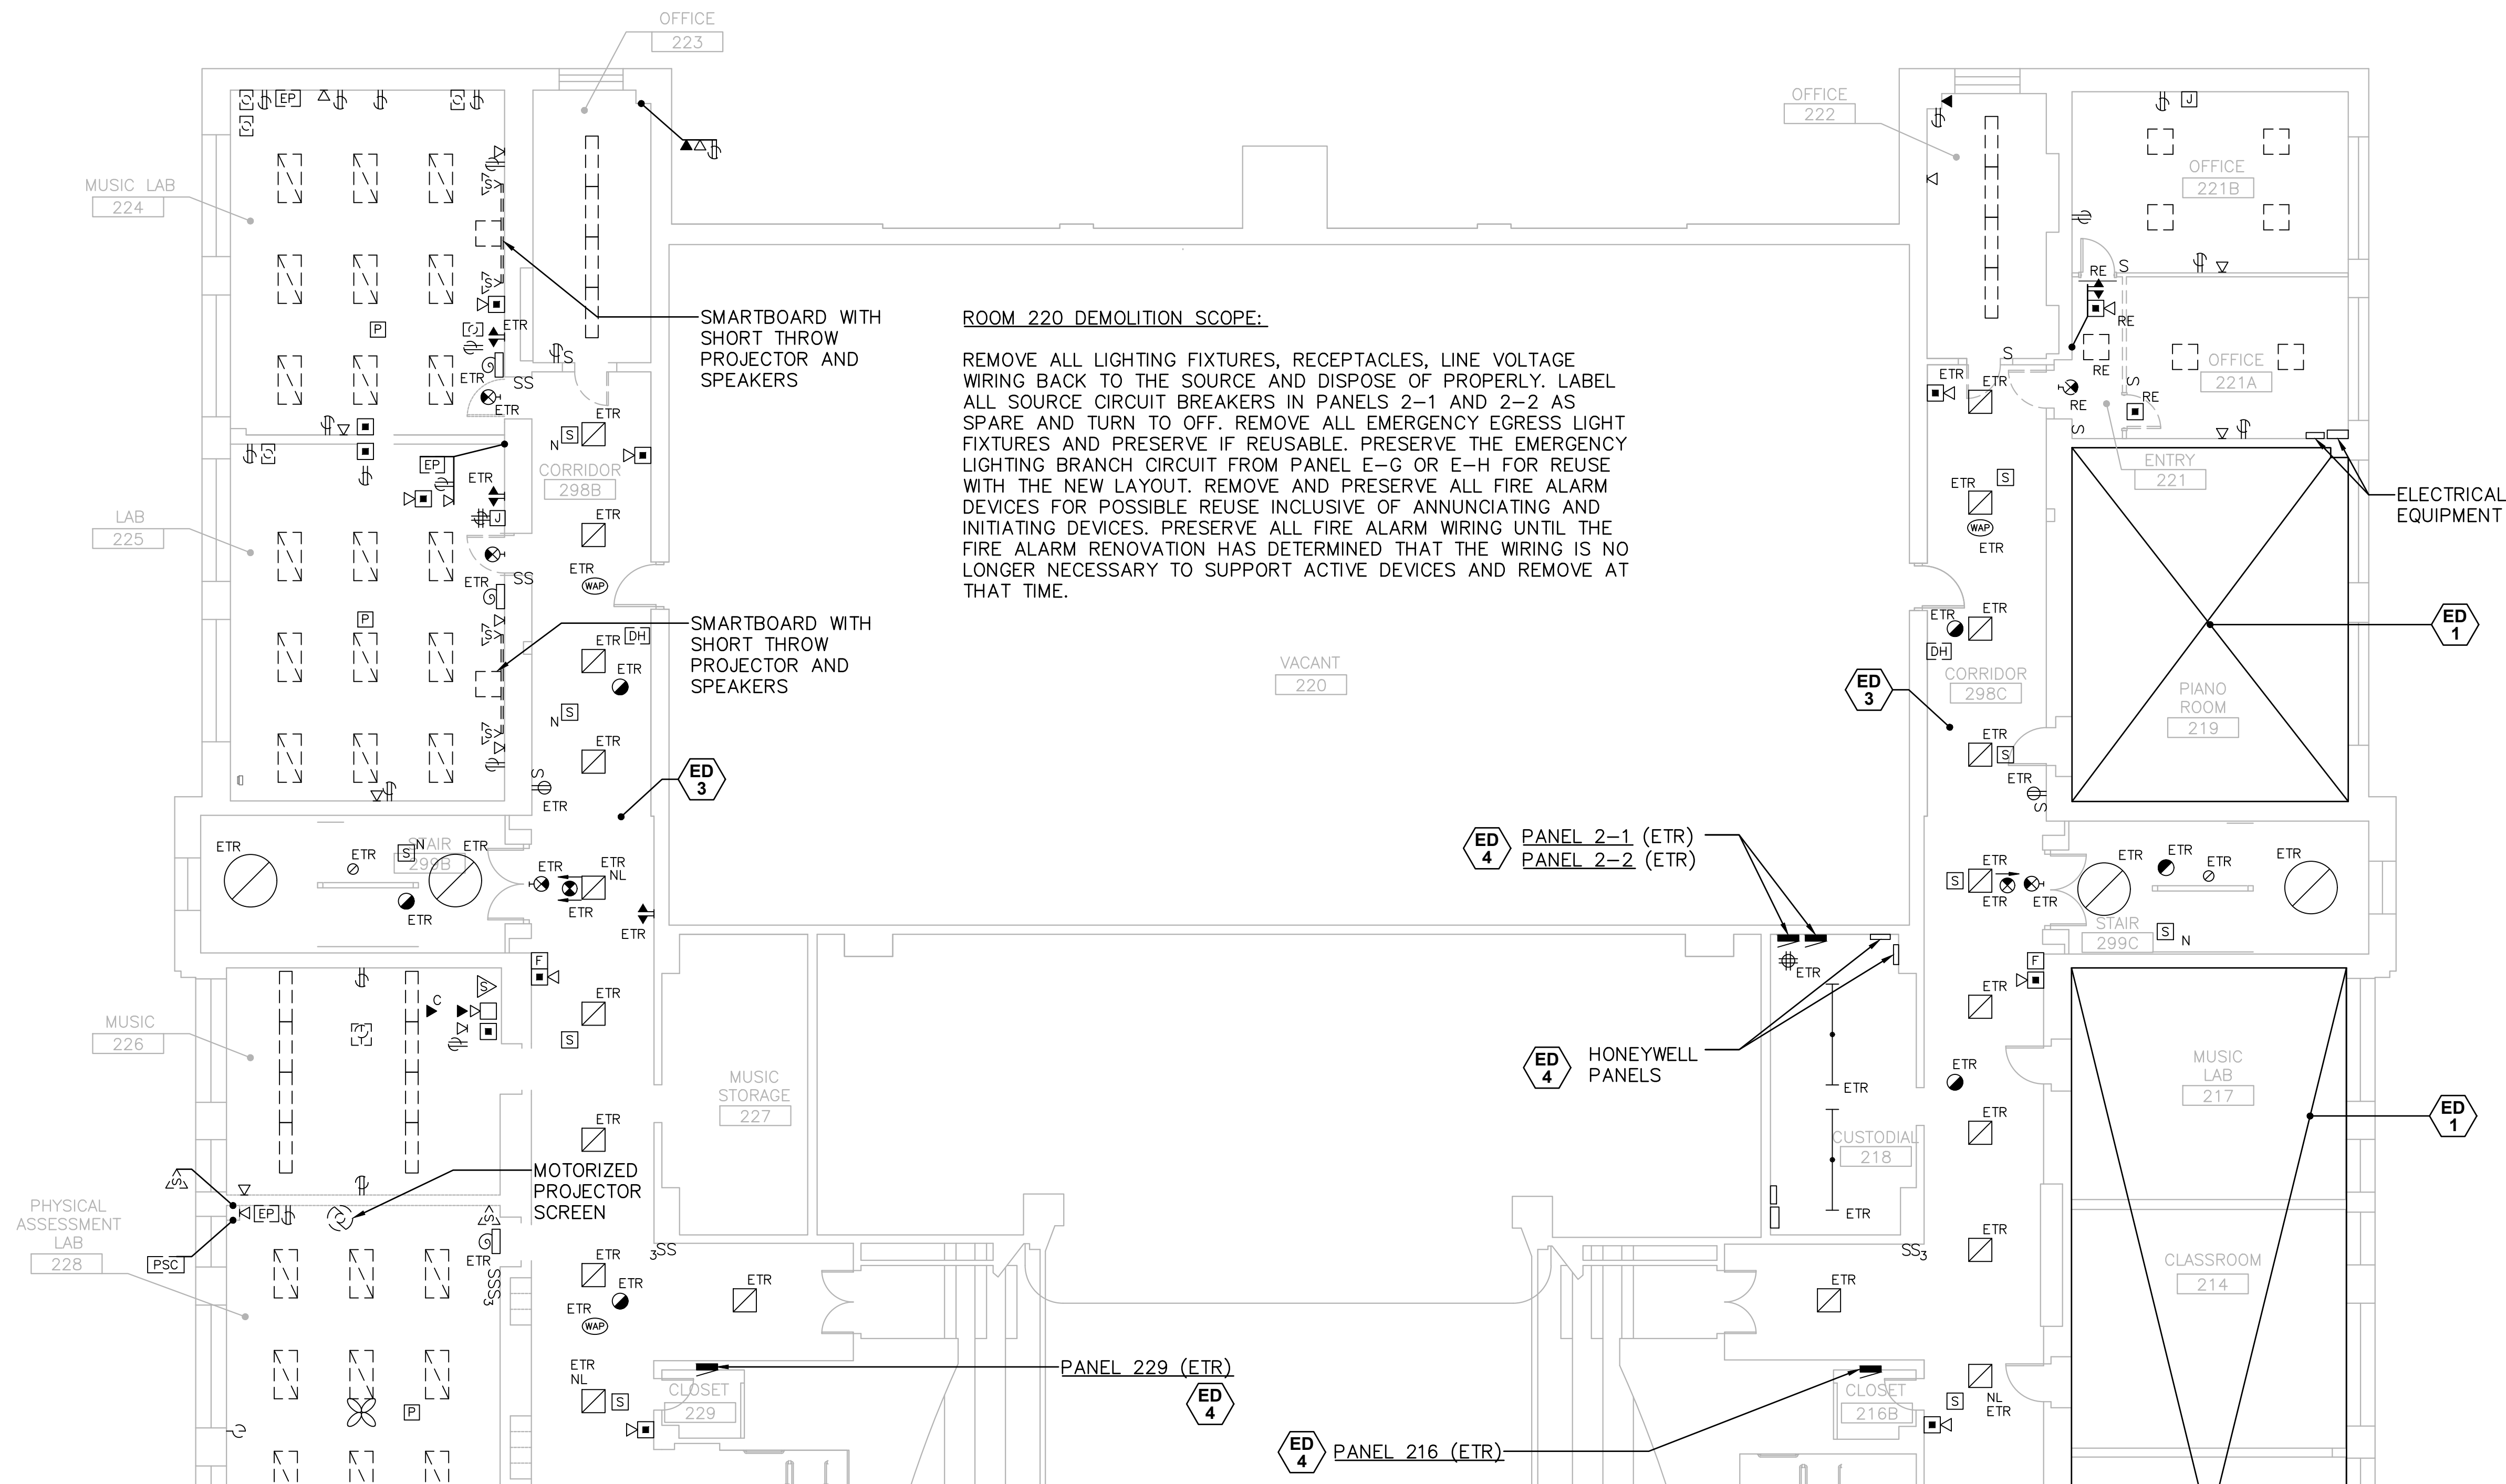

ROOM 220 DEMOLITION SCOPE:
 REMOVE ALL LIGHTING FIXTURES, RECEPTACLES, LINE VOLTAGE WIRING BACK TO THE SOURCE AND DISPOSE OF PROPERLY. LABEL ALL SOURCE CIRCUIT BREAKERS IN PANELS 2-1 AND 2-2 AS SPARE AND TURN TO OFF. REMOVE ALL EMERGENCY EGRESS LIGHT FIXTURES AND PRESERVE IF REUSABLE. PRESERVE THE EMERGENCY LIGHTING BRANCH CIRCUIT FROM PANEL E-G OR E-H FOR REUSE WITH THE NEW LAYOUT. REMOVE AND PRESERVE ALL FIRE ALARM DEVICES FOR POSSIBLE REUSE INCLUSIVE OF ANNUNCIATING AND INITIATING DEVICES. PRESERVE ALL FIRE ALARM WIRING UNTIL THE FIRE ALARM RENOVATION HAS DETERMINED THAT THE WIRING IS NO LONGER NECESSARY TO SUPPORT ACTIVE DEVICES AND REMOVE AT THAT TIME.

ELECTRICAL DEMOLITION KEY NOTES

- ED 1 NO ELECTRICAL WORK TO BE PERFORMED IN THIS AREA UNDER THIS CONTRACT.
- ED 2 ELECTRICAL DEMOLITION TO OCCUR IN THIS AREA. REMOVE EQUIPMENT AS REQUIRED AND MAKE SAFE.
- ED 3 ELECTRICAL WORK TO BE PERFORMED IN THIS AREA UNDER THIS CONTRACT. PRESERVE EXISTING ELECTRICAL FIXTURES AND EQUIPMENT IN THIS AREA UNLESS NOTED OTHERWISE. REMOVE, STORE, AND REINSTALL AS NECESSARY DURING CONSTRUCTION. REFER TO MECHANICAL DESIGN DRAWINGS AND ARCHITECTURAL DRAWINGS TO IDENTIFY SCOPE OF WORK INVOLVED WITH CEILING GRID REMOVAL. REMOVE LIGHT FIXTURES AT DESIGNATED AREAS OF GRID REMOVAL TO FACILITATE INSTALLATION OF NEW HVAC SYSTEMS. REINSTALL LIGHTING FIXTURES AFTER CEILING GRID HAS BEEN REINSTALLED.
- ED 4 EXISTING ELECTRICAL PANELS TO REMAIN. ANY REMOVED BRANCH CIRCUITS SHALL BE RELABELLED AS SPARE IN THE DIRECTORY AND THE CIRCUIT BREAKER PLACED IN THE OFF POSITION.

ELECTRICAL DEMOLITION NOTES

1. ALL FLUORESCENT LIGHTING FIXTURES SHALL BE REMOVED AND PROPERLY DISPOSED OF. ALL LAMPS SHALL BE RECYCLED REGARDLESS IF THEY ARE TCLP COMPLIANT.
2. ALL HAZARDOUS MATERIALS SHALL BE DISPOSED OF IN CONFORMANCE WITH UNIVERSAL WASTE RULES.
3. ALL SURFACE RACEWAY THAT IS REMOVED SHALL BE PRESERVED FOR REUSE. THE EC SHALL CONFIRM WITH THE OWNER REGARDING STORAGE OR DISPOSAL OF ANY UNUSED RACEWAY AT THE COMPLETION OF THE PROJECT.
4. PROVIDE 4" DEEP EXTENSION RINGS FOR ALL BACKBOXES REQUIRED AS EXISTING TO REMAIN WITHIN AREAS THAT ARE BEING FURRED OUT. CONFIRM ALL LOCATIONS AND EXACT DEPTHS WITH ARCHITECTURAL DRAWINGS.
5. ALL EXISTING FIRE ALARM ANNUNCIATING DEVICES SHALL BE EXISTING TO REMAIN. ALL EXISTING FIRE ALARM INITIATING DEVICES SHALL BE UPGRADED TO ADDRESSABLE THROUGHOUT THE SECOND AND THIRD FLOORS. COORDINATE REMOVAL OF DEVICES WITH THE PROPOSED MODERNIZATION SCOPE. INCORPORATE FIRE WATCH SERVICES TO MONITOR THE SPACE WHILE NEW DEVICES ARE BEING INSTALLED AND ACTIVATED.
6. ALL SMOKE DETECTORS SHALL BE PROTECTED DURING CONSTRUCTION.
7. WAP DEVICES IN CORRIDORS ARE EXISTING TO REMAIN. REMOVE, PRESERVE AND REINSTALL AFTER NEW CEILING IS IN PLACE.
8. THE OWNER WILL REMOVE PROJECTORS AND SMARTBOARDS PRIOR TO CONSTRUCTION ACTIVITY. THE EC SHALL PRESERVE FOR REUSE ALL EXTRON SYSTEMS, SPEAKER SYSTEMS, PROJECTOR CABLING, SPEAKER WIRING, AND REINSTALL AFTER NEW FINISHES AND CEILING ARE COMPLETE. REFER TO EXTRON #AAP102 DOCUMENTATION PROVIDED BY THE OWNER FOR INSTALLATION REQUIREMENTS.
9. WHERE EXISTING CLASSROOM OR OFFICE LIGHTING IS REMOVED, ALL POWER WIRING SHALL BE DISCONNECTED AND REMOVED. THE EXISTING BACKBOXES AND CONDUITS FOR LIGHTING SWITCHES SHALL BE PRESERVED FOR REUSE. SEE DEMOLITION SCOPE NOTE IN ROOM 220 FOR LIGHTING DEMOLITION PERTAINING TO THIS LOCATION.
10. EXISTING POWER CIRCUITS FOR WINDOW AC UNITS AND CONVENIENCE RECEPTACLES SHALL BE REMOVED BACK TO THE SOURCE UNLESS NOTED OTHERWISE.

1 ELECTRICAL DEMOLITION SECOND FLOOR PLAN-NORTH
 SCALE: 1/8" = 1'-0"


| drawing title | | | STATE OF CONNECTICUT | | |
|--|---------|-------------------------------|--|-----------------------------|-------------|
| SECOND FLOOR - NORTH DEMO PARTIAL PLAN | | | DEPARTMENT OF ADMINISTRATIVE SERVICES | | |
| REVISIONS | | | | | |
| mark | date | description | drawing prepared by | date | |
| | 8/4/17 | SCHEMATIC DESIGN SUBMISSION | CONSULTING ENGINEERING SERVICES, INC. 811 MIDDLE STREET MIDDLETOWN, CT | 07/25/18 | |
| | 1/15/18 | DESIGN DEVELOPMENT SUBMISSION | | scale | AS NOTED |
| | 4/16/18 | CONSTRUCTION DOCUMENTS | | project | drawn by |
| | 5/23/18 | | | WESTERN CT STATE UNIVERSITY | MAL |
| | 7/25/18 | | | WHITE HALL | approved by |
| | 12/1/19 | | 2ND AND 3RD FLOOR RENOVATIONS | SJM | |
| | | | DANBURY, CONNECTICUT | drawing no. | ED1.01 |
| | | | CAD no. | project no. | BI-RD-299 |

ELECTRICAL DEMOLITION KEY NOTES

- ED 1 NO ELECTRICAL WORK TO BE PERFORMED IN THIS AREA UNDER THIS CONTRACT.
- ED 2 ELECTRICAL DEMOLITION TO OCCUR IN THIS AREA. REMOVE EQUIPMENT AS REQUIRED AND MAKE SAFE.
- ED 3 ELECTRICAL WORK TO BE PERFORMED IN THIS AREA UNDER THIS CONTRACT. PRESERVE EXISTING ELECTRICAL FIXTURES AND EQUIPMENT IN THIS AREA UNLESS NOTED OTHERWISE. REMOVE, STORE, AND REINSTALL AS NECESSARY DURING CONSTRUCTION. REFER TO MECHANICAL DESIGN DRAWINGS AND ARCHITECTURAL DRAWINGS TO IDENTIFY SCOPE OF WORK INVOLVED WITH CEILING GRID REMOVAL. REMOVE LIGHT FIXTURES AT DESIGNATED AREAS OF GRID REMOVAL TO FACILITATE INSTALLATION OF NEW HVAC SYSTEMS. REINSTALL LIGHTING FIXTURES AFTER CEILING GRID HAS BEEN REINSTALLED.
- ED 4 EXISTING ELECTRICAL PANELS TO REMAIN. ANY REMOVED BRANCH CIRCUITS SHALL BE RELABELLED AS SPARE IN THE DIRECTORY AND THE CIRCUIT BREAKER PLACED IN THE OFF POSITION.


ELECTRICAL DEMOLITION NOTES

1. ALL FLUORESCENT LIGHTING FIXTURES SHALL BE REMOVED AND PROPERLY DISPOSED OF. ALL LAMPS SHALL BE RECYCLED REGARDLESS IF THEY ARE TCLP COMPLIANT.
2. ALL HAZARDOUS MATERIALS SHALL BE DISPOSED OF IN CONFORMANCE WITH UNIVERSAL WASTE RULES.
3. ALL SURFACE RACEWAY THAT IS REMOVED SHALL BE PRESERVED FOR REUSE. THE EC SHALL CONFIRM WITH THE OWNER REGARDING STORAGE OR DISPOSAL OF ANY UNUSED RACEWAY AT THE COMPLETION OF THE PROJECT.
4. PROVIDE 4" DEEP EXTENSION RINGS FOR ALL BACKBOXES REQUIRED AS EXISTING TO REMAIN WITHIN AREAS THAT ARE BEING FURRED OUT. CONFIRM ALL LOCATIONS AND EXACT DEPTHS WITH ARCHITECTURAL DRAWINGS.
5. ALL EXISTING FIRE ALARM ANNUCIATING DEVICES SHALL BE EXISTING TO REMAIN. ALL EXISTING FIRE ALARM INITIATING DEVICES SHALL BE UPGRADED TO ADDRESSABLE THROUGHOUT THE SECOND AND THIRD FLOORS. COORDINATE REMOVAL OF DEVICES WITH THE PROPOSED MODERNIZATION SCOPE. INCORPORATE FIRE WATCH SERVICES TO MONITOR THE SPACE WHILE NEW DEVICES ARE BEING INSTALLED AND ACTIVATED.
6. ALL SMOKE DETECTORS SHALL BE PROTECTED DURING CONSTRUCTION.
7. WAP DEVICES IN CORRIDORS ARE EXISTING TO REMAIN. REMOVE, PRESERVE AND REINSTALL AFTER NEW CEILING IS IN PLACE.
8. THE OWNER WILL REMOVE PROJECTORS AND SMARTBOARDS PRIOR TO CONSTRUCTION ACTIVITY. THE EC SHALL PRESERVE FOR REUSE ALL EXTRON SYSTEMS, SPEAKER SYSTEMS, PROJECTOR CABLING, SPEAKER WIRING, AND REINSTALL AFTER NEW FINISHES AND CEILING ARE COMPLETE. REFER TO EXTRON #AAP102 DOCUMENTATION PROVIDED BY THE OWNER FOR INSTALLATION REQUIREMENTS.
9. WHERE EXISTING CLASSROOM OR OFFICE LIGHTING IS REMOVED, ALL POWER WIRING SHALL BE DISCONNECTED AND REMOVED. THE EXISTING BACKBOXES AND CONDUITS FOR LIGHTING SWITCHES SHALL BE PRESERVED FOR REUSE. SEE DEMOLITION SCOPE NOTE IN ROOM 220 FOR LIGHTING DEMOLITION PERTAINING TO THIS LOCATION.
10. EXISTING POWER CIRCUITS FOR WINDOW AC UNITS AND CONVENIENCE RECEPTACLES SHALL BE REMOVED BACK TO THE SOURCE UNLESS NOTED OTHERWISE.

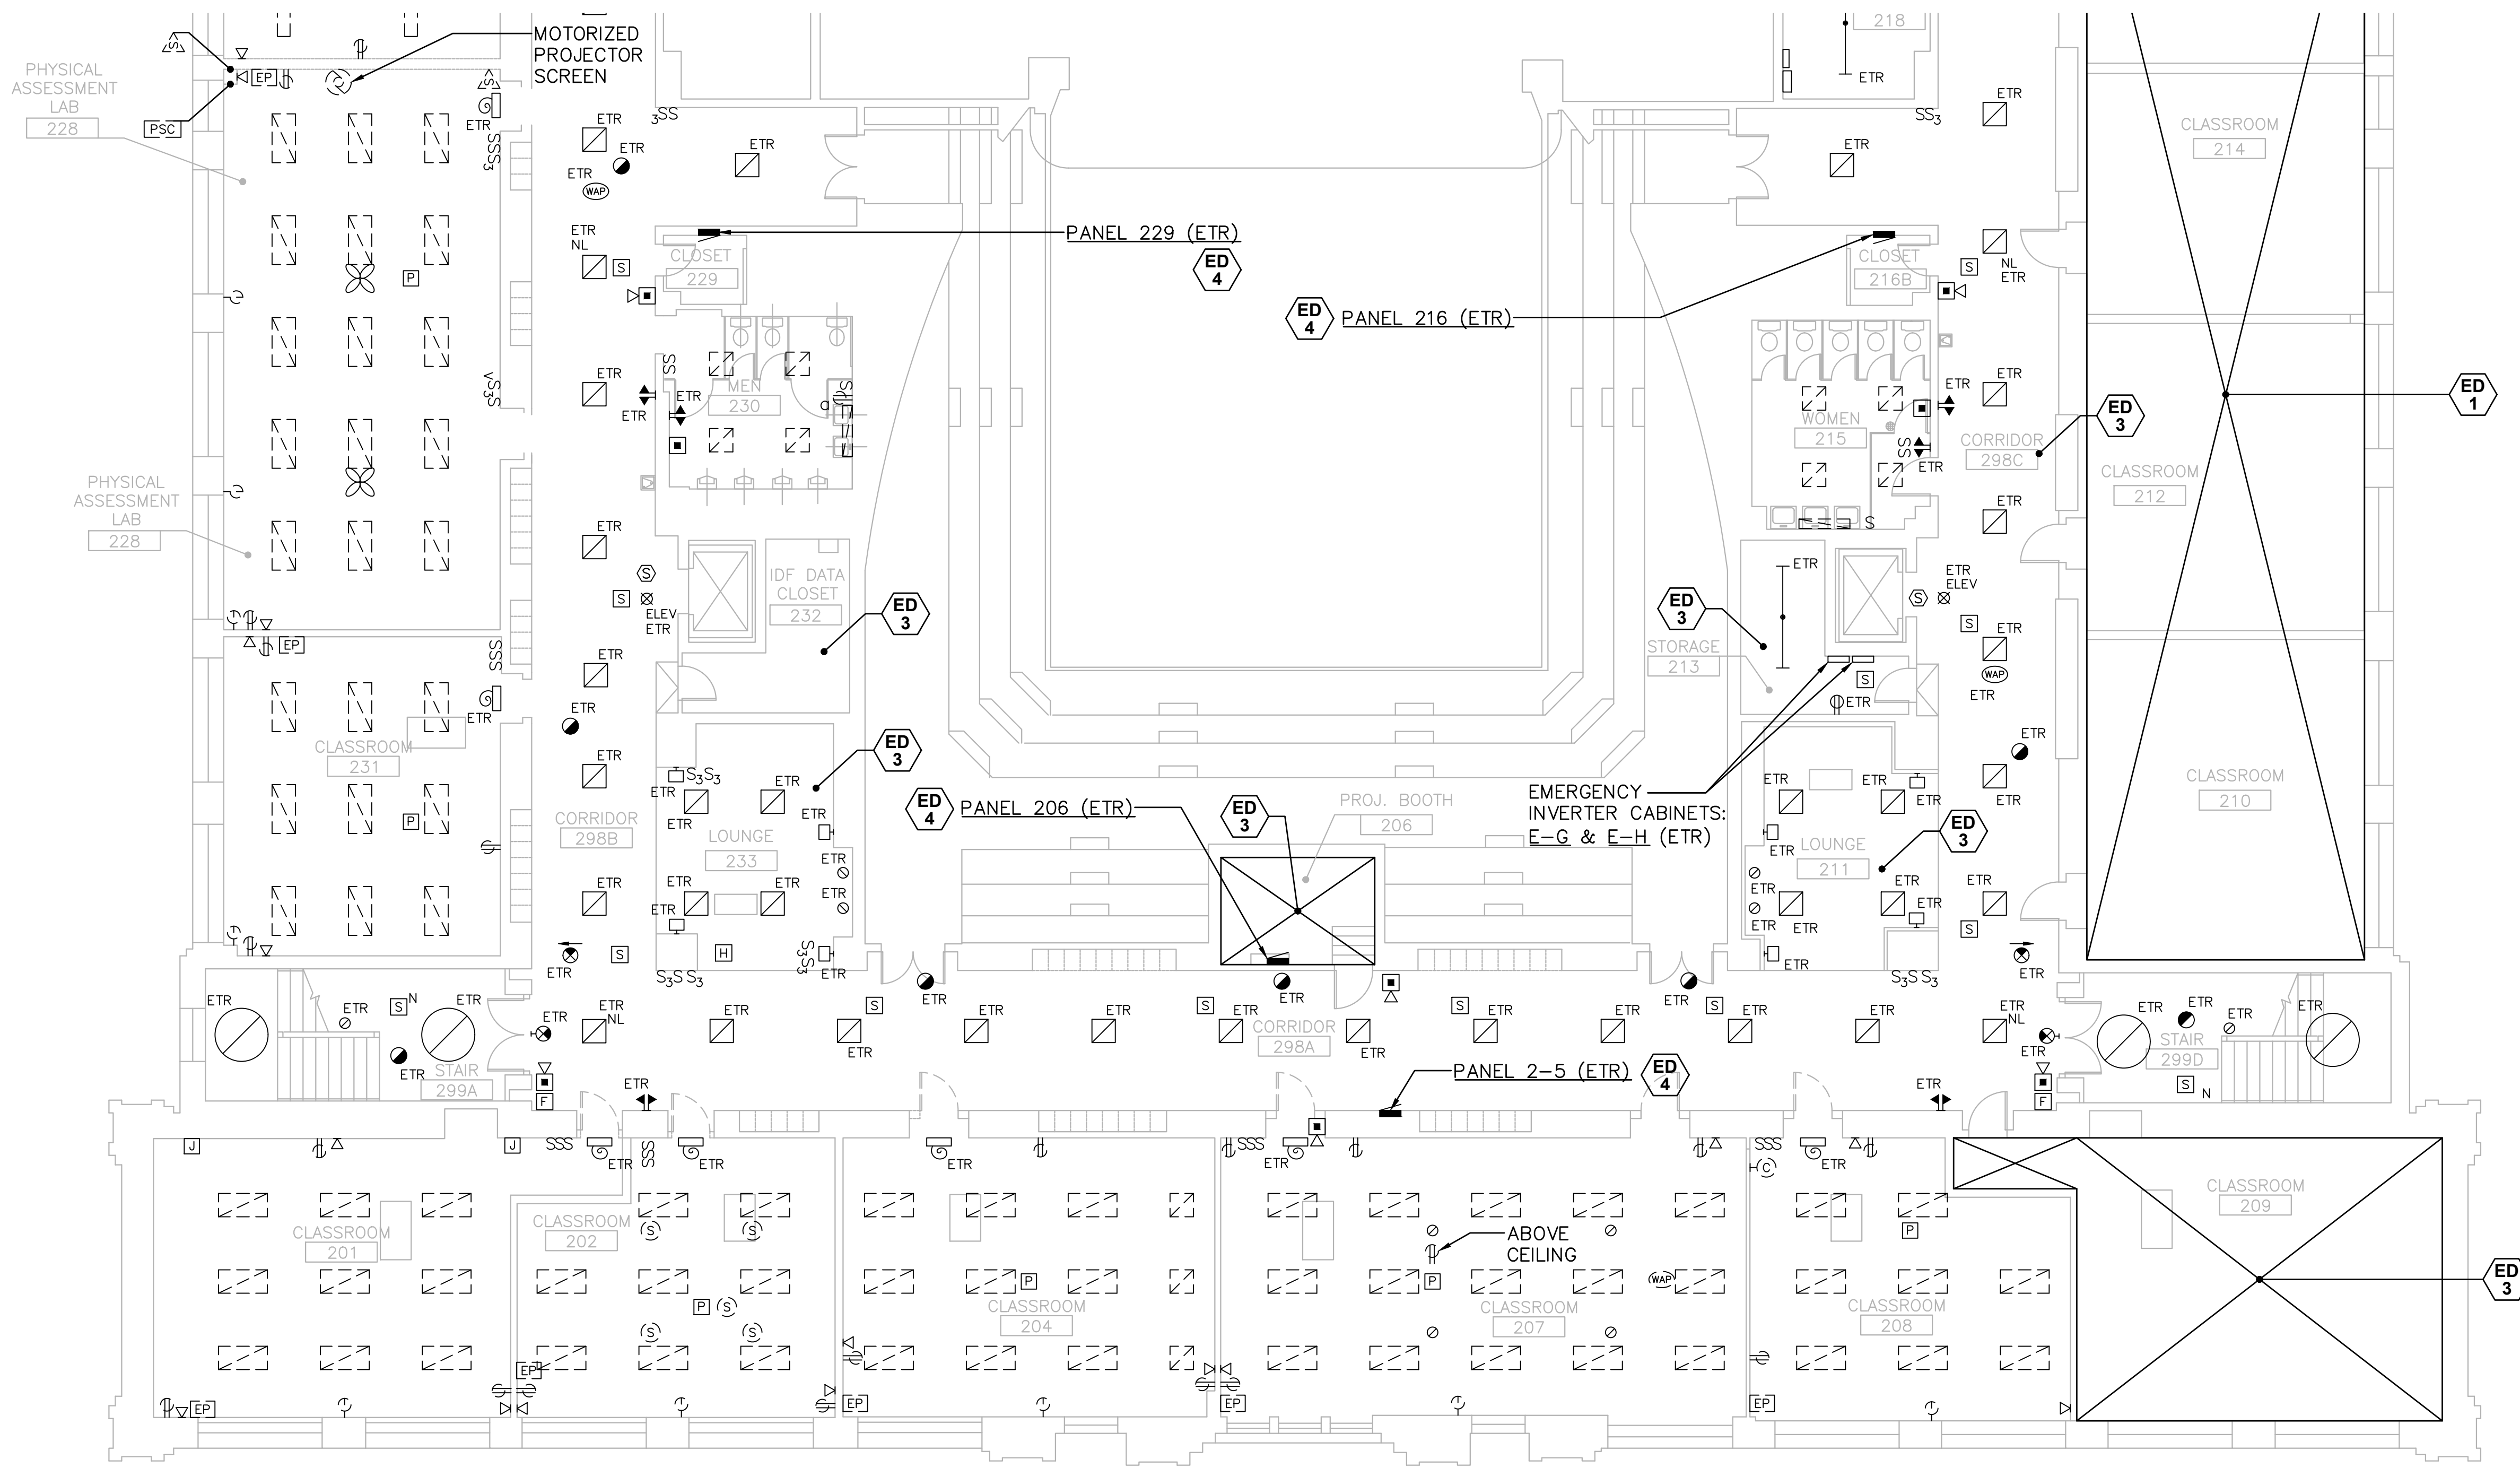

1 ELECTRICAL DEMOLITION SECOND FLOOR PLAN-SOUTH
SCALE: 1/8" = 1'-0"

| | | | |
|---|---|--|--------------------|
| drawing title SECOND FLOOR - SOUTH DEMO PARTIAL PLAN | | STATE OF CONNECTICUT DEPARTMENT OF ADMINISTRATIVE SERVICES | |
| REVISIONS | | | |
| mark | date | description | |
| | 8/4/17 | SCHEMATIC DESIGN SUBMISSION | |
| | 1/15/18 | DESIGN DEVELOPMENT SUBMISSION | |
| | 4/16/18 5/23/18 7/25/18 12/21/19 | CONSTRUCTION DOCUMENTS | |
| drawing prepared by CONSULTING ENGINEERING SERVICES, INC. 811 MIDDLE STREET MIDDLETOWN, CT | | date 07/25/18 | scale AS NOTED |
| project WESTERN CT STATE UNIVERSITY WHITE HALL 2ND AND 3RD FLOOR RENOVATIONS DANBURY, CONNECTICUT | | drawn by MAL | approved by SJM |
| CAD no. | project no. BI-RD-299 | drawing no. | ED1.02 |

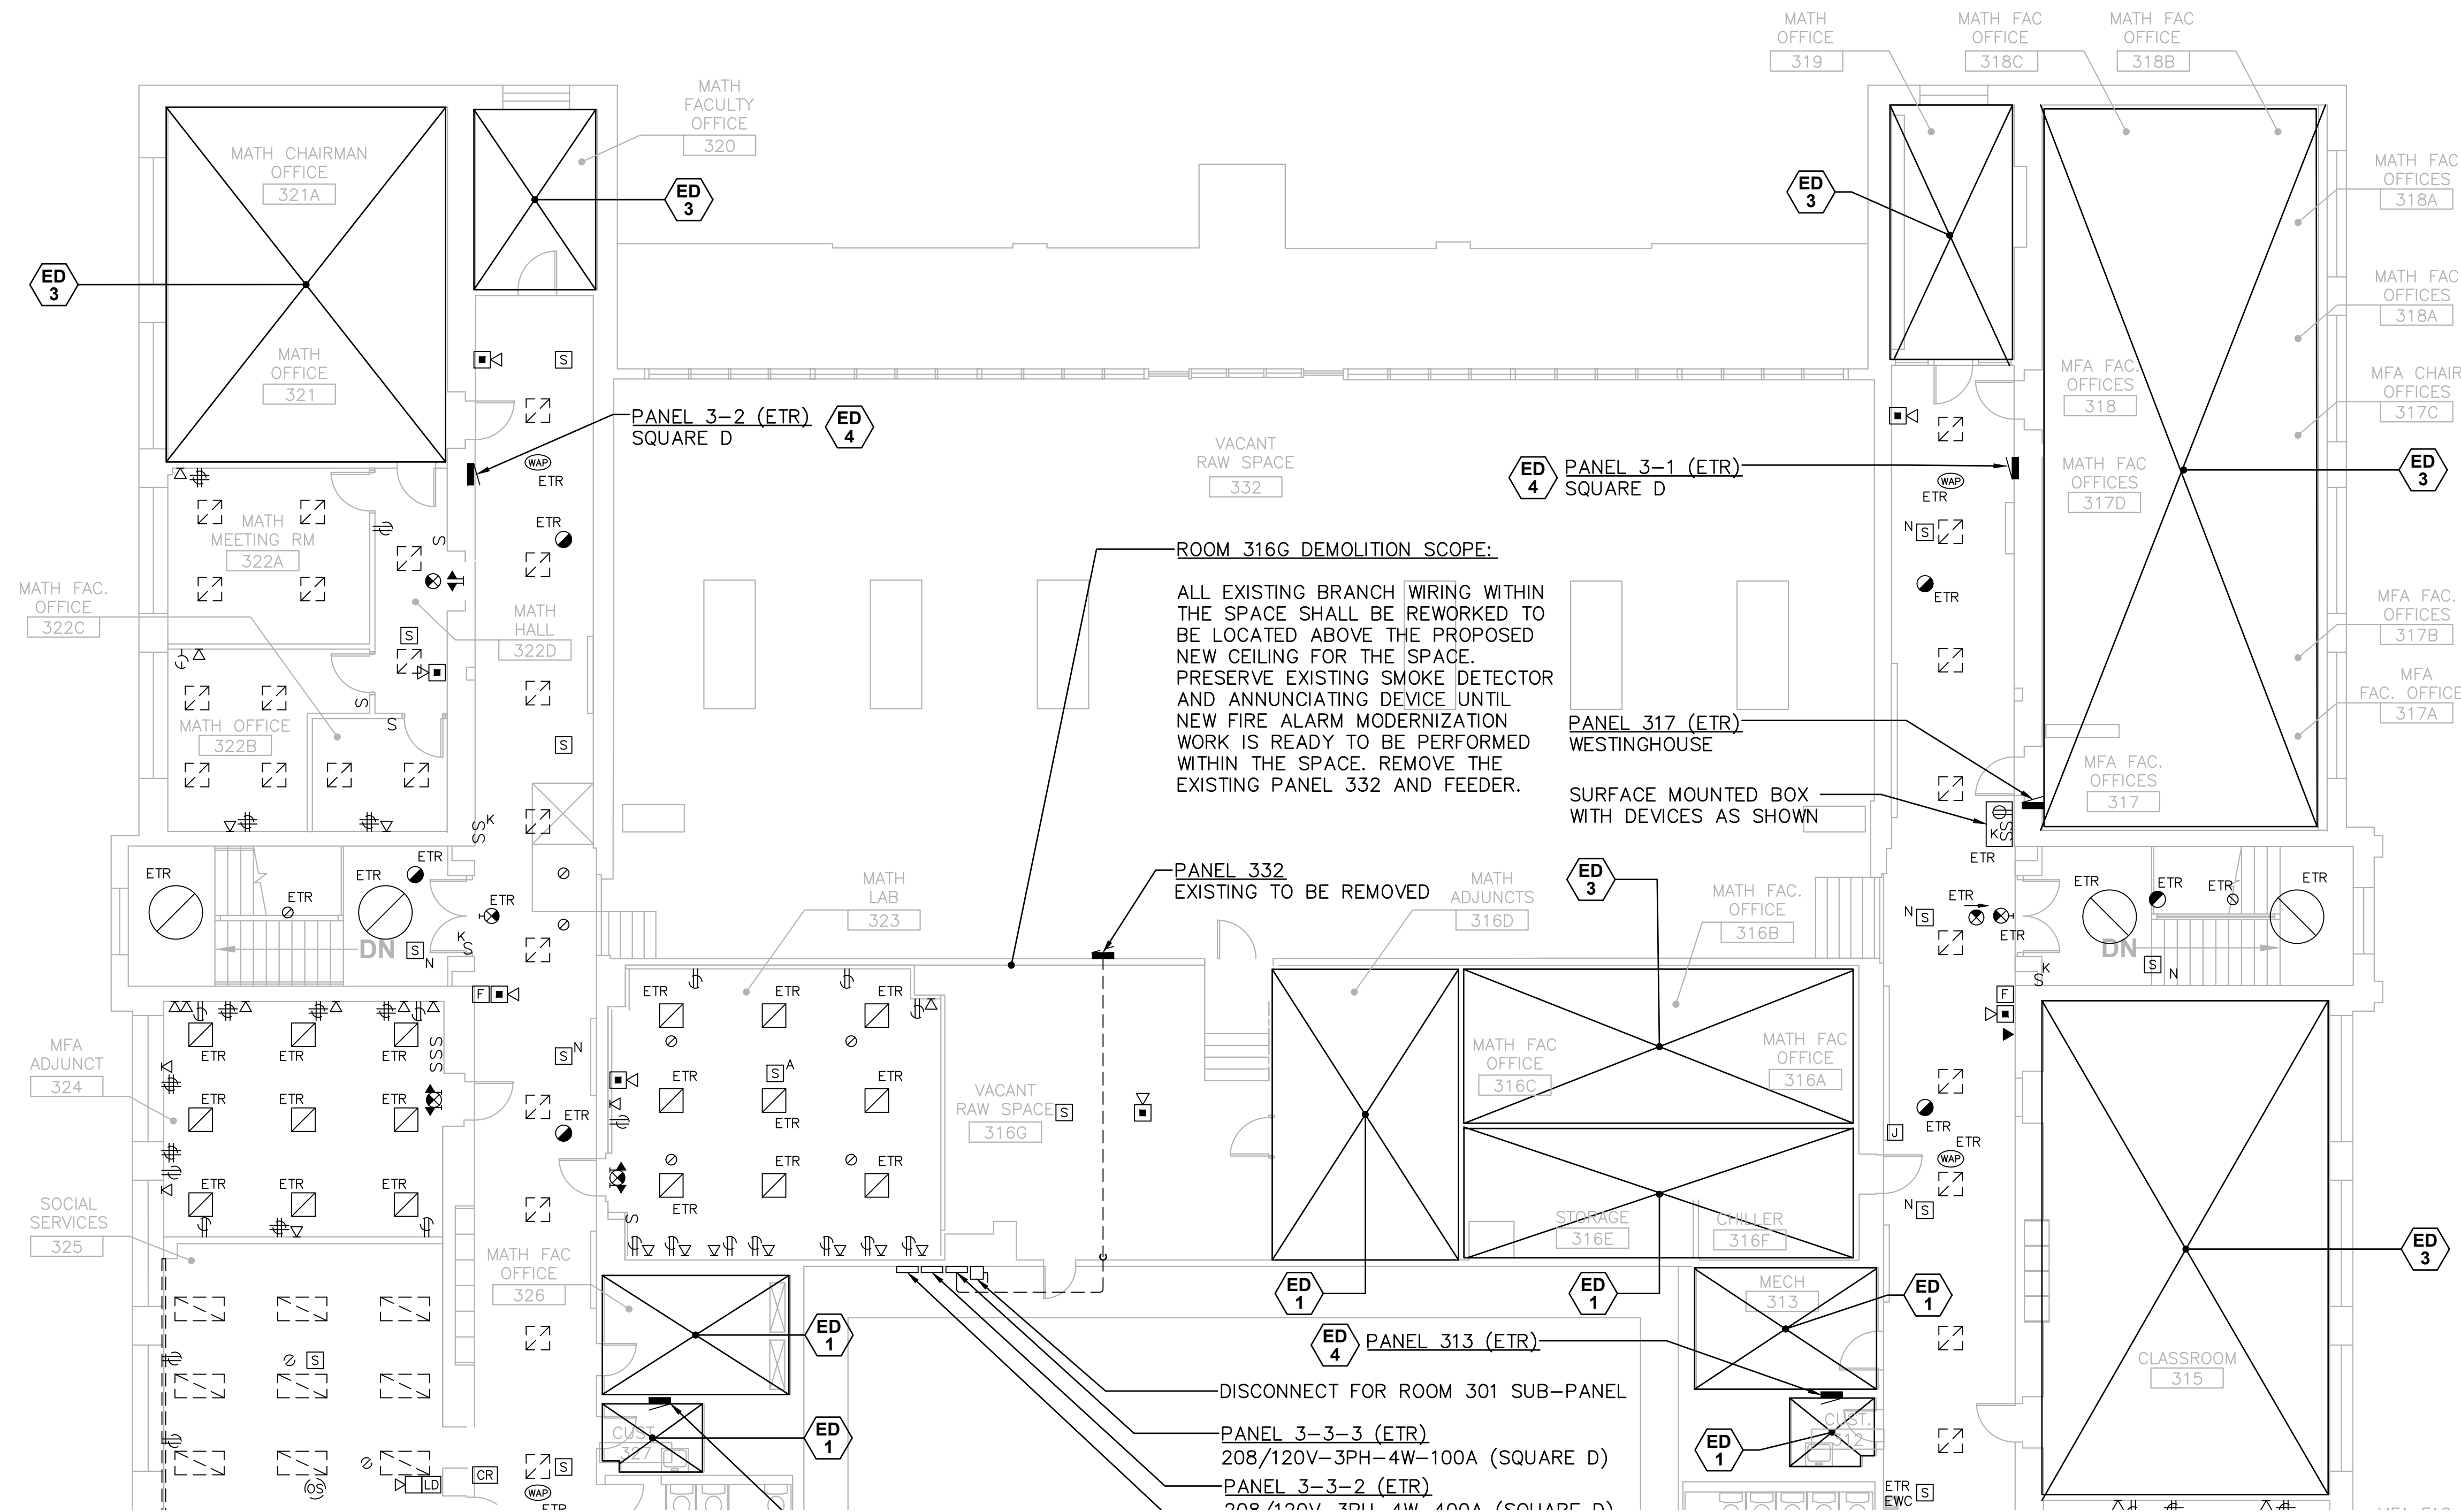


ROOM 316G DEMOLITION SCOPE:
 ALL EXISTING BRANCH WIRING WITHIN THE SPACE SHALL BE REWORKED TO BE LOCATED ABOVE THE PROPOSED NEW CEILING FOR THE SPACE. PRESERVE EXISTING SMOKE DETECTOR AND ANNUNCIATING DEVICE UNTIL NEW FIRE ALARM MODERNIZATION WORK IS READY TO BE PERFORMED WITHIN THE SPACE. REMOVE THE EXISTING PANEL 332 AND FEEDER.

1 ELECTRICAL DEMOLITION THIRD FLOOR PLAN-NORTH
 SCALE: 1/8"=1'-0"

- ELECTRICAL DEMOLITION KEY NOTES**
- ED 1 NO ELECTRICAL WORK TO BE PERFORMED IN THIS AREA UNDER THIS CONTRACT.
 - ED 2 ELECTRICAL DEMOLITION TO OCCUR IN THIS AREA. REMOVE EQUIPMENT AS REQUIRED AND MAKE SAFE.
 - ED 3 ELECTRICAL WORK TO BE PERFORMED IN THIS AREA UNDER THIS CONTRACT. PRESERVE EXISTING ELECTRICAL FIXTURES AND EQUIPMENT IN THIS AREA UNLESS NOTED OTHERWISE. REMOVE, STORE, AND REINSTALL AS NECESSARY DURING CONSTRUCTION. REFER TO MECHANICAL DESIGN DRAWINGS AND ARCHITECTURAL DRAWINGS TO IDENTIFY SCOPE OF WORK INVOLVED WITH CEILING GRID REMOVAL. REMOVE LIGHT FIXTURES AT DESIGNATED AREAS OF GRID REMOVAL TO FACILITATE INSTALLATION OF NEW HVAC SYSTEMS. REINSTALL LIGHTING FIXTURES AFTER CEILING GRID HAS BEEN REINSTALLED.
 - ED 4 EXISTING ELECTRICAL PANELS TO REMAIN. ANY REMOVED BRANCH CIRCUITS SHALL BE RELABELLED AS SPARE IN THE DIRECTORY AND THE CIRCUIT BREAKER PLACED IN THE OFF POSITION.

- ELECTRICAL DEMOLITION NOTES**
1. ALL FLUORESCENT LIGHTING FIXTURES SHALL BE REMOVED AND PROPERLY DISPOSED OF. ALL LAMPS SHALL BE RECYCLED REGARDLESS IF THEY ARE TCLP COMPLIANT.
 2. ALL HAZARDOUS MATERIALS SHALL BE DISPOSED OF IN CONFORMANCE WITH UNIVERSAL WASTE RULES.
 3. ALL SURFACE RACEWAY THAT IS REMOVED SHALL BE PRESERVED FOR REUSE. THE EC SHALL CONFIRM WITH THE OWNER REGARDING STORAGE OR DISPOSAL OF ANY UNUSED RACEWAY AT THE COMPLETION OF THE PROJECT.
 4. PROVIDE 4" DEEP EXTENSION RINGS FOR ALL BACKBOXES AS EXISTING TO REMAIN WITHIN AREAS THAT ARE BEING FURRED OUT. CONFIRM ALL LOCATIONS AND EXACT DEPTHS WITH ARCHITECTURAL DRAWINGS.
 5. ALL EXISTING FIRE ALARM ANNUNCIATING DEVICES SHALL BE EXISTING TO REMAIN. ALL EXISTING FIRE ALARM INITIATING DEVICES SHALL BE UPGRADED TO ADDRESSABLE THROUGHOUT THE SECOND AND THIRD FLOORS. COORDINATE REMOVAL OF DEVICES WITH THE PROPOSED MODERNIZATION SCOPE. INCORPORATE FIRE WATCH SERVICES TO MONITOR THE SPACE WHILE NEW DEVICES ARE BEING INSTALLED AND ACTIVATED.
 6. ALL SMOKE DETECTORS SHALL BE PROTECTED DURING CONSTRUCTION.
 7. WAP DEVICES IN CORRIDORS ARE EXISTING TO REMAIN. REMOVE, PRESERVE AND REINSTALL AFTER NEW CEILING IS IN PLACE.
 8. THE OWNER WILL REMOVE PROJECTORS AND SMARTBOARDS PRIOR TO CONSTRUCTION ACTIVITY. THE EC SHALL PRESERVE FOR REUSE ALL EXTRON SYSTEMS, SPEAKER SYSTEMS, PROJECTOR CABLING, SPEAKER WIRING, AND REINSTALL AFTER NEW FINISHES AND CEILING ARE COMPLETE. REFER TO EXTRON #AAP102 DOCUMENTATION PROVIDED BY THE OWNER FOR INSTALLATION REQUIREMENTS.
 9. WHERE EXISTING CLASSROOM OR OFFICE LIGHTING IS REMOVED, ALL POWER WIRING SHALL BE DISCONNECTED AND REMOVED. THE EXISTING BACKBOXES AND CONDUITS FOR LIGHTING SWITCHES SHALL BE PRESERVED FOR REUSE. SEE DEMOLITION SCOPE NOTE IN ROOM 220 FOR LIGHTING DEMOLITION PERTAINING TO THIS LOCATION.
 10. EXISTING POWER CIRCUITS FOR WINDOW AC UNITS AND CONVENIENCE RECEPTACLES SHALL BE REMOVED BACK TO THE SOURCE UNLESS NOTED OTHERWISE.


| | | | |
|---|---------|--|---|
| drawing title THIRD FLOOR - NORTH DEMO PARTIAL PLAN | | STATE OF CONNECTICUT DEPARTMENT OF ADMINISTRATIVE SERVICES | |
| REVISIONS | | | |
| mark | date | description | drawing prepared by |
| | 8/4/17 | SCHEMATIC DESIGN SUBMISSION | CONSULTING ENGINEERING SERVICES, INC. 811 MIDDLE STREET MIDDLETOWN, CT |
| | 1/15/18 | DESIGN DEVELOPMENT SUBMISSION | |
| | 4/16/18 | CONSTRUCTION DOCUMENTS | project WESTERN CT STATE UNIVERSITY WHITE HALL 2ND AND 3RD FLOOR RENOVATIONS DANBURY, CONNECTICUT |
| | 5/23/18 | | date 07/25/18 |
| | 7/25/18 | | scale AS NOTED |
| | 12/1/19 | | drawn by MAL |
| | | | approved by SJM |
| | | | drawing no. ED1.03 |
| | | | CAD no. |
| | | | project no. BI-RD-299 |

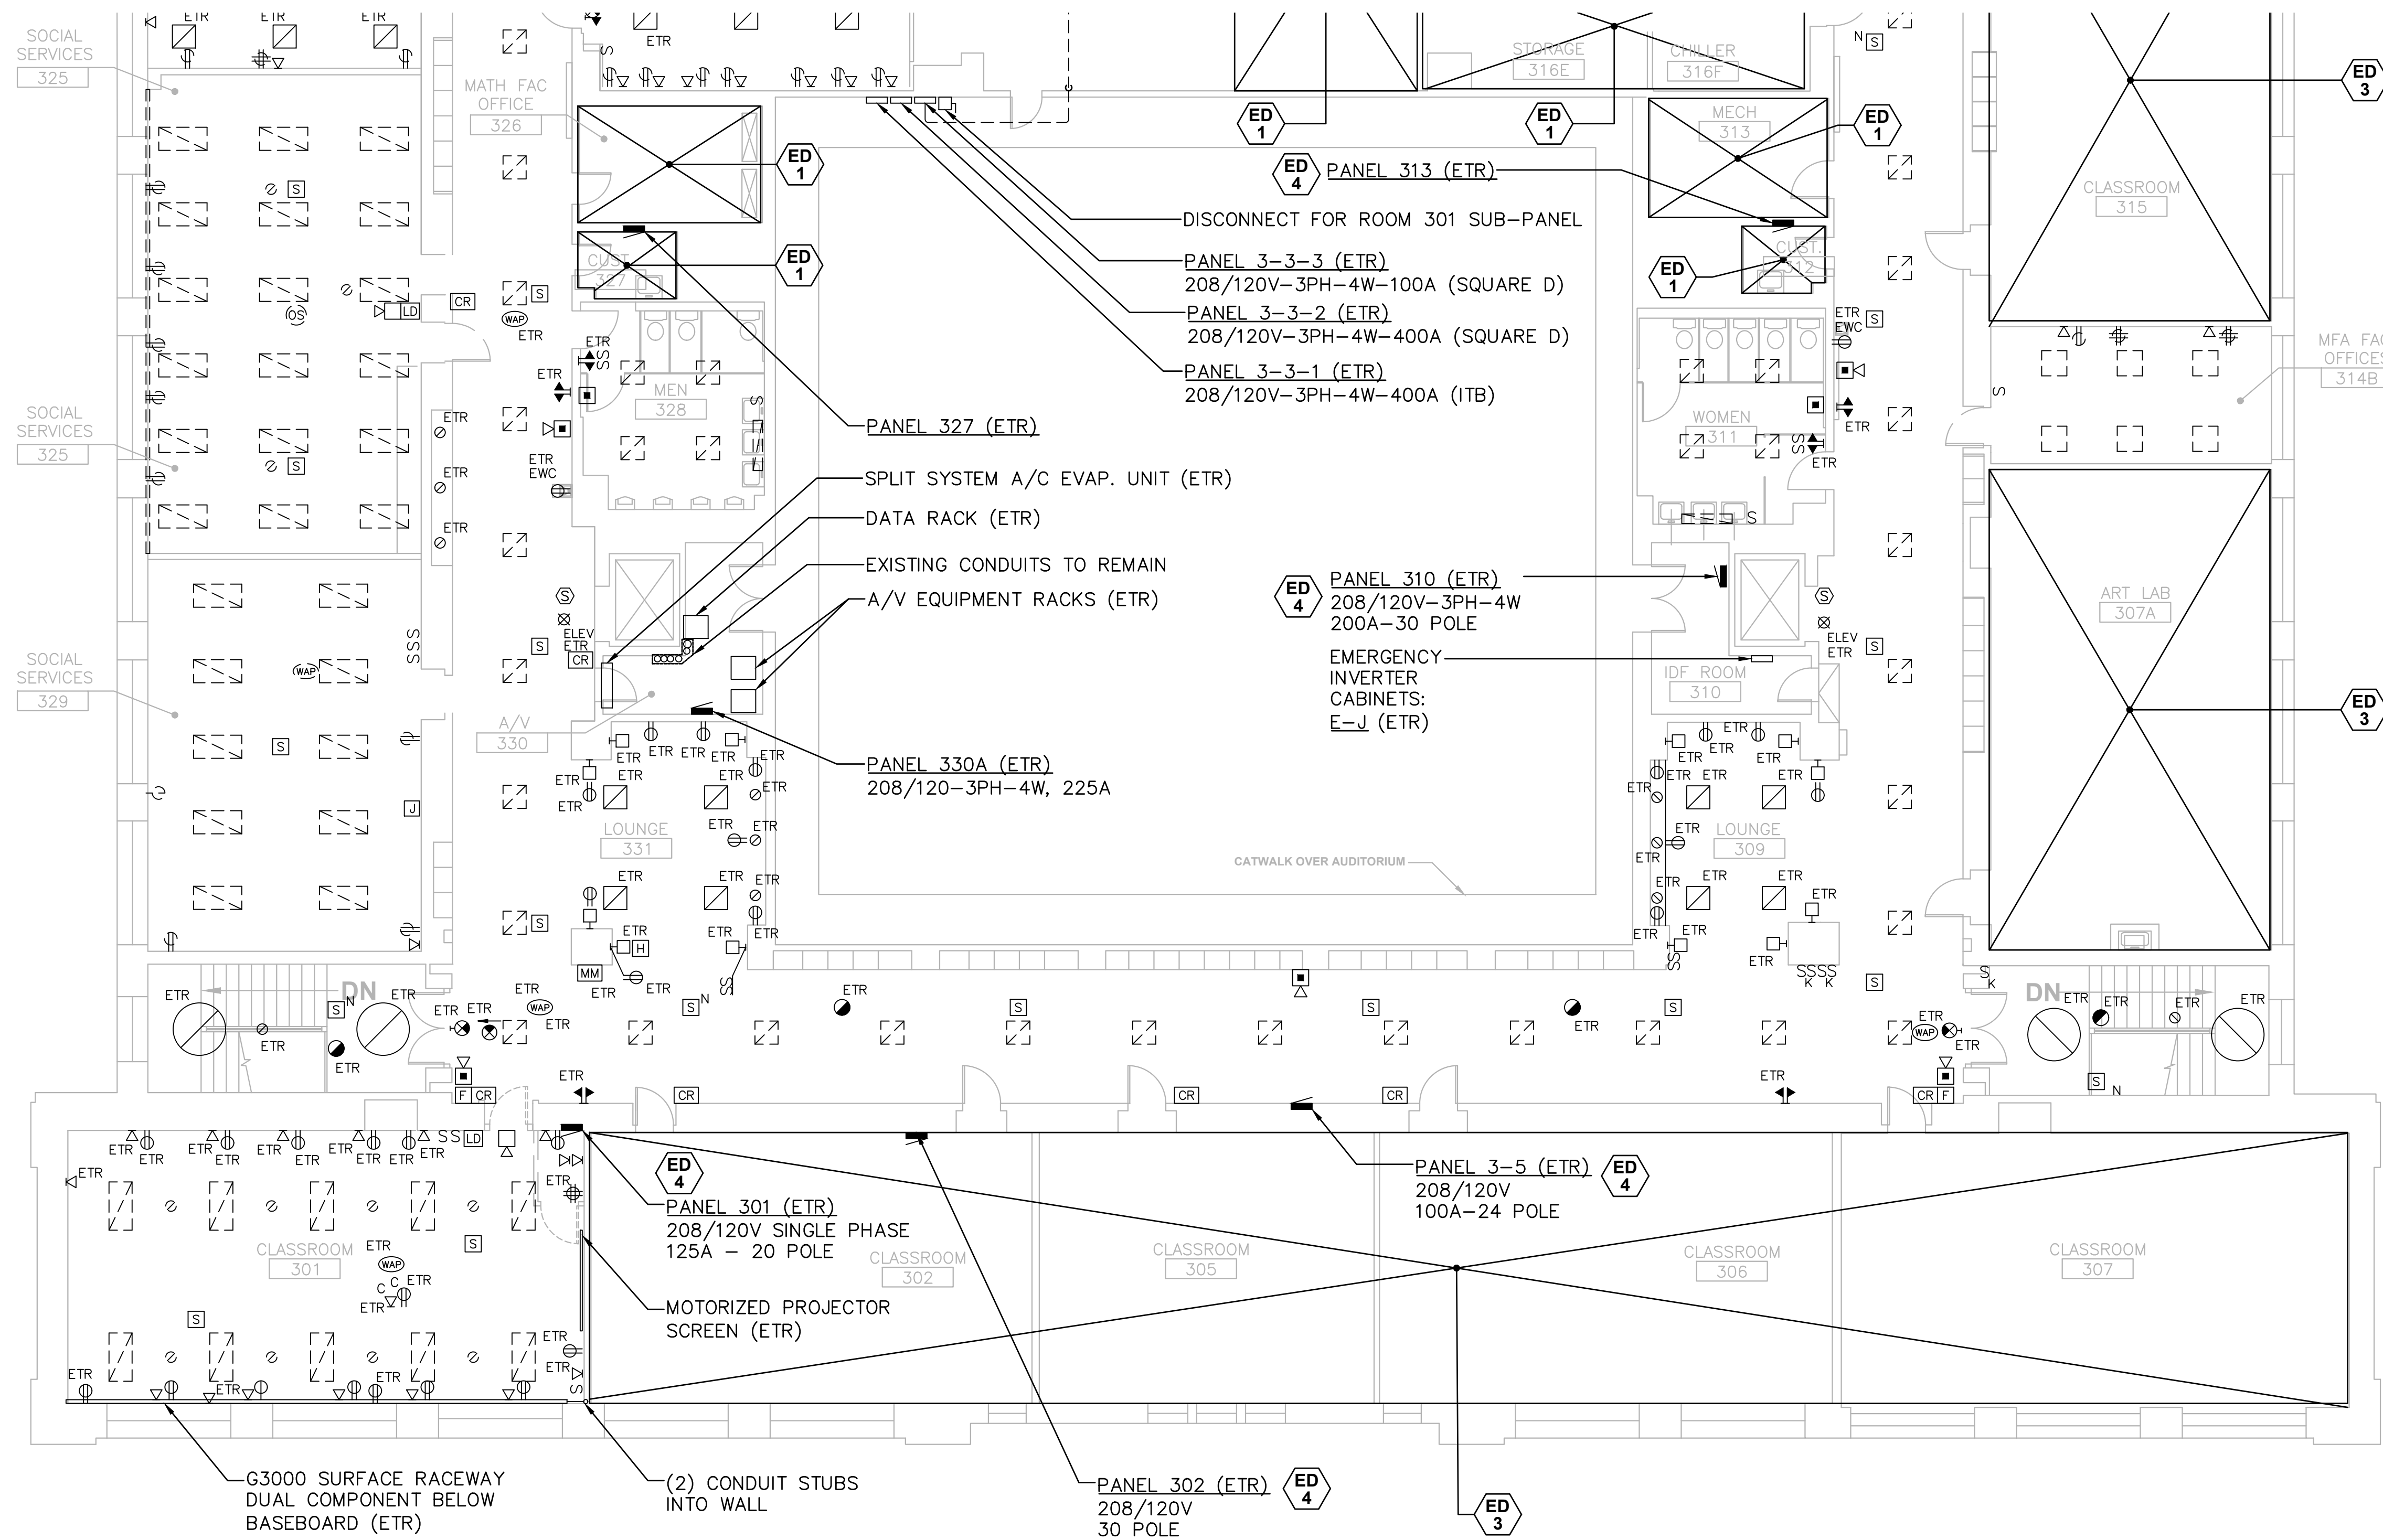

1 ELECTRICAL DEMOLITION THIRD FLOOR PLAN-SOUTH
SCALE: 1/8" = 1'-0"

- ELECTRICAL DEMOLITION KEY NOTES**
- ED 1 NO ELECTRICAL WORK TO BE PERFORMED IN THIS AREA UNDER THIS CONTRACT.
 - ED 2 ELECTRICAL DEMOLITION TO OCCUR IN THIS AREA. REMOVE EQUIPMENT AS REQUIRED AND MAKE SAFE.
 - ED 3 ELECTRICAL WORK TO BE PERFORMED IN THIS AREA UNDER THIS CONTRACT. PRESERVE EXISTING ELECTRICAL FIXTURES AND EQUIPMENT IN THIS AREA UNLESS NOTED OTHERWISE. REMOVE, STORE, AND REINSTALL AS NECESSARY DURING CONSTRUCTION. REFER TO MECHANICAL DESIGN DRAWINGS AND ARCHITECTURAL DRAWINGS TO IDENTIFY SCOPE OF WORK INVOLVED WITH CEILING GRID REMOVAL. REMOVE LIGHT FIXTURES AT DESIGNATED AREAS OF GRID REMOVAL TO FACILITATE INSTALLATION OF NEW HVAC SYSTEMS. REINSTALL LIGHTING FIXTURES AFTER CEILING GRID HAS BEEN REINSTALLED.
 - ED 4 EXISTING ELECTRICAL PANELS TO REMAIN. ANY REMOVED BRANCH CIRCUITS SHALL BE RELABELLED AS SPARE IN THE DIRECTORY AND THE CIRCUIT BREAKER PLACED IN THE OFF POSITION.
- ELECTRICAL DEMOLITION NOTES**
1. ALL FLUORESCENT LIGHTING FIXTURES SHALL BE REMOVED AND PROPERLY DISPOSED OF. ALL LAMPS SHALL BE RECYCLED REGARDLESS IF THEY ARE TCLP COMPLIANT.
 2. ALL HAZARDOUS MATERIALS SHALL BE DISPOSED OF IN CONFORMANCE WITH UNIVERSAL WASTE RULES.
 3. ALL SURFACE RACEWAY THAT IS REMOVED SHALL BE PRESERVED FOR REUSE. THE EC SHALL CONFIRM WITH THE OWNER REGARDING STORAGE OR DISPOSAL OF ANY UNUSED RACEWAY AT THE COMPLETION OF THE PROJECT.
 4. PROVIDE 4" DEEP EXTENSION RINGS FOR ALL BACKBOXES REQUIRED AS EXISTING TO REMAIN WITHIN AREAS THAT ARE BEING FURRED OUT. CONFIRM ALL LOCATIONS AND EXACT DEPTHS WITH ARCHITECTURAL DRAWINGS.
 5. ALL EXISTING FIRE ALARM ANNUNCIATING DEVICES SHALL BE EXISTING TO REMAIN. ALL EXISTING FIRE ALARM INITIATING DEVICES SHALL BE UPGRADED TO ADDRESSABLE THROUGHOUT THE SECOND AND THIRD FLOORS. COORDINATE REMOVAL OF DEVICES WITH THE PROPOSED MODERNIZATION SCOPE. INCORPORATE FIRE WATCH SERVICES TO MONITOR THE SPACE WHILE NEW DEVICES ARE BEING INSTALLED AND ACTIVATED.
 6. ALL SMOKE DETECTORS SHALL BE PROTECTED DURING CONSTRUCTION.
 7. WAP DEVICES IN CORRIDORS ARE EXISTING TO REMAIN. REMOVE, PRESERVE AND REINSTALL AFTER NEW CEILING IS IN PLACE.
 8. THE OWNER WILL REMOVE PROJECTORS AND SMARTBOARDS PRIOR TO CONSTRUCTION ACTIVITY. THE EC SHALL PRESERVE FOR REUSE ALL EXTRON SYSTEMS, SPEAKER SYSTEMS, PROJECTOR CABLING, SPEAKER WIRING, AND REINSTALL AFTER NEW FINISHES AND CEILING ARE COMPLETE. REFER TO EXTRON #AAP102 DOCUMENTATION PROVIDED BY THE OWNER FOR INSTALLATION REQUIREMENTS.
 9. WHERE EXISTING CLASSROOM OR OFFICE LIGHTING IS REMOVED, ALL POWER WIRING SHALL BE DISCONNECTED AND REMOVED. THE EXISTING BACKBOXES AND CONDUITS FOR LIGHTING SWITCHES SHALL BE PRESERVED FOR REUSE. SEE DEMOLITION SCOPE NOTE IN ROOM 220 FOR LIGHTING DEMOLITION PERTAINING TO THIS LOCATION.
 10. EXISTING POWER CIRCUITS FOR WINDOW AC UNITS AND CONVENIENCE RECEPTACLES SHALL BE REMOVED BACK TO THE SOURCE UNLESS NOTED OTHERWISE.

| | | | |
|---|---------|--|---|
| drawing title THIRD FLOOR - SOUTH DEMO PARTIAL PLAN | | STATE OF CONNECTICUT DEPARTMENT OF ADMINISTRATIVE SERVICES | |
| REVISIONS | | | |
| mark | date | description | drawing prepared by |
| | 8/4/17 | SCHEMATIC DESIGN SUBMISSION | CONSULTING ENGINEERING SERVICES, INC. |
| | 1/15/18 | DESIGN DEVELOPMENT SUBMISSION | 811 MIDDLE STREET MIDDLETOWN, CT |
| | 4/16/18 | CONSTRUCTION DOCUMENTS | project WESTERN CT STATE UNIVERSITY WHITE HALL 2ND AND 3RD FLOOR RENOVATIONS DANBURY, CONNECTICUT |
| | 5/23/18 | | date 07/25/18 |
| | 7/25/18 | | scale AS NOTED |
| | 12/1/19 | | drawn by MAL |
| | | | approved by SJM |
| | | | drawing no. ED1.04 |
| | | | CAD no. BI-RD-299 |

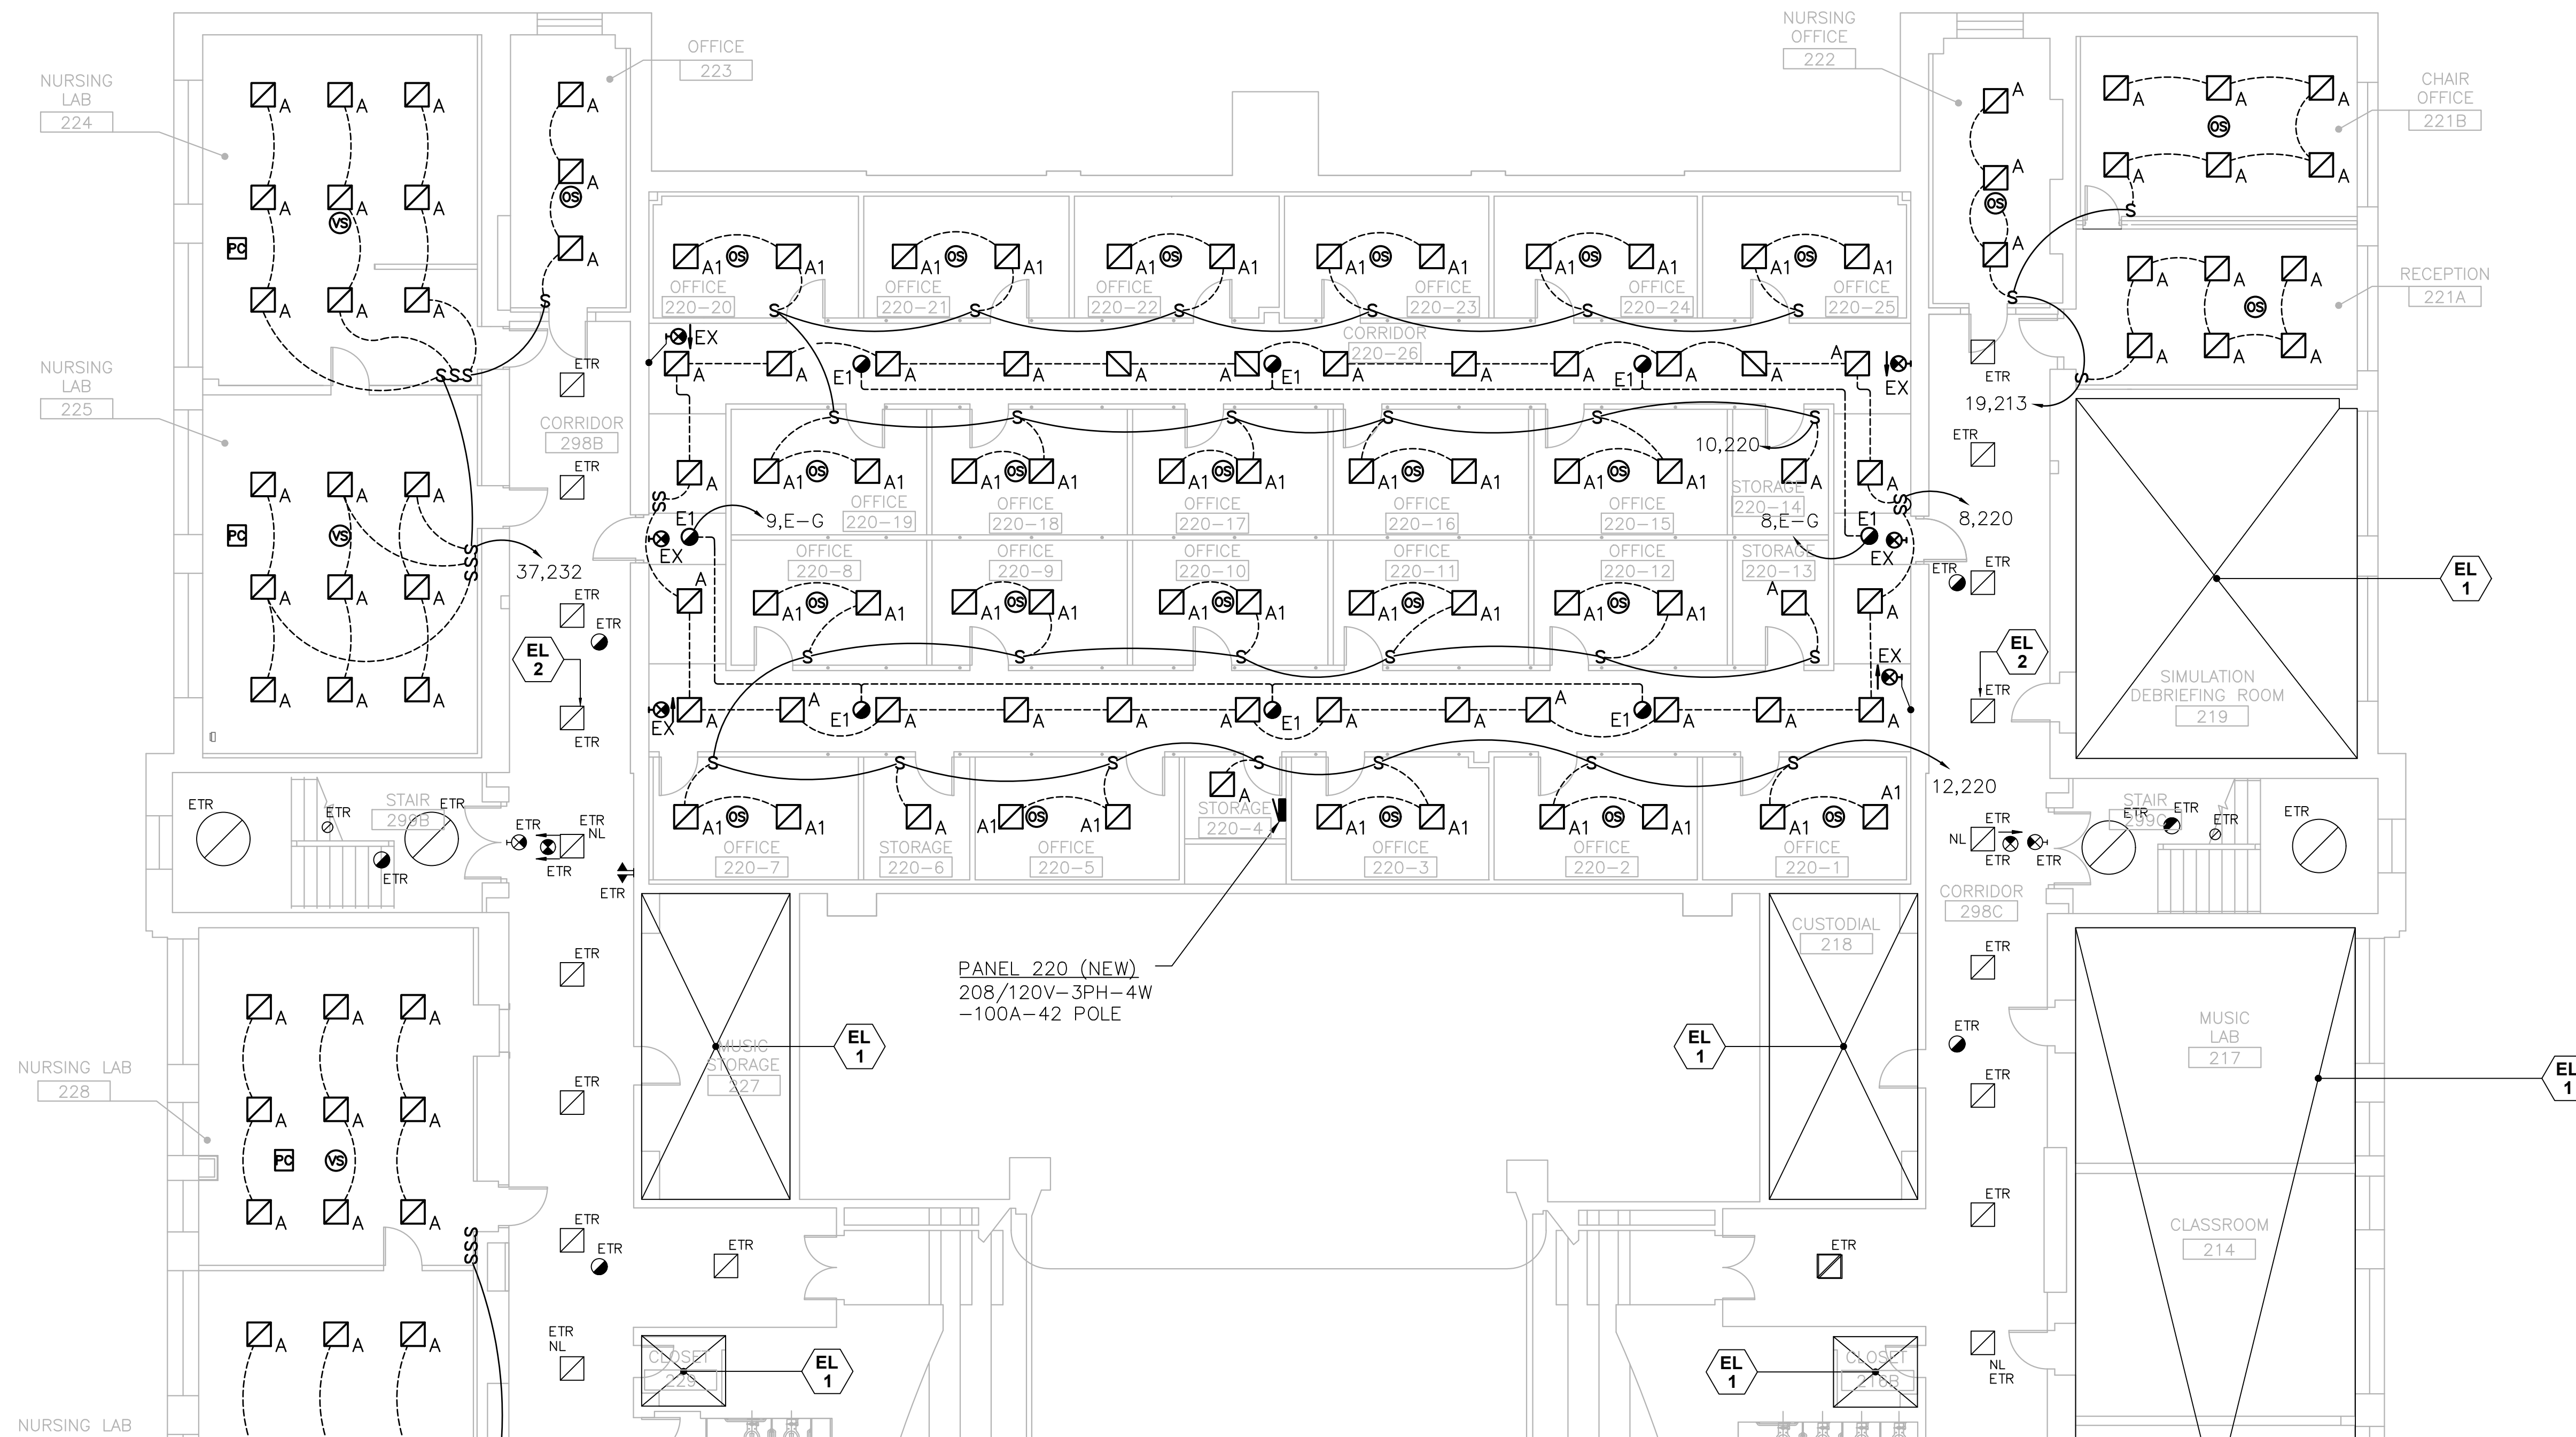


| ELECTRICAL LIGHTING KEY NOTES | |
|-------------------------------|---|
| EL 1 | NO ELECTRICAL WORK TO BE PERFORMED IN THIS AREA UNDER THIS CONTRACT. |
| EL 2 | EXISTING TO REMAIN 2'x2' LIGHTING FIXTURES IN CORRIDOR. FIXTURES SHALL BE REMOVED & REINSTALLED AS REQUIRED FOR ABOVE CEILING WORK. |

- | ELECTRICAL LIGHTING GENERAL NOTES | |
|-----------------------------------|---|
| 1. | NUMBERS INDICATED ADJACENT TO ELECTRICAL DEVICES, FIXTURES AND EQUIPMENT REPRESENTS THE CIRCUIT NUMBER THAT THE CIRCUIT SHALL CONNECT TO. REFER TO CIRCUIT HOMERUNS IDENTIFIED WITHIN THE DRAWING THAT THE EQUIPMENT IS PLACED ON FOR THE PROPER HOMERUN. |
| 2. | CONTRACTOR SHALL VERIFY PROPER OPERATION AND CONDITION OF EXISTING FIXTURES TO REMAIN AND PROVIDE A LIST OF PROBLEMS TO THE CA. |
| 3. | EXISTING CORRIDOR LIGHTING CONTROLS SHALL REMAIN AND BE UTILIZED WITH EXISTING TO REMAIN FIXTURES ON THE SECOND FLOOR AND WITH NEW FIXTURES ON THE THIRD FLOOR. |
| 4. | ALL BRANCH CIRCUITS SHALL BE INSTALLED IN EMT CONDUIT FROM THE PANELBOARD TO THE FIRST DEVICE OR PIECE OF EQUIPMENT ON THE CIRCUIT. WIRING FROM THE FIRST DEVICE TO ADDITIONAL DEVICES SHALL BE INSTALLED IN EMT CONDUIT OR MC CABLE. FLEX CONDUIT (GREENFIELD) WILL BE ALLOWED FOR FINAL WHIP CONNECTIONS OF 6 FEET IN LENGTH OR LESS. TYPE NM AND AC CABLE WILL NOT BE ALLOWED. |

1 ELECTRICAL LIGHTING SECOND FLOOR PLAN-NORTH
SCALE: 1/8" = 1'-0"

| drawing title | | | STATE OF CONNECTICUT DEPARTMENT OF ADMINISTRATIVE SERVICES | | | |
|--|--|-------------------------------|--|--|-----------|--|
| SECOND FLOOR - NORTH LIGHTING PARTIAL PLAN | | | REVISIONS | | | |
| mark | date | description | drawing prepared by | date | scale | |
| | 8/4/17 | SCHEMATIC DESIGN SUBMISSION | CONSULTING ENGINEERING SERVICES, INC. 811 MIDDLE STREET MIDDLETOWN, CT | 07/25/18 | AS NOTED | |
| | 1/15/18 | DESIGN DEVELOPMENT SUBMISSION | | | | |
| | 4/16/18 5/23/18 7/25/18 12/1/19 | CONSTRUCTION DOCUMENTS | | | | |
| | | | project | WESTERN CT STATE UNIVERSITY WHITE HALL 2ND AND 3RD FLOOR RENOVATIONS DANBURY, CONNECTICUT | | |
| | | | drawn by | MAL | | |
| | | | approved by | SJM | | |
| | | | drawing no. | EL1.01 | | |
| | | | CAD no. | project no. | BI-RD-299 | |

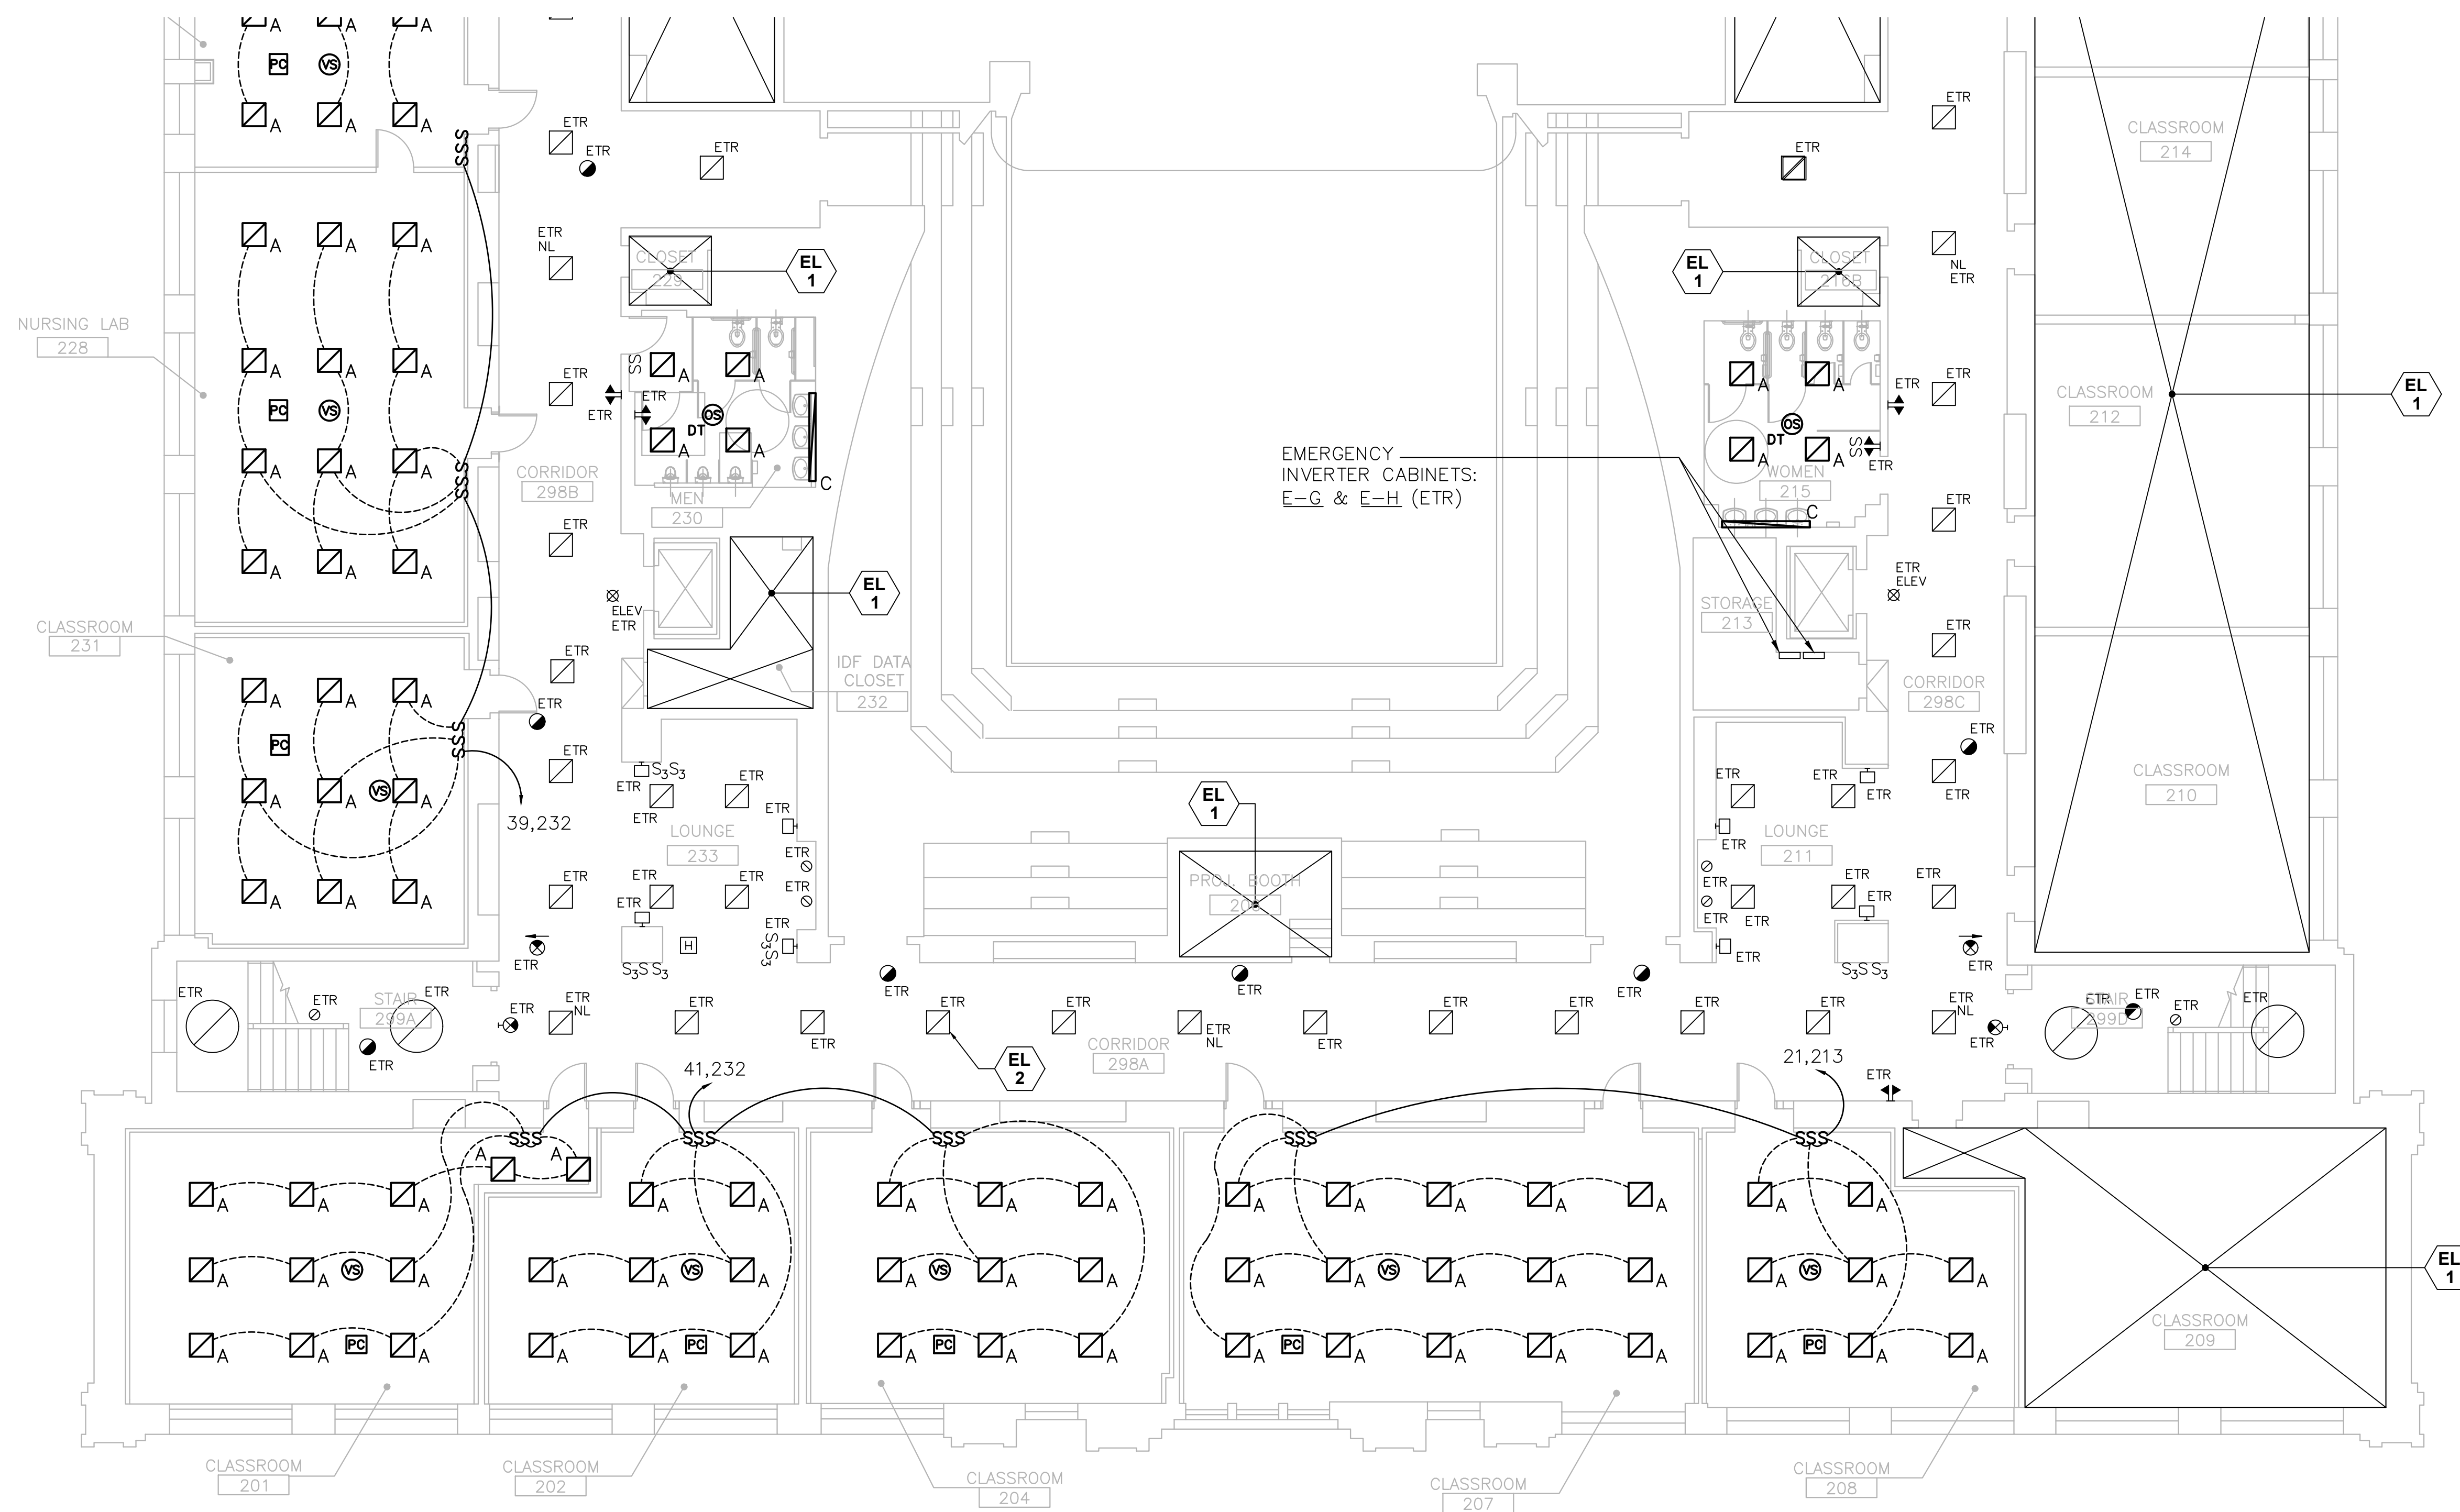

ELECTRICAL LIGHTING KEY NOTES

EL 1 NO ELECTRICAL WORK TO BE PERFORMED IN THIS AREA UNDER THIS CONTRACT.


EL 2 EXISTING TO REMAIN 2x2' LIGHTING FIXTURES IN CORRIDOR. FIXTURES SHALL BE REMOVED & REINSTALLED AS REQUIRED FOR ABOVE CEILING WORK.

ELECTRICAL LIGHTING GENERAL NOTES

- NUMBERS INDICATED ADJACENT TO ELECTRICAL DEVICES, FIXTURES AND EQUIPMENT REPRESENTS THE CIRCUIT NUMBER THAT THE CIRCUIT SHALL CONNECT TO. REFER TO CIRCUIT HOMERUNS IDENTIFIED WITHIN THE DRAWING THAT THE EQUIPMENT IS PLACED ON FOR THE PROPER HOMERUN.
- CONTRACTOR SHALL VERIFY PROPER OPERATION AND CONDITION OF EXISTING FIXTURES TO REMAIN AND PROVIDE A LIST OF PROBLEMS TO THE CA.
- EXISTING CORRIDOR LIGHTING CONTROLS SHALL REMAIN AND BE UTILIZED WITH EXISTING TO REMAIN FIXTURES ON THE SECOND FLOOR AND WITH NEW FIXTURES ON THE THIRD FLOOR.
- ALL BRANCH CIRCUITS SHALL BE INSTALLED IN EMT CONDUIT FROM THE PANELBOARD TO THE FIRST DEVICE OR PIECE OF EQUIPMENT ON THE CIRCUIT. WIRING FROM THE FIRST DEVICE TO ADDITIONAL DEVICES SHALL BE INSTALLED IN EMT CONDUIT OR MC CABLE. FLEX CONDUIT (GREENFIELD) WILL BE ALLOWED FOR FINAL WHIP CONNECTIONS OF 6 FEET IN LENGTH OR LESS. TYPE NM AND AC CABLE WILL NOT BE ALLOWED.

1 ELECTRICAL LIGHTING SECOND FLOOR PLAN-SOUTH
SCALE: 1/8" = 1'-0"

| | | | | | |
|--|---------|-------------------------------|--|-------------|---------------|
| drawing title SECOND FLOOR - SOUTH LIGHTING PARTIAL PLAN | | | STATE OF CONNECTICUT DEPARTMENT OF ADMINISTRATIVE SERVICES | | |
| REVISIONS | | | | | |
| mark | date | description | drawing prepared by | date | scale |
| | 8/4/17 | SCHEMATIC DESIGN SUBMISSION | CONSULTING ENGINEERING SERVICES, INC. 811 MIDDLE STREET MIDDLETOWN, CT | 07/25/18 | AS NOTED |
| | 1/15/18 | DESIGN DEVELOPMENT SUBMISSION | | | |
| | 4/16/18 | CONSTRUCTION DOCUMENTS | project | | |
| | 5/23/18 | | WESTERN CT STATE UNIVERSITY | | drawn by |
| | 7/25/18 | | WHITE HALL | | approved by |
| | 1/21/19 | | 2ND AND 3RD FLOOR RENOVATIONS | | SJM |
| | | | DANBURY, CONNECTICUT | | drawing no. |
| | | | CAD no. | project no. | EL1.02 |
| | | | | BI-RD-299 | |

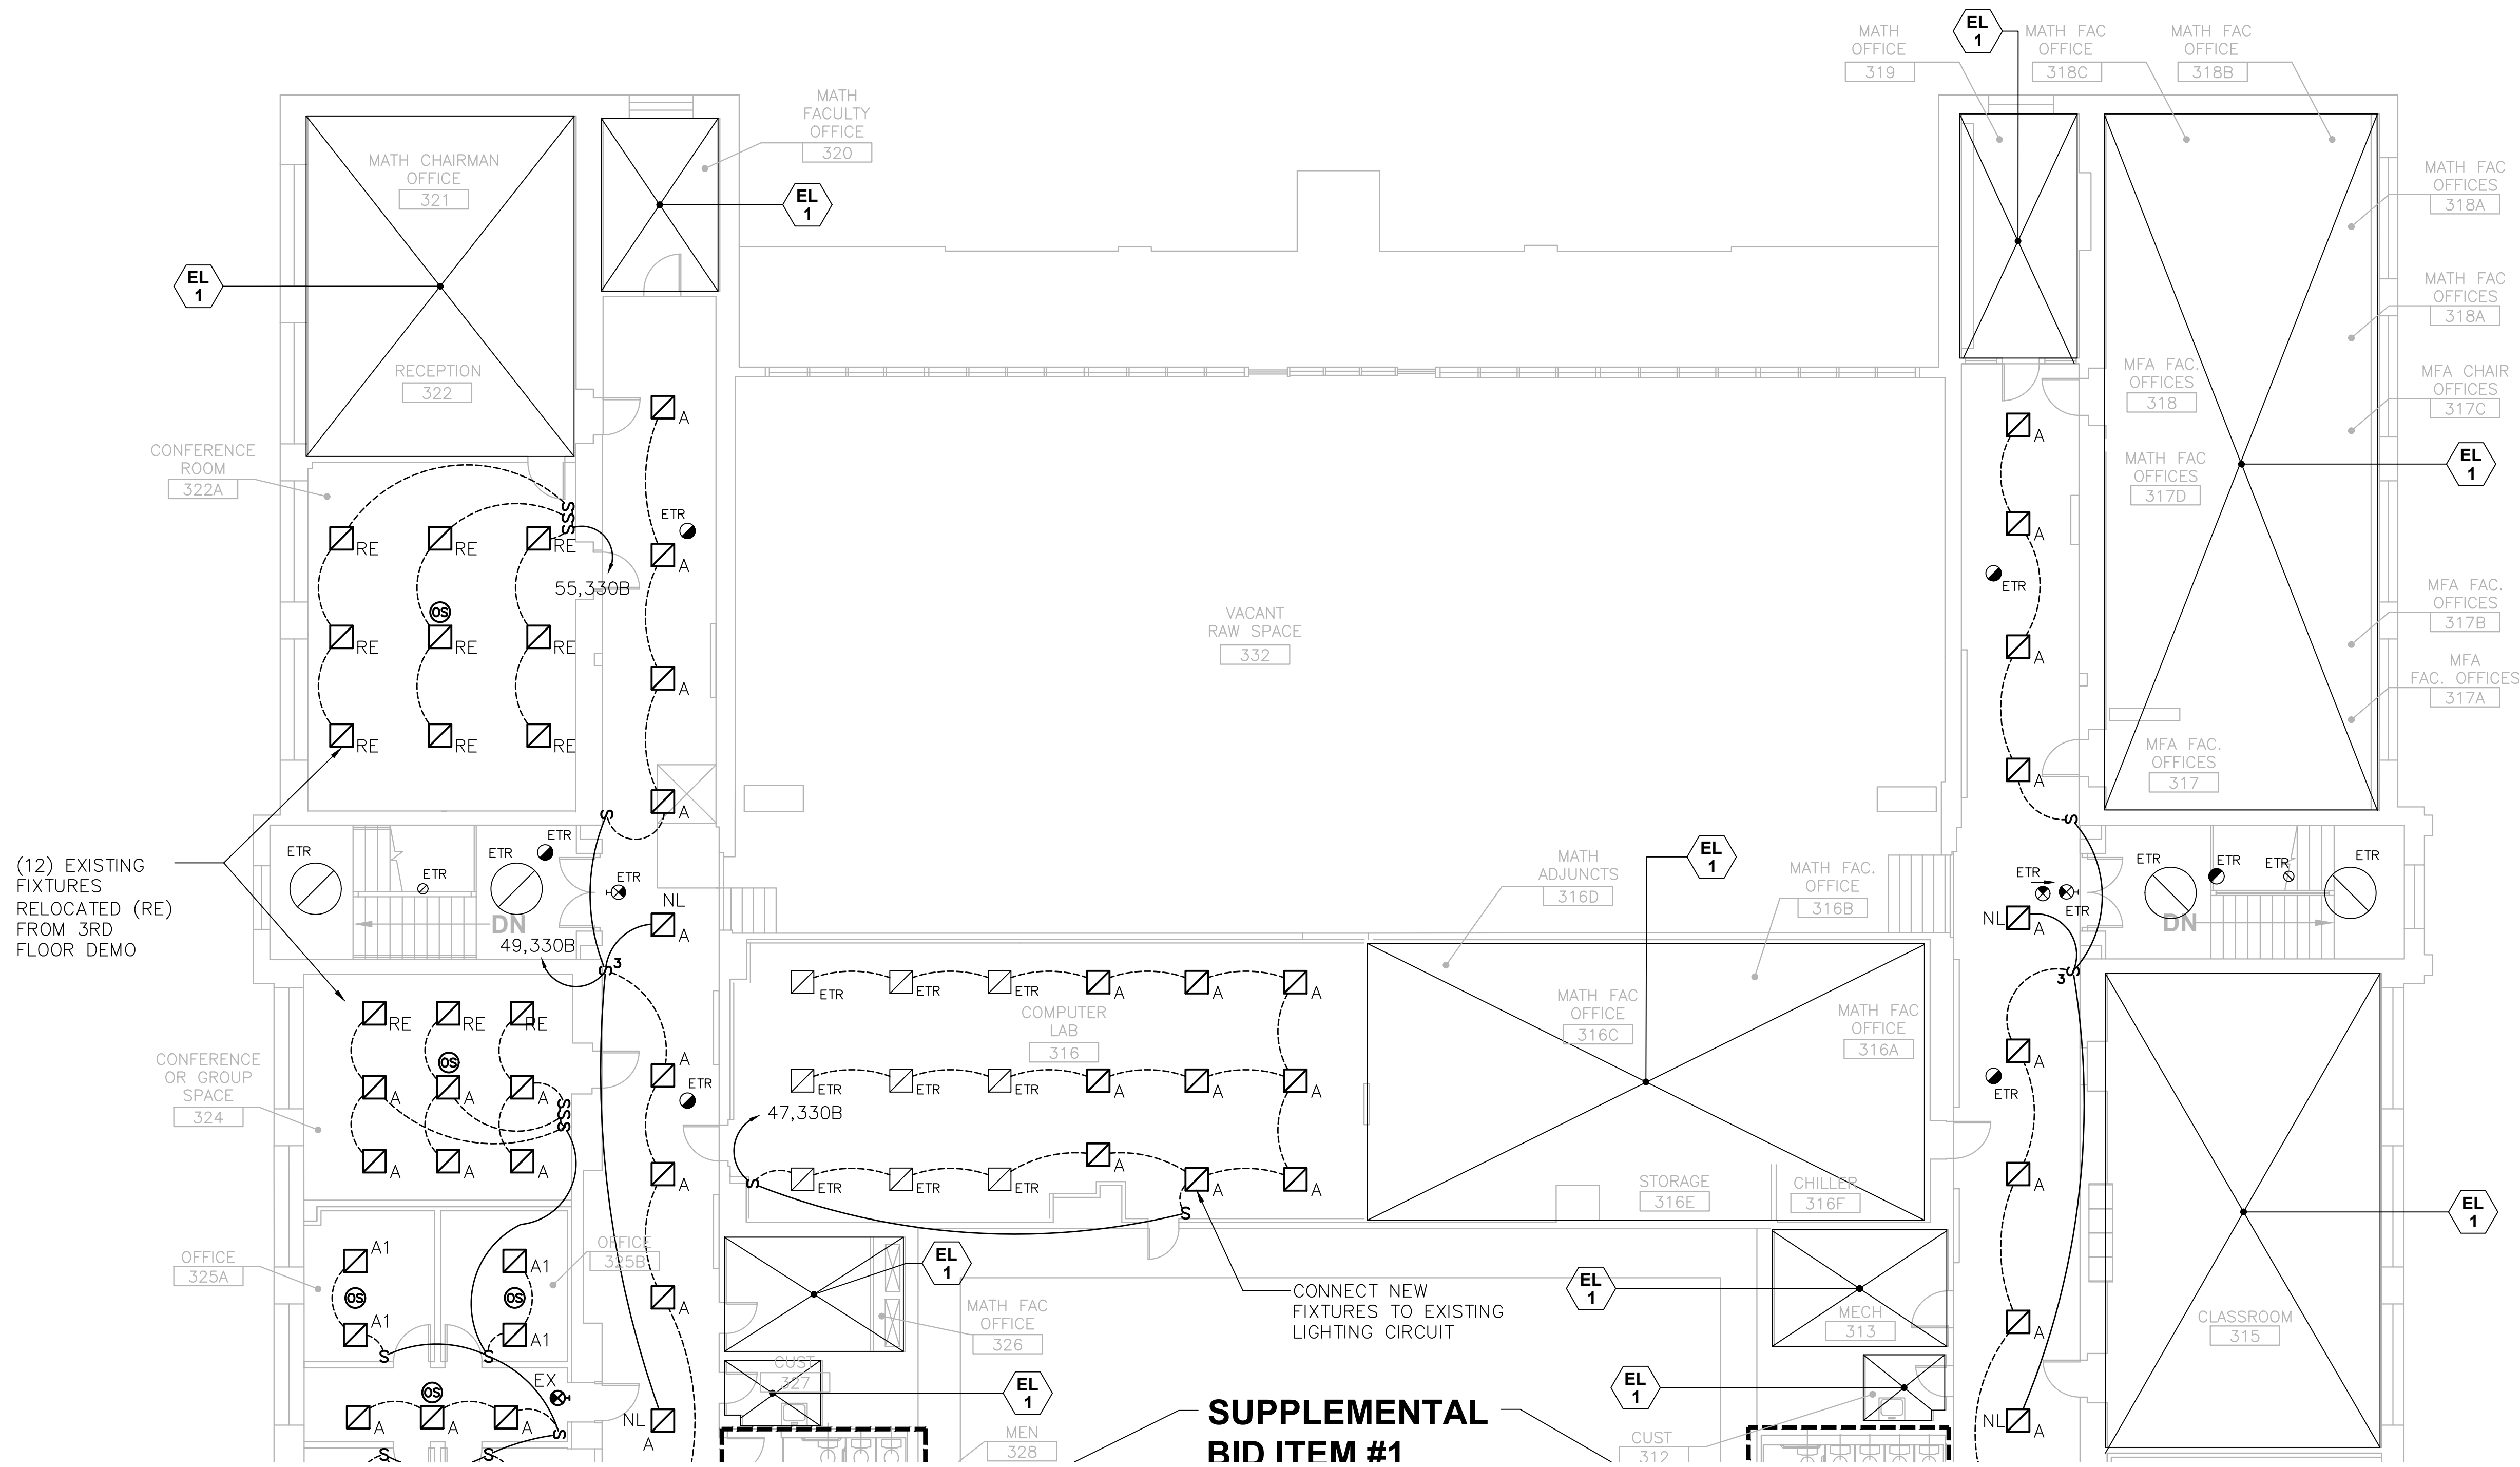

ELECTRICAL LIGHTING KEY NOTES

EL 1 NO ELECTRICAL WORK TO BE PERFORMED IN THIS AREA UNDER THIS CONTRACT.


EL 2 EXISTING TO REMAIN 2'x2' LIGHTING FIXTURES IN CORRIDOR. FIXTURES SHALL BE REMOVED & REINSTALLED AS REQUIRED FOR ABOVE CEILING WORK.

ELECTRICAL LIGHTING GENERAL NOTES

1. NUMBERS INDICATED ADJACENT TO ELECTRICAL DEVICES, FIXTURES AND EQUIPMENT REPRESENTS THE CIRCUIT NUMBER THAT THE CIRCUIT SHALL CONNECT TO. REFER TO CIRCUIT HOMERUNS IDENTIFIED WITHIN THE DRAWING THAT THE EQUIPMENT IS PLACED ON FOR THE PROPER HOMERUN.
2. CONTRACTOR SHALL VERIFY PROPER OPERATION AND CONDITION OF EXISTING FIXTURES TO REMAIN AND PROVIDE A LIST OF PROBLEMS TO THE CA.
3. EXISTING CORRIDOR LIGHTING CONTROLS SHALL REMAIN AND BE UTILIZED WITH EXISTING TO REMAIN FIXTURES ON THE SECOND FLOOR AND WITH NEW FIXTURES ON THE THIRD FLOOR.
4. ALL BRANCH CIRCUITS SHALL BE INSTALLED IN EMT CONDUIT FROM THE PANELBOARD TO THE FIRST DEVICE OR PIECE OF EQUIPMENT ON THE CIRCUIT. WIRING FROM THE FIRST DEVICE TO ADDITIONAL DEVICES SHALL BE INSTALLED IN EMT CONDUIT OR MC CABLE. FLEX CONDUIT (GREENFIELD) WILL BE ALLOWED FOR FINAL WHIP CONNECTIONS OF 6 FEET IN LENGTH OR LESS. TYPE NM AND AC CABLE WILL NOT BE ALLOWED.

1 ELECTRICAL LIGHTING THIRD FLOOR PLAN-NORTH
SCALE: 1/8" = 1'-0"

| | | | | | |
|---|---------|-------------------------------|--|--------------------|------------------------------|
| drawing title THIRD FLOOR - NORTH LIGHTING PARTIAL PLAN | | | STATE OF CONNECTICUT DEPARTMENT OF ADMINISTRATIVE SERVICES | | |
| REVISIONS | | | drawing prepared by CONSULTING ENGINEERING SERVICES, INC. 811 MIDDLE STREET MIDDLETOWN, CT | | |
| mark | date | description | date | scale | AS NOTED |
| | 8/4/17 | SCHEMATIC DESIGN SUBMISSION | 07/25/18 | | |
| | 1/15/18 | DESIGN DEVELOPMENT SUBMISSION | | | |
| | 4/16/18 | CONSTRUCTION DOCUMENTS | | | |
| | 5/23/18 | | | | |
| | 7/25/18 | | | | |
| | 1/21/19 | | | | |
| project WESTERN CT STATE UNIVERSITY WHITE HALL 2ND AND 3RD FLOOR RENOVATIONS DANBURY, CONNECTICUT | | | drawn by MAL | approved by SJM | drawing no. EL1.03 |
| CAD no. | | | project no. BI-RD-299 | | |

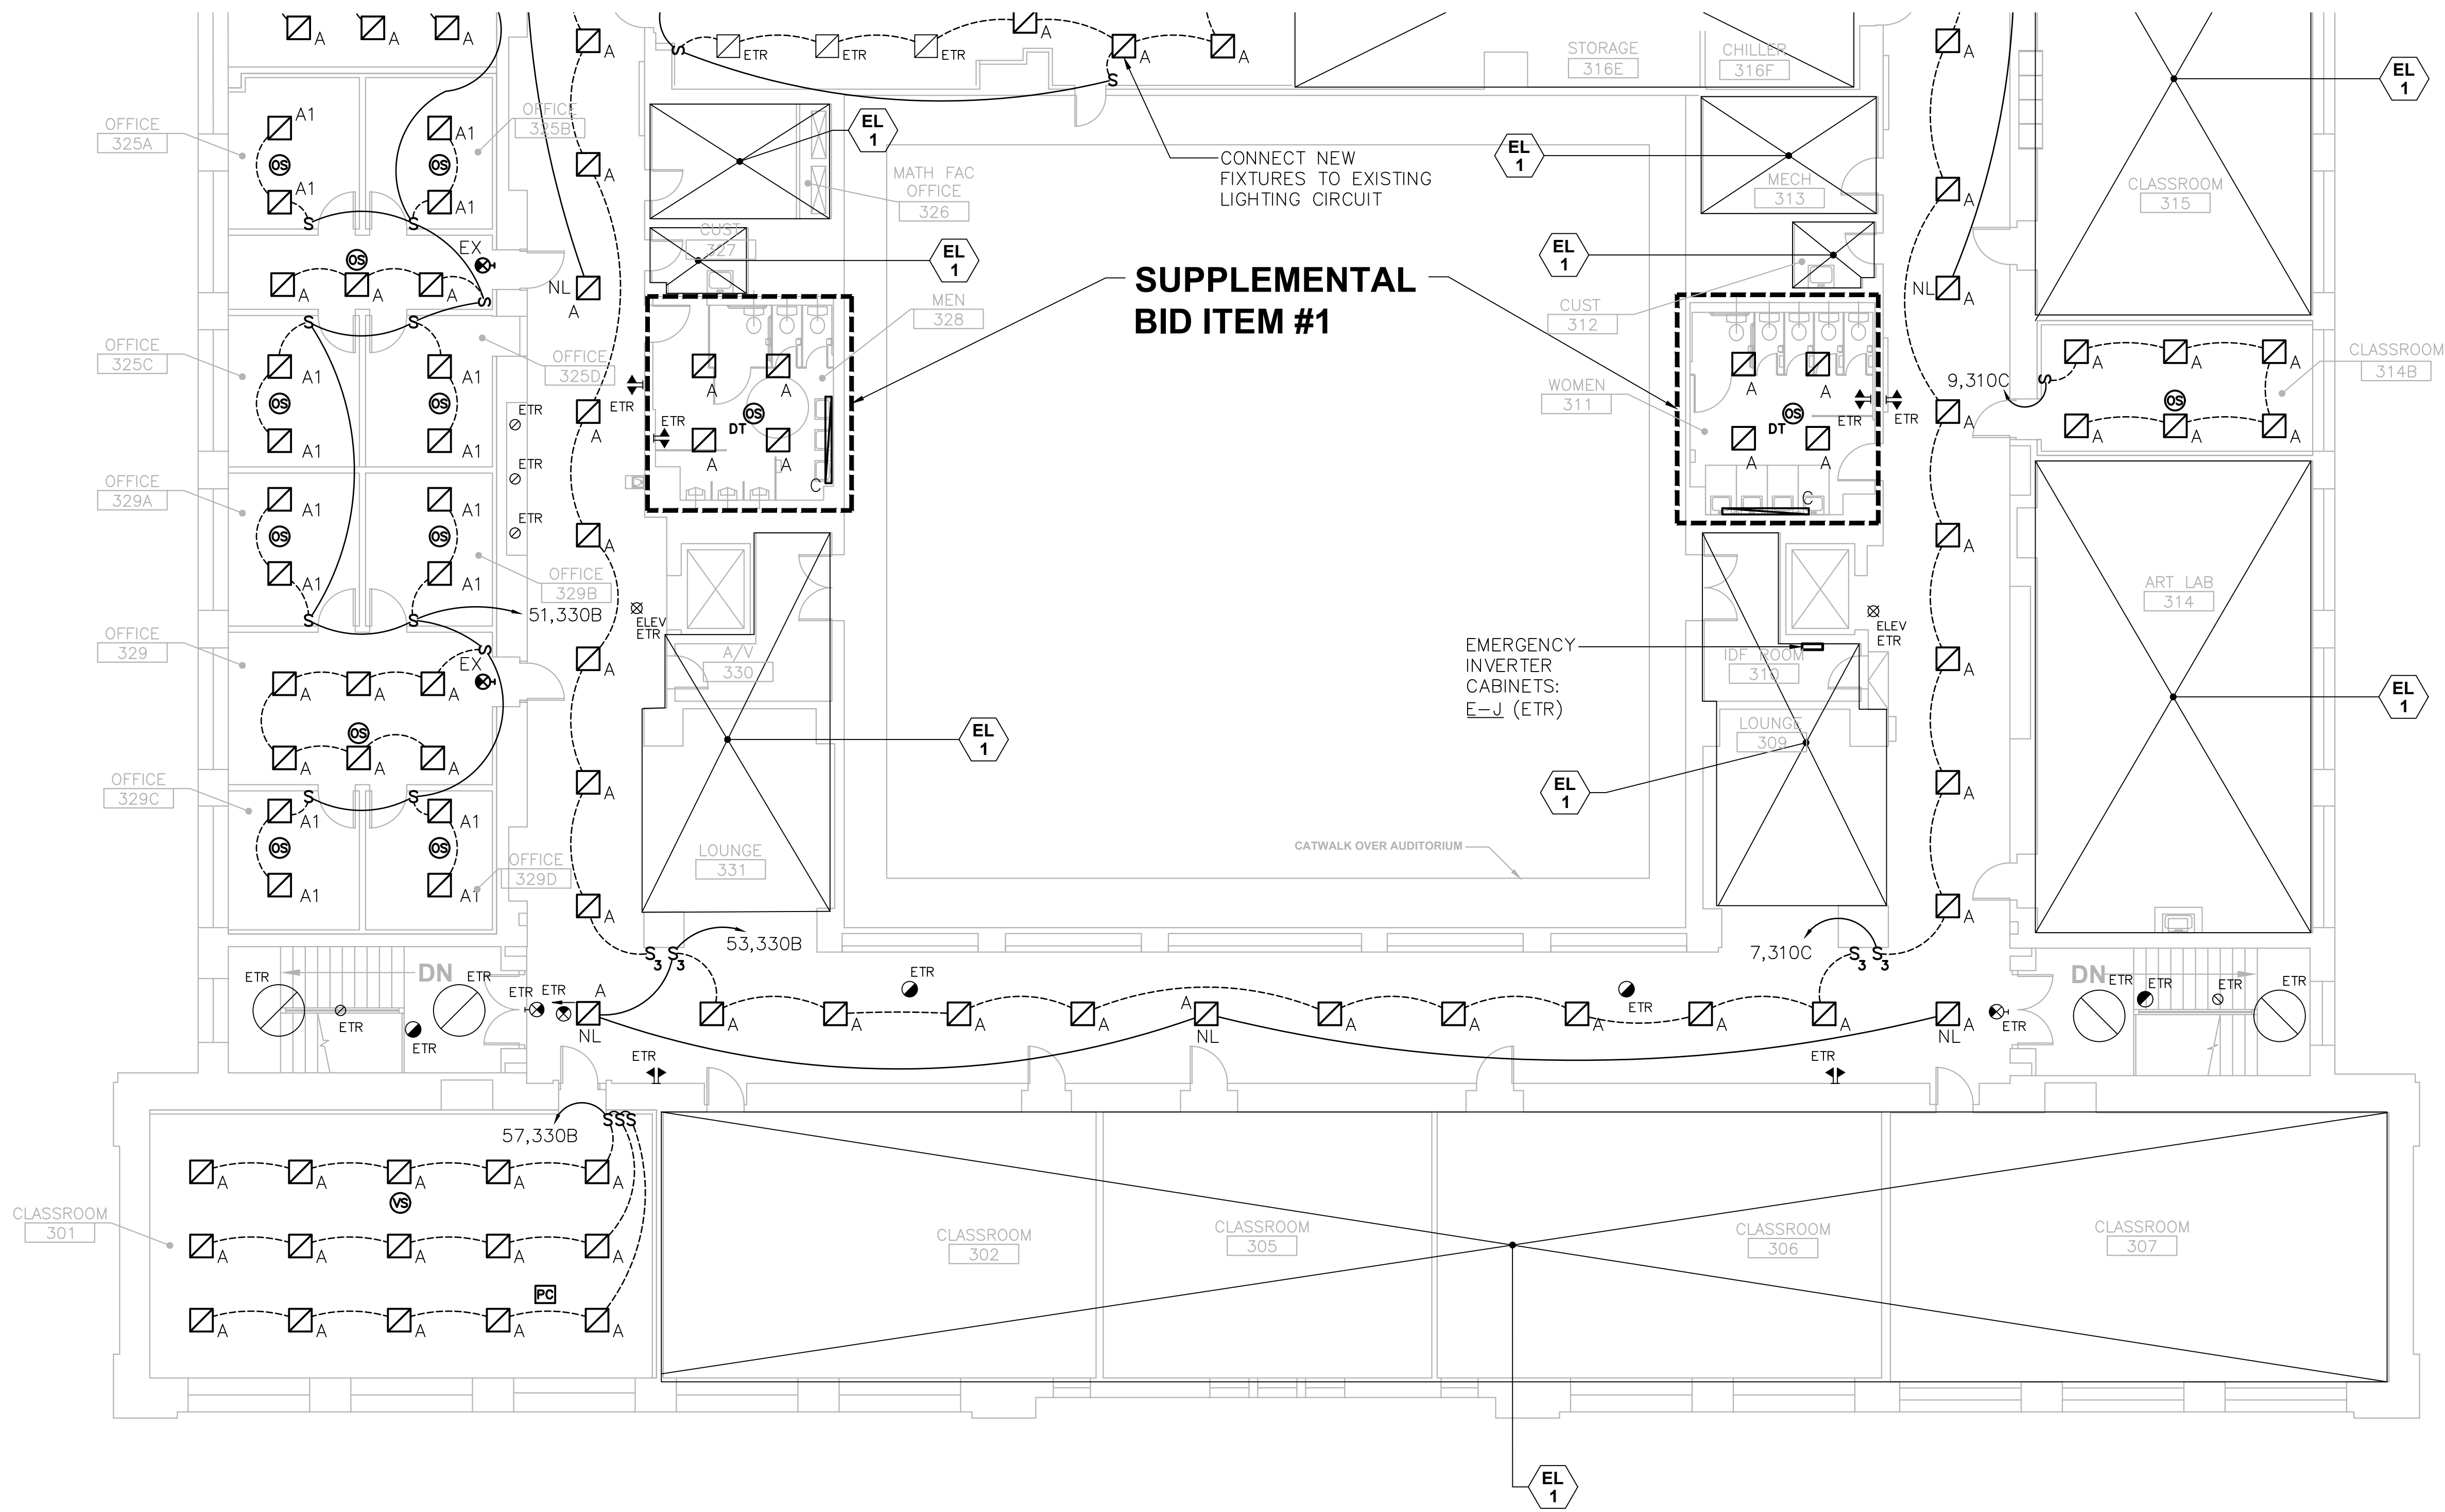

ELECTRICAL LIGHTING KEY NOTES

EL 1 NO ELECTRICAL WORK TO BE PERFORMED IN THIS AREA UNDER THIS CONTRACT.


EL 2 EXISTING TO REMAIN 2'x2' LIGHTING FIXTURES IN CORRIDOR. FIXTURES SHALL BE REMOVED & REINSTALLED AS REQUIRED FOR ABOVE CEILING WORK.

ELECTRICAL LIGHTING GENERAL NOTES

- NUMBERS INDICATED ADJACENT TO ELECTRICAL DEVICES, FIXTURES AND EQUIPMENT REPRESENTS THE CIRCUIT NUMBER THAT THE CIRCUIT SHALL CONNECT TO. REFER TO CIRCUIT HOMERUNS IDENTIFIED WITHIN THE DRAWING THAT THE EQUIPMENT IS PLACED ON FOR THE PROPER HOMERUN.
- CONTRACTOR SHALL VERIFY PROPER OPERATION AND CONDITION OF EXISTING FIXTURES TO REMAIN AND PROVIDE A LIST OF PROBLEMS TO THE CA.
- EXISTING CORRIDOR LIGHTING CONTROLS SHALL REMAIN AND BE UTILIZED WITH EXISTING TO REMAIN FIXTURES ON THE SECOND FLOOR AND WITH NEW FIXTURES ON THE THIRD FLOOR.
- ALL BRANCH CIRCUITS SHALL BE INSTALLED IN EMT CONDUIT FROM THE PANELBOARD TO THE FIRST DEVICE OR PIECE OF EQUIPMENT ON THE CIRCUIT. WIRING FROM THE FIRST DEVICE TO ADDITIONAL DEVICES SHALL BE INSTALLED IN EMT CONDUIT OR MC CABLE. FLEX CONDUIT (GREENFIELD) WILL BE ALLOWED FOR FINAL WHIP CONNECTIONS OF 6 FEET IN LENGTH OR LESS. TYPE NM AND AC CABLE WILL NOT BE ALLOWED.

1 ELECTRICAL LIGHTING THIRD FLOOR PLAN-SOUTH
SCALE: 1/8" = 1'-0"

| | | | | | |
|---|---------|-------------------------------|--|--------------------|------------------------------|
| drawing title THIRD FLOOR - SOUTH LIGHTING PARTIAL PLAN | | | STATE OF CONNECTICUT DEPARTMENT OF ADMINISTRATIVE SERVICES | | |
| REVISIONS | | | drawing prepared by CONSULTING ENGINEERING SERVICES, INC. 811 MIDDLE STREET MIDDLETOWN, CT | | |
| mark | date | description | date | scale | AS NOTED |
| | 8/4/17 | SCHEMATIC DESIGN SUBMISSION | 07/25/18 | | |
| | 1/15/18 | DESIGN DEVELOPMENT SUBMISSION | | | |
| | 4/16/18 | CONSTRUCTION DOCUMENTS | | | |
| | 5/23/18 | | | | |
| | 7/25/18 | | | | |
| | 12/1/19 | | | | |
| project WESTERN CT STATE UNIVERSITY WHITE HALL 2ND AND 3RD FLOOR RENOVATIONS DANBURY, CONNECTICUT | | | drawn by MAL | approved by SJM | drawing no. EL1.04 |
| CAD no. | | | project no. BI-RD-299 | | |

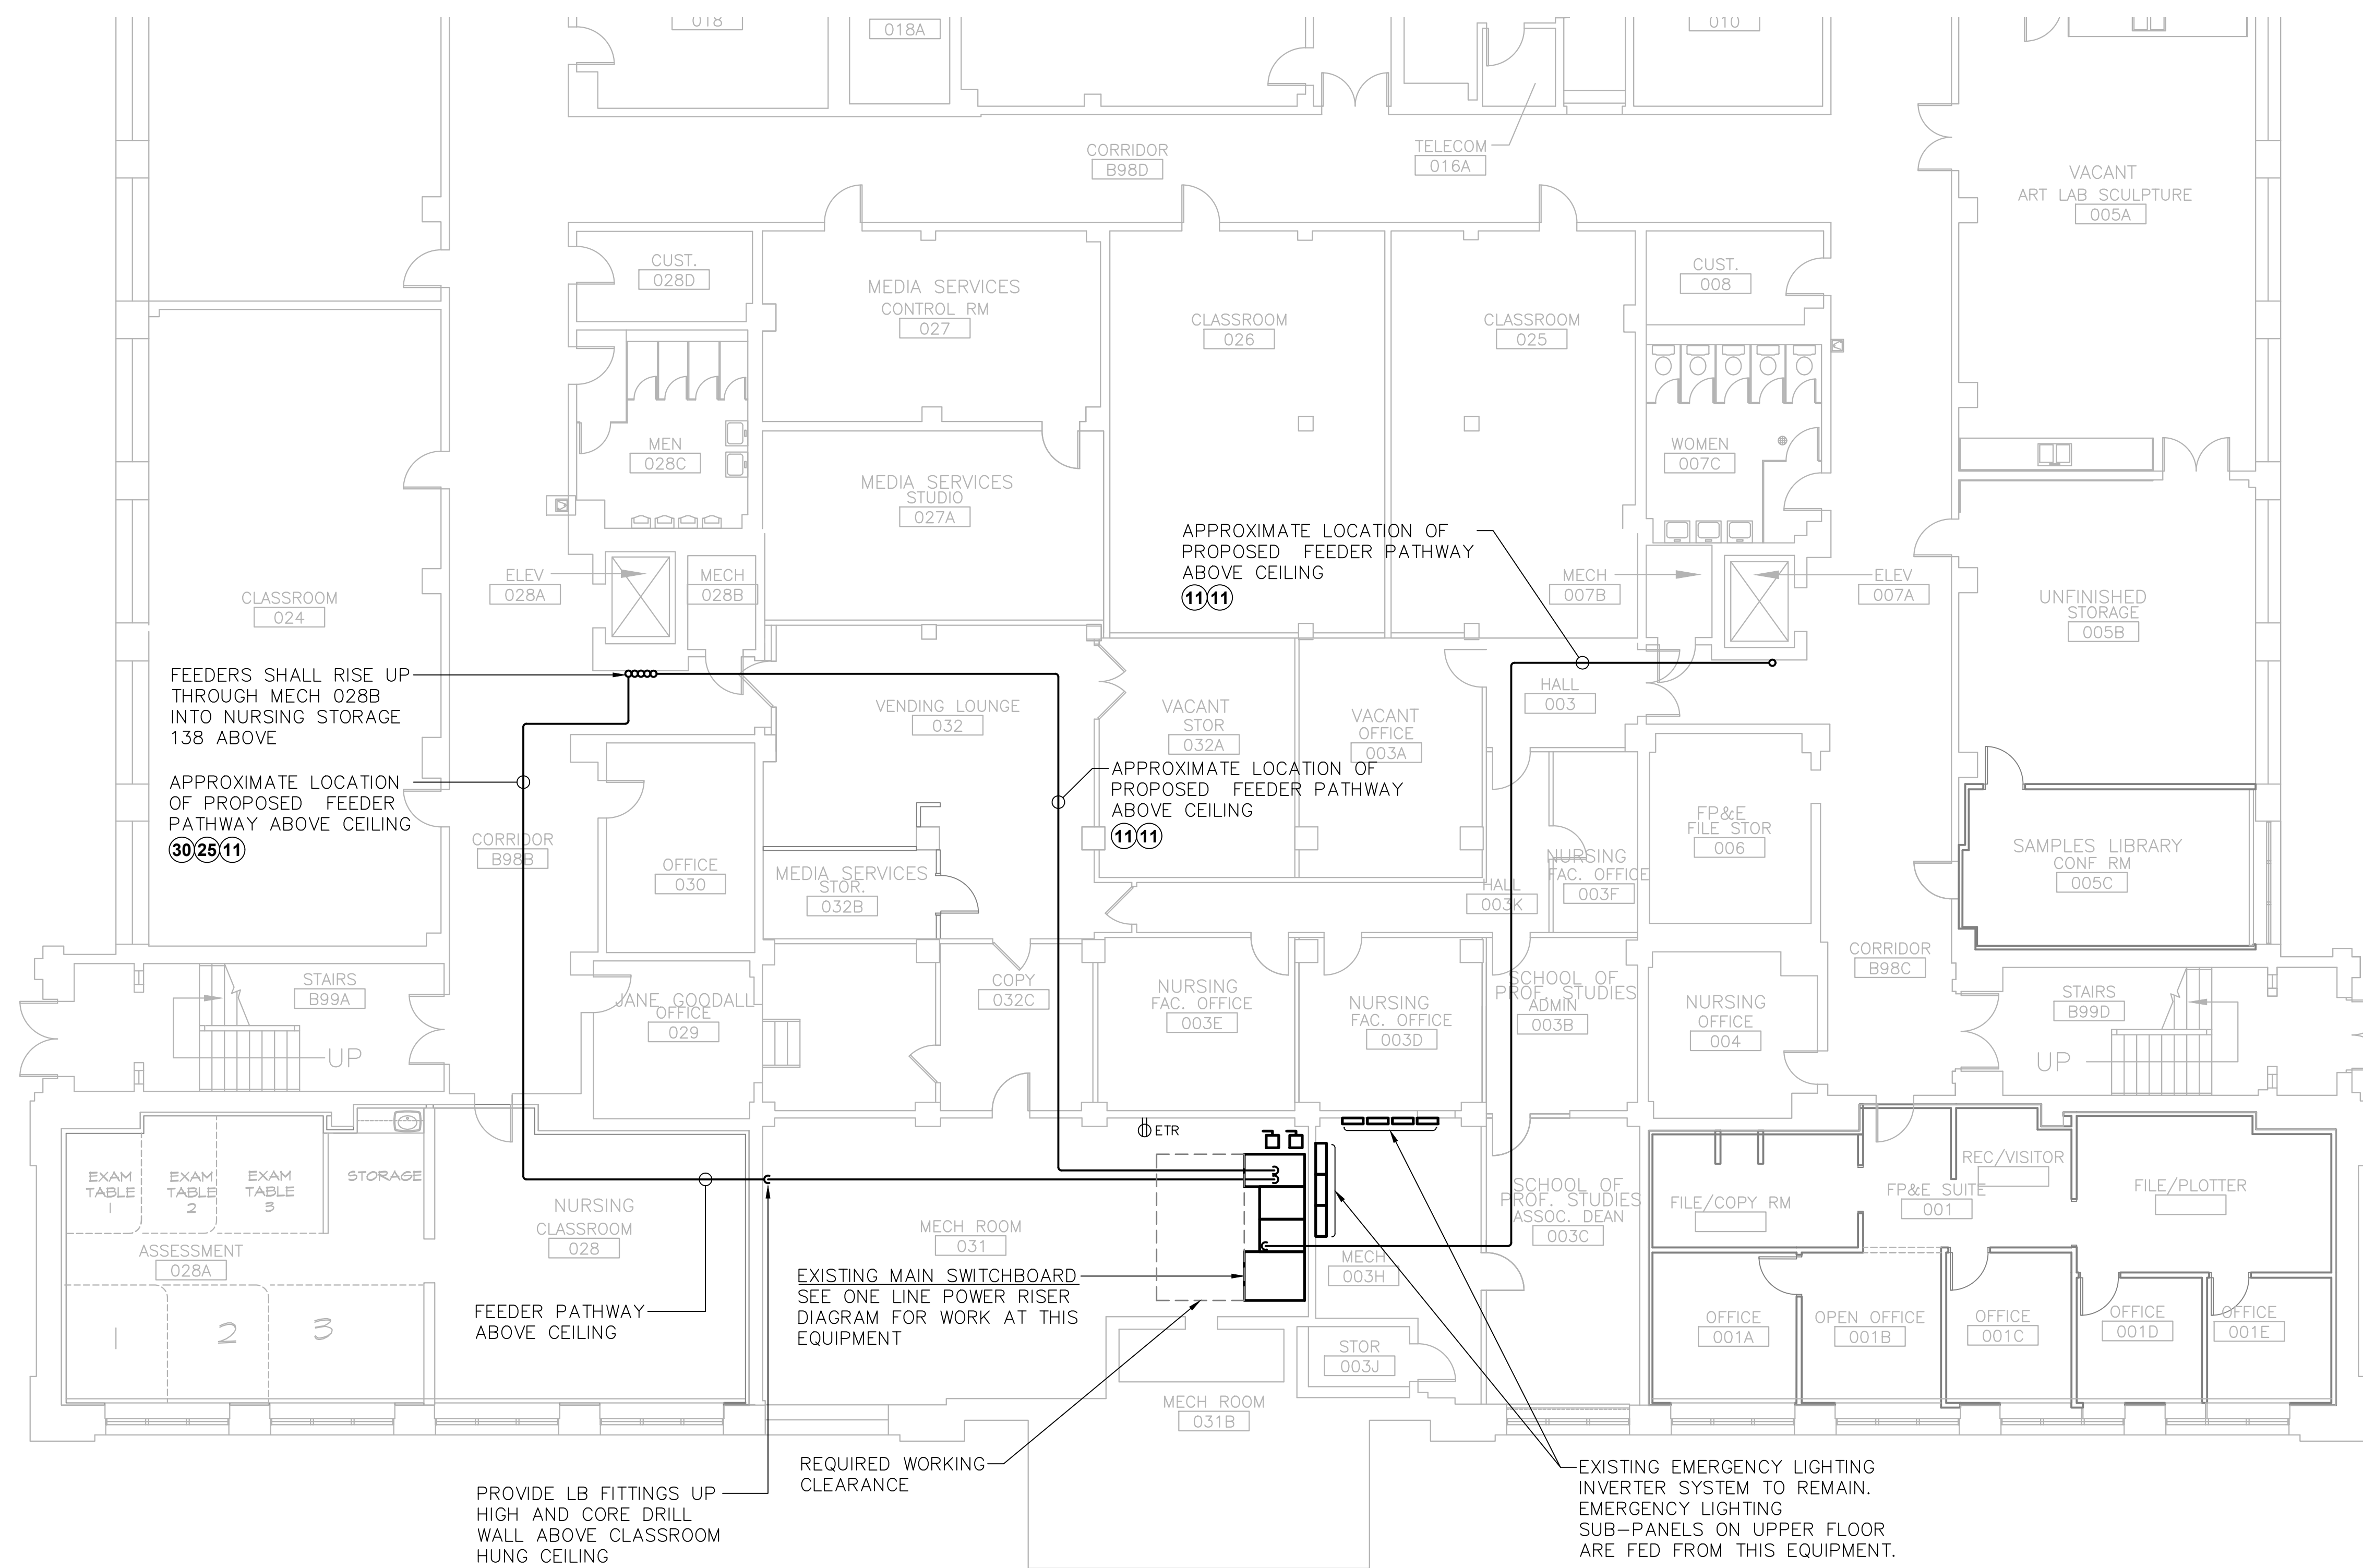

1 ELECTRICAL POWER BASEMENT PARTIAL PLAN
SCALE: 1/8" = 1'-0"

ELECTRICAL POWER KEY NOTES

- EP 1 NO ELECTRICAL WORK TO BE PERFORMED IN THIS AREA UNDER THIS CONTRACT.
- EP 2 ALL VRV UNITS WITHIN THIS AREA SHALL BE DAISY CHAINED AND CIRCUITED AS NOTED. REFER TO MOTOR CIRCUIT SCHEDULE ON DRAWING E2.03 FOR MORE INFORMATION.
- EP 3 RECEPTACLE SHALL BE MOUNTED HORIZONTALLY AT FLOOR LEVEL IN THE BENCH SEATING KICKSPACE.
- EP 4 EXISTING DEVICES WITH BACKBOXES AND CONDUIT THAT ARE LOCATED IN WALL CONSTRUCTION THAT WILL BE FURRED OUT AS PART OF THE OVERALL RENOVATION SHALL BE RETROFIT WITH BOX EXTENSIONS THAT SHALL PROMOTE A FLUSH INSTALLATION WITH THE NEW WALL SURFACE. ALL BOX LOCATIONS THAT HAVE EMPTY BACKBOXES SHALL BE REVIEWED WITH OWNER AND ENGINEER FOR A DECISION TO REMOVE OR ABANDON IN PLACE.
- EP 5 PROVIDE WIREMOLD V4000 DUAL COMPARTMENT.


ELECTRICAL POWER GENERAL NOTES

1. NUMBERS INDICATED ADJACENT TO ELECTRICAL DEVICES, FIXTURES AND EQUIPMENT REPRESENTS THE CIRCUIT NUMBER THAT THE CIRCUIT SHALL CONNECT TO. REFER TO CIRCUIT HOMERUNS IDENTIFIED WITHIN THE DRAWING THAT THE EQUIPMENT IS PLACED ON FOR THE PROPER HOMERUN.
2. CONDUIT RISER AND PATHWAY LOCATIONS SHALL BE COORDINATED WITH EXISTING PIPING, DUCTS, CONDUITS, BUILDING STEEL AND STRUCTURAL ELEMENTS.
3. PROVIDE APPROPRIATE FLOOR CORING PENETRATIONS AND SEAL WITH APPROVED FIRESTOP MATERIALS. REFER TO A9.01 AND A9.02 FOR DETAILS.
4. ALL BRANCH CIRCUITS SHALL BE INSTALLED IN EMT CONDUIT FROM THE PANELBOARD TO THE FIRST DEVICE OR PIECE OF EQUIPMENT ON THE CIRCUIT. WIRING FROM THE FIRST DEVICE TO ADDITIONAL DEVICES SHALL BE INSTALLED IN EMT CONDUIT OR MC CABLE. FLEX CONDUIT (GREENFIELD) WILL BE ALLOWED FOR FINAL WHIP CONNECTIONS OF 6 FEET IN LENGTH OR LESS. TYPE NM AND AC CABLE WILL NOT BE ALLOWED.

| | | | | | |
|---|---|-------------------------------|---|--------------------------|--------------------|
| drawing title BASEMENT - SOUTH POWER PARTIAL PLAN | | | STATE OF CONNECTICUT DEPARTMENT OF ADMINISTRATIVE SERVICES | | |
| REVISIONS | | | | | |
| mark | date | description | drawing prepared by | date | scale |
| | 8/4/17 | SCHEMATIC DESIGN SUBMISSION | CONSULTING ENGINEERING SERVICES, INC. 811 MIDDLE STREET MIDDLETOWN, CT | 07/25/18 | AS NOTED |
| | 1/15/18 | DESIGN DEVELOPMENT SUBMISSION | | | |
| | 4/16/18 5/23/18 7/25/18 12/21/19 | CONSTRUCTION DOCUMENTS | project WESTERN CT STATE UNIVERSITY WHITE HALL 2ND AND 3RD FLOOR RENOVATIONS DANBURY, CONNECTICUT | drawn by MAL | approved by SJM |
| | | | CAD no. | project no. BI-RD-299 | EP1.00 |

RECEPTACLE MOUNTED 80" AFF MOUNTED HORIZONTAL FOR OTOSCOPE PANEL (TYPICAL)

RECEPTACLE MOUNTED 80" AFF MOUNTED HORIZONTAL FOR OTOSCOPE PANEL (TYPICAL)

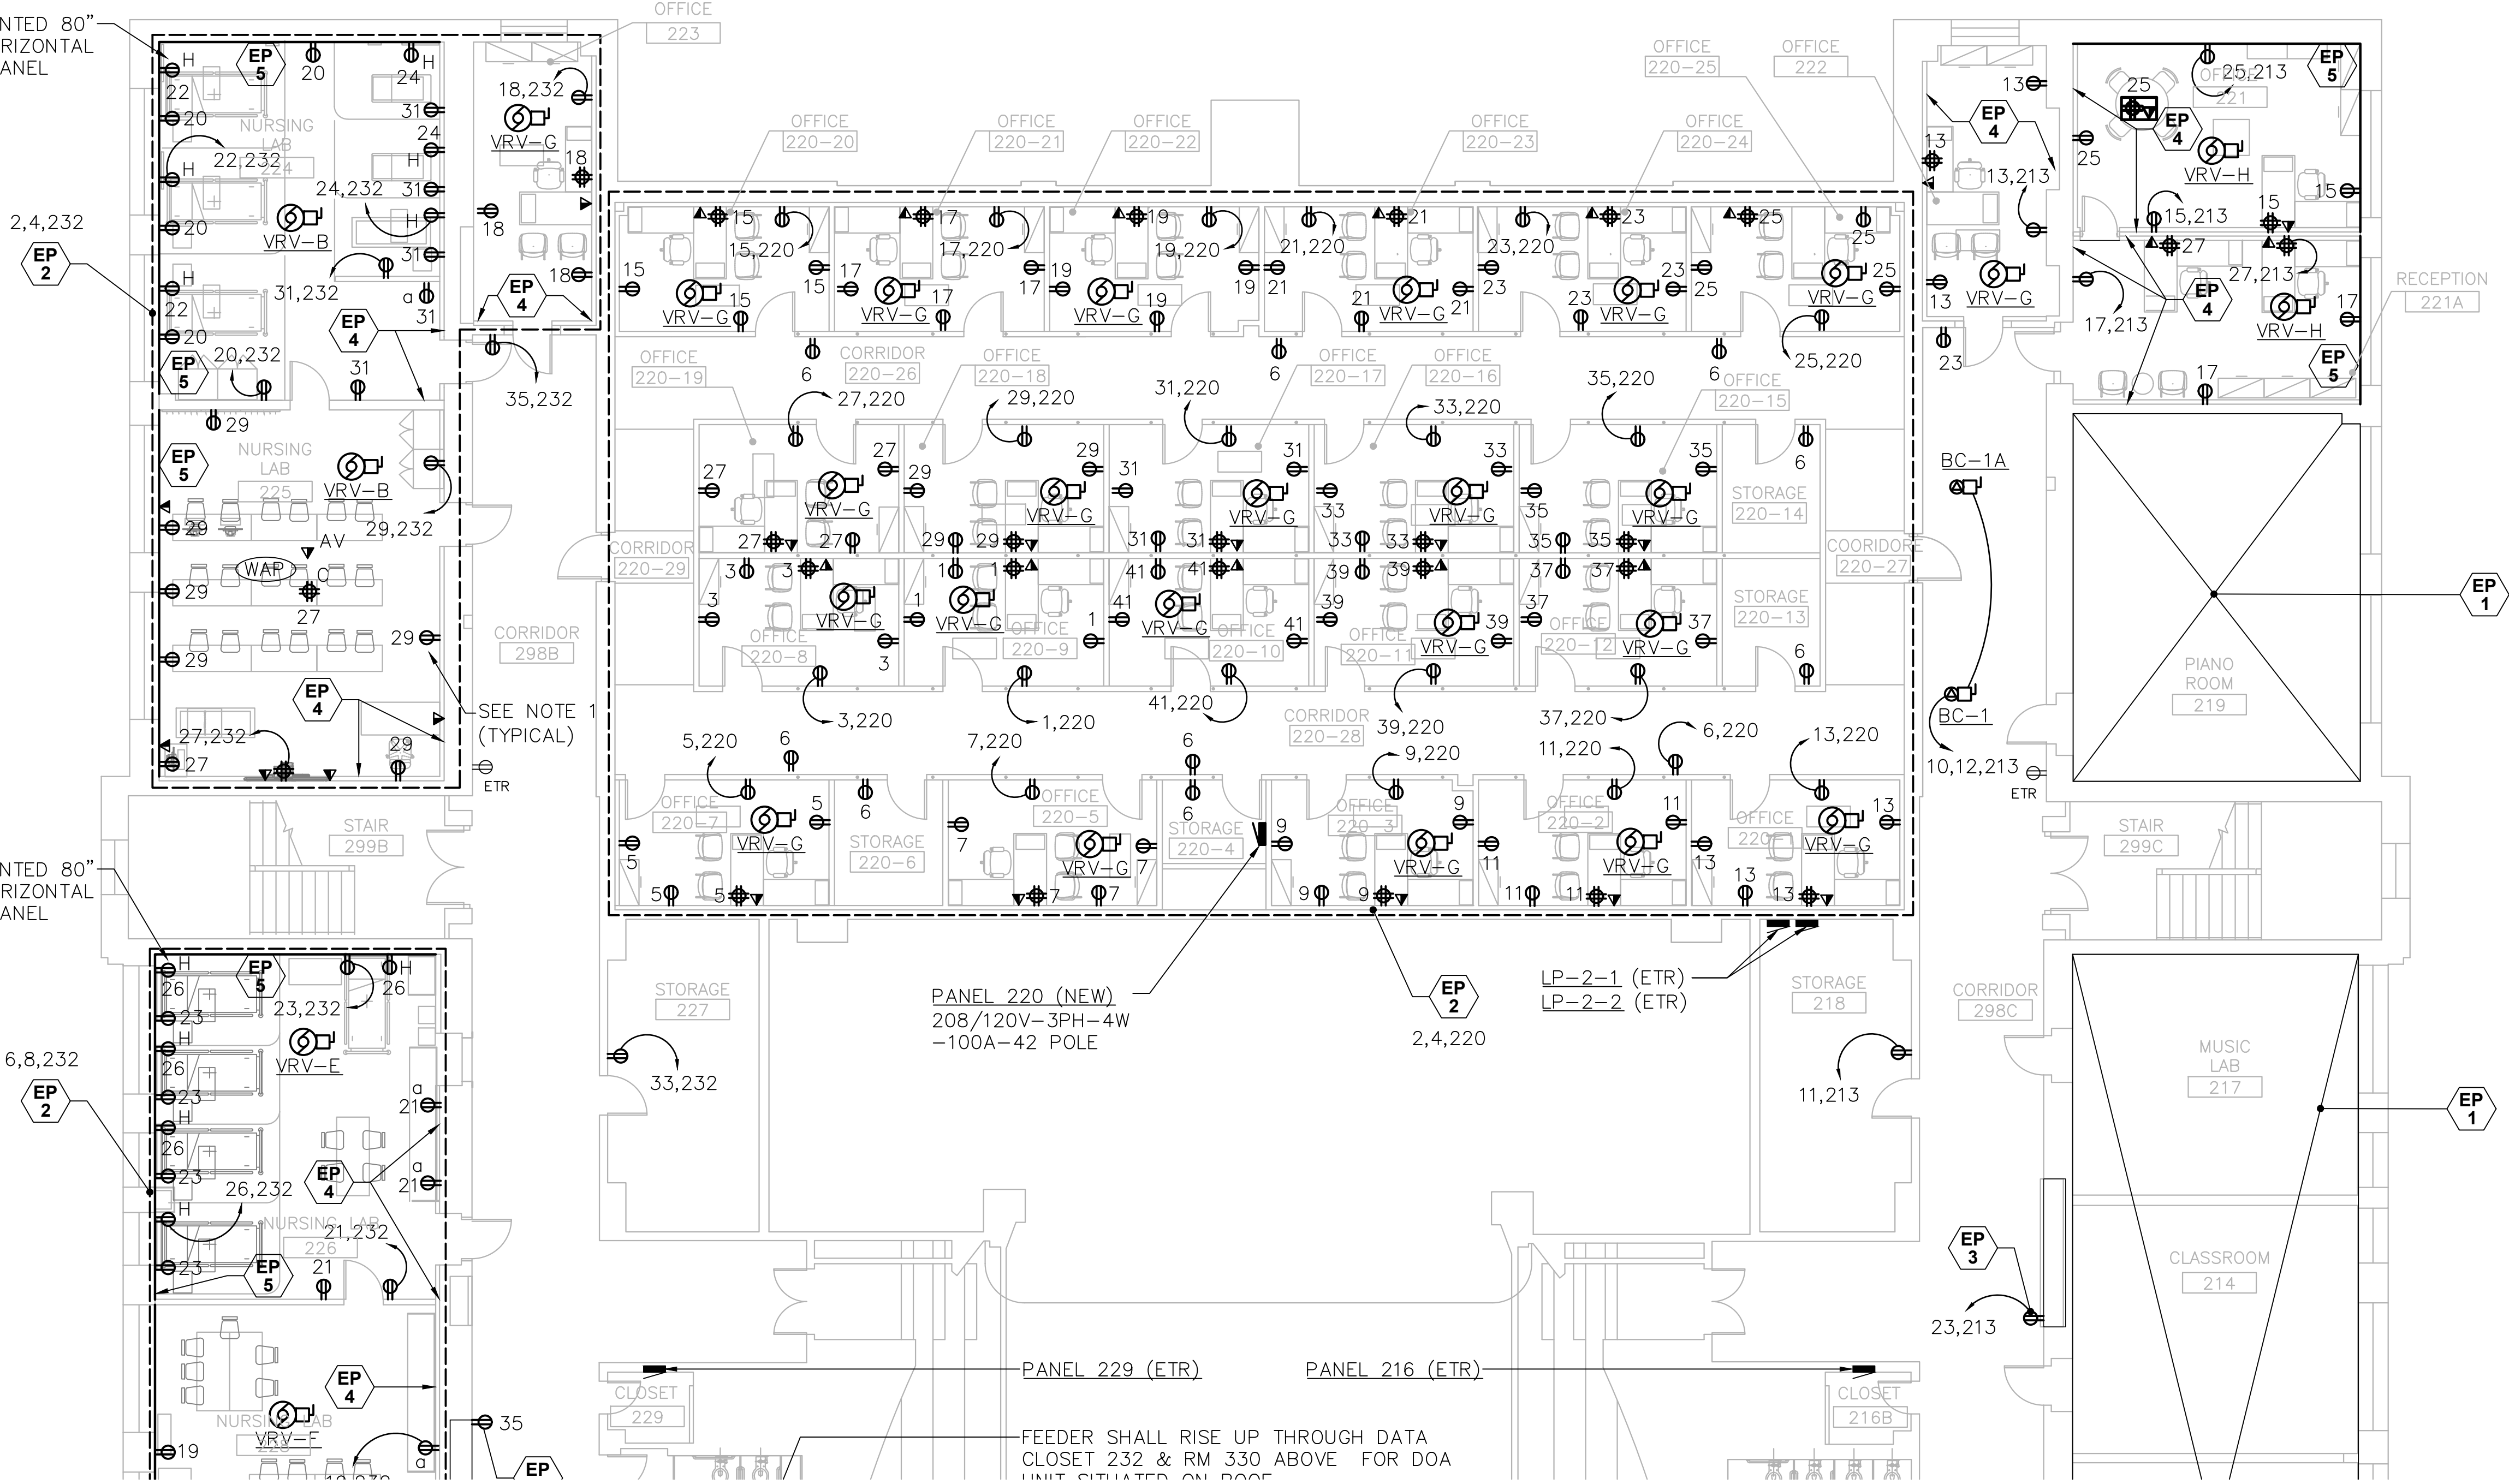

ELECTRICAL POWER KEY NOTES


- EP 1 NO ELECTRICAL WORK TO BE PERFORMED IN THIS AREA UNDER THIS CONTRACT.
- EP 2 ALL VRV UNITS WITHIN THIS AREA SHALL BE DAISY CHAINED AND CIRCUITED AS NOTED. REFER TO MOTOR CIRCUIT SCHEDULE ON DRAWING E2.03 FOR MORE INFORMATION.
- EP 3 RECEPTACLE SHALL BE MOUNTED HORIZONTALLY AT FLOOR LEVEL IN THE BENCH SEATING KICKSPACE.
- EP 4 EXISTING DEVICES WITH BACKBOXES AND CONDUIT THAT ARE LOCATED IN WALL CONSTRUCTION THAT WILL BE FURRED OUT AS PART OF THE OVERALL RENOVATION SHALL BE RETROFIT WITH BOX EXTENSIONS THAT SHALL PROMOTE A FLUSH INSTALLATION WITH THE NEW WALL SURFACE. ALL BOX LOCATIONS THAT HAVE EMPTY BACKBOXES SHALL BE REVIEWED WITH OWNER AND ENGINEER FOR A DECISION TO REMOVE OR ABANDON IN PLACE.
- EP 5 PROVIDE WIREMOLD V4000 DUAL COMPARTMENT.

ELECTRICAL POWER GENERAL NOTES

1. NUMBERS INDICATED ADJACENT TO ELECTRICAL DEVICES, FIXTURES AND EQUIPMENT REPRESENTS THE CIRCUIT NUMBER THAT THE CIRCUIT SHALL CONNECT TO. REFER TO CIRCUIT HOMERUNS IDENTIFIED WITHIN THE DRAWING THAT THE EQUIPMENT IS PLACED ON FOR THE PROPER HOMERUN.
2. CONDUIT RISER AND PATHWAY LOCATIONS SHALL BE COORDINATED WITH EXISTING PIPING, DUCTS, CONDUITS, BUILDING STEEL AND STRUCTURAL ELEMENTS.
3. PROVIDE APPROPRIATE FLOOR CORING PENETRATIONS AND SEAL WITH APPROVED FIRESTOP MATERIALS. REFER TO A9.01 AND A9.02 FOR DETAILS.
4. ALL BRANCH CIRCUITS SHALL BE INSTALLED IN EMT CONDUIT FROM THE PANELBOARD TO THE FIRST DEVICE OR PIECE OF EQUIPMENT ON THE CIRCUIT. WIRING FROM THE FIRST DEVICE TO ADDITIONAL DEVICES SHALL BE INSTALLED IN EMT CONDUIT OR MC CABLE. FLEX CONDUIT (GREENFIELD) WILL BE ALLOWED FOR FINAL WHIP CONNECTIONS OF 6 FEET IN LENGTH OR LESS. TYPE NM AND AC CABLE WILL NOT BE ALLOWED.

1 ELECTRICAL POWER SECOND FLOOR PLAN-NORTH
SCALE: 1/8"=1'-0"

| | | | | | |
|---|---------|-------------------------------|--|-------------|---------------|
| drawing title SECOND FLOOR - NORTH POWER PARTIAL PLAN | | | STATE OF CONNECTICUT DEPARTMENT OF ADMINISTRATIVE SERVICES | | |
| REVISIONS | | | | | |
| mark | date | description | drawing prepared by | date | scale |
| | 8/4/17 | SCHEMATIC DESIGN SUBMISSION | CONSULTING ENGINEERING SERVICES, INC. 811 MIDDLE STREET MIDDLETOWN, CT | 07/25/18 | AS NOTED |
| | 1/15/18 | DESIGN DEVELOPMENT SUBMISSION | | | |
| | 4/16/18 | CONSTRUCTION DOCUMENTS | project | | |
| | 5/23/18 | | WESTERN CT STATE UNIVERSITY | | |
| | 7/25/18 | | WHITE HALL | | |
| | 1/21/19 | | 2ND AND 3RD FLOOR RENOVATIONS | | |
| | | | DANBURY, CONNECTICUT | | |
| | | | CAD no. | project no. | |
| | | | | BI-RD-299 | |
| | | | | | EP1.01 |

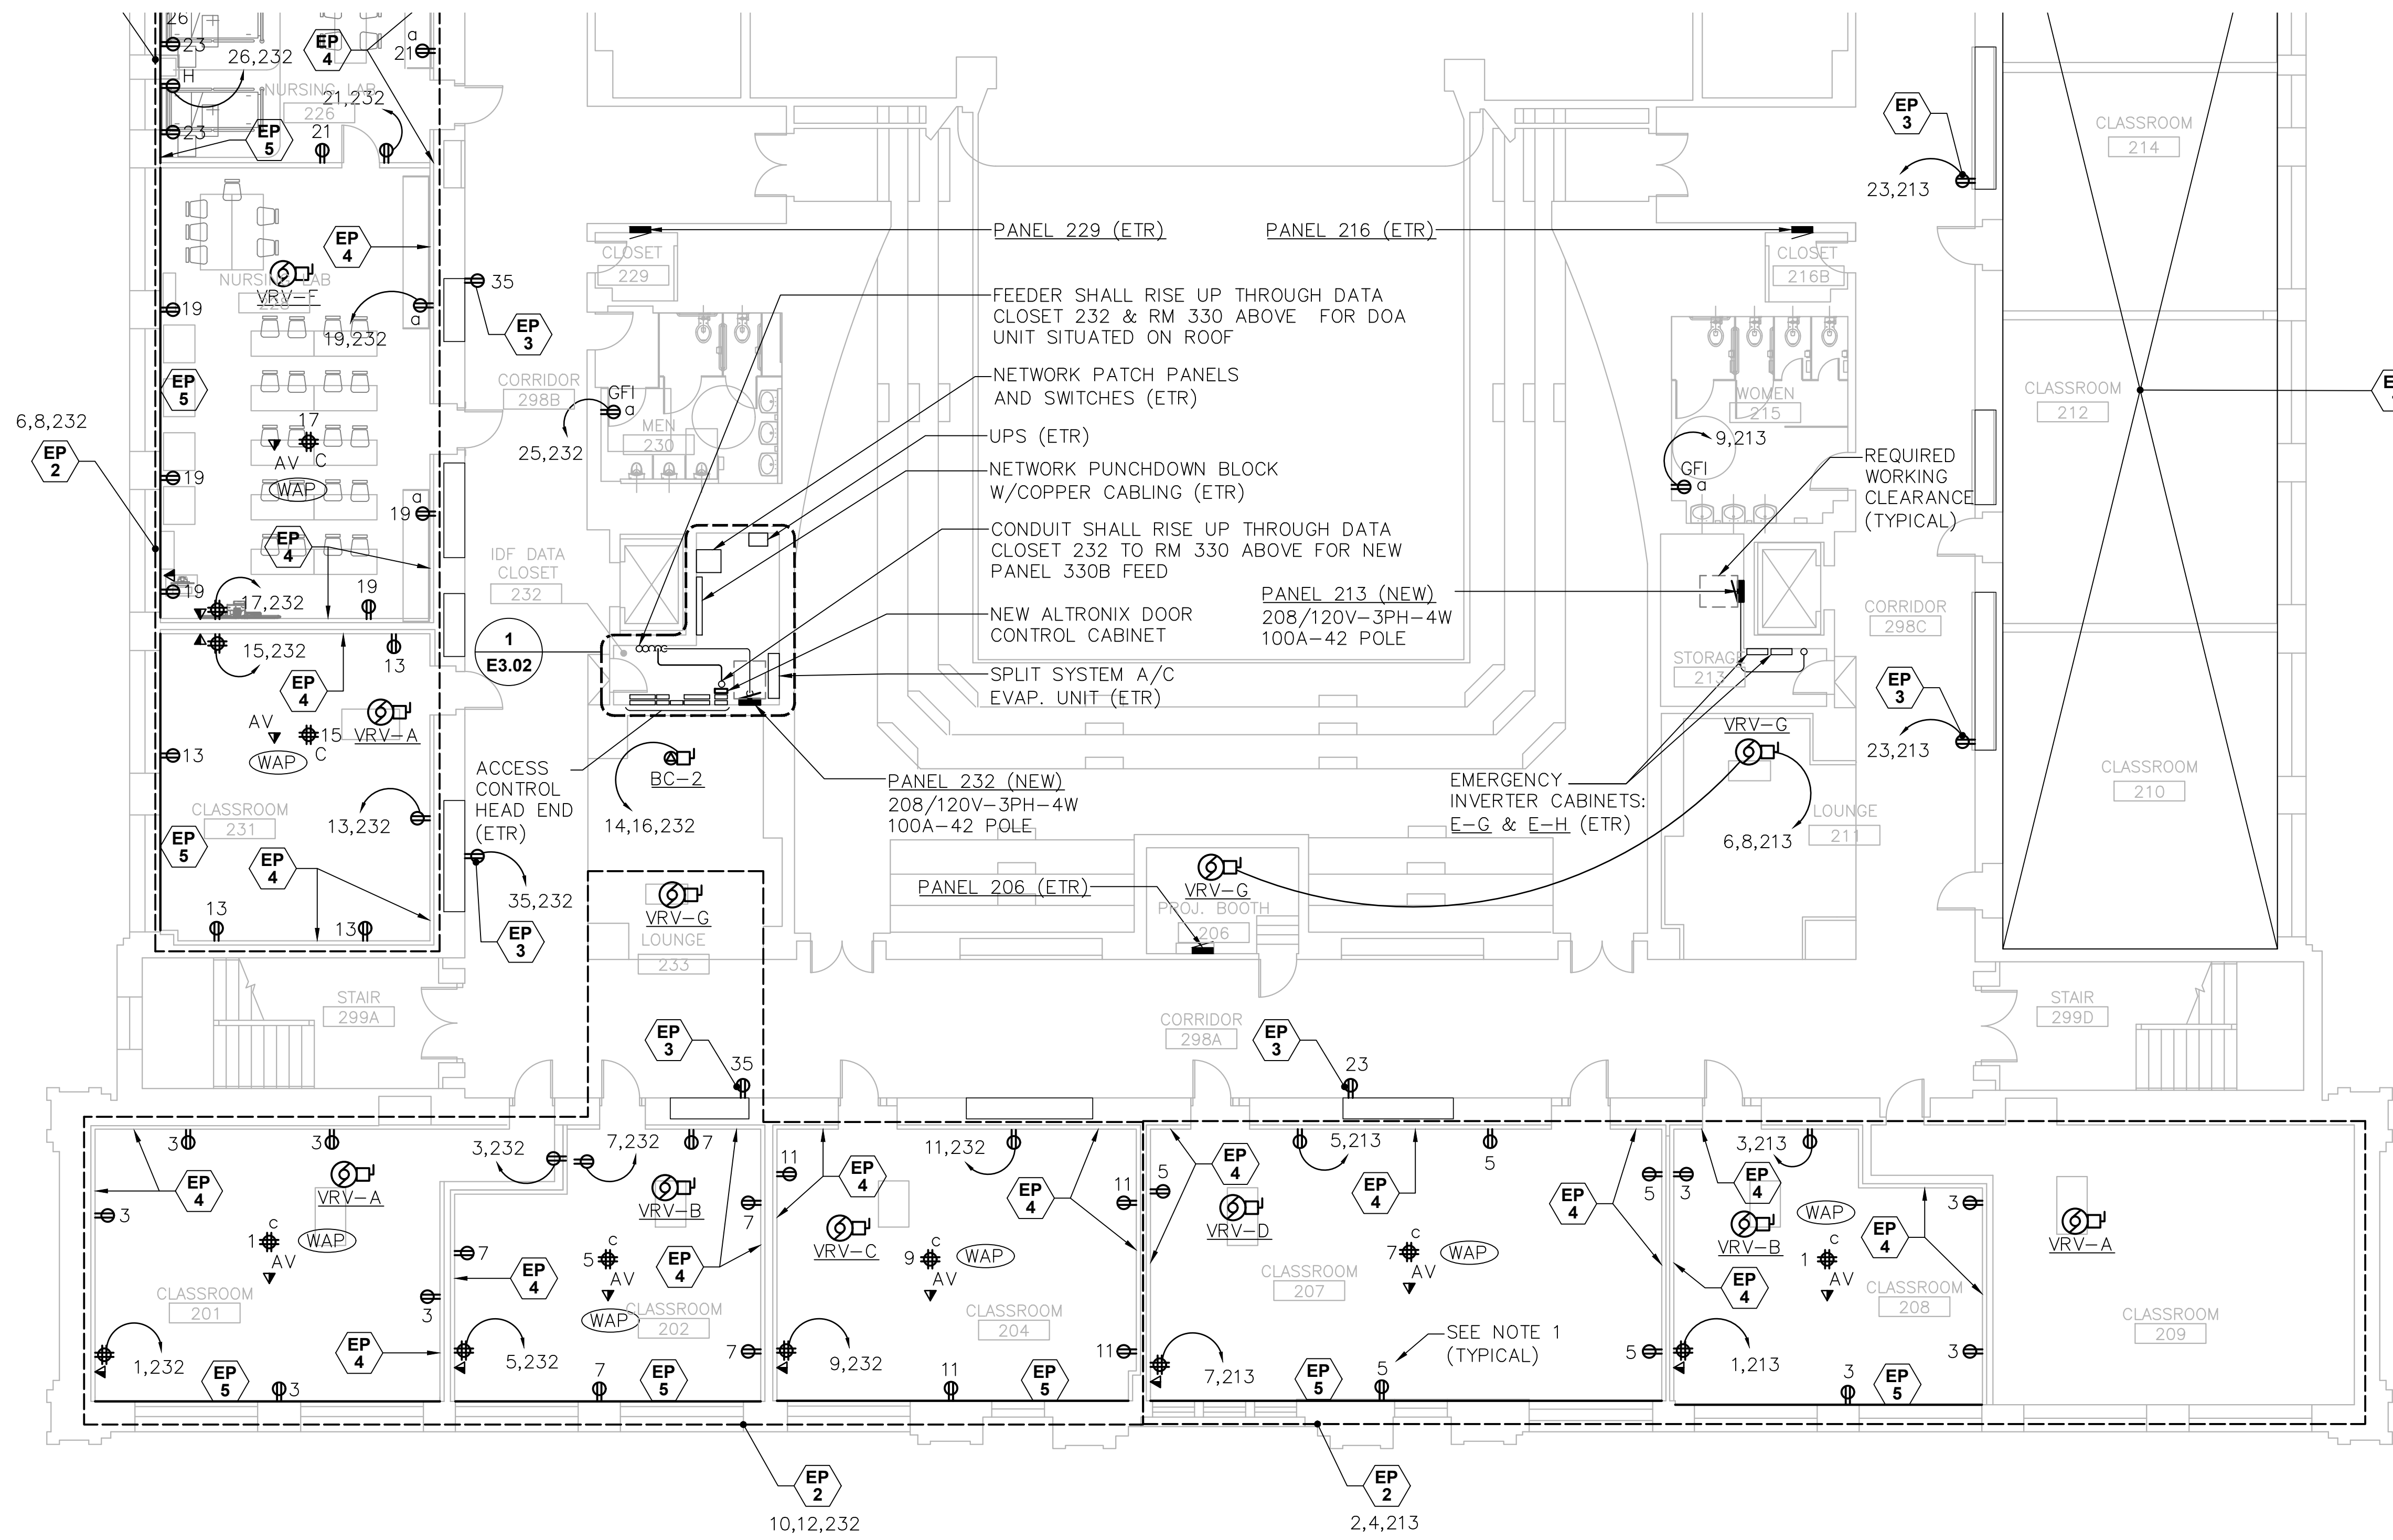


1 ELECTRICAL POWER SECOND FLOOR PLAN-SOUTH
SCALE: 1/8" = 1'-0"

| ELECTRICAL POWER KEY NOTES | |
|----------------------------|--|
| EP 1 | NO ELECTRICAL WORK TO BE PERFORMED IN THIS AREA UNDER THIS CONTRACT. |
| EP 2 | ALL VRV UNITS WITHIN THIS AREA SHALL BE DAISY CHAINED AND CIRCUITED AS NOTED. REFER TO MOTOR CIRCUIT SCHEDULE ON DRAWING E2.03 FOR MORE INFORMATION. |
| EP 3 | RECEPTACLE SHALL BE MOUNTED HORIZONTALLY AT FLOOR LEVEL IN THE BENCH SEATING KICKSPACE. |
| EP 4 | EXISTING DEVICES WITH BACKBOXES AND CONDUIT THAT ARE LOCATED IN WALL CONSTRUCTION THAT WILL BE FURRED OUT AS PART OF THE OVERALL RENOVATION SHALL BE RETROFIT WITH BOX EXTENSIONS THAT SHALL PROMOTE A FLUSH INSTALLATION WITH THE NEW WALL SURFACE. ALL BOX LOCATIONS THAT HAVE EMPTY BACKBOXES SHALL BE REVIEWED WITH OWNER AND ENGINEER FOR A DECISION TO REMOVE OR ABANDON IN PLACE. |
| EP 5 | PROVIDE WIREMOLD V4000 DUAL COMPARTMENT. |

| ELECTRICAL POWER GENERAL NOTES | |
|--------------------------------|---|
| 1. | NUMBERS INDICATED ADJACENT TO ELECTRICAL DEVICES, FIXTURES AND EQUIPMENT REPRESENTS THE CIRCUIT NUMBER THAT THE CIRCUIT SHALL CONNECT TO. REFER TO CIRCUIT HOMERUNS IDENTIFIED WITHIN THE DRAWING THAT THE EQUIPMENT IS PLACED ON FOR THE PROPER HOMERUN. |
| 2. | CONDUIT RISER AND PATHWAY LOCATIONS SHALL BE COORDINATED WITH EXISTING PIPING, DUCTS, CONDUITS, BUILDING STEEL AND STRUCTURAL ELEMENTS. |
| 3. | PROVIDE APPROPRIATE FLOOR CORING PENETRATIONS AND SEAL WITH APPROVED FIRESTOP MATERIALS. REFER TO A9.01 AND A9.02 FOR DETAILS. |
| 4. | ALL BRANCH CIRCUITS SHALL BE INSTALLED IN EMT CONDUIT FROM THE PANELBOARD TO THE FIRST DEVICE OR PIECE OF EQUIPMENT ON THE CIRCUIT. WIRING FROM THE FIRST DEVICE TO ADDITIONAL DEVICES SHALL BE INSTALLED IN EMT CONDUIT OR MC CABLE. FLEX CONDUIT (GREENFIELD) WILL BE ALLOWED FOR FINAL WHIP CONNECTIONS OF 6 FEET IN LENGTH OR LESS. TYPE NM AND AC CABLE WILL NOT BE ALLOWED. |

| drawing title | | STATE OF CONNECTICUT | |
|---|-------------|---------------------------------------|---------------|
| SECOND FLOOR - SOUTH POWER PARTIAL PLAN | | DEPARTMENT OF ADMINISTRATIVE SERVICES | |
| REVISIONS | | | |
| mark | date | description | |
| | 8/4/17 | SCHEMATIC DESIGN SUBMISSION | |
| | 1/15/18 | DESIGN DEVELOPMENT SUBMISSION | |
| | 4/16/18 | CONSTRUCTION DOCUMENTS | |
| | 5/23/18 | | |
| | 7/25/18 | | |
| | 12/1/19 | | |
| drawing prepared by | | CONSULTING ENGINEERING SERVICES, INC. | |
| date | | 811 MIDDLE STREET | |
| scale | | MIDDLETOWN, CT | |
| project | | WESTERN CT STATE UNIVERSITY | |
| drawn by | | WHITE HALL | |
| approved by | | 2ND AND 3RD FLOOR RENOVATIONS | |
| drawing no. | | DANBURY, CONNECTICUT | |
| CAD no. | project no. | BI-RD-299 | |
| | | | EP1.02 |

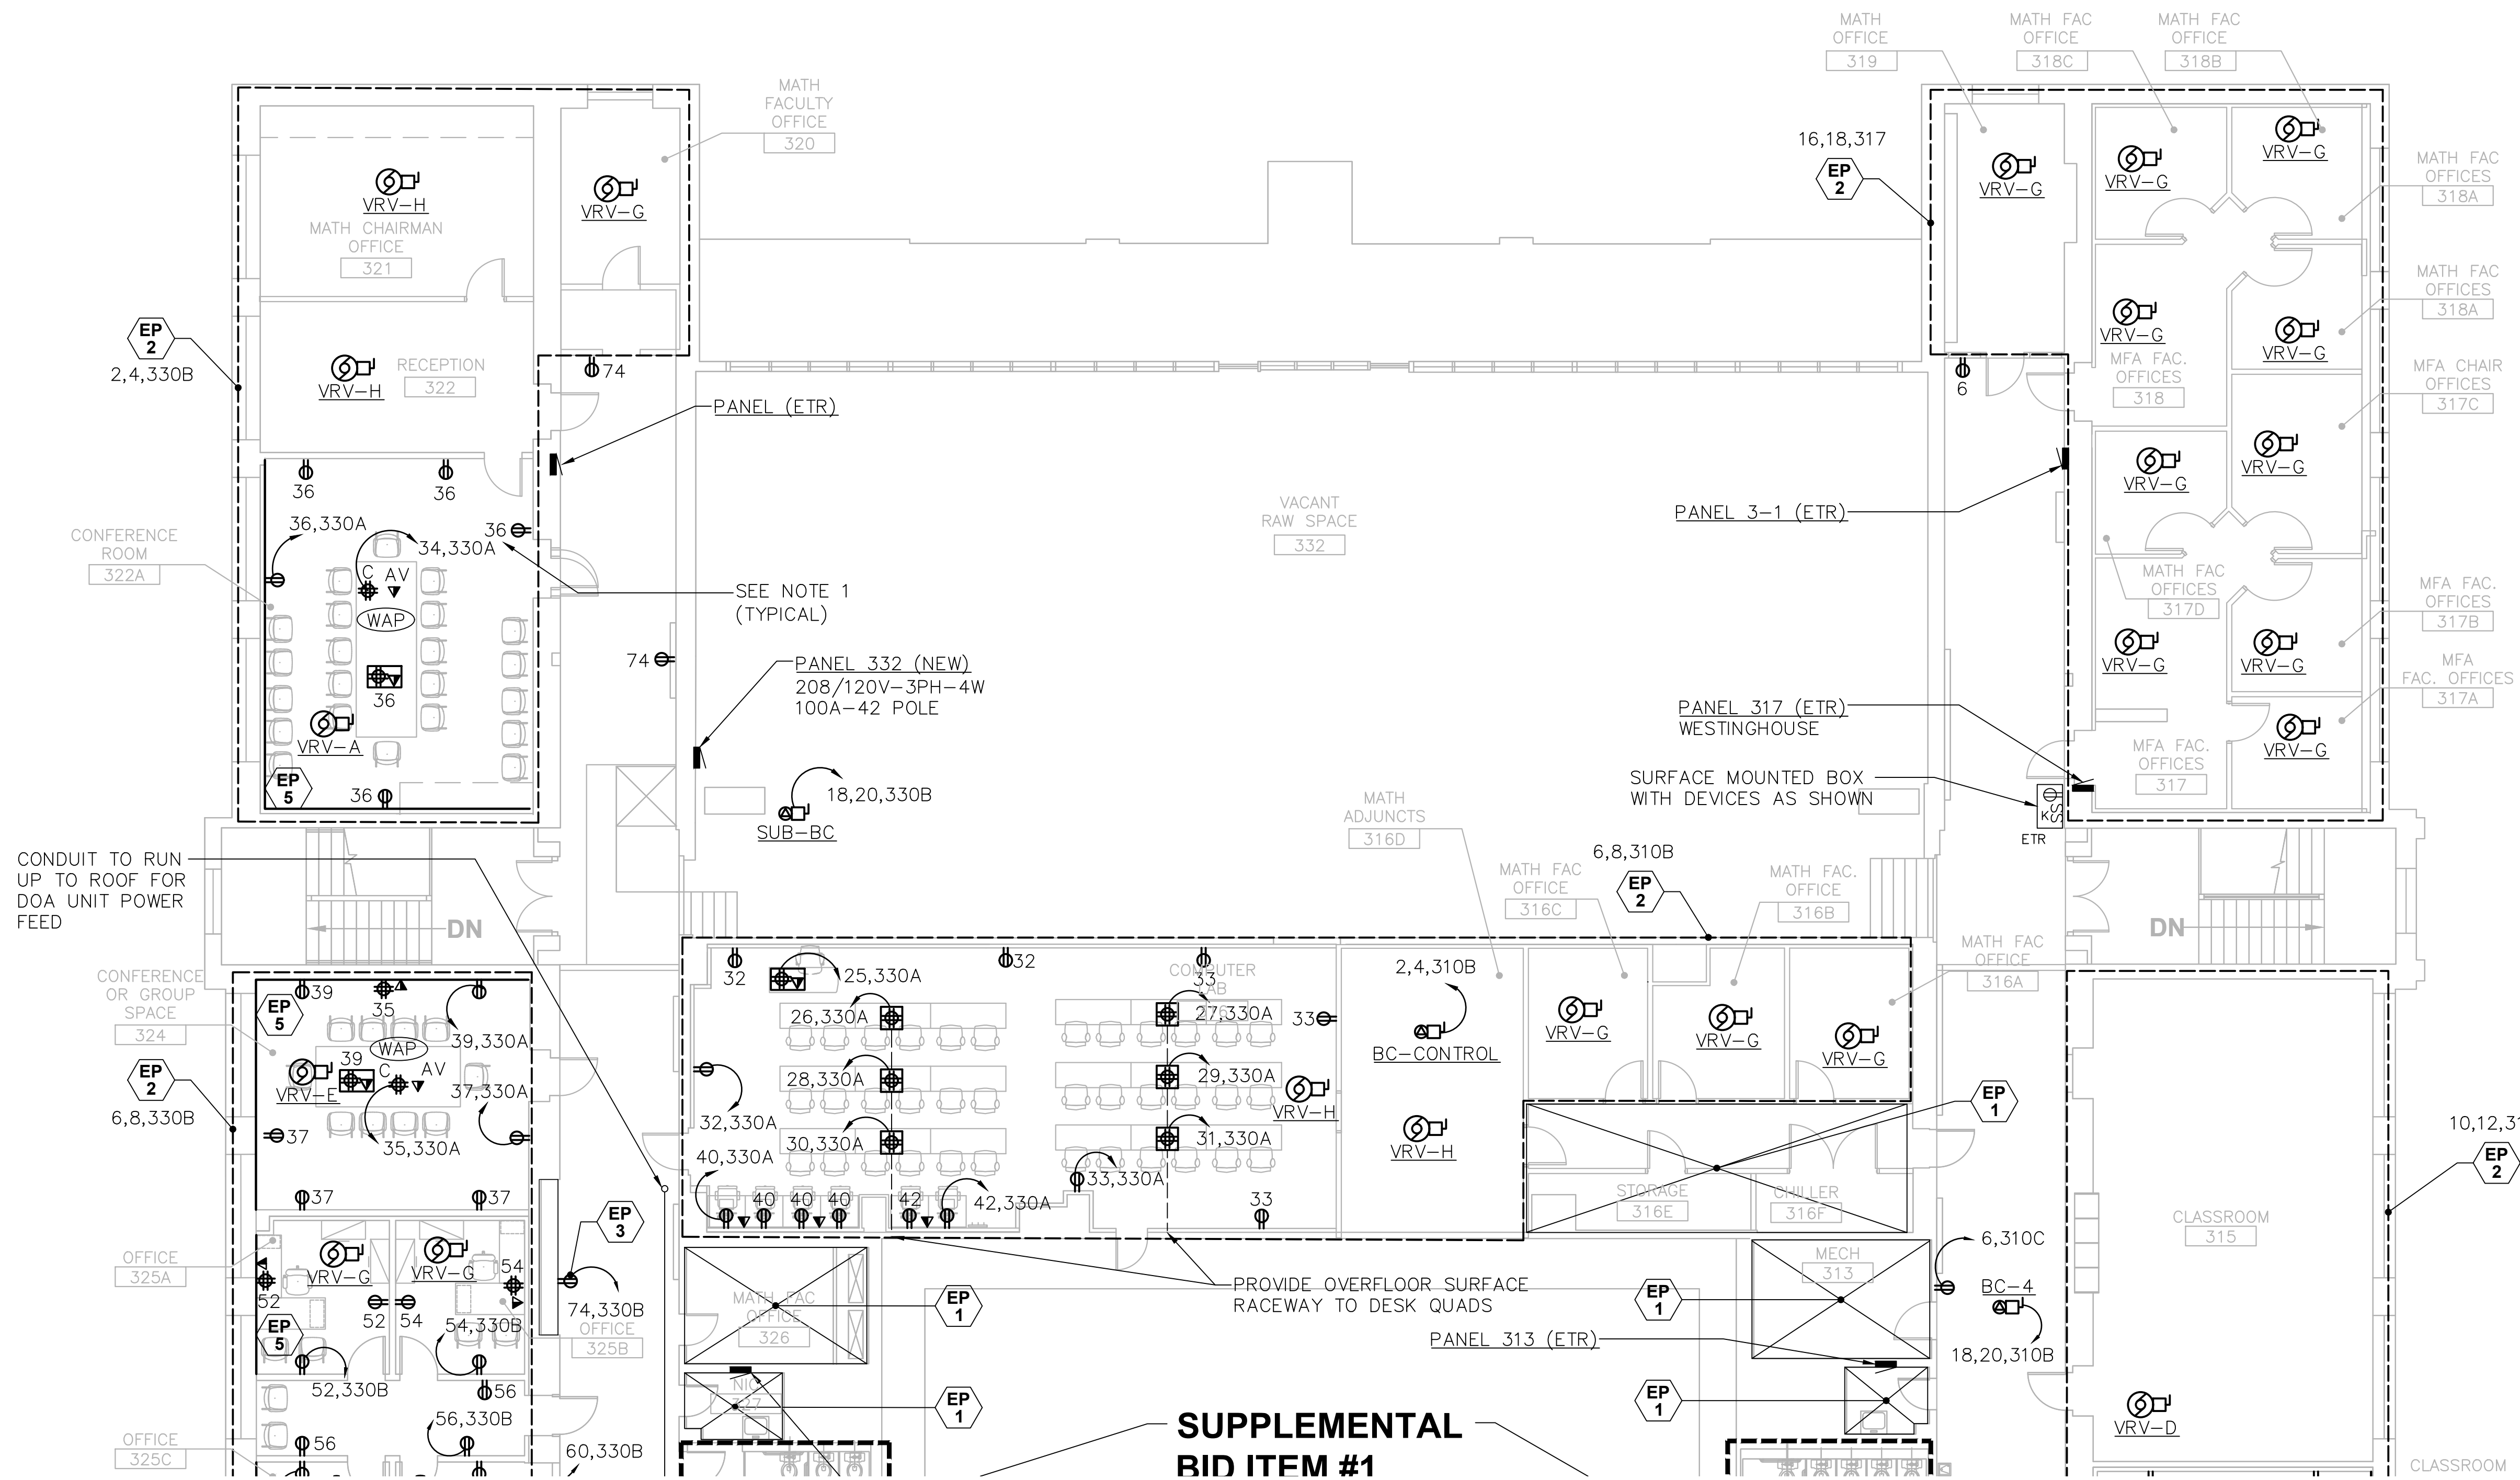


1 ELECTRICAL POWER THIRD FLOOR PLAN-NORTH
SCALE: 1/8"=1'-0"

- ELECTRICAL POWER KEY NOTES**
- EP 1 NO ELECTRICAL WORK TO BE PERFORMED IN THIS AREA UNDER THIS CONTRACT.
 - EP 2 ALL VRV UNITS WITHIN THIS AREA SHALL BE DAISY CHAINED AND CIRCUITED AS NOTED. REFER TO MOTOR CIRCUIT SCHEDULE ON DRAWING E2.03 FOR MORE INFORMATION.
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 - EP 5 PROVIDE WIREMOLD V4000 DUAL COMPARTMENT.

- ELECTRICAL POWER GENERAL NOTES**
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| drawing title | | | STATE OF CONNECTICUT | | | |
|--|--|-------------------------------|--|--|----------|--|
| THIRD FLOOR - NORTH POWER PARTIAL PLAN | | | DEPARTMENT OF ADMINISTRATIVE SERVICES | | | |
| REVISIONS | | | | | | |
| mark | date | description | drawing prepared by | date | scale | |
| | 8/4/17 | SCHEMATIC DESIGN SUBMISSION | CONSULTING ENGINEERING SERVICES, INC. 811 MIDDLE STREET MIDDLETOWN, CT | 07/25/18 | AS NOTED | |
| | 1/15/18 | DESIGN DEVELOPMENT SUBMISSION | | | | |
| | 4/16/18 5/23/18 7/25/18 1/21/19 | CONSTRUCTION DOCUMENTS | | | | |
| | | | project | WESTERN CT STATE UNIVERSITY WHITE HALL 2ND AND 3RD FLOOR RENOVATIONS DANBURY, CONNECTICUT | | |
| | | | drawn by | MAL | | |
| | | | approved by | SJM | | |
| | | | drawing no. | EP1.03 | | |
| | | | CAD no. | project no. BI-RD-299 | | |

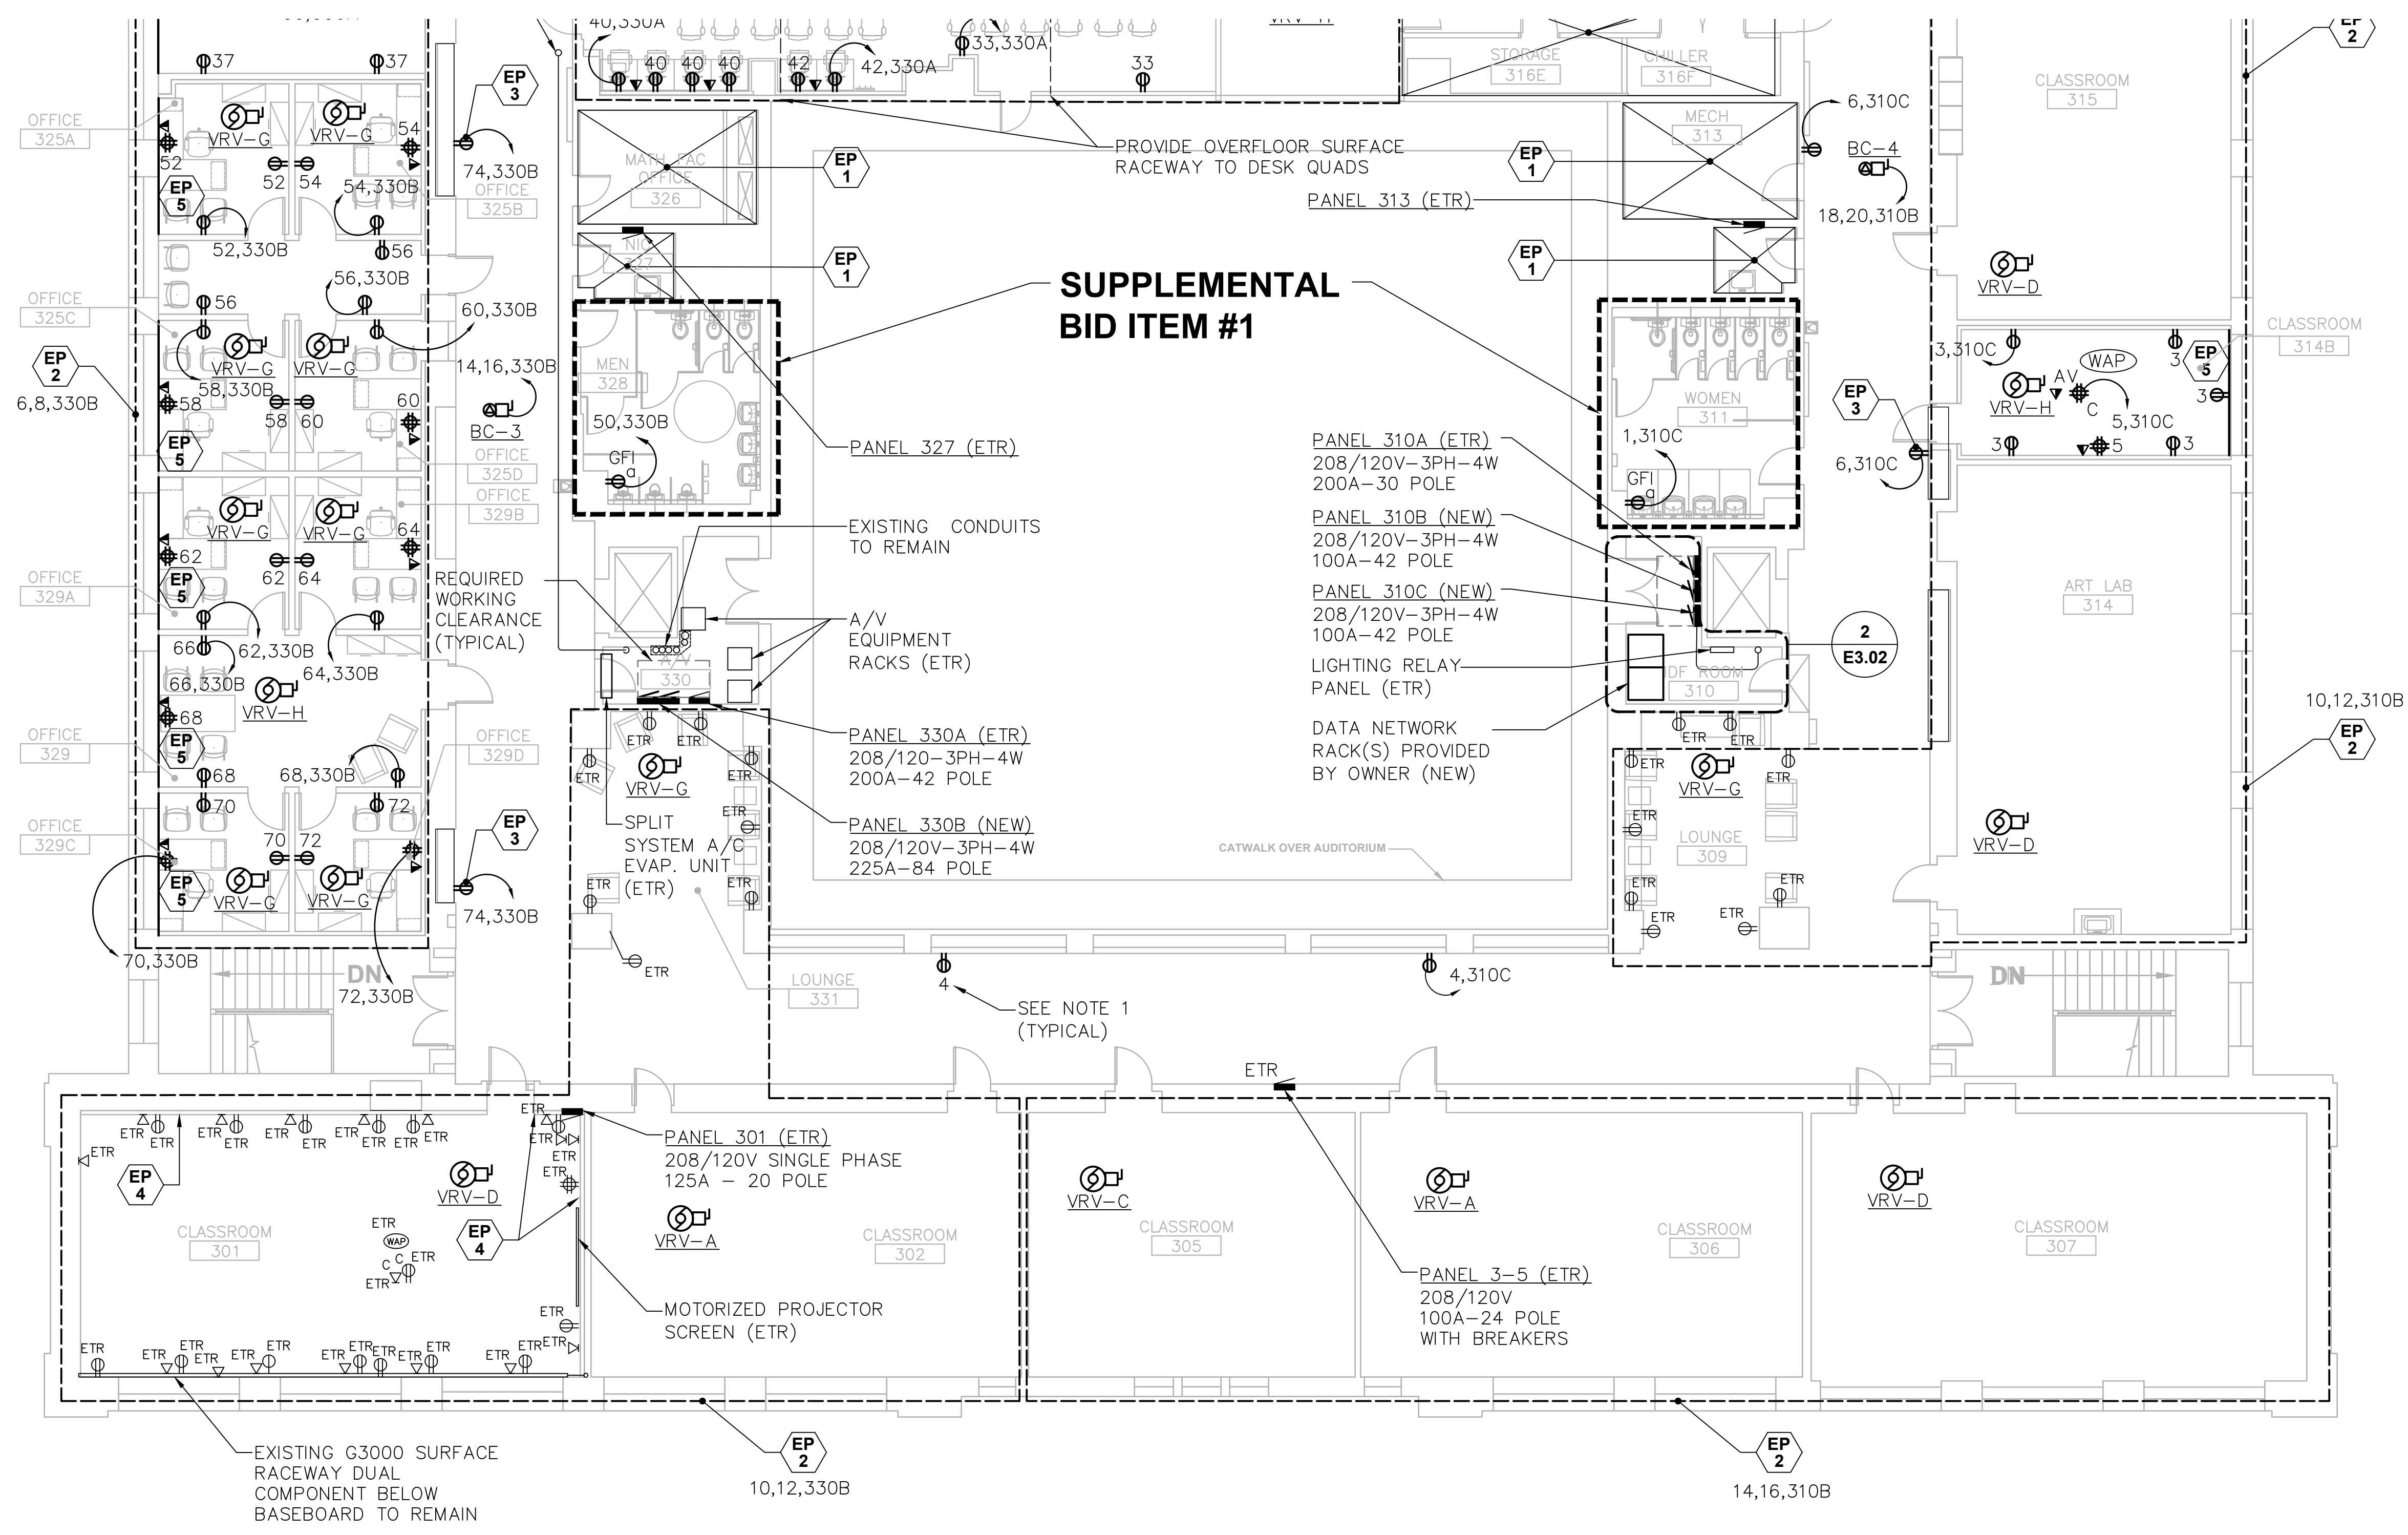


- ELECTRICAL POWER KEY NOTES**
- EP 1 NO ELECTRICAL WORK TO BE PERFORMED IN THIS AREA UNDER THIS CONTRACT.
 - EP 2 ALL VRV UNITS WITHIN THIS AREA SHALL BE DAISY CHAINED AND CIRCUITED AS NOTED. REFER TO MOTOR CIRCUIT SCHEDULE ON DRAWING E2.03 FOR MORE INFORMATION.
 - EP 3 RECEPTACLE SHALL BE MOUNTED HORIZONTALLY AT FLOOR LEVEL IN THE BENCH SEATING KICKSPACE.
 - EP 4 EXISTING DEVICES WITH BACKBOXES AND CONDUIT THAT ARE LOCATED IN WALL CONSTRUCTION THAT WILL BE FURRED OUT AS PART OF THE OVERALL RENOVATION SHALL BE RETROFIT WITH BOX EXTENSIONS THAT SHALL PROMOTE A FLUSH INSTALLATION WITH THE NEW WALL SURFACE. ALL BOX LOCATIONS THAT HAVE EMPTY BACKBOXES SHALL BE REVIEWED WITH OWNER AND ENGINEER FOR A DECISION TO REMOVE OR ABANDON IN PLACE.
 - EP 5 PROVIDE WIREMOLD V4000 DUAL COMPARTMENT.

- ELECTRICAL POWER GENERAL NOTES**
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1 ELECTRICAL POWER THIRD FLOOR PLAN-SOUTH
SCALE: 1/8" = 1'-0"

| drawing title | | | STATE OF CONNECTICUT DEPARTMENT OF ADMINISTRATIVE SERVICES | | | |
|--|--|-------------------------------|--|--|-----------|--|
| THIRD FLOOR - SOUTH POWER PARTIAL PLAN | | | REVISIONS | | | |
| mark | date | description | drawing prepared by | date | scale | |
| | 8/4/17 | SCHEMATIC DESIGN SUBMISSION | CONSULTING ENGINEERING SERVICES, INC. 811 MIDDLE STREET MIDDLETOWN, CT | 07/25/18 | AS NOTED | |
| | 1/15/18 | DESIGN DEVELOPMENT SUBMISSION | | | | |
| | 4/16/18 5/23/18 7/25/18 12/1/19 | CONSTRUCTION DOCUMENTS | | | | |
| | | | project | WESTERN CT STATE UNIVERSITY WHITE HALL 2ND AND 3RD FLOOR RENOVATIONS DANBURY, CONNECTICUT | | |
| | | | CAD no. | project no. | BI-RD-299 | |
| | | | drawn by | MAL | | |
| | | | approved by | SJM | | |
| | | | drawing no. | EP1.04 | | |

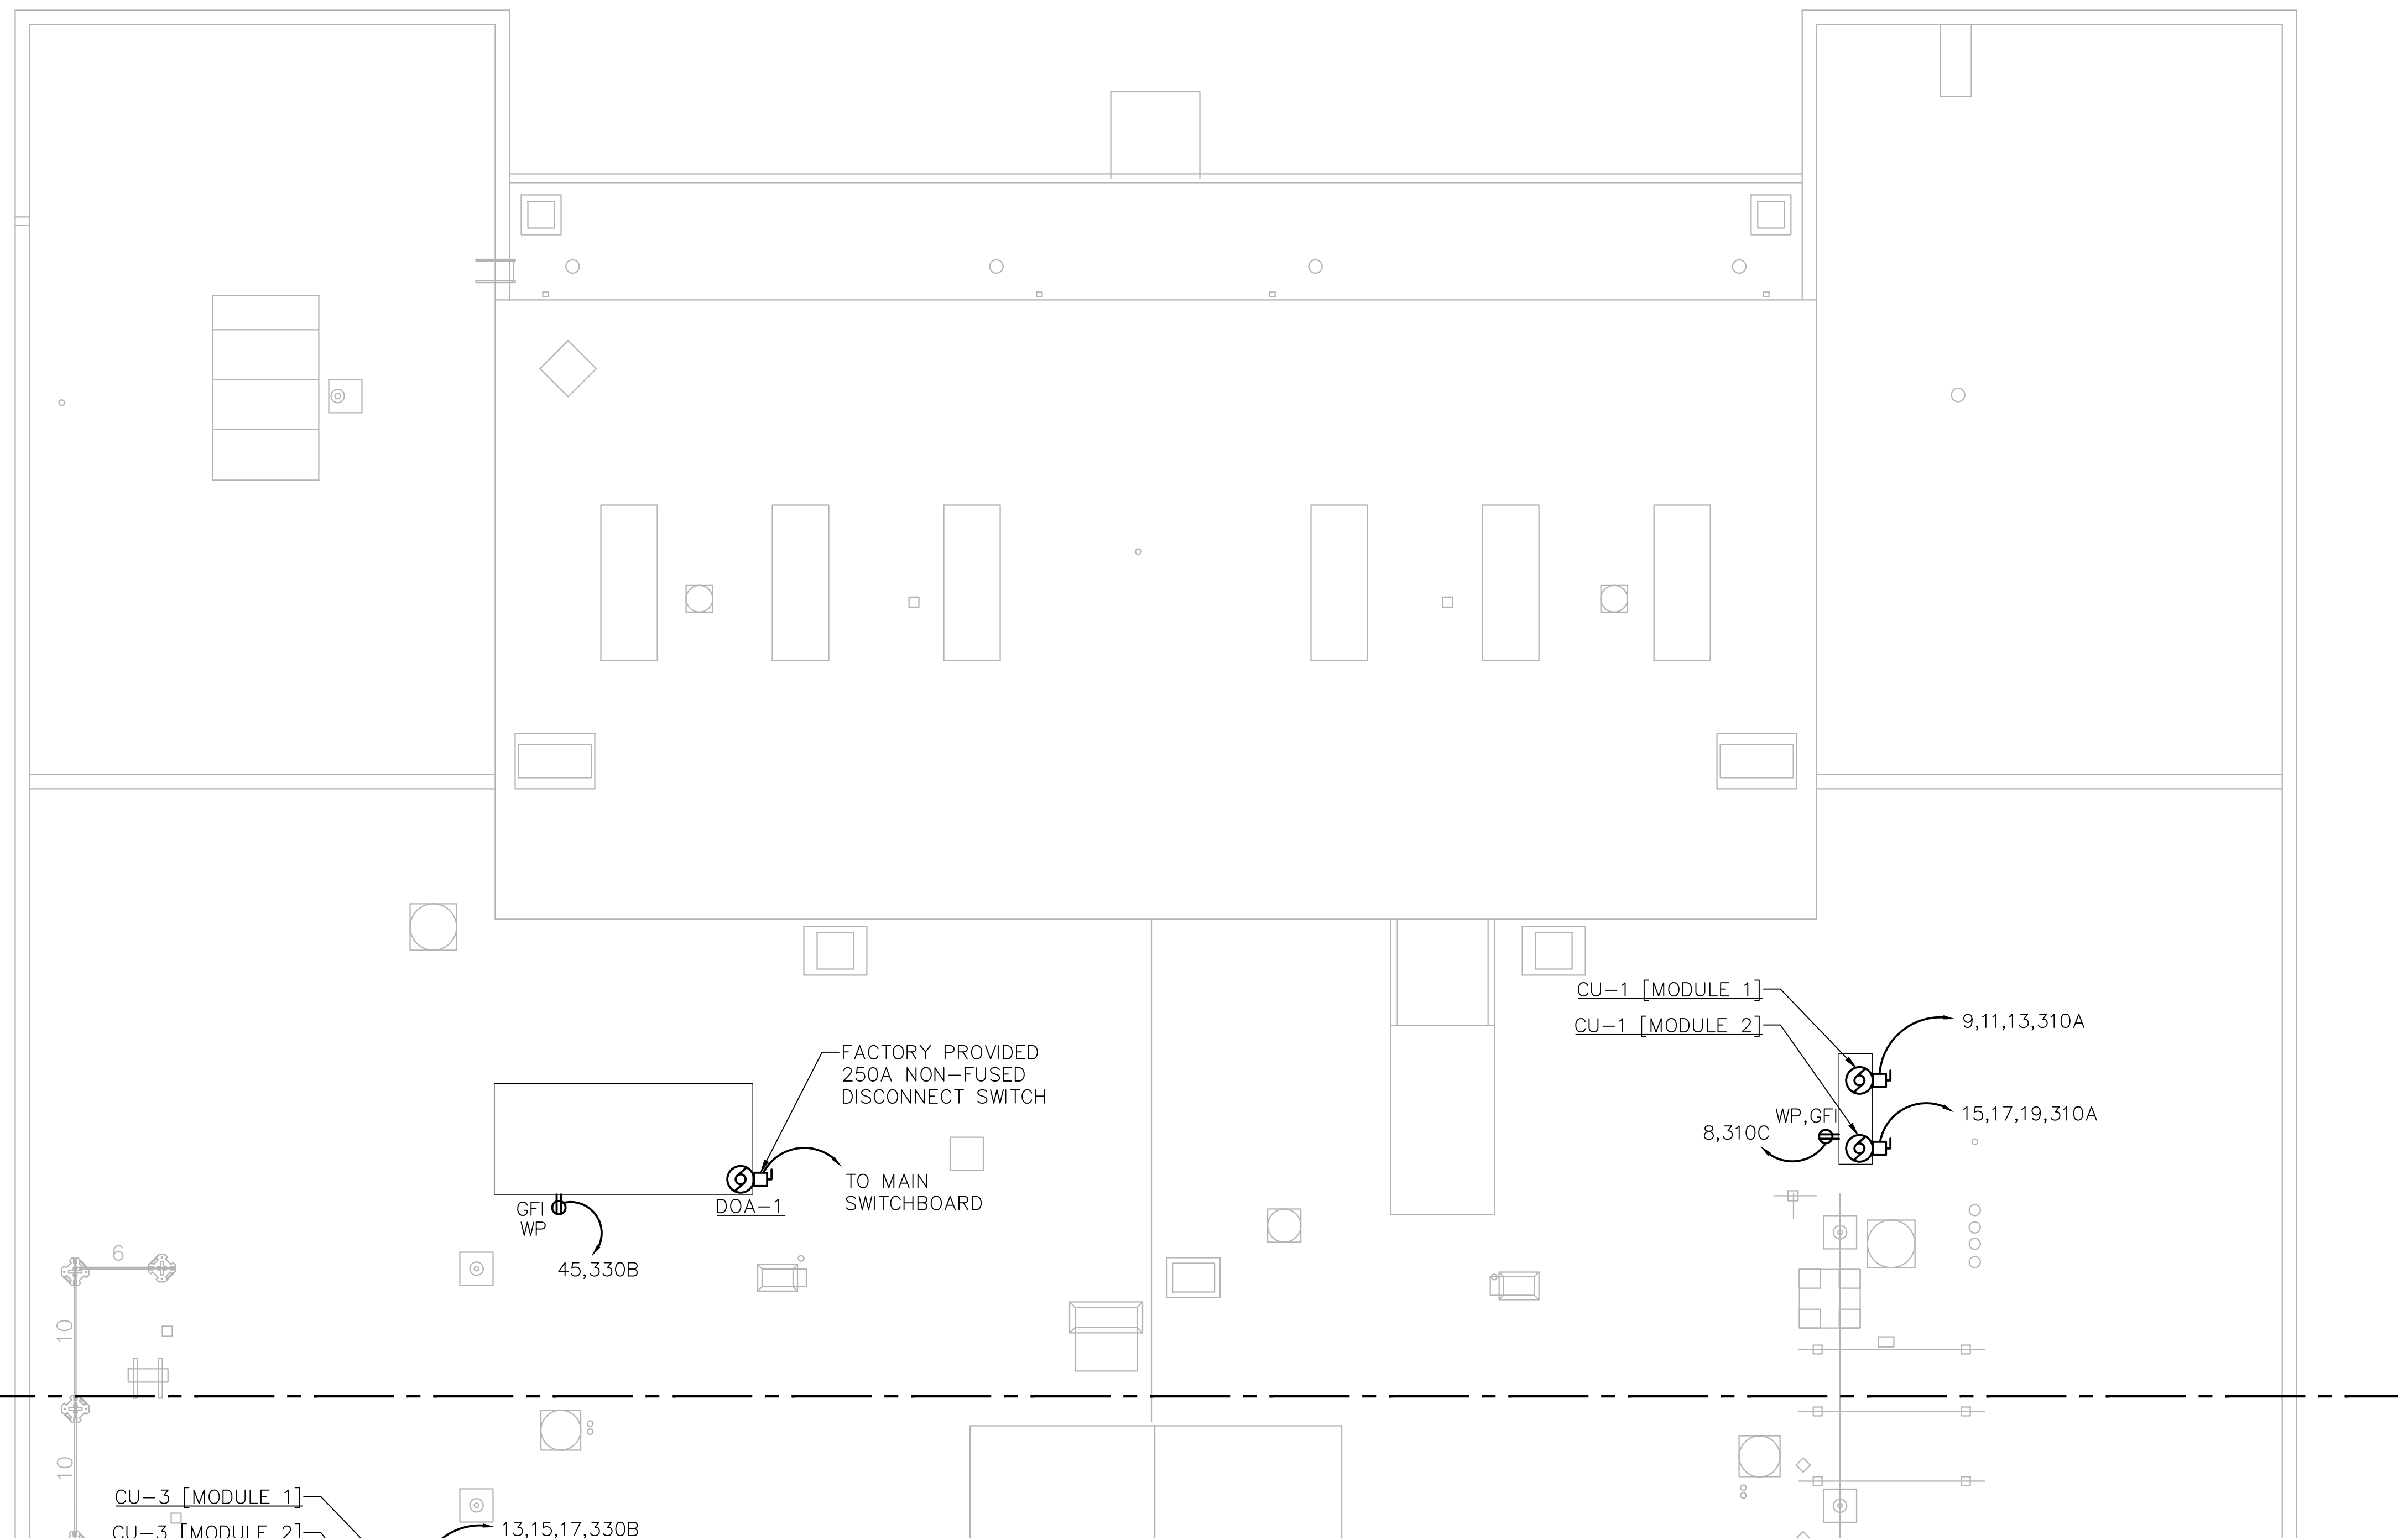

1 ELECTRICAL POWER ROOF PLAN-NORTH
SCALE: 1/8" = 1'-0"

ELECTRICAL POWER KEY NOTES


- EP 1 NO ELECTRICAL WORK TO BE PERFORMED IN THIS AREA UNDER THIS CONTRACT.
- EP 2 ALL VRV UNITS WITHIN THIS AREA SHALL BE DAISY CHAINED AND CIRCUITED AS NOTED. REFER TO MOTOR CIRCUIT SCHEDULE ON DRAWING E2.03 FOR MORE INFORMATION.
- EP 3 RECEPTACLE SHALL BE MOUNTED HORIZONTALLY AT FLOOR LEVEL IN THE BENCH SEATING KICKSPACE.
- EP 4 EXISTING DEVICES WITH BACKBOXES AND CONDUIT THAT ARE LOCATED IN WALL CONSTRUCTION THAT WILL BE FURRED OUT AS PART OF THE OVERALL RENOVATION SHALL BE RETROFIT WITH BOX EXTENSIONS THAT SHALL PROMOTE A FLUSH INSTALLATION WITH THE NEW WALL SURFACE. ALL BOX LOCATIONS THAT HAVE EMPTY BACKBOXES SHALL BE REVIEWED WITH OWNER AND ENGINEER FOR A DECISION TO REMOVE OR ABANDON IN PLACE.
- EP 5 PROVIDE WIREMOLD V4000 DUAL COMPARTMENT.

ELECTRICAL POWER GENERAL NOTES

1. NUMBERS INDICATED ADJACENT TO ELECTRICAL DEVICES, FIXTURES AND EQUIPMENT REPRESENTS THE CIRCUIT NUMBER THAT THE CIRCUIT SHALL CONNECT TO. REFER TO CIRCUIT HOMERUNS IDENTIFIED WITHIN THE DRAWING THAT THE EQUIPMENT IS PLACED ON FOR THE PROPER HOMERUN.
2. CONDUIT RISER AND PATHWAY LOCATIONS SHALL BE COORDINATED WITH EXISTING PIPING, DUCTS, CONDUITS, BUILDING STEEL AND STRUCTURAL ELEMENTS.
3. PROVIDE APPROPRIATE FLOOR CORING PENETRATIONS AND SEAL WITH APPROVED FIRESTOP MATERIALS. REFER TO A9.01 AND A9.02 FOR DETAILS.
4. ALL BRANCH CIRCUITS SHALL BE INSTALLED IN EMT CONDUIT FROM THE PANELBOARD TO THE FIRST DEVICE OR PIECE OF EQUIPMENT ON THE CIRCUIT. WIRING FROM THE FIRST DEVICE TO ADDITIONAL DEVICES SHALL BE INSTALLED IN EMT CONDUIT OR MC CABLE. FLEX CONDUIT (GREENFIELD) WILL BE ALLOWED FOR FINAL WHIP CONNECTIONS OF 6 FEET IN LENGTH OR LESS. TYPE NM AND AC CABLE WILL NOT BE ALLOWED.

| | | | | | | |
|---|--|-------------------------------|--|-------------|---------------|-------------|
| drawing title ROOF - NORTH POWER PARTIAL PLAN | | | STATE OF CONNECTICUT DEPARTMENT OF ADMINISTRATIVE SERVICES | | | |
| REVISIONS | | | | | | |
| mark | date | description | drawing prepared by | date | | |
| | 8/4/17 | SCHEMATIC DESIGN SUBMISSION | CONSULTING ENGINEERING SERVICES, INC. 811 MIDDLE STREET MIDDLETOWN, CT | 07/25/18 | | |
| | 1/15/18 | DESIGN DEVELOPMENT SUBMISSION | | scale | AS NOTED | |
| | 4/16/18 5/23/18 7/25/18 1/21/19 | CONSTRUCTION DOCUMENTS | | project | drawn by | approved by |
| | | | WESTERN CT STATE UNIVERSITY WHITE HALL 2ND AND 3RD FLOOR RENOVATIONS DANBURY, CONNECTICUT | MAL | SJM | |
| | | | CAD no. | project no. | drawing no. | |
| | | | | BI-RD-299 | EP1.05 | |

MATCH LINE

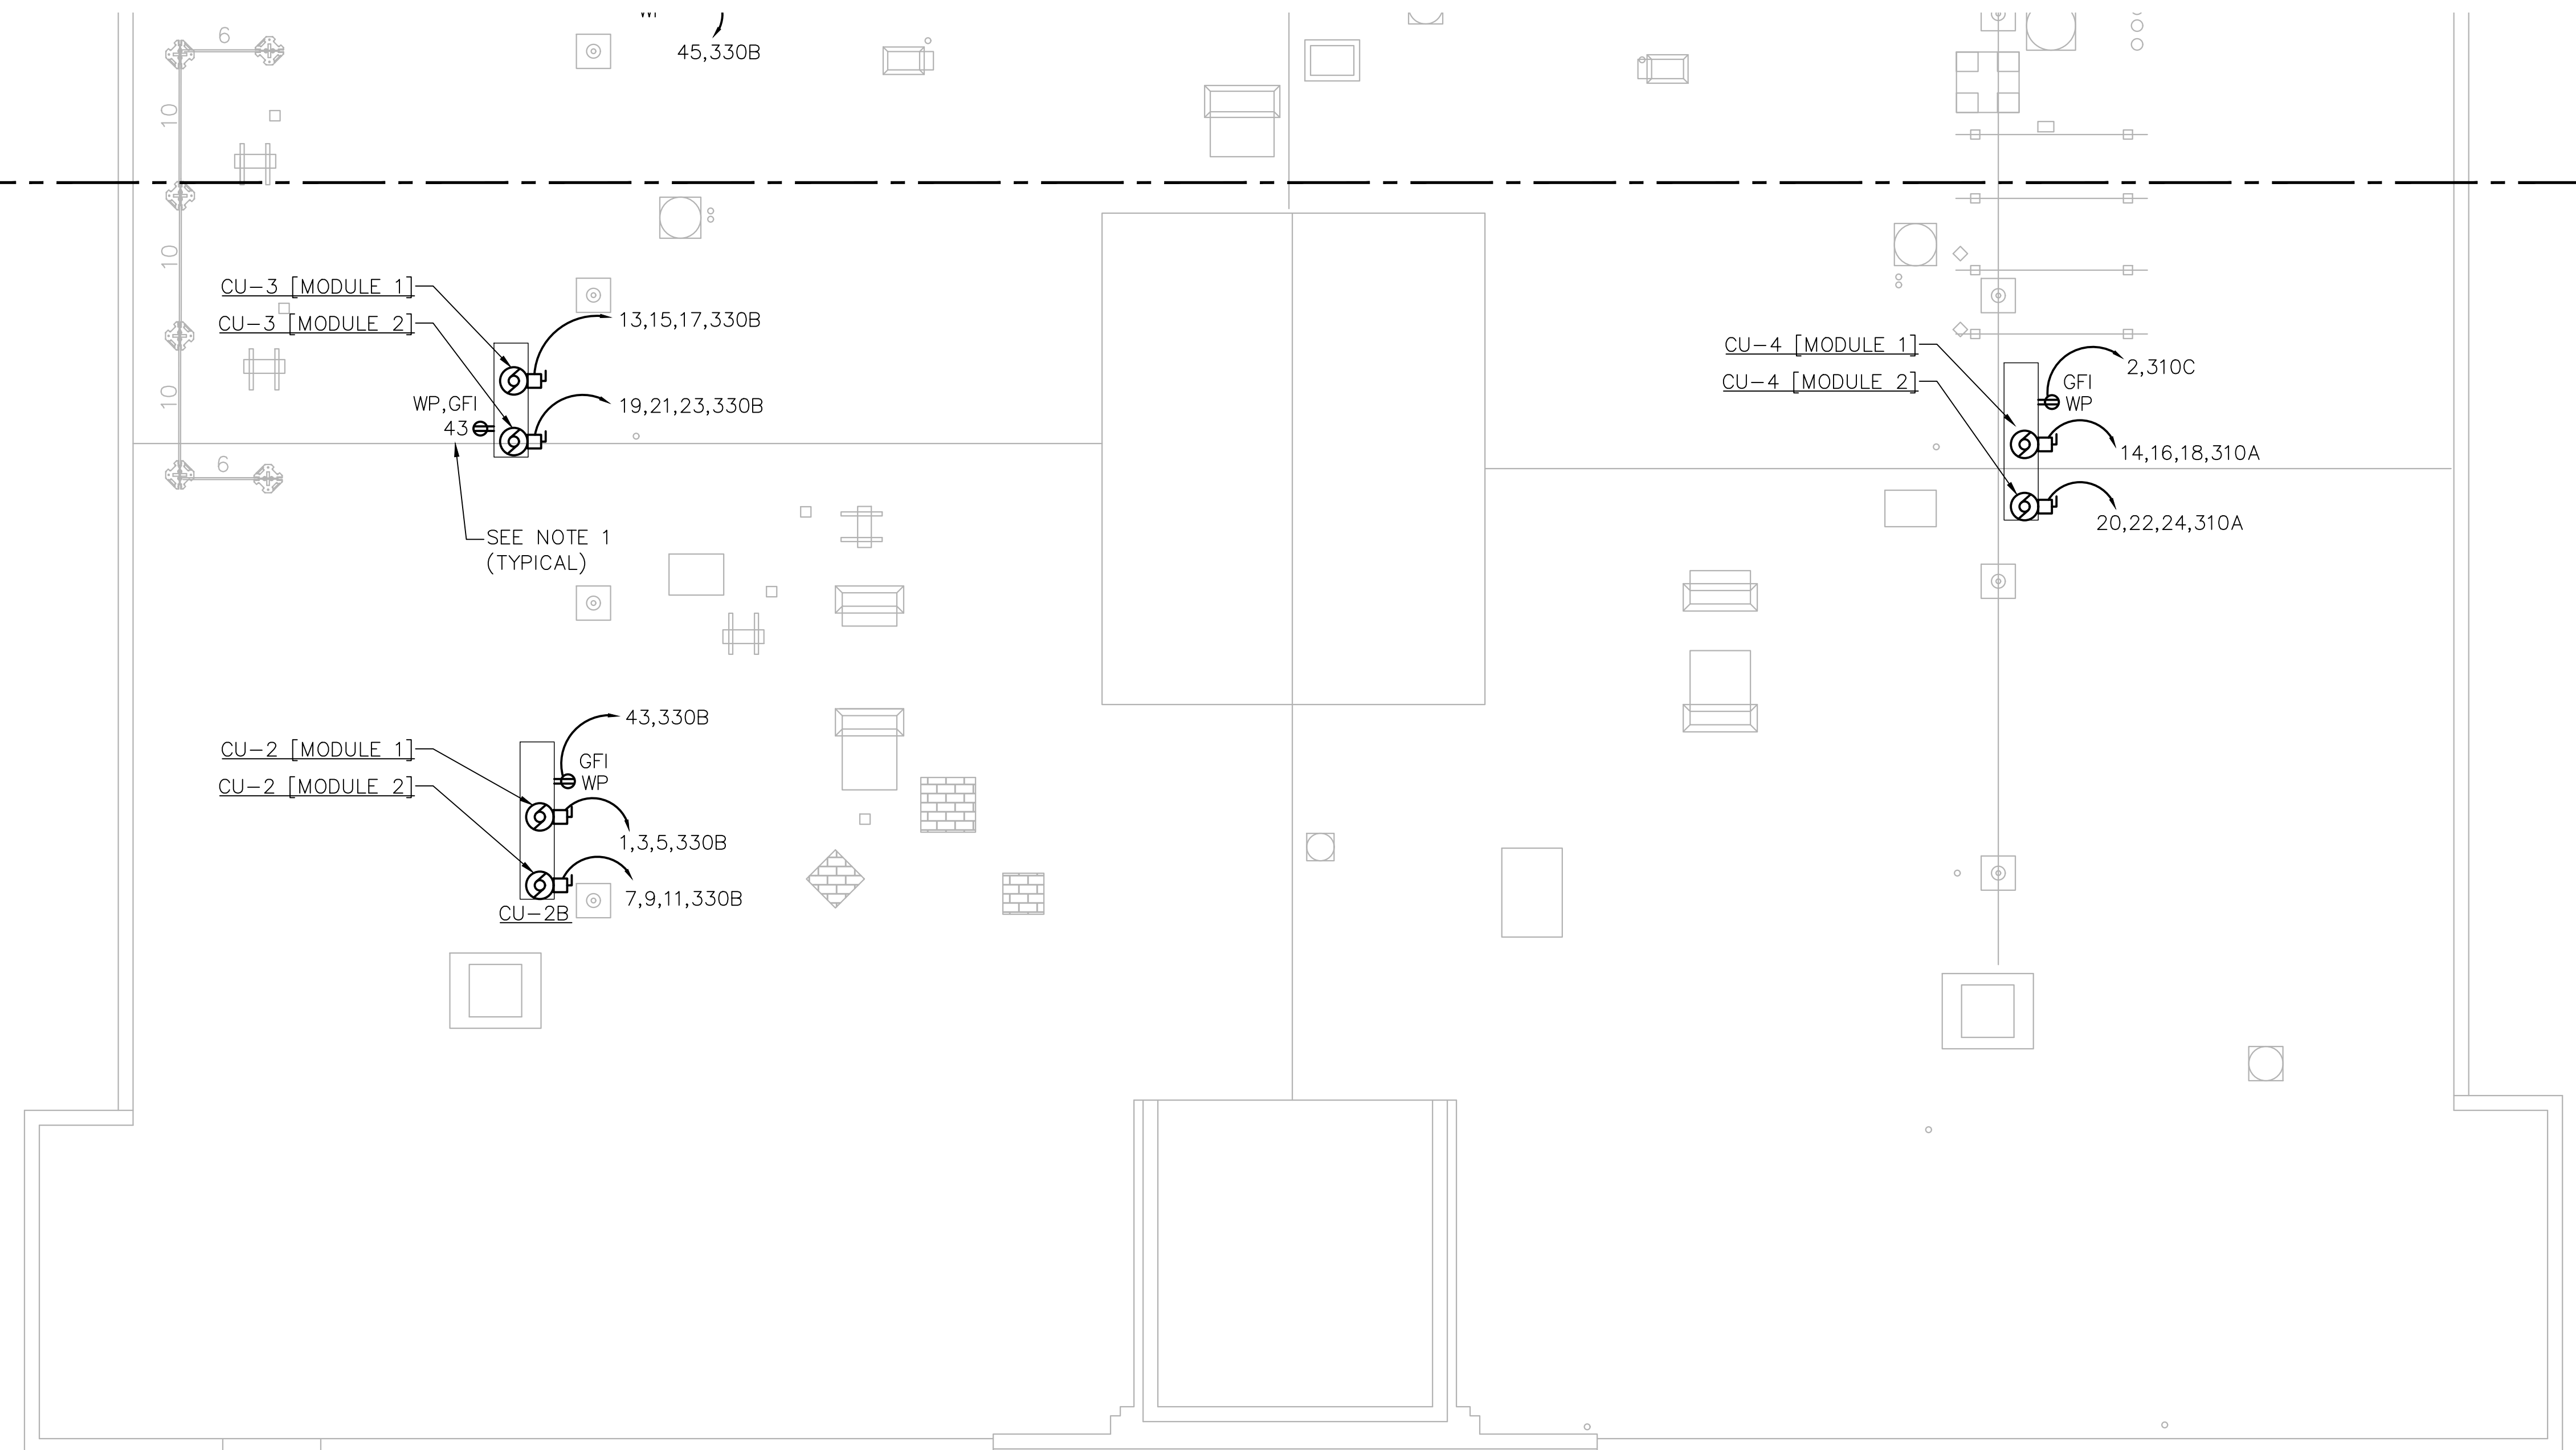

1 ELECTRICAL POWER ROOF PLAN-SOUTH
SCALE: 1/8" = 1'-0"

ELECTRICAL POWER KEY NOTES

- EP 1 NO ELECTRICAL WORK TO BE PERFORMED IN THIS AREA UNDER THIS CONTRACT.
- EP 2 ALL VRY UNITS WITHIN THIS AREA SHALL BE DAISY CHAINED AND CIRCUITED AS NOTED. REFER TO MOTOR CIRCUIT SCHEDULE ON DRAWING E2.03 FOR MORE INFORMATION.
- EP 3 RECEPTACLE SHALL BE MOUNTED HORIZONTALLY AT FLOOR LEVEL IN THE BENCH SEATING KICKSPACE.
- EP 4 EXISTING DEVICES WITH BACKBOXES AND CONDUIT THAT ARE LOCATED IN WALL CONSTRUCTION THAT WILL BE FURRED OUT AS PART OF THE OVERALL RENOVATION SHALL BE RETROFIT WITH BOX EXTENSIONS THAT SHALL PROMOTE A FLUSH INSTALLATION WITH THE NEW WALL SURFACE. ALL BOX LOCATIONS THAT HAVE EMPTY BACKBOXES SHALL BE REVIEWED WITH OWNER AND ENGINEER FOR A DECISION TO REMOVE OR ABANDON IN PLACE.
- EP 5 PROVIDE WIREMOLD V4000 DUAL COMPARTMENT.

ELECTRICAL POWER GENERAL NOTES

1. NUMBERS INDICATED ADJACENT TO ELECTRICAL DEVICES, FIXTURES AND EQUIPMENT REPRESENTS THE CIRCUIT NUMBER THAT THE CIRCUIT SHALL CONNECT TO. REFER TO CIRCUIT HOMERUNS IDENTIFIED WITHIN THE DRAWING THAT THE EQUIPMENT IS PLACED ON FOR THE PROPER HOMERUN.
2. CONDUIT RISER AND PATHWAY LOCATIONS SHALL BE COORDINATED WITH EXISTING PIPING, DUCTS, CONDUITS, BUILDING STEEL AND STRUCTURAL ELEMENTS.
3. PROVIDE APPROPRIATE FLOOR CORING PENETRATIONS AND SEAL WITH APPROVED FIRESTOP MATERIALS. REFER TO A9.01 AND A9.02 FOR DETAILS.
4. ALL BRANCH CIRCUITS SHALL BE INSTALLED IN EMT CONDUIT FROM THE PANELBOARD TO THE FIRST DEVICE OR PIECE OF EQUIPMENT ON THE CIRCUIT. WIRING FROM THE FIRST DEVICE TO ADDITIONAL DEVICES SHALL BE INSTALLED IN EMT CONDUIT OR MC CABLE. FLEX CONDUIT (GREENFIELD) WILL BE ALLOWED FOR FINAL WHIP CONNECTIONS OF 6 FEET IN LENGTH OR LESS. TYPE NM AND AC CABLE WILL NOT BE ALLOWED.

| | | | | | |
|---|---------|-------------------------------|--|-------------|---------------|
| drawing title ROOF - SOUTH POWER PARTIAL PLAN | | | STATE OF CONNECTICUT DEPARTMENT OF ADMINISTRATIVE SERVICES | | |
| REVISIONS | | | | | |
| mark | date | description | drawing prepared by | date | scale |
| | 8/4/17 | SCHEMATIC DESIGN SUBMISSION | CONSULTING ENGINEERING SERVICES, INC. 811 MIDDLE STREET MIDDLETOWN, CT | 07/25/18 | AS NOTED |
| | 1/15/18 | DESIGN DEVELOPMENT SUBMISSION | | | |
| | 4/16/18 | CONSTRUCTION DOCUMENTS | project | | |
| | 5/23/18 | | WESTERN CT STATE UNIVERSITY | | |
| | 7/25/18 | | WHITE HALL | | |
| | 1/21/19 | | 2ND AND 3RD FLOOR RENOVATIONS | | |
| | | | DANBURY, CONNECTICUT | | |
| | | | CAD no. | project no. | |
| | | | | BI-RD-299 | |
| | | | | | EP1.06 |



ELECTRICAL SECURITY KEY NOTES


- ES 1 EXISTING ACCESS CONTROLLED DOOR TO REMAIN. NO WORK UNDER THIS CONTRACT.
- ES 2 NEW ACCESS CONTROLLED DOOR WITH THE FOLLOWING:
 - ELECTRIFIED LOCKSET (DL) AT NON ADA DOORS
 - ELECTRONIC CRASH BAR (ECB) AT ADA DOORS
 - DOOR CONTACTS
 - DOOR MANAGEMENT ALARM
 - REQUEST TO EXIT
 - CARD READER
 - LOCAL LOCKDOWN
 FOR A DOOR WITH ADA OPERATOR REER TO DETAIL 3/E3.01. FOR A DOOR WITHOUT AN ADA OPERATOR REFER TO DETAIL 2/E3.01.
- ES 3 EXISTING SECURITY TRUNK CABLE PROVISION IS EXISTING AT THIS LOCATION.
- ES 4 INSTALL A NEW SECURITY TRUNK CABLE TO A 4x4 BOX AT THIS DOOR LOCATION LOCATED ABOVE THE CEILING.
- ES 5 EXISTING SECURITY CABLES TO REMAIN IN PLACE AND BE PREPARED FOR FUTURE USE BY OWNER.
- ES 6 SECURITY CAMERA LOCATION, IP BASED WITH HOMERUN TO THIRD FLOOR IDF CLOSET 310 FOR 2nd AND 3rd FLOOR DEVICES.
- ES 7 PROVIDE RACEWAY TO NEAREST CORRIDOR AND STUB UP TO ACCESSIBLE CEILING SPACE.
- ES 8 PROVIDE JUNCTION BOX WITH 120V CONNECTION TO DOOR OPERATOR/PUSH PLATE SYSTEM FROM NEAREST CONVENIENCE RECEPTACLE CIRCUIT WITHIN CORRESPONDING SPACE.
- ES 9 PROVIDE RIB RELAYS #RIB-2UC TO INTERFACE WITH THE LOCKDOWN SYSTEM AT EACH DOOR PROVIDED WITH AN ADA OPERATOR. REFER TO DETAIL 3/E3.01

ELECTRICAL SECURITY GENERAL NOTES

1. SIMPLEX SHALL PROVIDE SHOP DRAWINGS OF PROPOSED FIRE ALARM EQUIPMENT TO ENSURE COMPATIBILITY WITH THE EXISTING SYSTEM.

1 ELECTRICAL SECURITY SECOND FLOOR PLAN-NORTH
SCALE: 1/8"=1'-0"

| | | | | | |
|--|---------|-------------------------------|--|---------------|--------------------|
| drawing title SECOND FLOOR - NORTH SECURITY PARTIAL PLAN | | | STATE OF CONNECTICUT DEPARTMENT OF ADMINISTRATIVE SERVICES | | |
| REVISIONS | | | | | |
| mark | date | description | drawing prepared by | date | |
| | 8/4/17 | SCHEMATIC DESIGN SUBMISSION | CONSULTING ENGINEERING SERVICES, INC. 811 MIDDLE STREET MIDDLETOWN, CT | 07/25/18 | |
| | 1/15/18 | DESIGN DEVELOPMENT SUBMISSION | | | scale AS NOTED |
| | 4/16/18 | CONSTRUCTION DOCUMENTS | project | | drawn by XXX |
| | 5/23/18 | | WESTERN CT STATE UNIVERSITY WHITE HALL 2ND AND 3RD FLOOR RENOVATIONS DANBURY, CONNECTICUT | | approved by XXX |
| | 7/25/18 | | | | |
| | 12/1/19 | | | | |
| CAD no. | | | project no. | ES1.01 | |
| | | | SI-RD-299 | | |

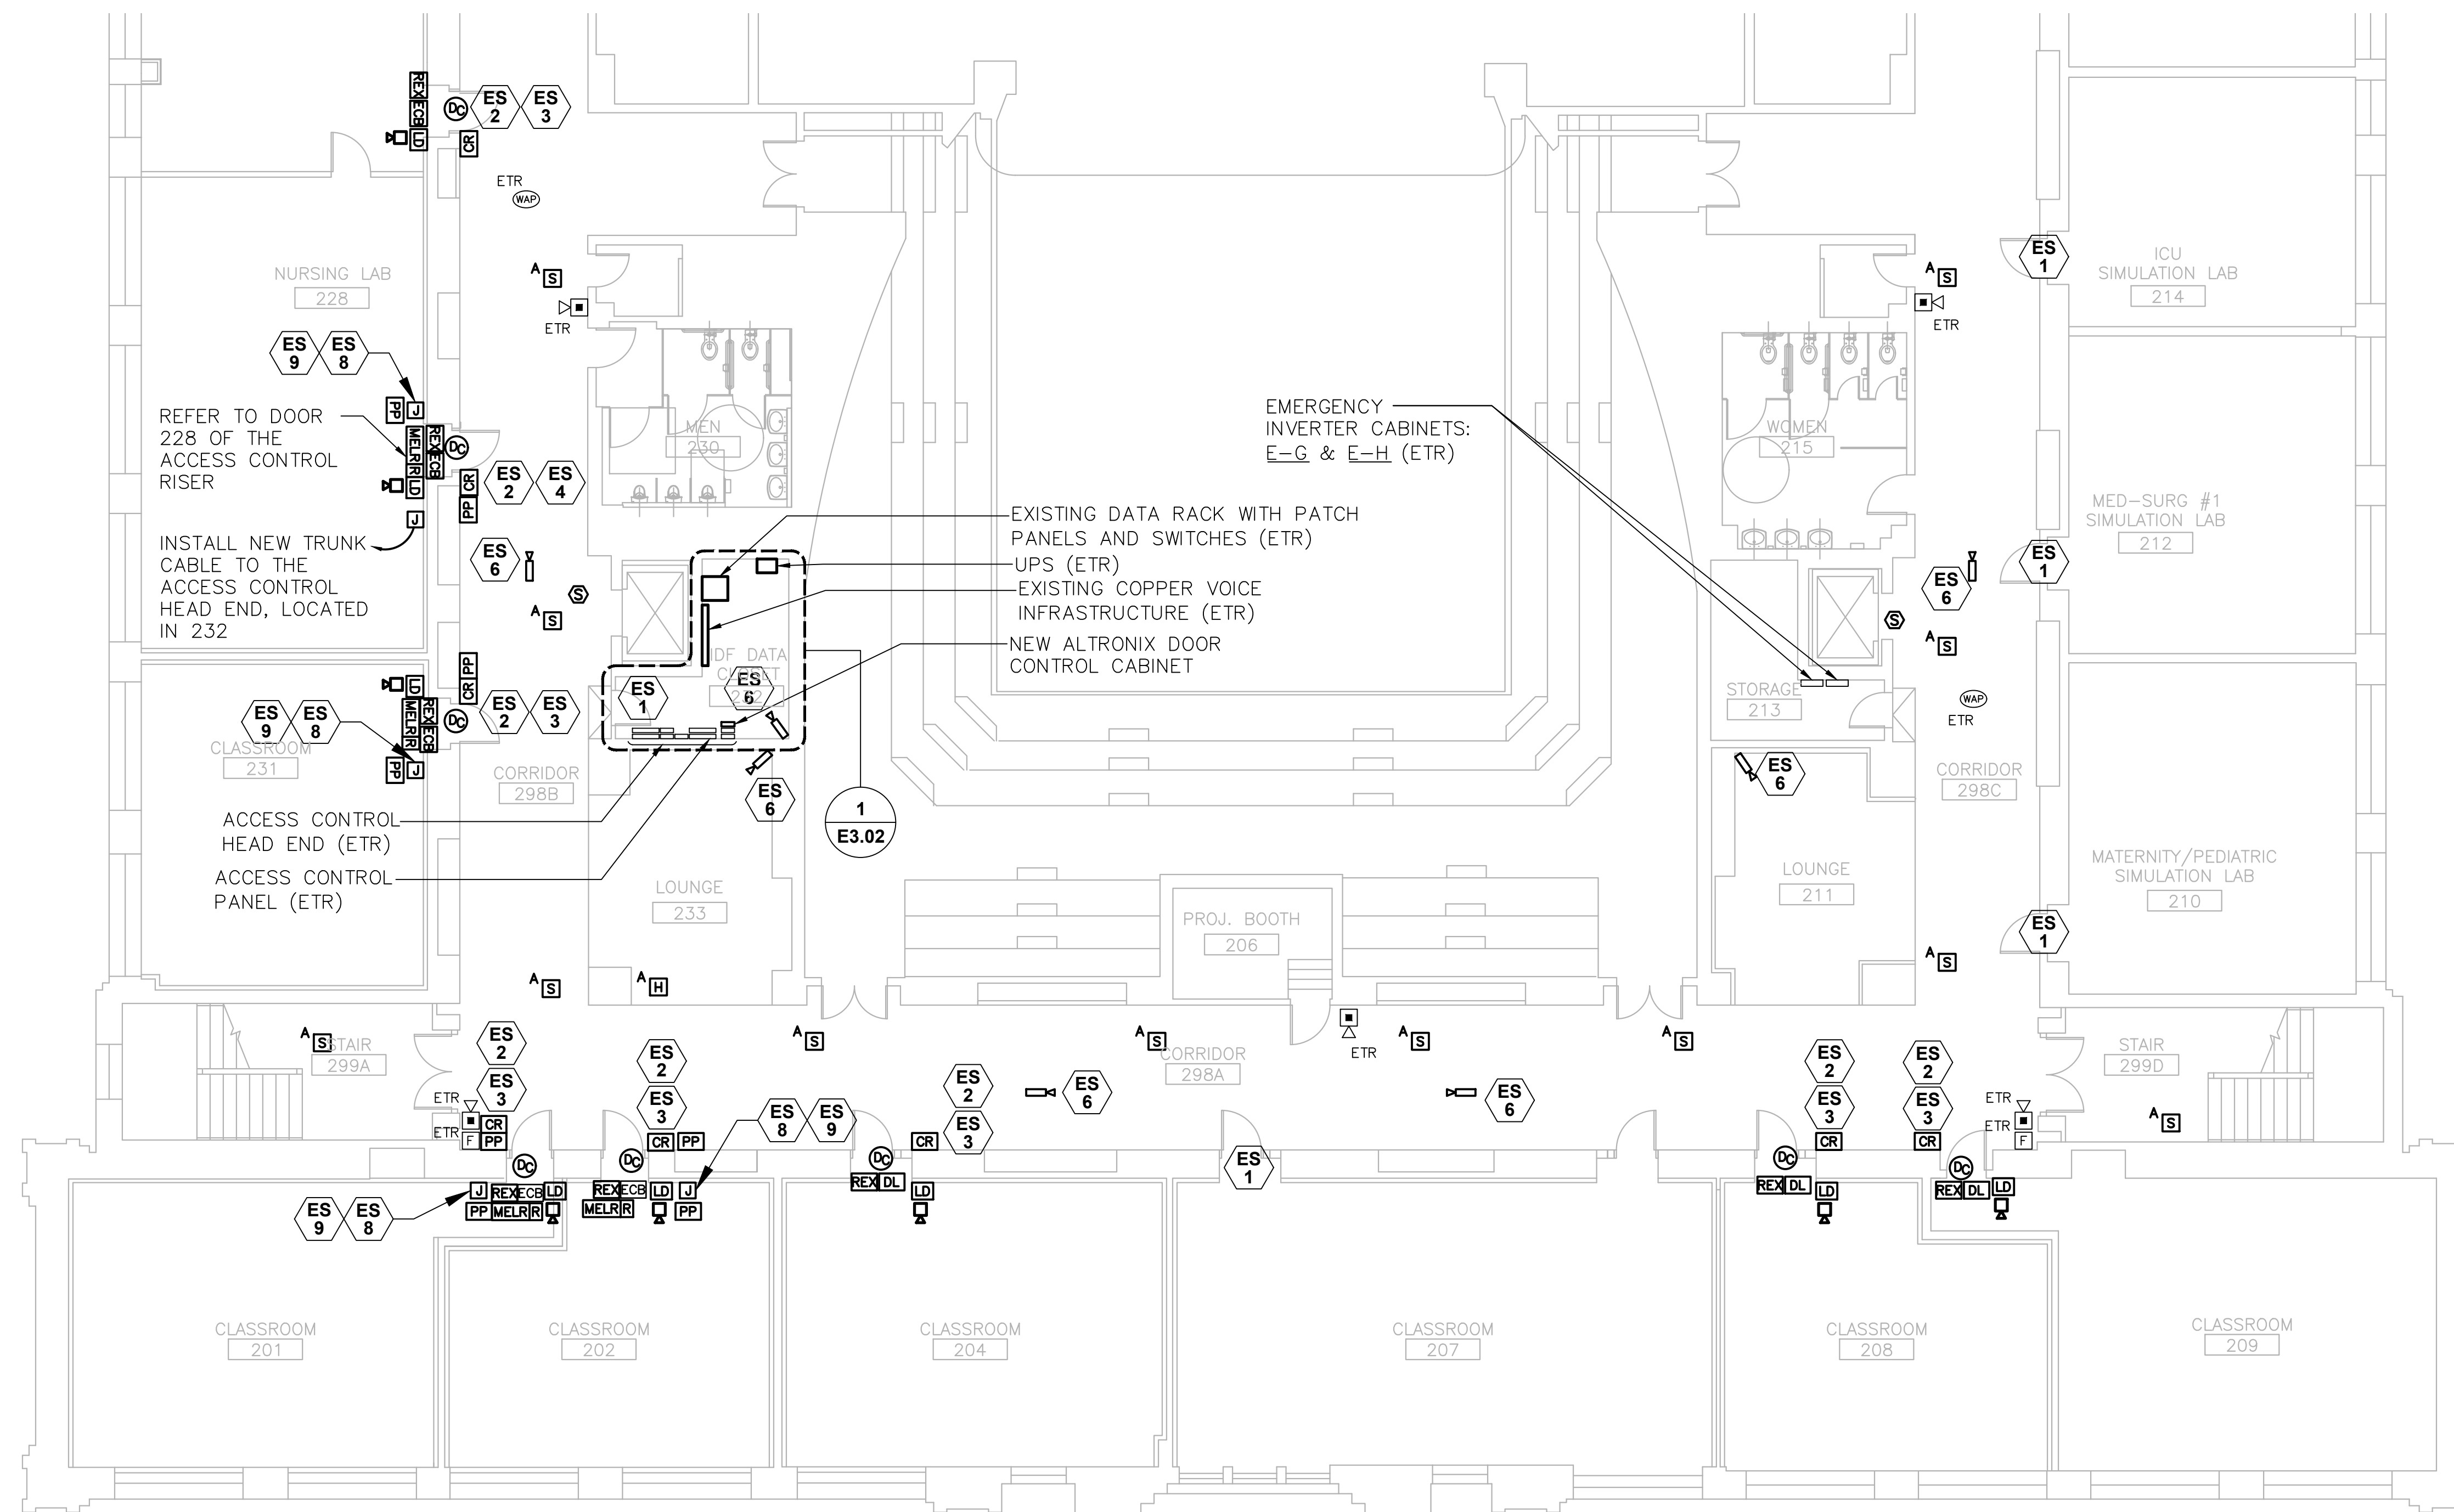

ELECTRICAL SECURITY KEY NOTES


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 - ELECTRIFIED LOCKSET (DL) AT NON ADA DOORS
 - ELECTRONIC CRASH BAR (ECB) AT ADA DOORS
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 - LOCAL LOCKDOWN
 FOR A DOOR WITH ADA OPERATOR REER TO DETAIL 3/E3.01. FOR A DOOR WITHOUT AN ADA OPERATOR REFER TO DETAIL 2/E3.01.
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- ES 4 INSTALL A NEW SECURITY TRUNK CABLE TO A 4x4 BOX AT THIS DOOR LOCATION LOCATED ABOVE THE CEILING.
- ES 5 EXISTING SECURITY CABLES TO REMAIN IN PLACE AND BE PREPARED FOR FUTURE USE BY OWNER.
- ES 6 SECURITY CAMERA LOCATION, IP BASED WITH HOMERUN TO THIRD FLOOR IDF CLOSET 310 FOR 2nd AND 3rd FLOOR DEVICES.
- ES 7 PROVIDE RACEWAY TO NEAREST CORRIDOR AND STUB UP TO ACCESSIBLE CEILING SPACE.
- ES 8 PROVIDE JUNCTION BOX WITH 120V CONNECTION TO DOOR OPERATOR/PUSH PLATE SYSTEM FROM NEAREST CONVENIENCE RECEPTACLE CIRCUIT WITHIN CORRESPONDING SPACE.
- ES 9 PROVIDE RIB RELAYS #RIB-2UC TO INTERFACE WITH THE LOCKDOWN SYSTEM AT EACH DOOR PROVIDED WITH AN ADA OPERATOR. REFER TO DETAIL 3/E3.01

ELECTRICAL SECURITY GENERAL NOTES

1. SIMPLEX SHALL PROVIDE SHOP DRAWINGS OF PROPOSED FIRE ALARM EQUIPMENT TO ENSURE COMPATIBILITY WITH THE EXISTING SYSTEM.

1 ELECTRICAL SECURITY SECOND FLOOR PLAN-SOUTH
SCALE: 1/8" = 1'-0"

| | | | | | | |
|--|--|-------------------------------|--|-------------|---------------|-------------|
| drawing title SECOND FLOOR - SOUTH SECURITY PARTIAL PLAN | | | STATE OF CONNECTICUT DEPARTMENT OF ADMINISTRATIVE SERVICES | | | |
| REVISIONS | | | | | | |
| mark | date | description | drawing prepared by | date | | |
| | 8/4/17 | SCHEMATIC DESIGN SUBMISSION | CONSULTING ENGINEERING SERVICES, INC. 811 MIDDLE STREET MIDDLETOWN, CT | 07/25/18 | | |
| | 1/15/18 | DESIGN DEVELOPMENT SUBMISSION | | scale | AS NOTED | |
| | 4/16/18 5/23/18 7/25/18 1/21/19 | CONSTRUCTION DOCUMENTS | | project | drawn by | approved by |
| | | | WESTERN CT STATE UNIVERSITY WHITE HALL 2ND AND 3RD FLOOR RENOVATIONS DANBURY, CONNECTICUT | MAL | SJM | |
| | | | CAD no. | project no. | drawing no. | |
| | | | | BI-RD-299 | ES1.02 | |

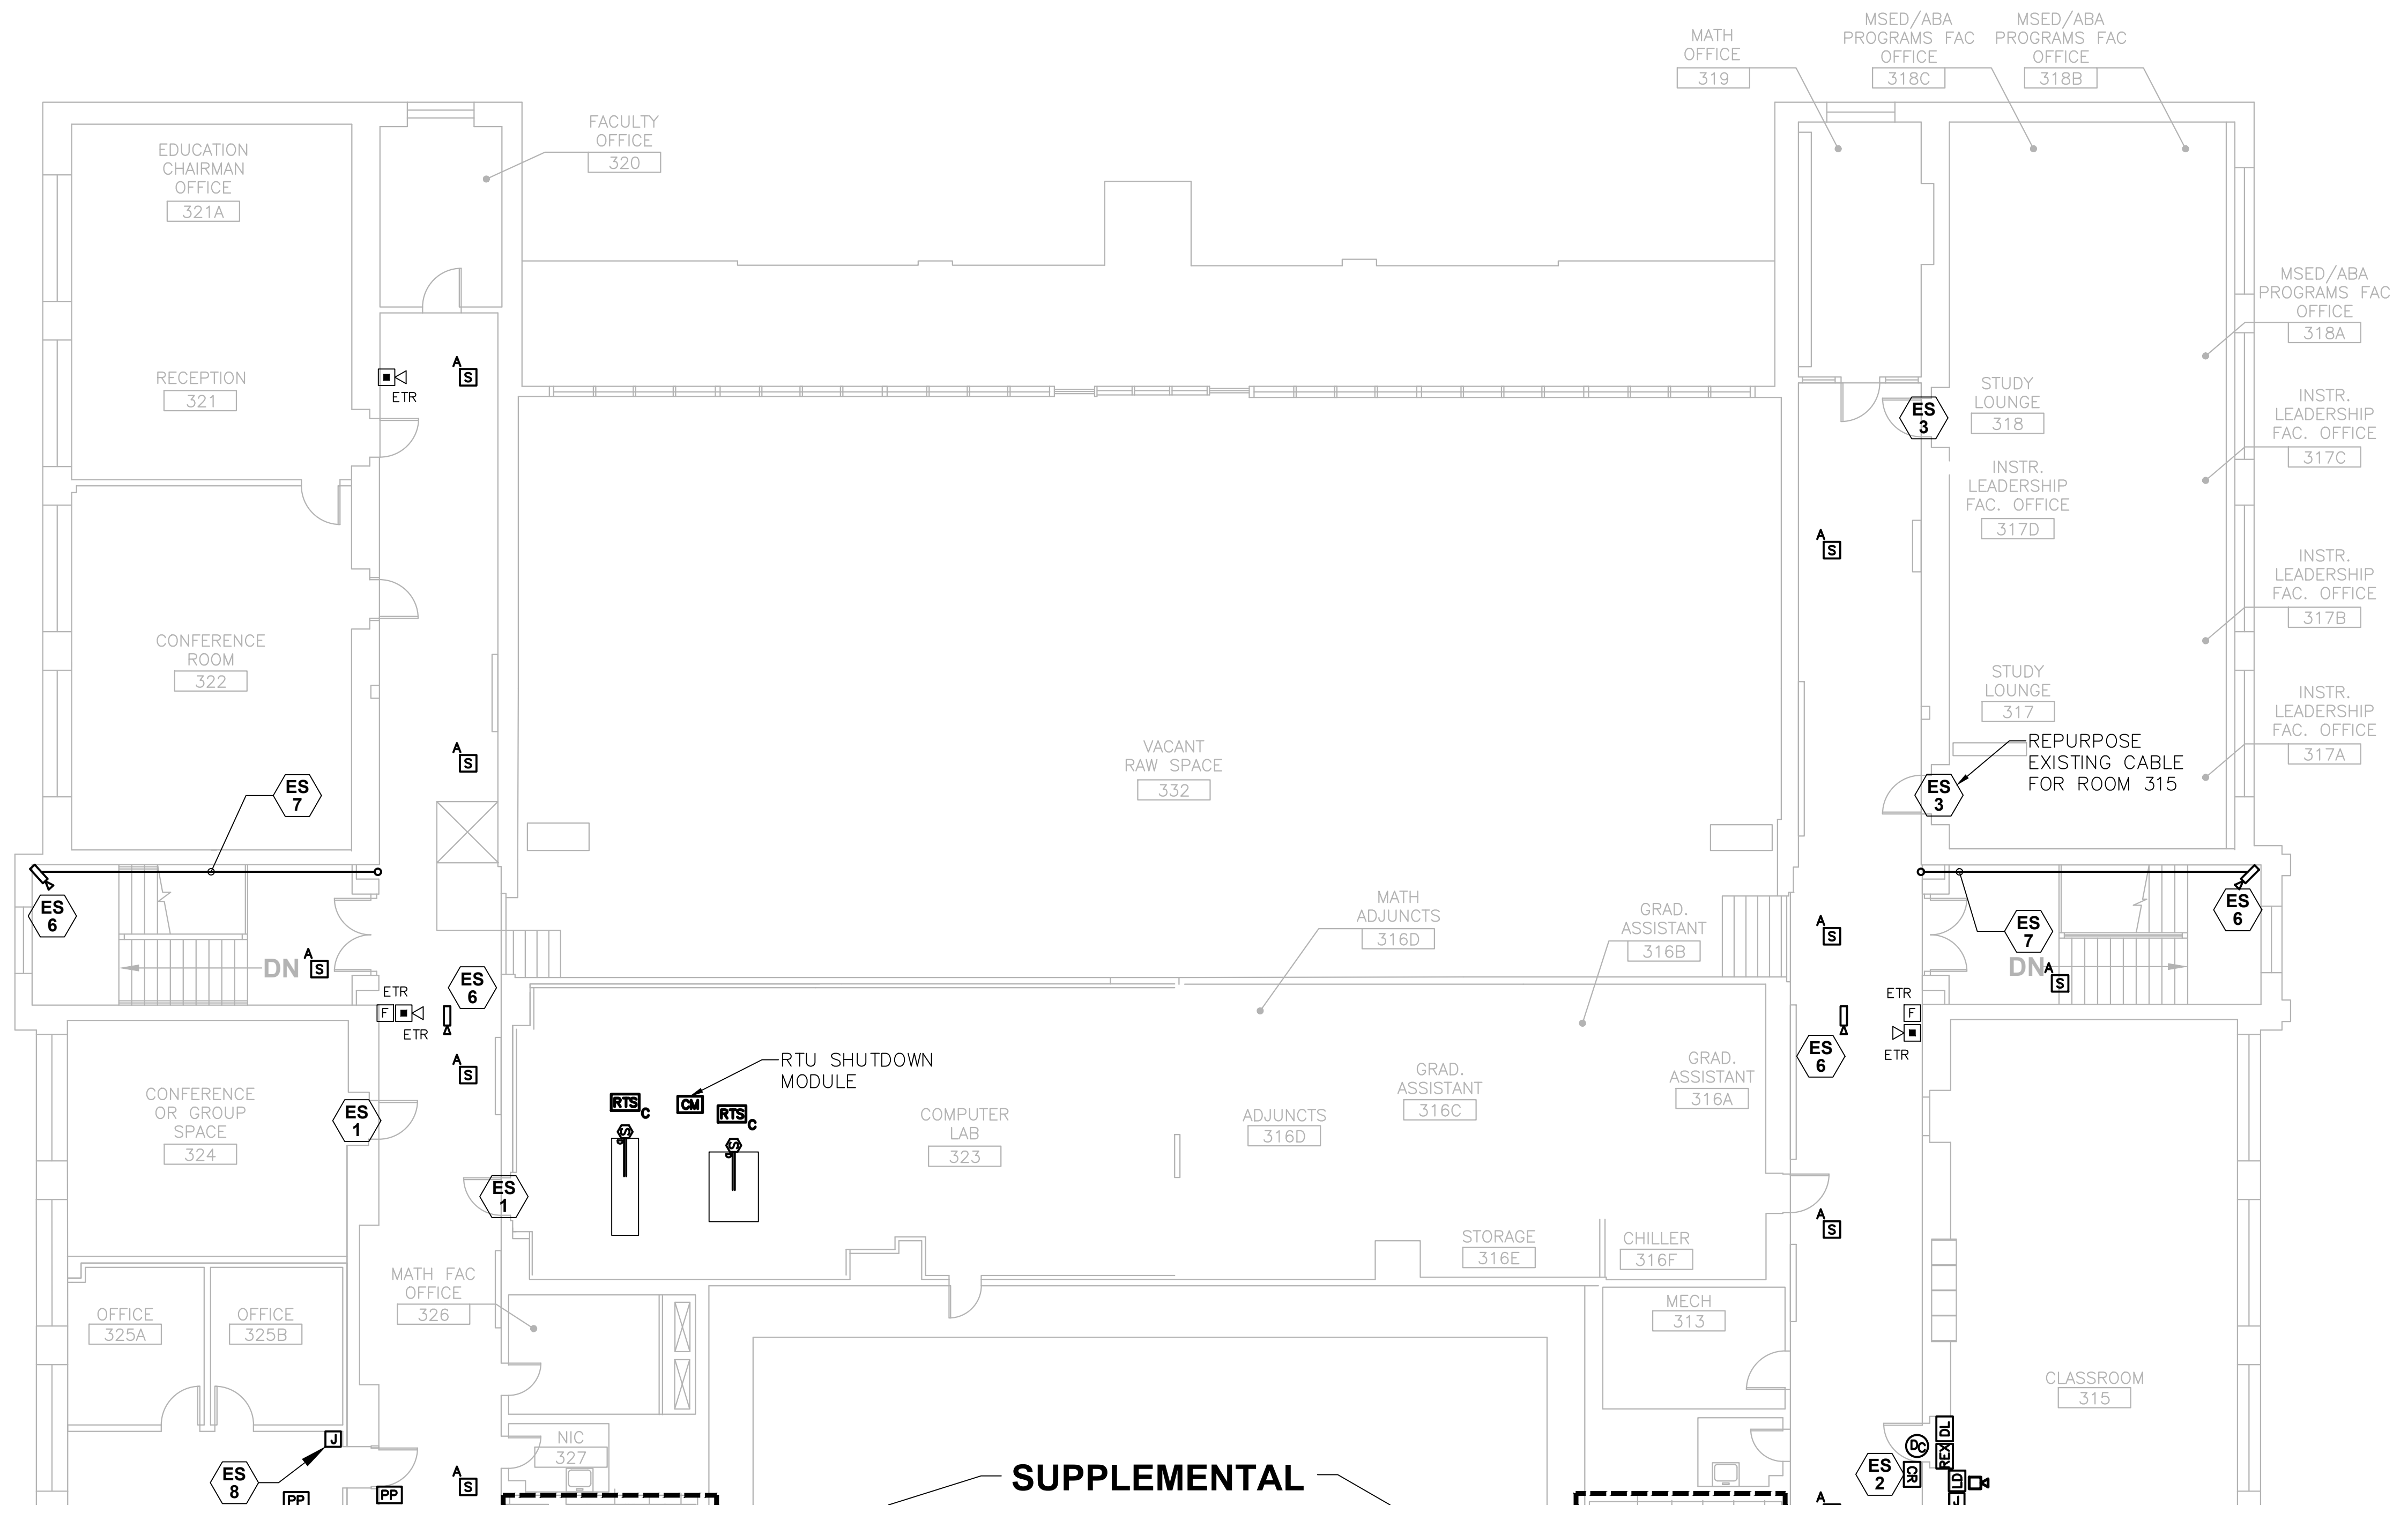

ELECTRICAL SECURITY KEY NOTES


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ELECTRICAL SECURITY GENERAL NOTES

1. SIMPLEX SHALL PROVIDE SHOP DRAWINGS OF PROPOSED FIRE ALARM EQUIPMENT TO ENSURE COMPATIBILITY WITH THE EXISTING SYSTEM.

1 ELECTRICAL SECURITY THIRD FLOOR PLAN-NORTH
SCALE: 1/8"=1'-0"

| | | | |
|---|--|--|--|
| drawing title THIRD FLOOR - NORTH SECURITY PARTIAL PLAN | | STATE OF CONNECTICUT DEPARTMENT OF ADMINISTRATIVE SERVICES | |
| REVISIONS | | | |
| mark | date | description | drawing prepared by |
| | 8/4/17 | SCHEMATIC DESIGN SUBMISSION | CONSULTING ENGINEERING SERVICES, INC. 811 MIDDLE STREET MIDDLETOWN, CT |
| | 1/15/18 | DESIGN DEVELOPMENT SUBMISSION | |
| | 4/16/18 5/23/18 7/25/18 12/1/19 | CONSTRUCTION DOCUMENTS | |
| | | project | date |
| | | WESTERN CT STATE UNIVERSITY WHITE HALL 2ND AND 3RD FLOOR RENOVATIONS DANBURY, CONNECTICUT | 07/25/18 |
| | | CAD no. | scale |
| | | BI-RD-299 | AS NOTED |
| | | project no. | drawn by |
| | | | MAL |
| | | | approved by |
| | | | SJM |
| | | | drawing no. |
| | | | ES1.03 |

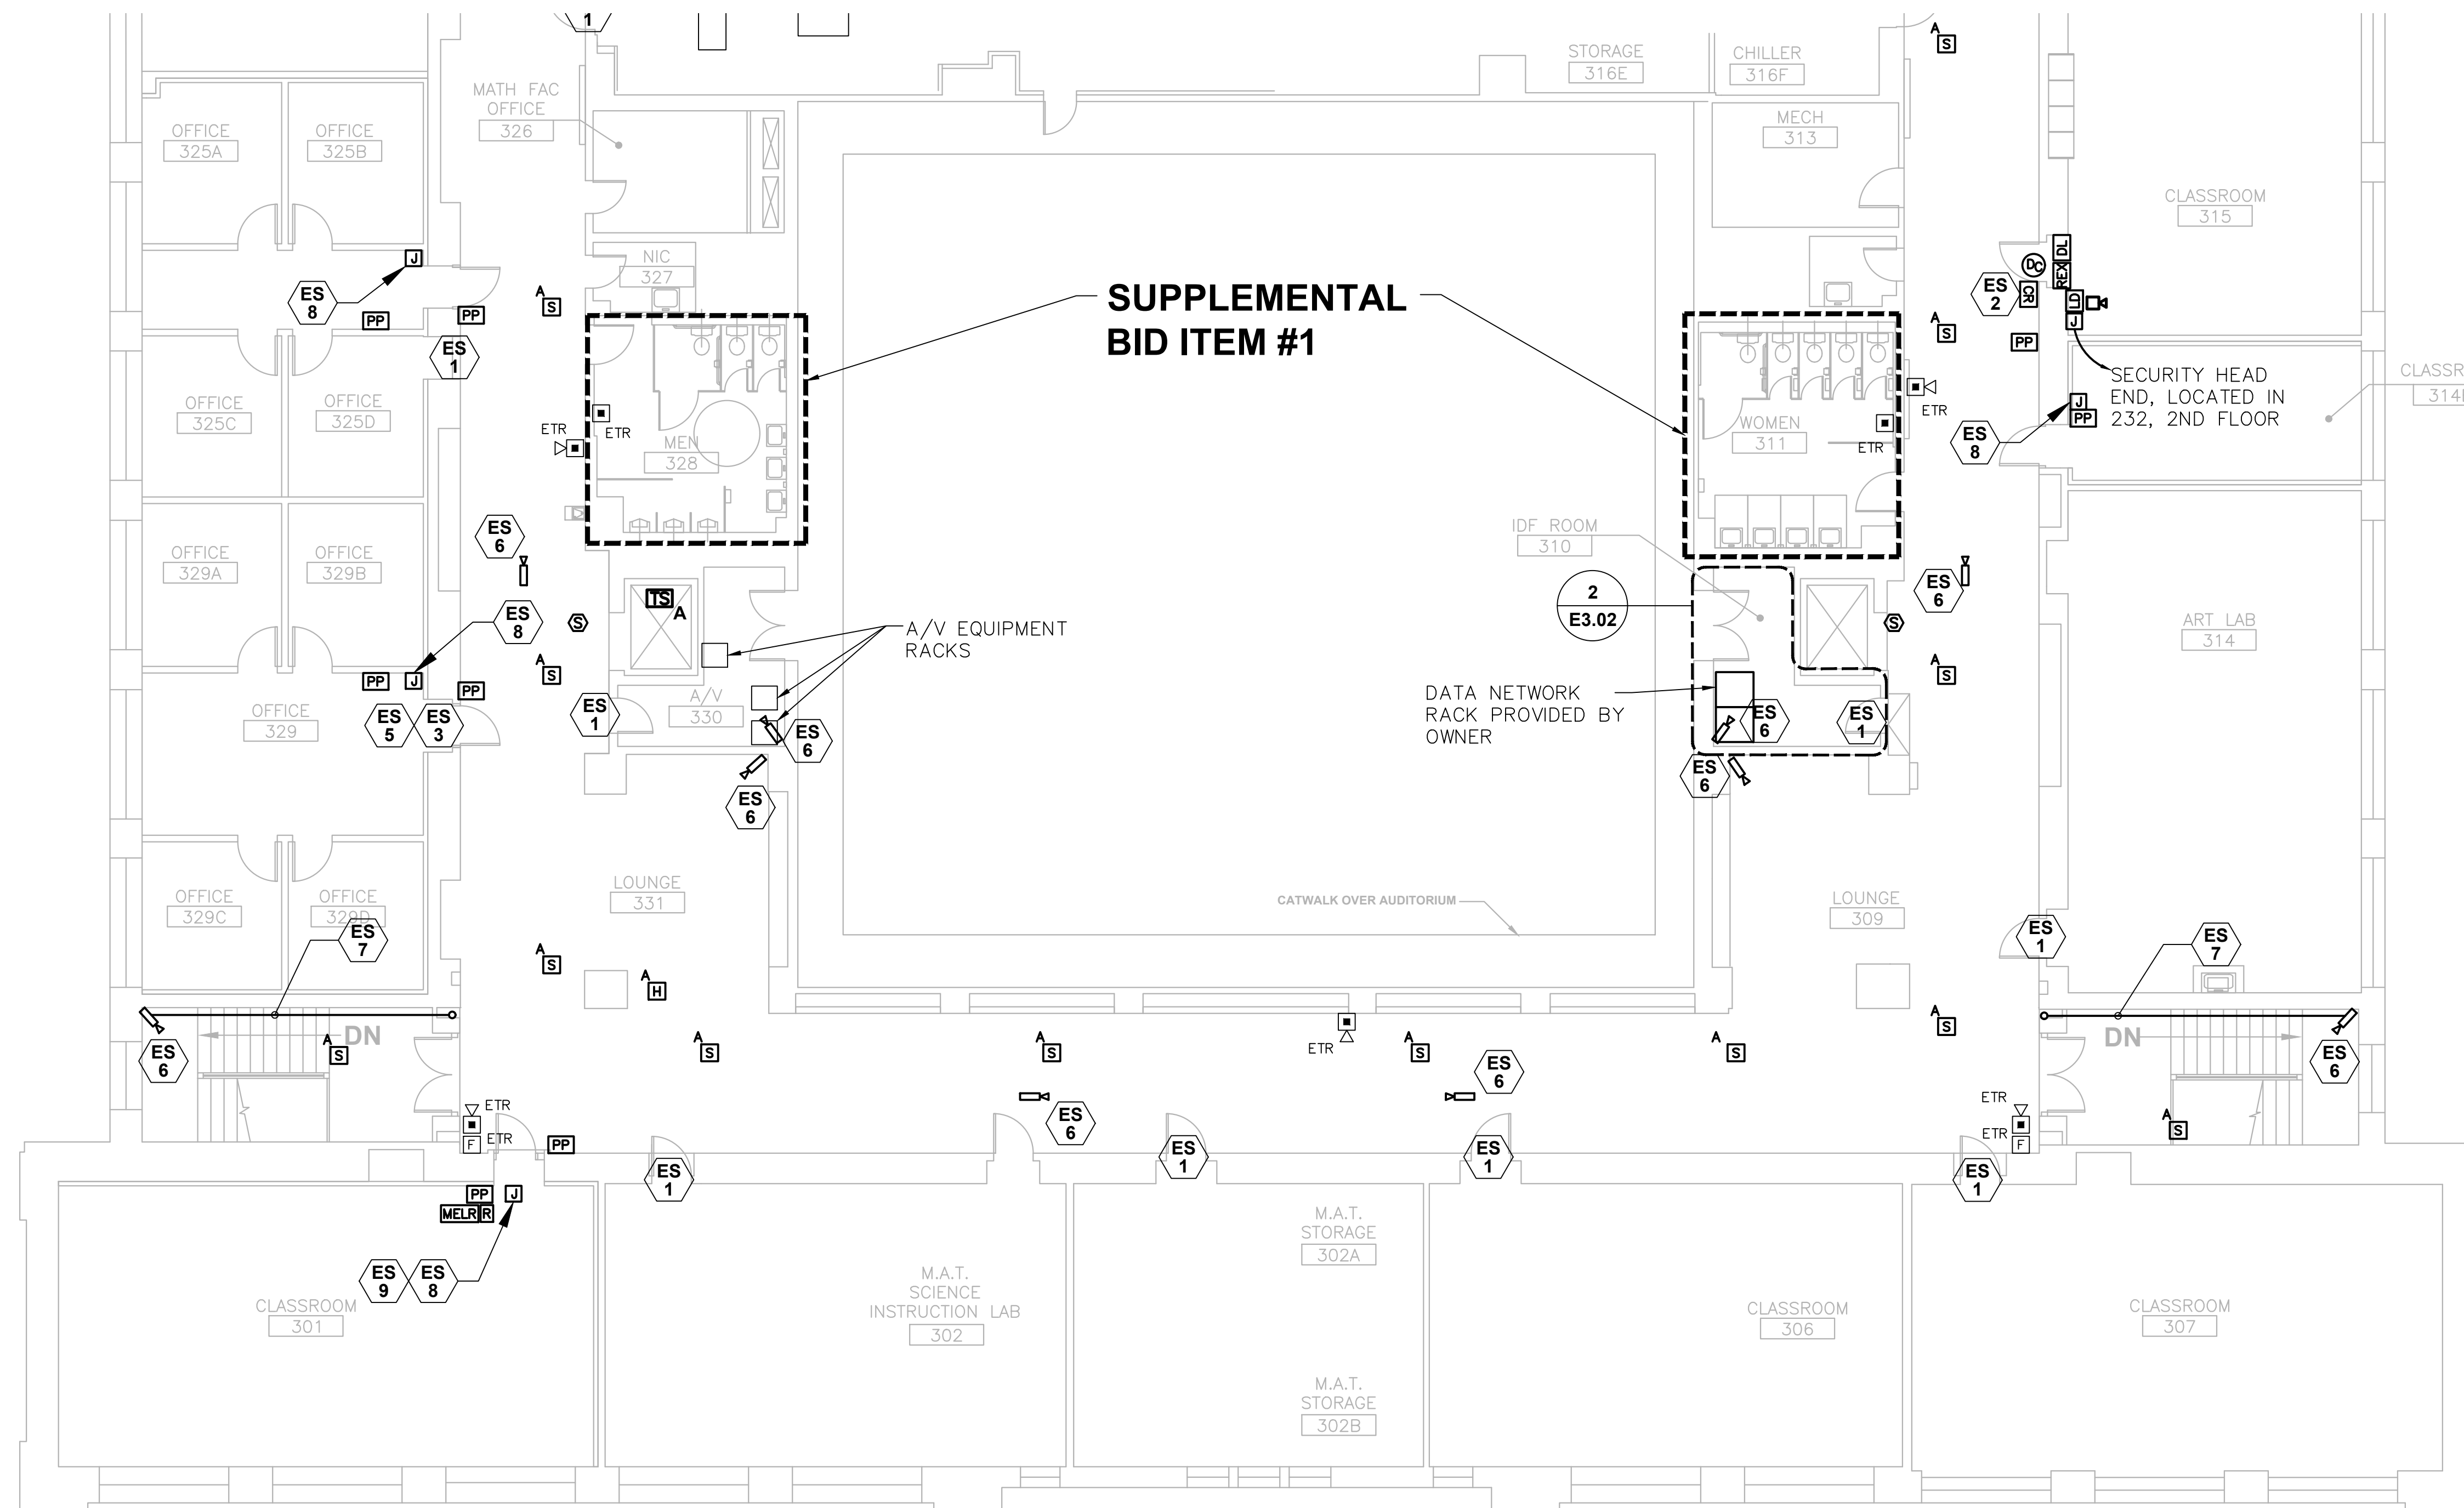

1 ELECTRICAL SECURITY THIRD FLOOR PLAN-SOUTH
SCALE: 1/8" = 1'-0"

ELECTRICAL SECURITY KEY NOTES

- ES 1 EXISTING ACCESS CONTROLLED DOOR TO REMAIN. NO WORK UNDER THIS CONTRACT.
- ES 2 NEW ACCESS CONTROLLED DOOR WITH THE FOLLOWING:
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 - ELECTRONIC CRASH BAR (ECB) AT ADA DOORS
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ELECTRICAL SECURITY GENERAL NOTES

1. SIMPLEX SHALL PROVIDE SHOP DRAWINGS OF PROPOSED FIRE ALARM EQUIPMENT TO ENSURE COMPATIBILITY WITH THE EXISTING SYSTEM.

| | | | | | |
|---|---------|-------------------------------|--|----------|----------|
| drawing title | | | STATE OF CONNECTICUT | | |
| THIRD FLOOR - SOUTH SECURITY PARTIAL PLAN | | | DEPARTMENT OF ADMINISTRATIVE SERVICES | | |
| REVISIONS | | | | | |
| mark | date | description | drawing prepared by | date | scale |
| | 8/4/17 | SCHEMATIC DESIGN SUBMISSION | CONSULTING ENGINEERING SERVICES, INC. 811 MIDDLE STREET MIDDLETOWN, CT | 07/25/18 | AS NOTED |
| | 1/15/18 | DESIGN DEVELOPMENT SUBMISSION | | project | drawn by |
| | 4/16/18 | CONSTRUCTION DOCUMENTS | WESTERN CT STATE UNIVERSITY WHITE HALL 2ND AND 3RD FLOOR RENOVATIONS DANBURY, CONNECTICUT | MAL | SJM |
| | 5/23/18 | | | | |
| | 7/25/18 | | | | |
| | 12/1/19 | | | | |
| CAD no. | | | project no. | ES1.04 | |
| | | | BI-RD-299 | | |

| ELECTRICAL SYMBOL LIST | | | |
|------------------------|---|----------|--|
| SYMBOL | DESCRIPTION | SYMBOL | DESCRIPTION |
| [Symbol] | SURFACE MOUNTED PANELBOARD | [Symbol] | PENDANT LIGHTING FIXTURE |
| [Symbol] | RECESSED PANELBOARD | [Symbol] | RECESSED LIGHTING FIXTURE |
| [Symbol] | DISCONNECT SWITCH | [Symbol] | WALL MOUNTED SCONCE LIGHTING FIXTURE |
| [Symbol] | FUSED DISCONNECT SWITCH | [Symbol] | INDUSTRIAL LED FIXTURE |
| [Symbol] | ELECTRICAL MOTOR | [Symbol] | SURFACE MOUNTED DOWNLIGHT FIXTURE |
| [Symbol] | PADDLE FAN | [Symbol] | RECESSED DOWNLIGHT FIXTURE |
| [Symbol] | BRANCH CIRCUIT WIRING, CONCEALED IN WALLS OR CEILINGS | [Symbol] | RECESSED DOWNLIGHT FIXTURE ON EMERGENCY POWER |
| [Symbol] | HOMERUN TO PANELBOARD, UNLESS INDICATED OTHERWISE SHALL BE CONNECTED TO A 1 POLE, 20 AMP CIRCUIT BREAKER | [Symbol] | WALL MOUNTED EXIT SIGN |
| [Symbol] | BRANCH CIRCUIT WIRING, SWITCHED | [Symbol] | CEILING MOUNTED EXIT SIGN |
| [Symbol] | CONDUIT RUN ON SURFACE OF WALLS/CEILING | [Symbol] | PENDANT MOUNTED ELEVATOR SIGN |
| [Symbol] | BRANCH CIRCUIT WIRING BELOW GRADE/SLAB | [Symbol] | WALL MOUNTED COMBINATION SPEAKER/STROBE LIGHT WITH ADJUSTABLE CANDELA & SPEAKER DB SETTINGS MOUNT AT 6'-8" AFF |
| [Symbol] | SECURITY/ACCESS CONTROL CABLE WITH BREAKOUT BOX | [Symbol] | WALL MOUNTED ADA 15/75 CANDELA STROBE UNIT ONLY |
| [Symbol] | SINGLE GANG BOX WITH BUSHED HOLE AND XLR MICROPHONE CABLE | [Symbol] | WALL MOUNTED FIRE ALARM MANUAL PULL STATION, MOUNT AT 48" AFF |
| [Symbol] | JUNCTION BOX | [Symbol] | CEILING MOUNTED SMOKE DETECTOR |
| [Symbol] | DUPLEX WALL MOUNTED RECEPTACLE, * SEE NOTE BELOW | [Symbol] | CEILING MOUNTED SMOKE DETECTOR, NEWER TYPE |
| [Symbol] | DOUBLE DUPLEX WALL MOUNTED RECEPTACLE, * SEE NOTE BELOW | [Symbol] | CEILING MOUNTED SMOKE DETECTOR, ADDRESSABLE TYPE |
| [Symbol] | DUPLEX RECEPTACLE WITH GROUND FAULT CIRCUIT INTERRUPTION | [Symbol] | CEILING MOUNTED SMOKE DETECTOR, ZONED TYPE |
| [Symbol] | SPECIAL PURPOSE RECEPTACLE, NEMA CONFIGURATION AS INDICATED | [Symbol] | DUCT SMOKE DETECTOR |
| [Symbol] | TELEPHONE OUTLET, 4-11/16" BACKBOX WITH 1" CONDUIT STUBBED INTO AN ACCESSIBLE CEILING, PROVIDE NYLON PULL STRING AND BUSHING, * SEE NOTE BELOW | [Symbol] | PROJECTOR |
| [Symbol] | COMPUTER, PRINTER/FAX OUTLET, 4-11/16" BACKBOX WITH 1" CONDUIT STUBBED INTO ACCESSIBLE CEILING, PROVIDE NYLON PULL STRING AND BUSHING, PROVIDE (2) CAT6 DATA CABLES, JACKS AND FACEPLATE, * SEE NOTE BELOW | [Symbol] | EXTRON PROJECTOR INTERCONNECT |
| [Symbol] | WORKSTATION AREA OUTLET (WAO), 4-11/16" BACKBOX WITH 1" CONDUIT STUBBED INTO ACCESSIBLE CEILING, PROVIDE NYLON PULL STRING AND BUSHING, PROVIDE (2) CAT6 DATA CABLES, JACKS AND FACEPLATE, * SEE NOTE BELOW | [Symbol] | MOTORIZED PROJECTOR SCREEN CONTROL |
| [Symbol] | ELECTRIFIED DOOR LOCKSET | [Symbol] | CONTROL MODULE |
| [Symbol] | ELECTRONIC CRASH BAR | [Symbol] | CEILING MOUNTED VACANCY SENSOR |
| [Symbol] | ADA DOOR OPERATOR PUSH PLATE | [Symbol] | CEILING MOUNTED OCCUPANCY SENSOR |
| [Symbol] | RIB RELAY | [Symbol] | DUAL TECHNOLOGY CEILING MOUNTED OCCUPANCY SENSOR |
| [Symbol] | MOTORIZED ELECTRONIC LATCH RETRACTION WITH ECB | [Symbol] | CORNER MOUNTED VACANCY SENSOR |
| [Symbol] | SURVEILLANCE CAMERA - IP BASED, PROVIDE (2) CAT6 CABLES, JACKS AND (2) PORT JACK AT THIS LOCATION. | [Symbol] | FIRE ALARM CONTROL PANEL |
| [Symbol] | CARD READER | [Symbol] | LIGHTING CONTACTOR PANEL |
| [Symbol] | REQUEST TO EXIT | [Symbol] | EMERGENCY CALL TOGGLE SWITCH |
| [Symbol] | CEILING MOUNTED MOTION DETECTOR - 360° DETECTION PATTERN | [Symbol] | EMERGENCY CALL FOR AID COMBINATION BUZZER/LIGHT |
| [Symbol] | LOCAL LOCKDOWN | [Symbol] | SINGLE POLE TOGGLE SWITCH |
| [Symbol] | DOOR MANAGEMENT ALARM | [Symbol] | THREE WAY TOGGLE SWITCH |
| [Symbol] | 1' X 4' SURFACE WRAP LIGHT FIXTURE | [Symbol] | DIMMER SWITCH |
| [Symbol] | WALL MOUNTED LINEAR SCONCE LIGHT FIXTURE | [Symbol] | KEY SWITCH |
| [Symbol] | 2' X 2' SURFACE MOUNT LIGHT FIXTURE | [Symbol] | THREE WAY DIMMER SWITCH |
| [Symbol] | WALL MOUNTED EMERGENCY PENDANT FIXTURE | [Symbol] | WALL MOUNTED OCCUPANCY SENSOR SWITCH |

NOTE:
RECEPTACLE/DATA OUTLET SUBSCRIPT * DENOTES:
blank = WALL MOUNTED 18" AFF UNLESS NOTED OTHERWISE
a = MOUNT ABOVE COUNTER
b = LOCATE PER ARCHITECTURAL ELEVATIONS
c = CEILING MOUNTED
H = HORIZONTALLY MOUNTED 80" AFF UNLESS NOTED OTHERWISE

| LIGHTING FIXTURE SCHEDULE | | | | | |
|---------------------------|---|-------|-----------------------------------|--------------------------|---|
| TYPE | MANUFACTURER | VOLT. | LAMPS | MOUNTING | FIXTURE DESCRIPTION |
| A | METALUX 22EN-LD1-34-UNV-L835-CD1-U 2x2 LED RECESSED TROFFER | MVOLT | LED-35W 3400 LUMENS | RECESSED CEILING | 2x2 RECESSED TROFFER, 3400 LUMENS, 3500K, 1 DRIVER, 0-10V DIMMER |
| A1 | METALUX 22EN-LD1-40-UNV-L835-CD1-U 2x2 LED RECESSED TROFFER | MVOLT | LED-35W 4000 LUMENS | RECESSED CEILING | 2x2 RECESSED TROFFER, 4000 LUMENS, 3500K, 1 DRIVER, 0-10V DIMMER |
| B | DAY-BRITE LF4FR3935UDZT | 120V | LED-33W 3700 LUMENS | CEILING | 4" INDUSTRIAL LED FIXTURE WITH ALUMINUM HOUSING, PRISMATIC REFRACTOR, AND AIRCRAFT CABLE MOUNTING, FIXTURE SHALL BE MOUNTED AT 8'-0" AFF UNLESS OTHERWISE NOTED. |
| C | LITHONIA #FMVICAL-8IN-MVOLT-30K- 90CRI-BN-M4 | 120V | LED-34W 3000 LUMENS | SURFACE WALL MOUNT | 48" WALL SCONCE OVER TOILET ROOM SINKS, VANITY LIGHT BAR LINEAR LED WBRUSHED NICKEL FINISH |
| E1 | DUAL-LITE #EV4R | 120V | 15W | RECESSED CEILING | EMERGENCY LIGHTING FIXTURE, RECESS MOUNTED IN CEILING |
| EX | DUAL-LITE HCX-U-R-W-03L | 120V | 3W MR16 LED INCL. W/FIXTURE | UNIVERSAL | UNIVERSAL MOUNT SINGLE/DOUBLE FACE EXIT SIGN WITH INTEGRAL BATTERY AND SOLID STATE CHARGER, (2) MR16 LED HEADS |


- LIGHTING FIXTURE NOTES:**
- THE NAMED MANUFACTURER LISTED IN THE LUMINAIRE SCHEDULE IS THE BASIS OF DESIGN. IF THE CONTRACTOR CHOOSES TO PROVIDE AN EQUIVALENT MANUFACTURER, THE LIGHT FIXTURE SUBMITTAL SHALL INCLUDE IN ADDITION TO THE PROPOSED LIGHT FIXTURE CUT SHEETS LIGHTING CALCULATIONS FOR ALL INTERIOR AND EXTERIOR AREAS. THE EQUAL FIXTURE APPROVAL SHALL BE EVALUATED BASED ON THE AESTHETICS, QUALITY, CONSTRUCTION AND OPTICAL PERFORMANCE BY THE ENGINEER AND OR ARCHITECT. FIXTURE SAMPLES SHALL BE PROVIDED AS REQUESTED BY THE ENGINEER AND OR ARCHITECT.
 - REFER TO THE ELECTRICAL SPECIFICATIONS FOR ADDITIONAL GENERAL REQUIREMENTS.
 - FIXTURES SHALL BE UL OR ETL LISTED, DLC QUALIFIED.
 - LED LIGHTING FIXTURES AND COMPONENTS SHALL BE DESIGNED AND TESTED IN ACCORDANCE WITH IES LM-79 AND LM-80, UL 1593 AND 8750. DRIVERS SHALL BE PROVIDED THAT OPERATE AT THE LISTED VOLTAGE RATING OF THE FIXTURE.
 - MOUNTING HARDWARE SUCH AS HANGERS, BRACKETS, RAILS, YOKES, STEMS, CHAINS, ETC., SHALL BE PROVIDED AS NECESSARY TO MOUNT SPECIFIED FIXTURE.
 - REFER TO ARCHITECTURAL DRAWINGS AND REFLECTED CEILING PLANS FOR SPECIFIC DETAILS, ARRANGEMENT, MOUNTING HEIGHTS, CEILING CONSTRUCTION, ETC., COLORS AND FINISHES SHALL BE SELECTED BY THE ARCHITECT.
 - FIXTURES SHALL BE SEISMICALLY SUPPORTED AS REQUIRED BY THE APPLICABLE BUILDING CODE. RECESSED TROFFER STYLE FIXTURES SHALL BE SUPPORTED FROM THE BUILDING STRUCTURE WITH A MINIMUM OF 2 SUPPORTS.
 - WIRE EMERGENCY FIXTURES AND EXIT SIGNS AHEAD OF SWITCHED LEGS.

| MOTOR CIRCUIT SCHEDULE | | | | | | | | | | | | | | | | |
|------------------------|------------------|----------------|---------------------|------------|---------------------|--------------------|---|------|--------------|------|---------|---------|----------|---------|-------|---------------|
| EQUIPMENT | PANEL | CIRCUIT NUMBER | CIRCUIT BREAKER OCP | # OF POLES | BRANCH CIRCUIT | LOCAL DISC. SWITCH | MOTOR STARTER BY DIV. 26 (UNLESS NOTED OTHERWISE) | | | LOAD | | | | REMARKS | | |
| | | | | | | | SIZE | TYPE | LOCATION | HP | MCA | FLA | FUSE MOP | | PHASE | VOLT |
| DOA-1 | MAIN SWITCHBOARD | - | 225 A | 3 | 3#250KCMIL #4G, 3"C | DIV. 23 | | | ROOF | - | 193.0 A | 181.0 A | 225 A | 3 | 208 | SEE NOTE 1, 2 |
| CU-1 [MODULE 1] | PANEL 310A | 9,11,13 | 40 A | 3 | 3#6 #10G, 1"C | | | | ROOF | - | 34.0 A | 27.2 A | 40 A | 3 | 208 | SEE NOTE 2 |
| CU-1 [MODULE 2] | PANEL 310A | 15,17,19 | 40 A | 3 | 3#6 #10G, 1"C | | | | ROOF | - | 34.0 A | 27.2 A | 40 A | 3 | 208 | SEE NOTE 2 |
| CU-2 [MODULE 1] | PANEL 330B | 1,3,5 | 60 A | 3 | 3#4 #8G, 1 1/4"C | | | | ROOF | - | 53.0 A | 42.4 A | 60 A | 3 | 208 | SEE NOTE 2 |
| CU-2 [MODULE 2] | PANEL 330B | 7,9,11 | 60 A | 3 | 3#4 #8G, 1 1/4"C | | | | ROOF | - | 53.0 A | 42.4 A | 60 A | 3 | 208 | SEE NOTE 2 |
| CU-3 [MODULE 1] | PANEL 330B | 13,15,17 | 40 A | 3 | 3#6 #10G, 1"C | | | | ROOF | - | 34.0 A | 27.2 A | 40 A | 3 | 208 | SEE NOTE 2 |
| CU-3 [MODULE 2] | PANEL 330B | 19,21,23 | 30 A | 3 | 3#8 #10G, 3/4"C | | | | ROOF | - | 23.0 A | 18.4 A | 30 A | 3 | 208 | SEE NOTE 2 |
| CU-4 [MODULE 1] | PANEL 310A | 14,16,18 | 60 A | 3 | 3#4 #8G, 1 1/4"C | | | | ROOF | - | 53.0 A | 42.4 A | 60 A | 3 | 208 | SEE NOTE 2 |
| CU-4 [MODULE 2] | PANEL 310A | 20,22,24 | 60 A | 3 | 3#4 #8G, 1 1/4"C | | | | ROOF | - | 53.0 A | 42.4 A | 60 A | 3 | 208 | SEE NOTE 2 |
| VRV-A, B, D | PANEL 213 | 2,4 | 15 A | 2 | 2#12 #12G, 3/4"C | | | | SECOND FLOOR | - | 9.5 A | 7.58 A | 15 A | 1 | 208 | SEE NOTE 2 |
| VRV-Gx2 | PANEL 213 | 6,8 | 15 A | 2 | 2#12 #12G, 3/4"C | | | | SECOND FLOOR | - | 0.5 A | 0.4 A | 15 A | 1 | 208 | SEE NOTE 2 |
| VRV-Gx2, Hx2 | PANEL 220 | 2,4 | 15 A | 2 | 2#12 #12G, 3/4"C | | | | SECOND FLOOR | - | 6.3 A | 5.04 A | 15 A | 1 | 208 | SEE NOTE 2 |
| VRV-Bx2, G | PANEL 232 | 2,4 | 15 A | 2 | 2#12 #12G, 3/4"C | | | | SECOND FLOOR | - | 5.7 A | 4.6 A | 15 A | 1 | 208 | SEE NOTE 2 |
| VRV-A, E, F | PANEL 232 | 6,8 | 15 A | 2 | 2#12 #12G, 3/4"C | | | | SECOND FLOOR | - | 7.2 A | 5.8 A | 15 A | 1 | 208 | SEE NOTE 2 |
| VRV-A, B, C, G | PANEL 232 | 10,12 | 15 A | 2 | 2#12 #12G, 3/4"C | | | | SECOND FLOOR | - | 9.0 A | 7.2 A | 15 A | 1 | 208 | SEE NOTE 2 |
| VRV-Gx10 | PANEL 310B | 2,4 | 15 A | 2 | 2#12 #12G, 3/4"C | | | | THIRD FLOOR | - | 2.5 A | 2.0 A | 15 A | 1 | 208 | SEE NOTE 2 |
| VRV-Gx3, Hx2 | PANEL 310B | 6,8 | 15 A | 2 | 2#12 #12G, 3/4"C | | | | THIRD FLOOR | - | 1.5 A | 1.2 A | 15 A | 1 | 208 | SEE NOTE 2 |
| VRV-Dx2, G, H | PANEL 310B | 10,12 | 15 A | 2 | 2#12 #12G, 3/4"C | | | | THIRD FLOOR | - | 7.5 A | 6.0 A | 15 A | 1 | 208 | SEE NOTE 2 |
| VRV-A, C, D | PANEL 310B | 14,16 | 15 A | 2 | 2#12 #12G, 3/4"C | | | | THIRD FLOOR | - | 9.5 A | 7.6 A | 15 A | 1 | 208 | SEE NOTE 2 |
| VRV-A, G, Hx2 | PANEL 330B | 2,4 | 15 A | 2 | 2#12 #12G, 3/4"C | | | | THIRD FLOOR | - | 4.4 A | 3.5 A | 15 A | 1 | 208 | SEE NOTE 2 |
| VRV-E, Gx8, H | PANEL 330B | 6,8 | 15 A | 2 | 2#12 #12G, 3/4"C | | | | THIRD FLOOR | - | 2.9 A | 2.3 A | 15 A | 1 | 208 | SEE NOTE 2 |
| VRV-A, D, G | PANEL 330B | 10,12 | 15 A | 2 | 2#12 #12G, 3/4"C | | | | THIRD FLOOR | - | 7.0 A | 5.6 A | 15 A | 1 | 208 | SEE NOTE 2 |

- MOTOR CIRCUIT SCHEDULE NOTES:**
- EC TO CONNECT FEEDER TO THE FACTORY PROVIDED DISCONNECT SWITCH.
 - EC TO PROVIDE ADDITIONAL FIELD MOUNTED EXTERNAL FUSIBLE DISCONNECT SWITCH.

| ELECTRICAL ABBREVIATIONS | | | |
|--------------------------|---------------------------|-------|-----------------------------------|
| A/AMP | AMPERE | KCMIL | THOUSAND CIRCULAR MILS |
| AC | ALTERNATING CURRENT | KVA | KILOVOLT AMPERE |
| ACU | AIR CONDITIONING UNIT | KW | KILOWATT |
| AFF | ABOVE FINISHED FLOOR | MAX | MAXIMUM |
| AFG | ABOVE FINISHED GRADE | MAU | MAKE UP AIR UNIT |
| AHU | AIR HANDLING UNIT | MCC | MOTOR CONTROL CENTER |
| AIC | AMPS INTERRUPTING CURRENT | MCCB | MOLDED CASE CIRCUIT BREAKER |
| ATS | AUTOMATIC TRANSFER SWITCH | MH | METAL HALIDE |
| AWG | AMERICAN WIRE GAUGE | MIN | MINIMUM |
| BSMT | BASEMENT | MLO | MAIN LUGS ONLY |
| C | CONDUIT | NA | NOT APPLICABLE |
| CATV | CABLE TELEVISION | NEC | NATIONAL ELECTRIC CODE |
| C/B | CIRCUIT BREAKER | NIC | NOT IN CONTRACT |
| CKT | CIRCUIT | NL | NIGHT LIGHT (24 HR) |
| COMP | COMPRESSOR | NR | NEW TO REPLACE EXISTING |
| CP | CONDENSATE PUMP | NTS | NOT TO SCALE |
| CT | CURRENT TRANSFORMER | OH | OVERHEAD |
| CU | CONDENSING UNIT, COPPER | P | POLE |
| CUH | CABINET UNIT HEATER | PE | PRIMARY ELECTRICAL SERVICE |
| DIA/Ø | DIAMETER | PF | POWER FACTOR |
| DN | DOWN | PH/Ø | PHASE |
| DWG | DRAWING | PNL | PANEL |
| E/ETR | EXISTING TO REMAIN | PVC | POLYVINYL CHLORIDE CONDUIT |
| EF | EXHAUST FAN | RE | REMOVE EXISTING |
| ELEC | ELECTRICAL | RGS | RIGID GALVANIZED STEEL CONDUIT |
| ELEV | ELEVATOR | RL | RELOCATE EXISTING |
| EMT | ELECTRIC METALLIC TUBING | RM | ROOM |
| EUH | ELECTRIC UNIT HEATER | RR | REMOVE AND REPLACE ON NEW SURFACE |
| EWC | ELECTRIC WATER COOLER | RTU | ROOFTOP UNIT |
| EWV | ELECTRIC WATER HEATER | SE | SECONDARY ELECTRICAL SERVICE |
| F | FAHRENHEIT | SPEC | SPECIFICATION |
| FA | FIRE ALARM | SWBD | SWITCHBOARD |
| FACP | FIRE ALARM CONTROL PANEL | TELE | TELECOMMUNICATIONS/TELEPHONE |
| FC | FOOT CANDLE | TV | TRANSIENT VOLTAGE SUPPRESSION |
| FCU | FAN COIL UNIT | TVSS | TELEVISION |
| G | GROUND | T/TX | TRANSFORMER |
| GFI | GROUND FAULT INTERRUPTER | TYP | TYPICAL |
| HP | HORSE POWER | UGT | UNDERGROUND TRENCH |
| HPS | HIGH PRESSURE SODIUM | UH | UNIT HEATER |
| HR | HOUR | V | VOLTS |
| HZ | HERTZ | VA | VOLT AMPERE |
| IG | ISOLATED GROUND | VAC | VOLTS ALTERNATING CURRENT |
| IN | INCHES | W | WATT, WIRE |
| JB | JUNCTION BOX | WAP | WIRELESS ACCESS POINT |
| | | WG | WIRE GUARD |
| | | WP | WEATHERPROOF |

| | | | | | |
|---|----------|-------------------------------|---|---------------------------------------|----------|
| drawing title ELECTRICAL ABBREVIATIONS, SYMBOLS & NOTES | | | STATE OF CONNECTICUT DEPARTMENT OF ADMINISTRATIVE SERVICES | | |
| REVISIONS | | | | | |
| mark | date | description | drawing prepared by | scale | date |
| | 8/4/17 | SCHEMATIC DESIGN SUBMISSION | CONSULTING ENGINEERING SERVICES, INC. 811 MIDDLE STREET MIDDLETOWN, CT | AS NOTED | 07/25/18 |
| | 1/15/18 | DESIGN DEVELOPMENT SUBMISSION | | | |
| | 4/16/18 | CONSTRUCTION DOCUMENTS | project WESTERN CT STATE UNIVERSITY WHITE HALL 2ND AND 3RD FLOOR RENOVATIONS DANBURY, CONNECTICUT | drawn by MAL approved by SJM | |
| | 7/25/18 | | | drawing no. | |
| | 12/11/19 | | CAD no. project no. BI-RD-299 | | |
| | | | | E2.01 | |

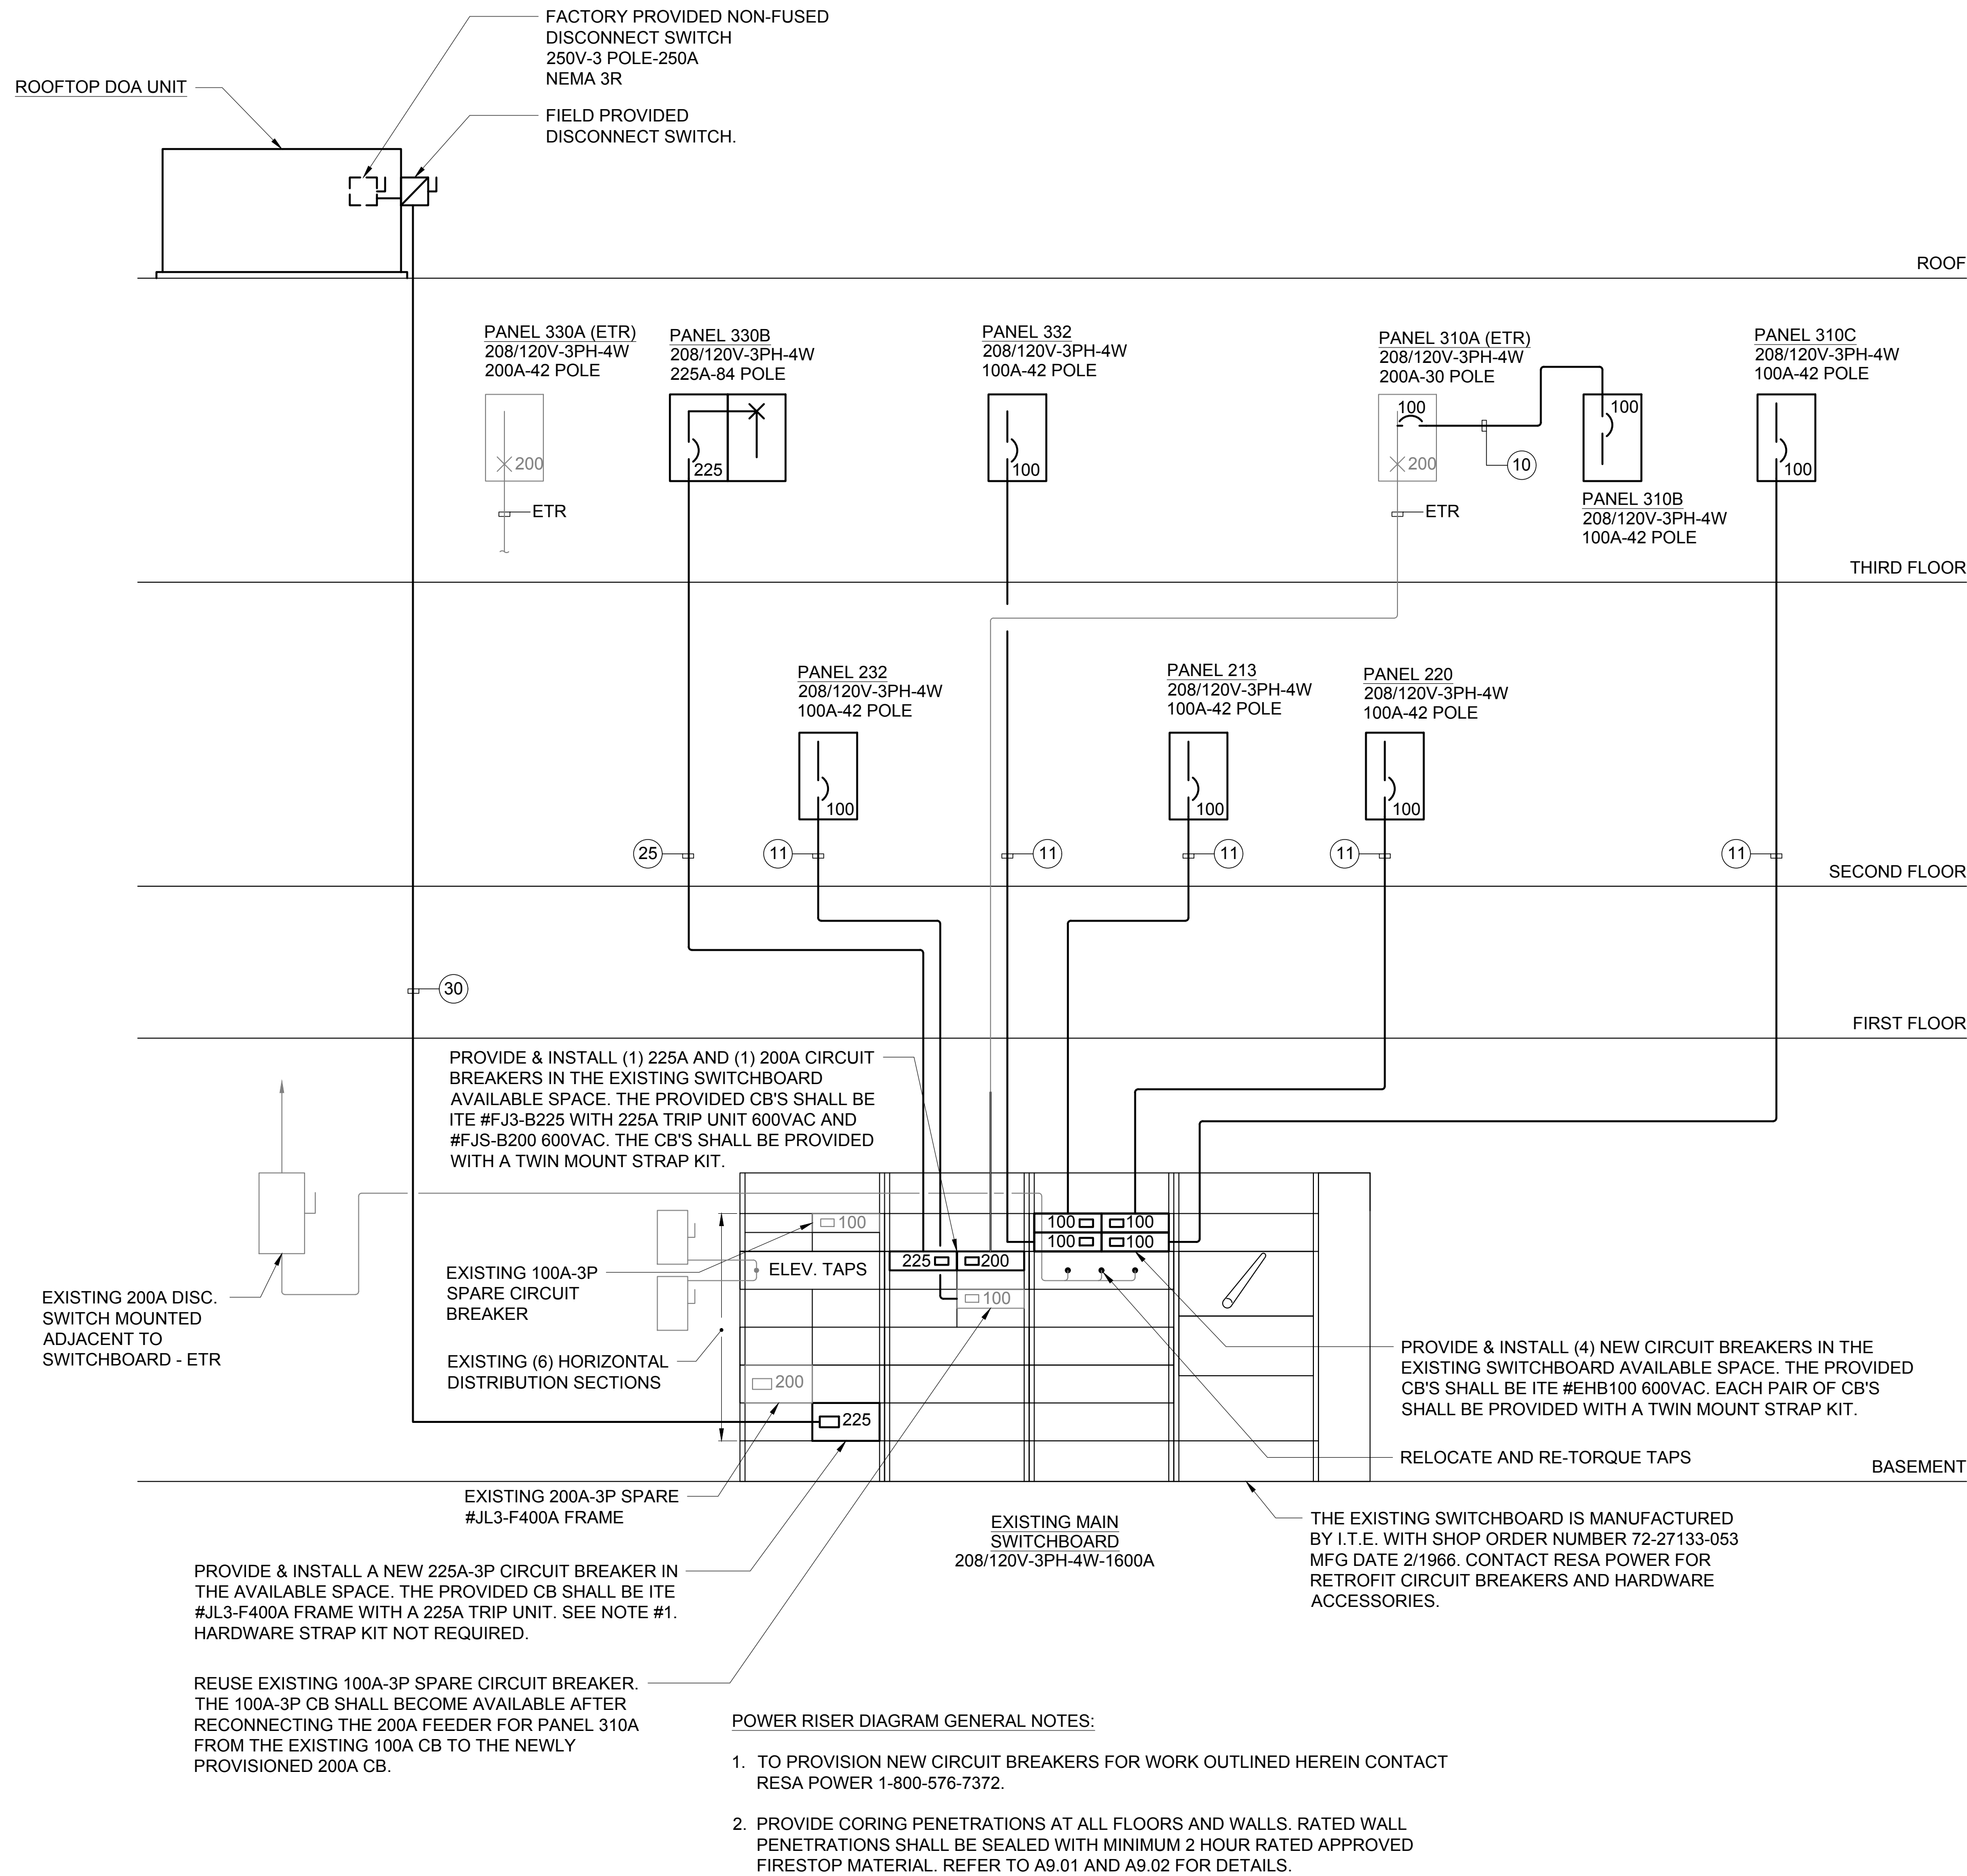

1 PARTIAL ONE-LINE POWER RISER DIAGRAM
SCALE: NO SCALE

THREE PHASE COPPER FEEDER SCHEDULE

| CIRCUIT SYMBOL | CONDUCTORS (3 PH, 3W) WITH GROUND | CONDUIT SIZE | CONDUCTORS (3 PH, 4W) | CONDUIT SIZE | OVERCURRENT RATING |
|----------------|-------------------------------------|--------------|-------------------------------------|--------------|--------------------|
| 5 | 3#6 & 1#10G | 3/4" | 4#6 & 1#10G | 1" | 50A |
| 6 | 3#4 & 1#10G | 1" | 4#4 & 1#10G | 1 1/4" | 60A |
| 7 | 3#4 & 1#8G | 1" | 4#4 & 1#8G | 1 1/4" | 70A |
| 8 | 3#3 & 1#8G | 1 1/4" | 4#3 & 1#8G | 1 1/4" | 80A |
| 9 | 3#2 & 1#8G | 1 1/4" | 4#2 & 1#8G | 1 1/4" | 90A |
| 10 | 3#1 & 1#8G | 1 1/2" | 4#1 & 1#8G | 1 1/2" | 100A |
| 11 | 3#2 & 1#6G | 1 1/4" | 4#2 & 1#6G | 1 1/4" | 110A |
| 12 | 3#1 & 1#6G | 1 1/2" | 4#1 & 1#6G | 1 1/2" | 125A |
| 15 | 3#1/0 & 1#6G | 1 1/2" | 4#1/0 & 1#6G | 2" | 150A |
| 17 | 3#2/0 & 1#6G | 2" | 4#2/0 & 1#6G | 2" | 175A |
| 20 | 3#3/0 & 1#6G | 2" | 4#3/0 & 1#6G | 2" | 200A |
| 22 | 3#4/0 & 1#4G | 2" | 4#4/0 & 1#4G | 2 1/2" | 225A |
| 25 | 3#250KCMIL & 1#4G | 2 1/2" | 4#250KCMIL & 1#4G | 3" | 250A |
| 30 | 3#350KCMIL & 1#4G | 3" | 4#350KCMIL & 1#4G | 3" | 300A |
| 35 | 3#500KCMIL & 1#3G | 3" | 4#500KCMIL & 1#3G | 4" | 350A |
| 40 | 3#600KCMIL & 1#3G | 3" | 4#600KCMIL & 1#3G | 4" | 400A |
| 45 | 2 SETS OF: 3#4/0+1#2G | (2) 2" | 2 SETS OF: 4#4/0+1#2G | (2) 3" | 450A |
| 50 | 2 SETS OF: 3#250KCMIL+1#2G | (2) 2-1/2" | 2 SETS OF: 4#250KCMIL+1#2G | (2) 3" | 500A |
| 60 | 2 SETS OF: 3#350KCMIL+1#1G | (2) 3" | 2 SETS OF: 4#350KCMIL+1#1G | (2) 3" | 600A |
| 70 | 2 SETS OF: 3#500KCMIL+1#1/0G | (2) 3" | 2 SETS OF: 4#500KCMIL+1#1/0G | (2) 4" | 700A |
| 80 | 2 SETS OF: 3#600KCMIL+1#1/0G | (2) 3" | 2 SETS OF: 4#600KCMIL+1#1/0G | (2) 4" | 800A |
| 90 | 3 SETS OF: 3#350KCMIL+1#2/0G | (3) 3" | 3 SETS OF: 4#350KCMIL+1#2/0G | (3) 3" | 900A |
| 100 | 3 SETS OF: 3#400KCMIL+1#2/0G | (3) 3" | 3 SETS OF: 4#400KCMIL+1#2/0G | (3) 4" | 1000A |
| 120 | 4 SETS OF: 3#350KCMIL+1#3/0G | (4) 3" | 4 SETS OF: 4#350KCMIL+1#3/0G | (4) 4" | 1200A |
| 160 | 4 SETS OF: 3#600KCMIL+1#4/0G | (4) 3" | 4 SETS OF: 4#600KCMIL+1#4/0G | (4) 4" | 1600A |
| 200 | 5 SETS OF: 3#600KCMIL+1#250KCMIL(G) | (5) 3" | 5 SETS OF: 4#600KCMIL+1#250KCMIL(G) | (5) 4" | 2000A |
| 250 | 6 SETS OF: 3#600KCMIL+1#350KCMIL(G) | (6) 3" | 6 SETS OF: 4#600KCMIL+1#350KCMIL(G) | (6) 4" | 2500A |
| 300 | 8 SETS OF: 3#500KCMIL+1#500KCMIL(G) | (8) 3" | 8 SETS OF: 4#500KCMIL+1#500KCMIL(G) | (8) 4" | 3000A |

NOTES:


- UNLESS OTHERWISE INDICATED, CONDUCTOR SIZING SHALL MATCH THE SIZE INDICATED ABOVE FOR THE APPLICABLE OVERCURRENT DEVICE. PROVIDE LARGER CONDUCTORS AND CONDUIT WHERE INDICATED, OR AS REQUIRED BY CODE.
- CONDUIT SIZES IN THIS TABLE REFLECT THE REQUIREMENTS OF NEC INFORMATIVE ANNEX "C", TABLE C.1.
- PROVIDE A 4-WIRE CIRCUIT UNLESS DEVICE SERVED DOES NOT HAVE PROVISIONS FOR A NEUTRAL.
- REFER TO PANELBOARD SCHEDULES AND MOTOR CIRCUIT SCHEDULE (WHERE APPLICABLE) FOR CONDUCTOR AND CONDUIT SIZE REQUIREMENTS FOR OTHER MOTOR LOADS NOT SHOWN ON ONE LINE DIAGRAM.
- CONDUCTOR SIZES ARE BASED ON 60°C WHERE AMPACITY IS LESS THAN OR EQUAL TO 100A AND 75°C WHERE AMPACITY IS GREATER THAN 100A. ALL EQUIPMENT AND CONDUCTOR TERMINATIONS CONNECTED TO WIRES SHALL MATCH THESE RATINGS.
- REFER TO SPECIFICATIONS FOR ADDITIONAL ELECTRICAL CONDUCTOR REQUIREMENTS.

ELECTRICAL SERVICE CALCULATION

CALCULATED IN ACCORDANCE WITH NEC ARTICLE 220.87:
 EXISTING MAXIMUM ELECTRICAL DEMAND RECORDED IN AUGUST/SEPTEMBER OF 2015: 232.0 kW
 EXISTING MAXIMUM DEMAND CALCULATED AT 125% = 232.0 X 1.25 = 290 kW
 NEW LOAD TO THE BUILDING:
 DOA - 55.60 kW
 CONDENSING UNITS - 98.00 kW
 VRV UNITS - 12.30 kW

TOTAL CALCULATED LOAD = 455.90 kW
 455900 / .90 PF = 506555 kVA / 360 = 1407 AMPERES

| REVISIONS | | | STATE OF CONNECTICUT DEPARTMENT OF ADMINISTRATIVE SERVICES | |
|-----------|--------------------------------|-------------------------------|---|-----------------------------|
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| | 8/4/17 | SCHEMATIC DESIGN SUBMISSION | CONSULTING ENGINEERING SERVICES, INC. 811 MIDDLE STREET MIDDLETOWN, CT | 07/25/18 |
| | 1/15/18 | DESIGN DEVELOPMENT SUBMISSION | | AS NOTED |
| | 4/16/18 | CONSTRUCTION DOCUMENTS | | drawn by MAL |
| | 5/23/18 7/25/18 12/11/19 | | | approved by SJM |
| | | | project WESTERN CT STATE UNIVERSITY WHITE HALL 2ND AND 3RD FLOOR RENOVATIONS DANBURY, CONNECTICUT | drawing no. E2.02 |
| | | | CAD no. | project no. BI-RD-299 |

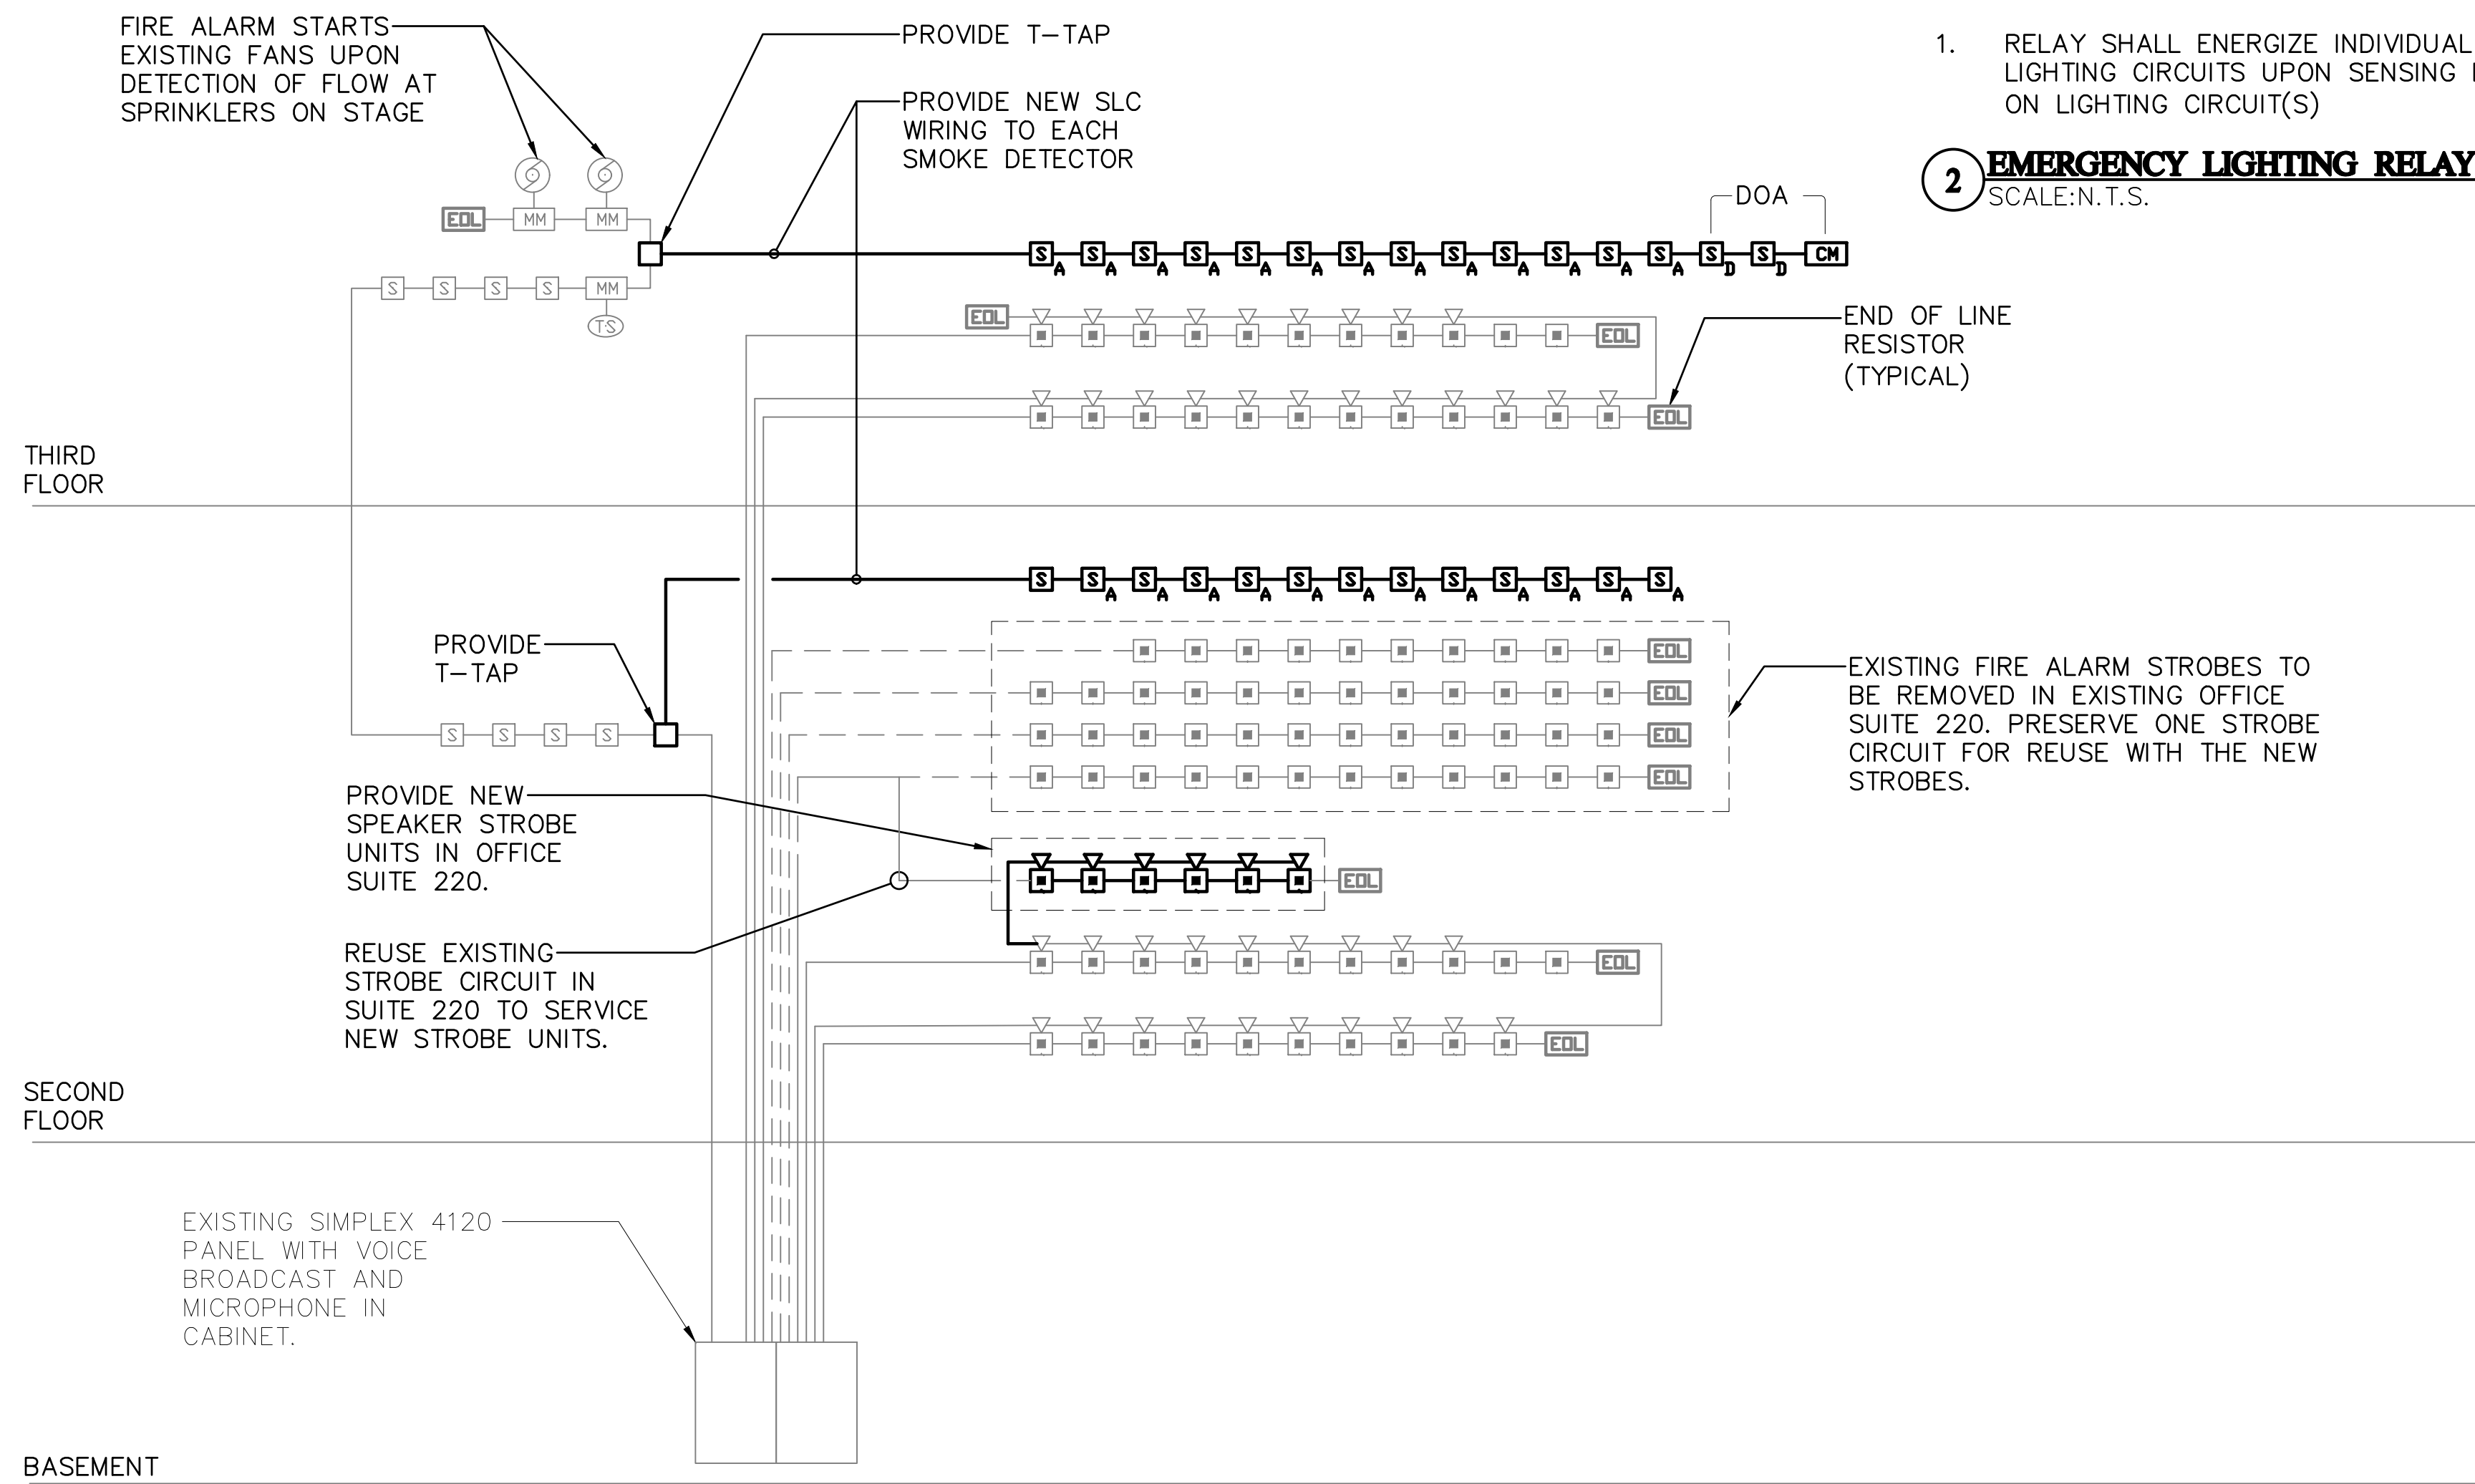


GENERAL NOTES - FIRE ALARM SYSTEM:

- EXISTING SIMPLEX 4100 SYSTEM TO BE REUSED
- ALL EQUIPMENT, WIRING, MISC MATERIALS, PROGRAMMING, ACCEPTANCE TESTING SHOULD BE PERFORMED UNDER THIS CONTRACT.
- BASE BID WORK WILL REQUIRE A CPU/BACKPLANE UPGRADE AND IDNET2+2 250 POINT 4 LOOP MODULE INSTALLED WITHIN THE CONTROL PANEL.
- THE RISER DIAGRAM DEPICTS BASE BID REQUIREMENTS, REFER TO SIMPLEX GRINNELL TECHNICAL SUPPORT.
- THE EC SHALL UTILIZE SIMPLEX GRINNELL FOR A TURNKEY SYSTEM INSTALLATION. CONTACT RICHARD BAKER AT SIMPLEX GRINNELL 860-602-3200. ALL COSTS RELATED TO FIRE ALARM SYSTEM IMPROVEMENTS SHALL BE CARRIED UNDER THIS CONTRACT.
- BASEMENT AND FIRST FLOOR PERIPHERAL DEVICES ARE NOT INDICATED ON THIS RISER DIAGRAM.


BASE BID REQUIREMENTS:

CONVERT FULL SECOND AND THIRD FLOOR SMOKE DETECTORS, PULL STATIONS, AND DUCT SMOKE DETECTOR INFRASTRUCTURE TO ADDRESSABLE CONFIGURATION, INSTALL (2) DUCT SMOKE DETECTORS AND SHUT DOWN MODULE FOR DOA. A TOTAL OF 119 POINTS OF EXISTING EQUIPMENT SHALL BE CONVERTED TO ADDRESSABLE WITH NEW SMOKE DETECTORS. EQUIPMENT TO REMAIN SHALL BE PROVIDED WITH MONITOR MODULES. SIMPLEX GRINNELL REFERENCE #129424481

1 FIRE ALARM RISER DIAGRAM
SCALE:N.T.S.

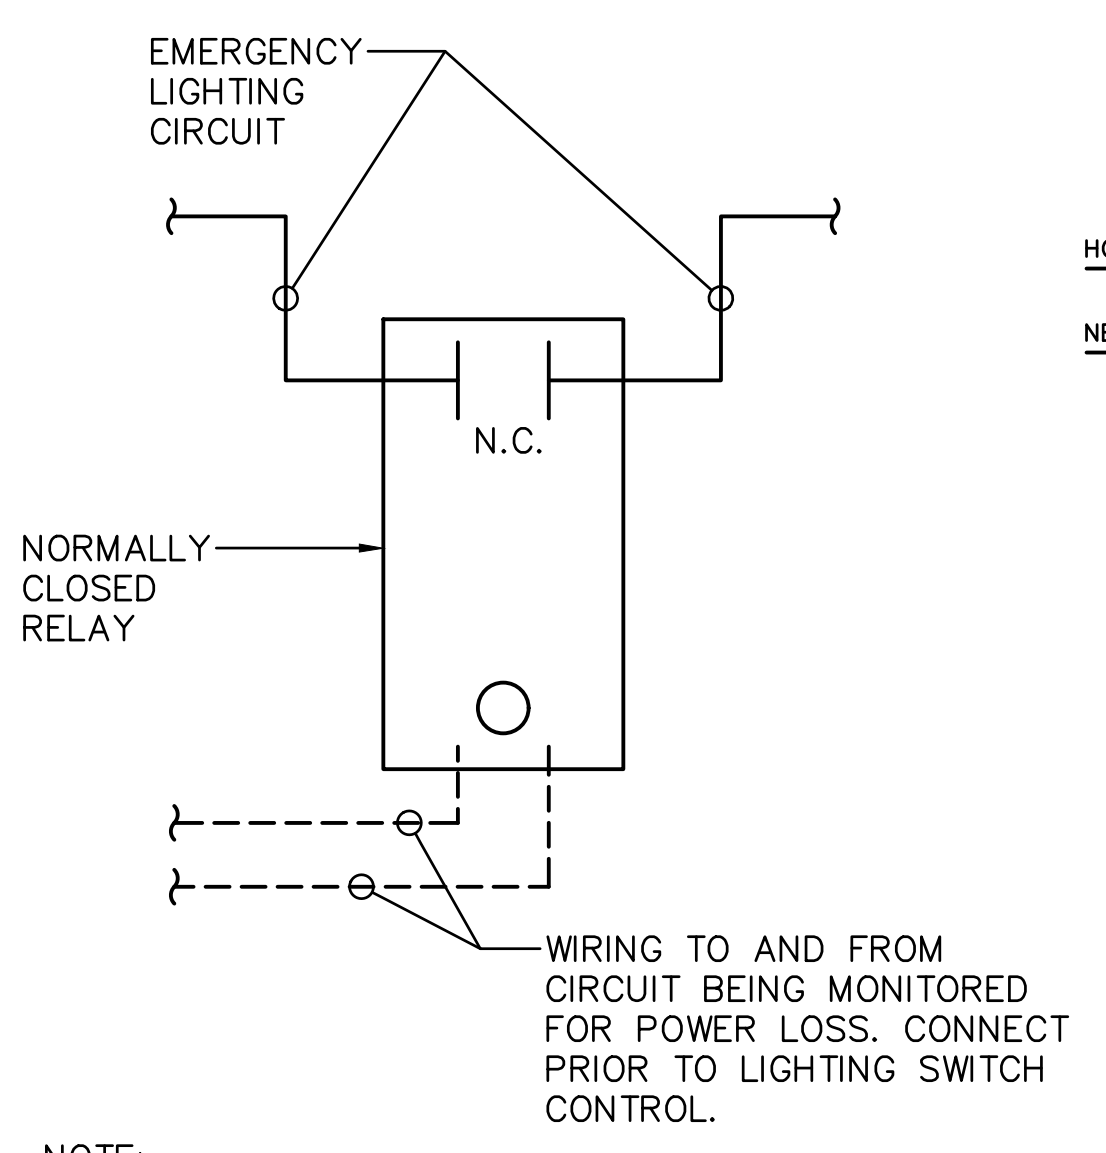


- NOTE:**
- RELAY SHALL ENERGIZE INDIVIDUAL EMERGENCY LIGHTING CIRCUITS UPON SENSING LOSS OF POWER ON LIGHTING CIRCUIT(S)
- 2 EMERGENCY LIGHTING RELAY WIRING DETAIL**
SCALE:N.T.S.

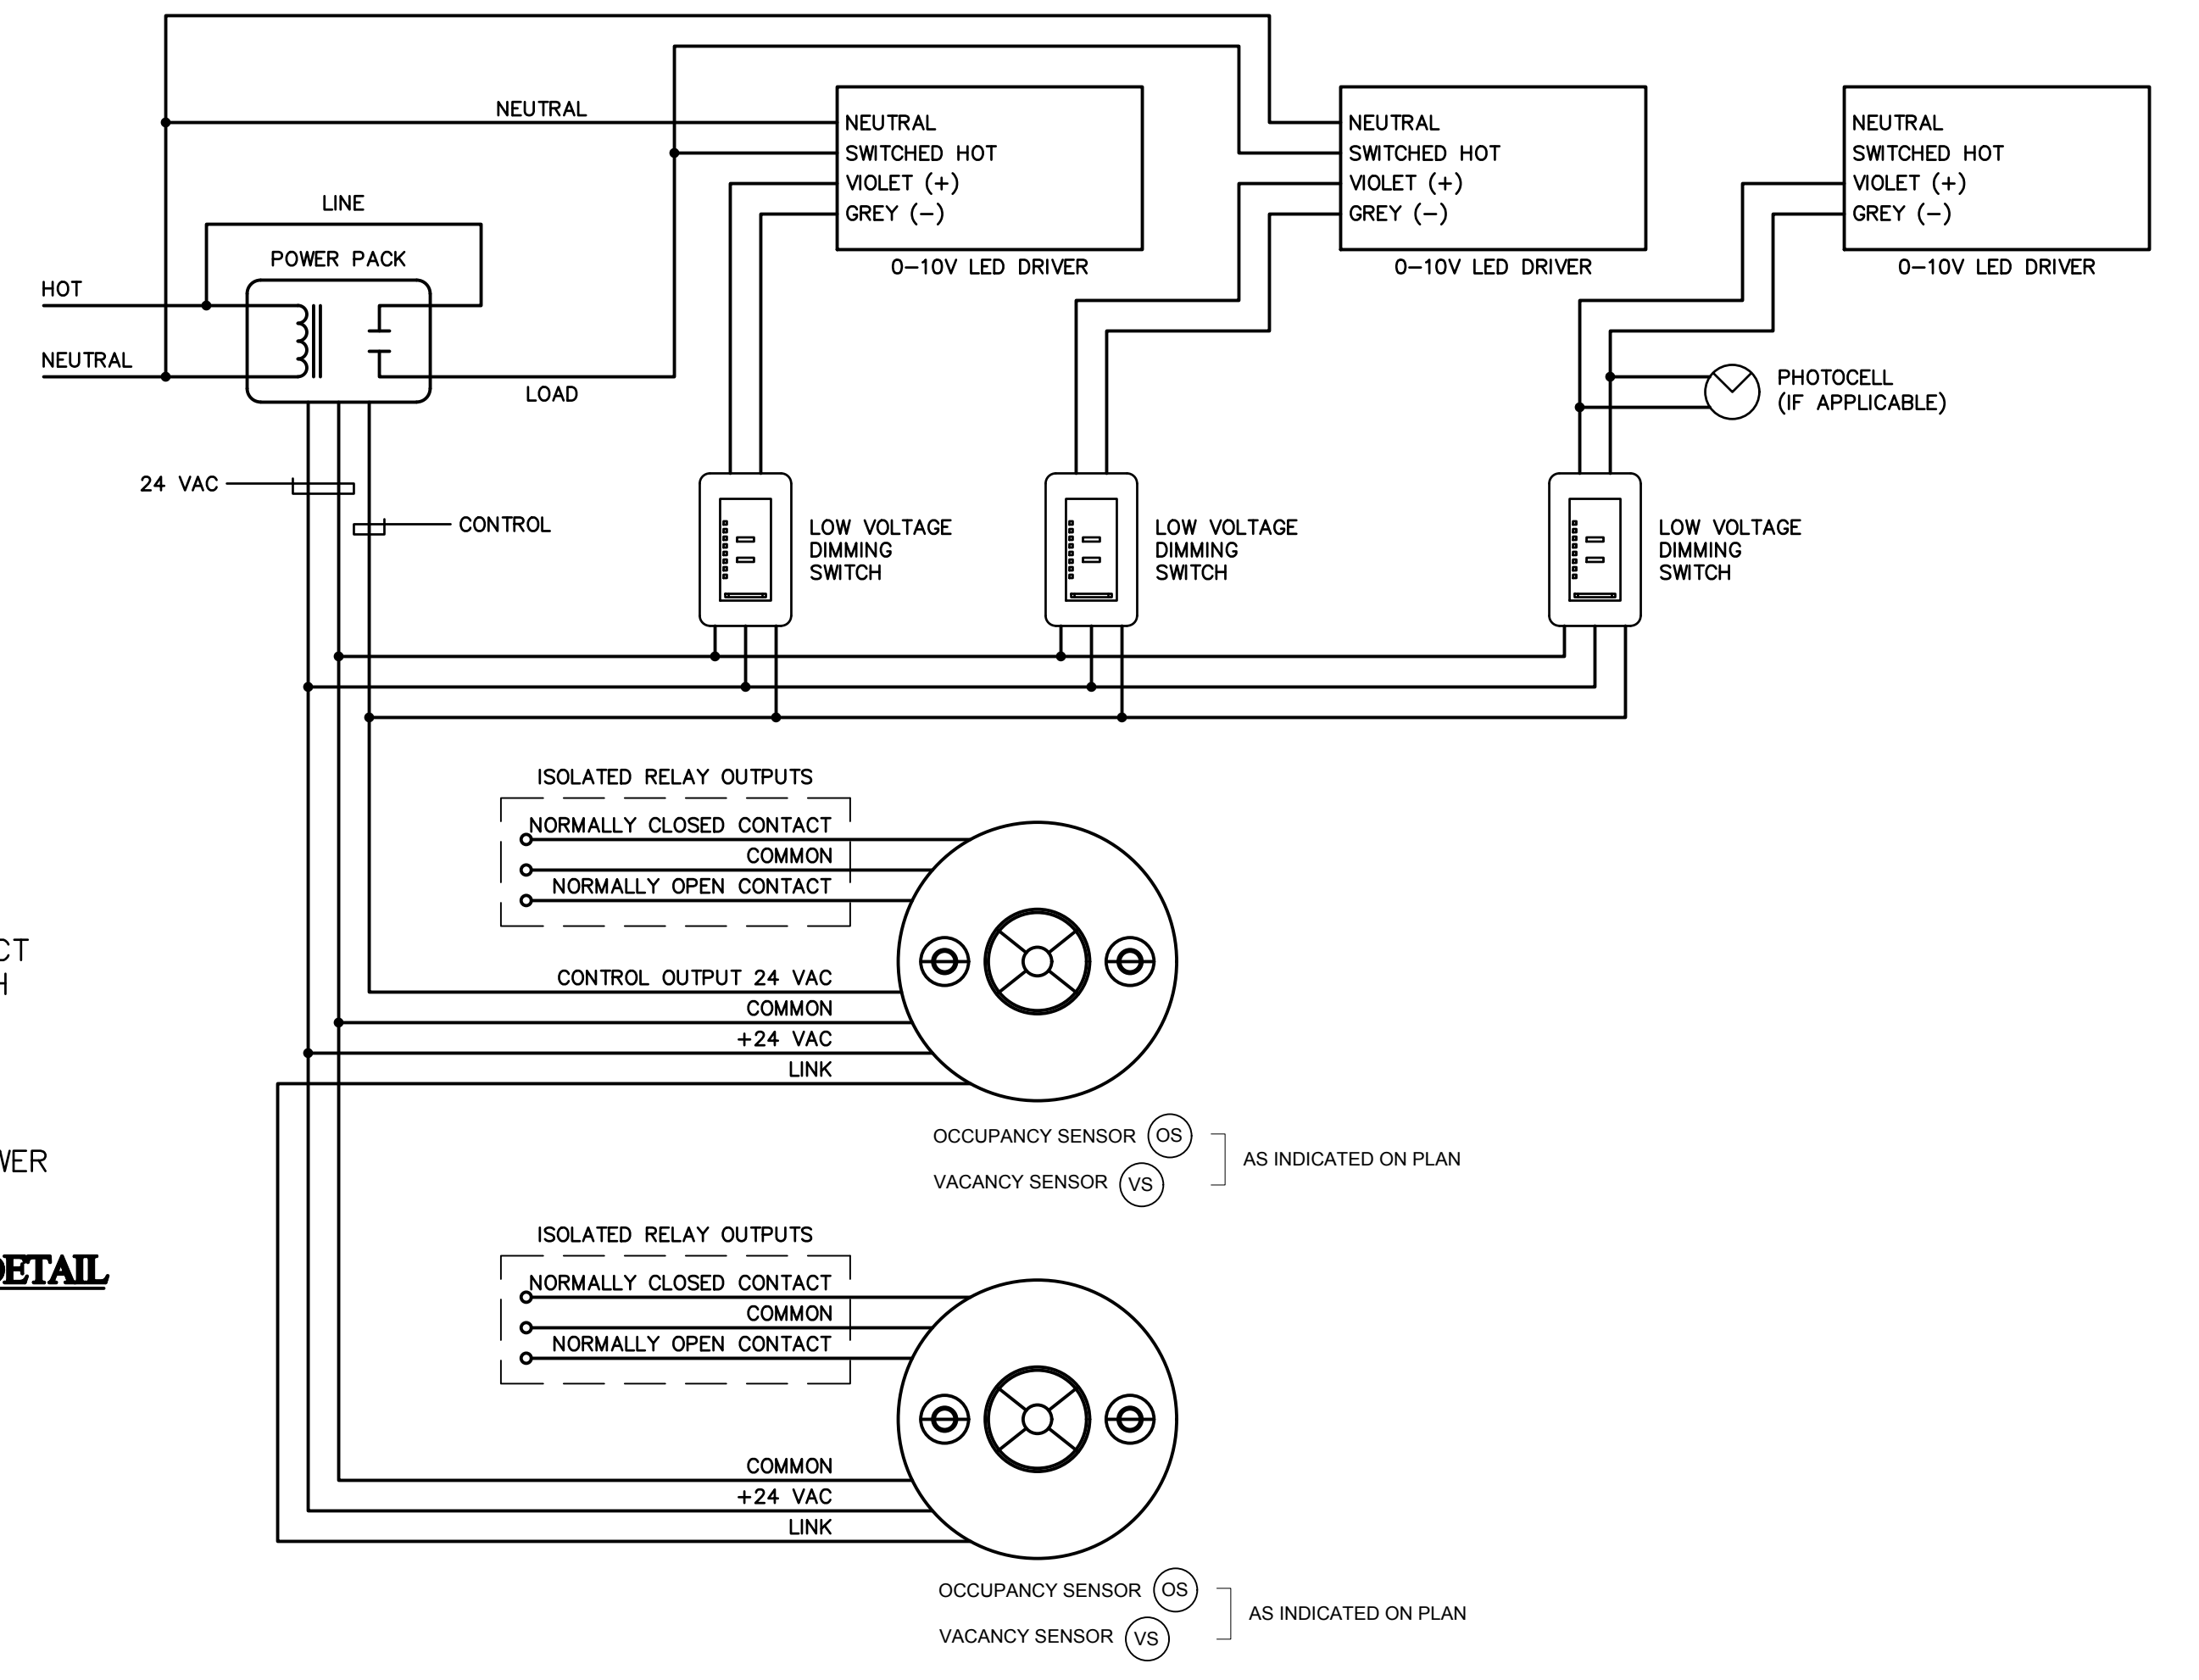


- NOTES:**
- REFER TO MANUFACTURERS WIRING DIAGRAM FOR EXACT WIRING DETAIL.
 - NO MORE THAN EIGHT SENSORS TO ONE POWER PACK.
 - PROVIDE LOW VOLTAGE MANUAL ON DIMMER SWITCHES WITH MOUNTING PLATE AND DECORA COVER PLATE TO MATCH NEW SWITCH PLATES.
 - SET SENSOR TO "VACANCY" OR "OCCUPANCY" OPERATION.
 - ALL SWITCHES CONTROL ON/OFF OPERATION.
 - TYPICAL FOR CONFERENCE ROOM AND ROOMS WITH TWO SEPARATE DIMMED LOADS.
- TYPICAL SPECIFICATION**
- CEILING MOUNTED OCCUPANCY SENSOR SHALL BE - DOUGLAS LIGHTING CONTROLS MODEL WVRSD1-R-N
- POWER PACKS SHALL BE - DOUGLAS LIGHTING CONTROLS MODEL WP-PP20-D
- LOW VOLTAGE DIMMER SHALL BE - DOUGLAS LIGHTING CONTROLS MODEL WRD-8701
- PHOTOCELL SHALL BE - DOUGLAS LIGHTING CONTROLS MODEL WPC-5700

3 STANDALONE OCCUPANCY/VACANCY SENSOR/PHOTOCELL WIRING SCHEMATIC
SCALE:N.T.S.

| drawing title | | | STATE OF CONNECTICUT | | | |
|--------------------|---------|-------------------------------|--|-------------|--------------|--|
| ELECTRICAL DETAILS | | | DEPARTMENT OF ADMINISTRATIVE SERVICES | | | |
| REVISIONS | | | | | | |
| mark | date | description | drawing prepared by | date | scale | |
| | 8/4/17 | SCHEMATIC DESIGN SUBMISSION | CONSULTING ENGINEERING SERVICES, INC. 811 MIDDLE STREET MIDDLETOWN, CT | 07/25/18 | AS NOTED | |
| | 1/15/18 | DESIGN DEVELOPMENT SUBMISSION | | | | |
| | 4/16/18 | CONSTRUCTION DOCUMENTS | | | | |
| | 5/23/18 | | WESTERN CT STATE UNIVERSITY WHITE HALL 2ND AND 3RD FLOOR RENOVATIONS DANBURY, CONNECTICUT | | | |
| | 7/25/18 | | | | | |
| | 1/21/19 | | | | | |
| | | | CAD no. | project no. | | |
| | | | | BI-RD-299 | | |
| | | | | | E3.00 | |

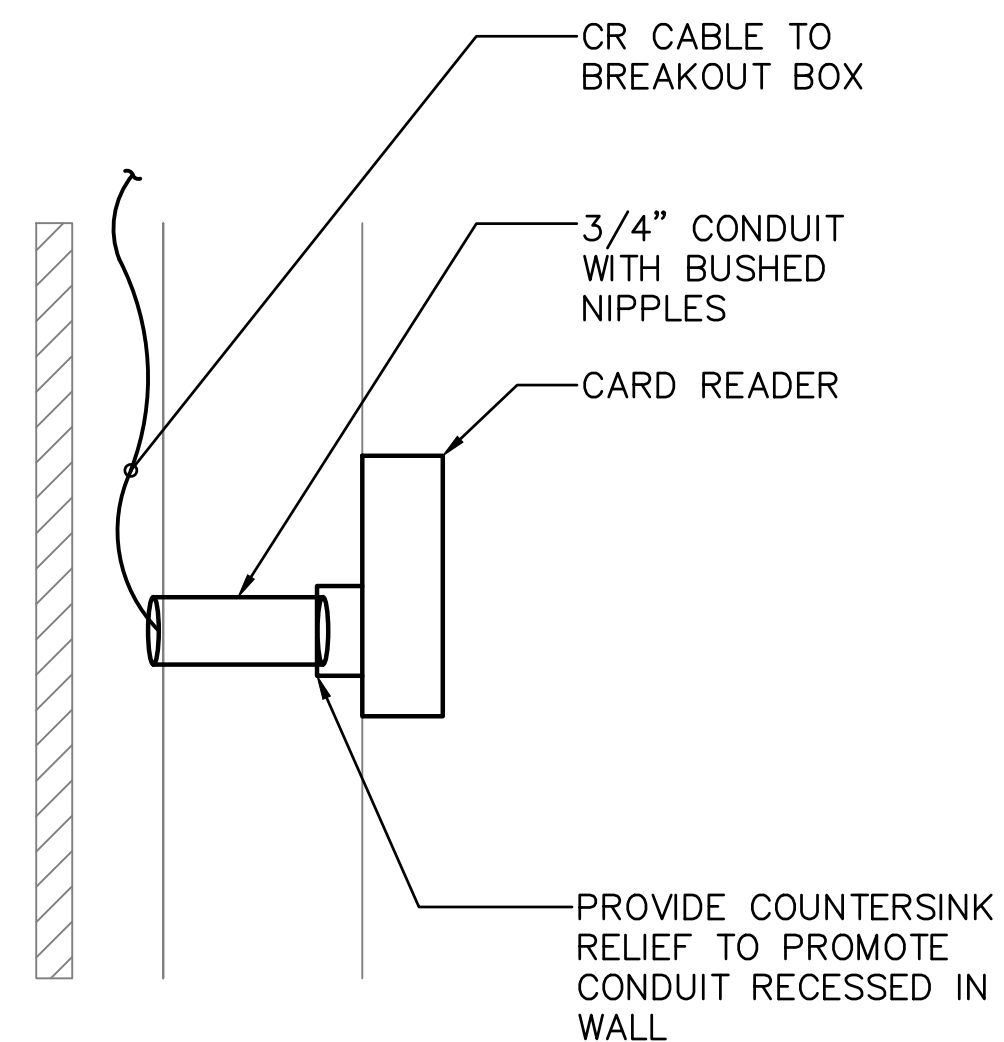


4 CARD READER MOUNTING DETAIL
SCALE: N.T.S.

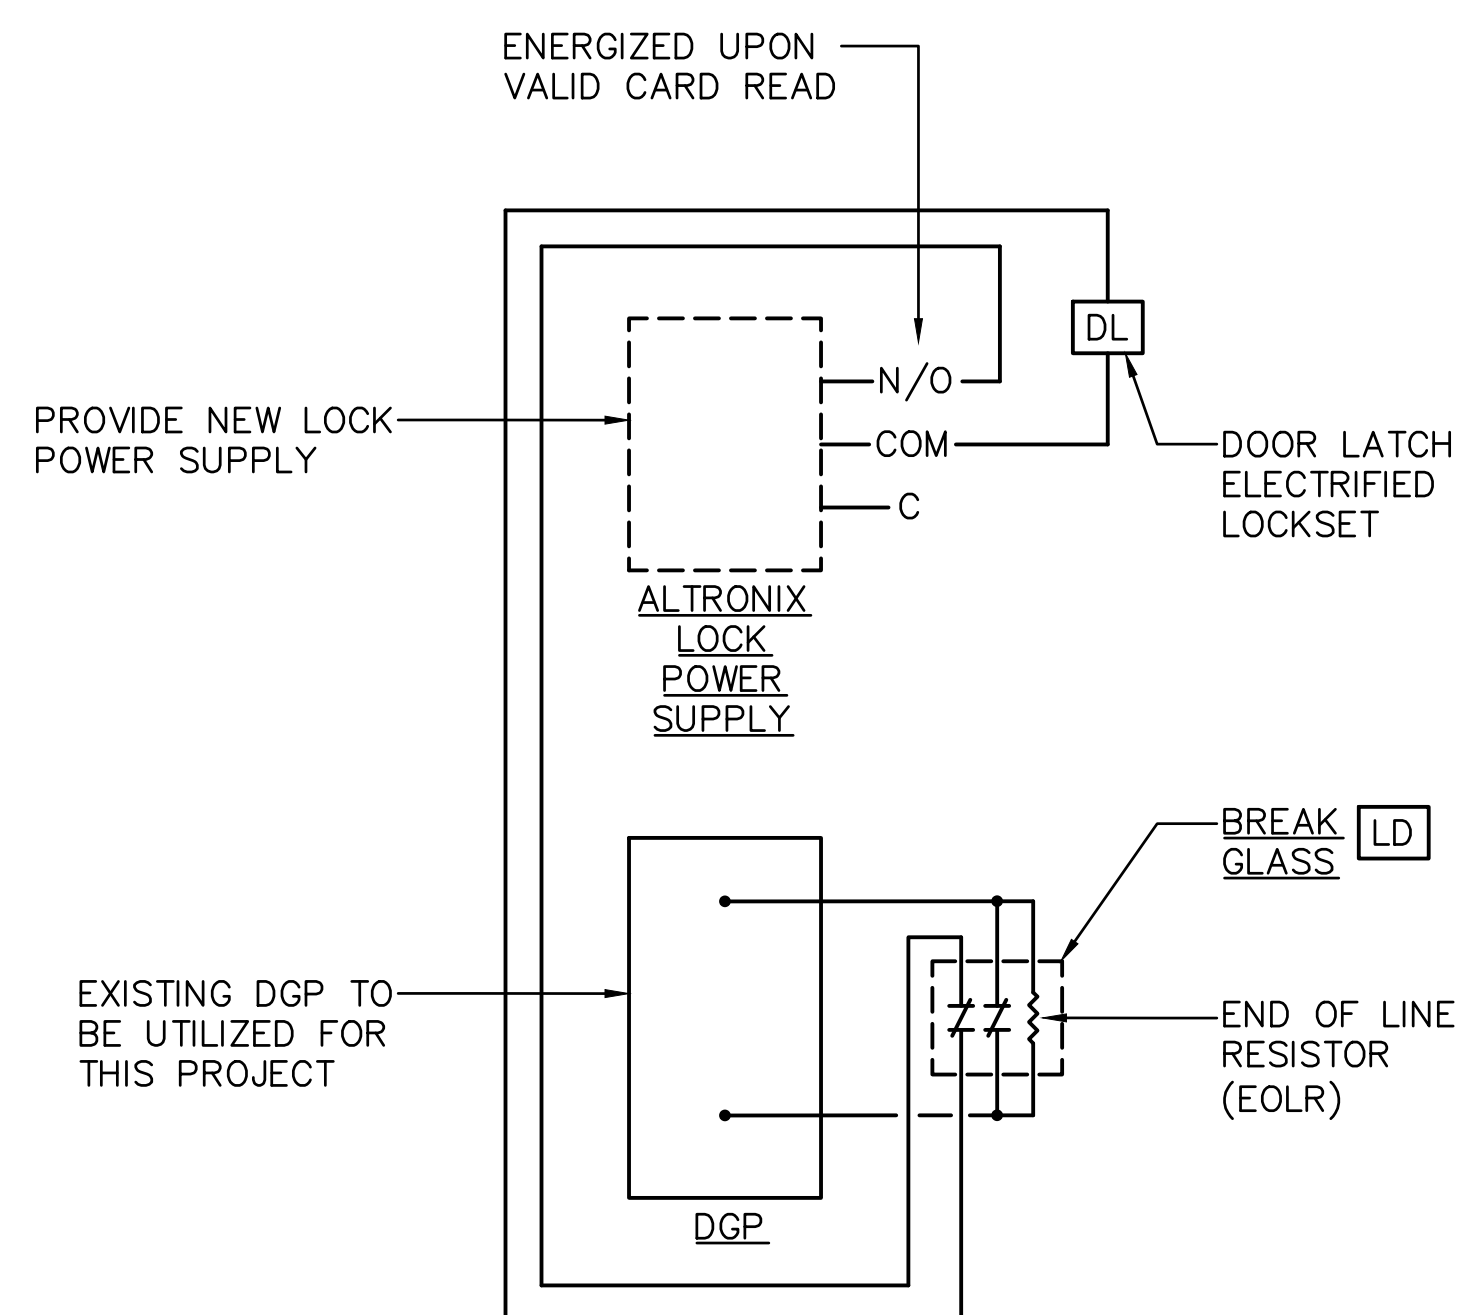

SEQUENCE OF OPERATION:

1. NORMAL STATE – BREAK GLASS CIRCUIT CLOSED, POWER TO DL NOT SUPPLIED BY ALTRONIX POWER SUPPLY AT THIS TIME
2. ACCESS REQUEST – VALID CARD READ SHALL ENERGIZE THE DL COMPONENT TO ALLOW ACCESS INTO THE ROOM
3. UPON GLASS BREAK / LOCK DOWN ACTIVATION – CONTACTS BREAK TO INTERRUPT POWER TO THE DL OPERATOR TO BLOCK ENTRY INTO THE ROOM.
4. UPON GLASS BREAK / LOCK DOWN ACTIVATION – CONTACTS MAKE OR BREAK TO SEND A SIGNAL TO THE DATA GATHERING PANEL THAT A LOCAL LOCKDOWN ACTIVATION HAS BEEN INITIATED AND THE SYSTEM SENDS A SIGNAL TO THE LOCAL POLICE DEPARTMENT.

2 NON-ADA ACCESS CONTROL WITH LOCK DOWN CIRCUIT
SCALE: N.T.S.

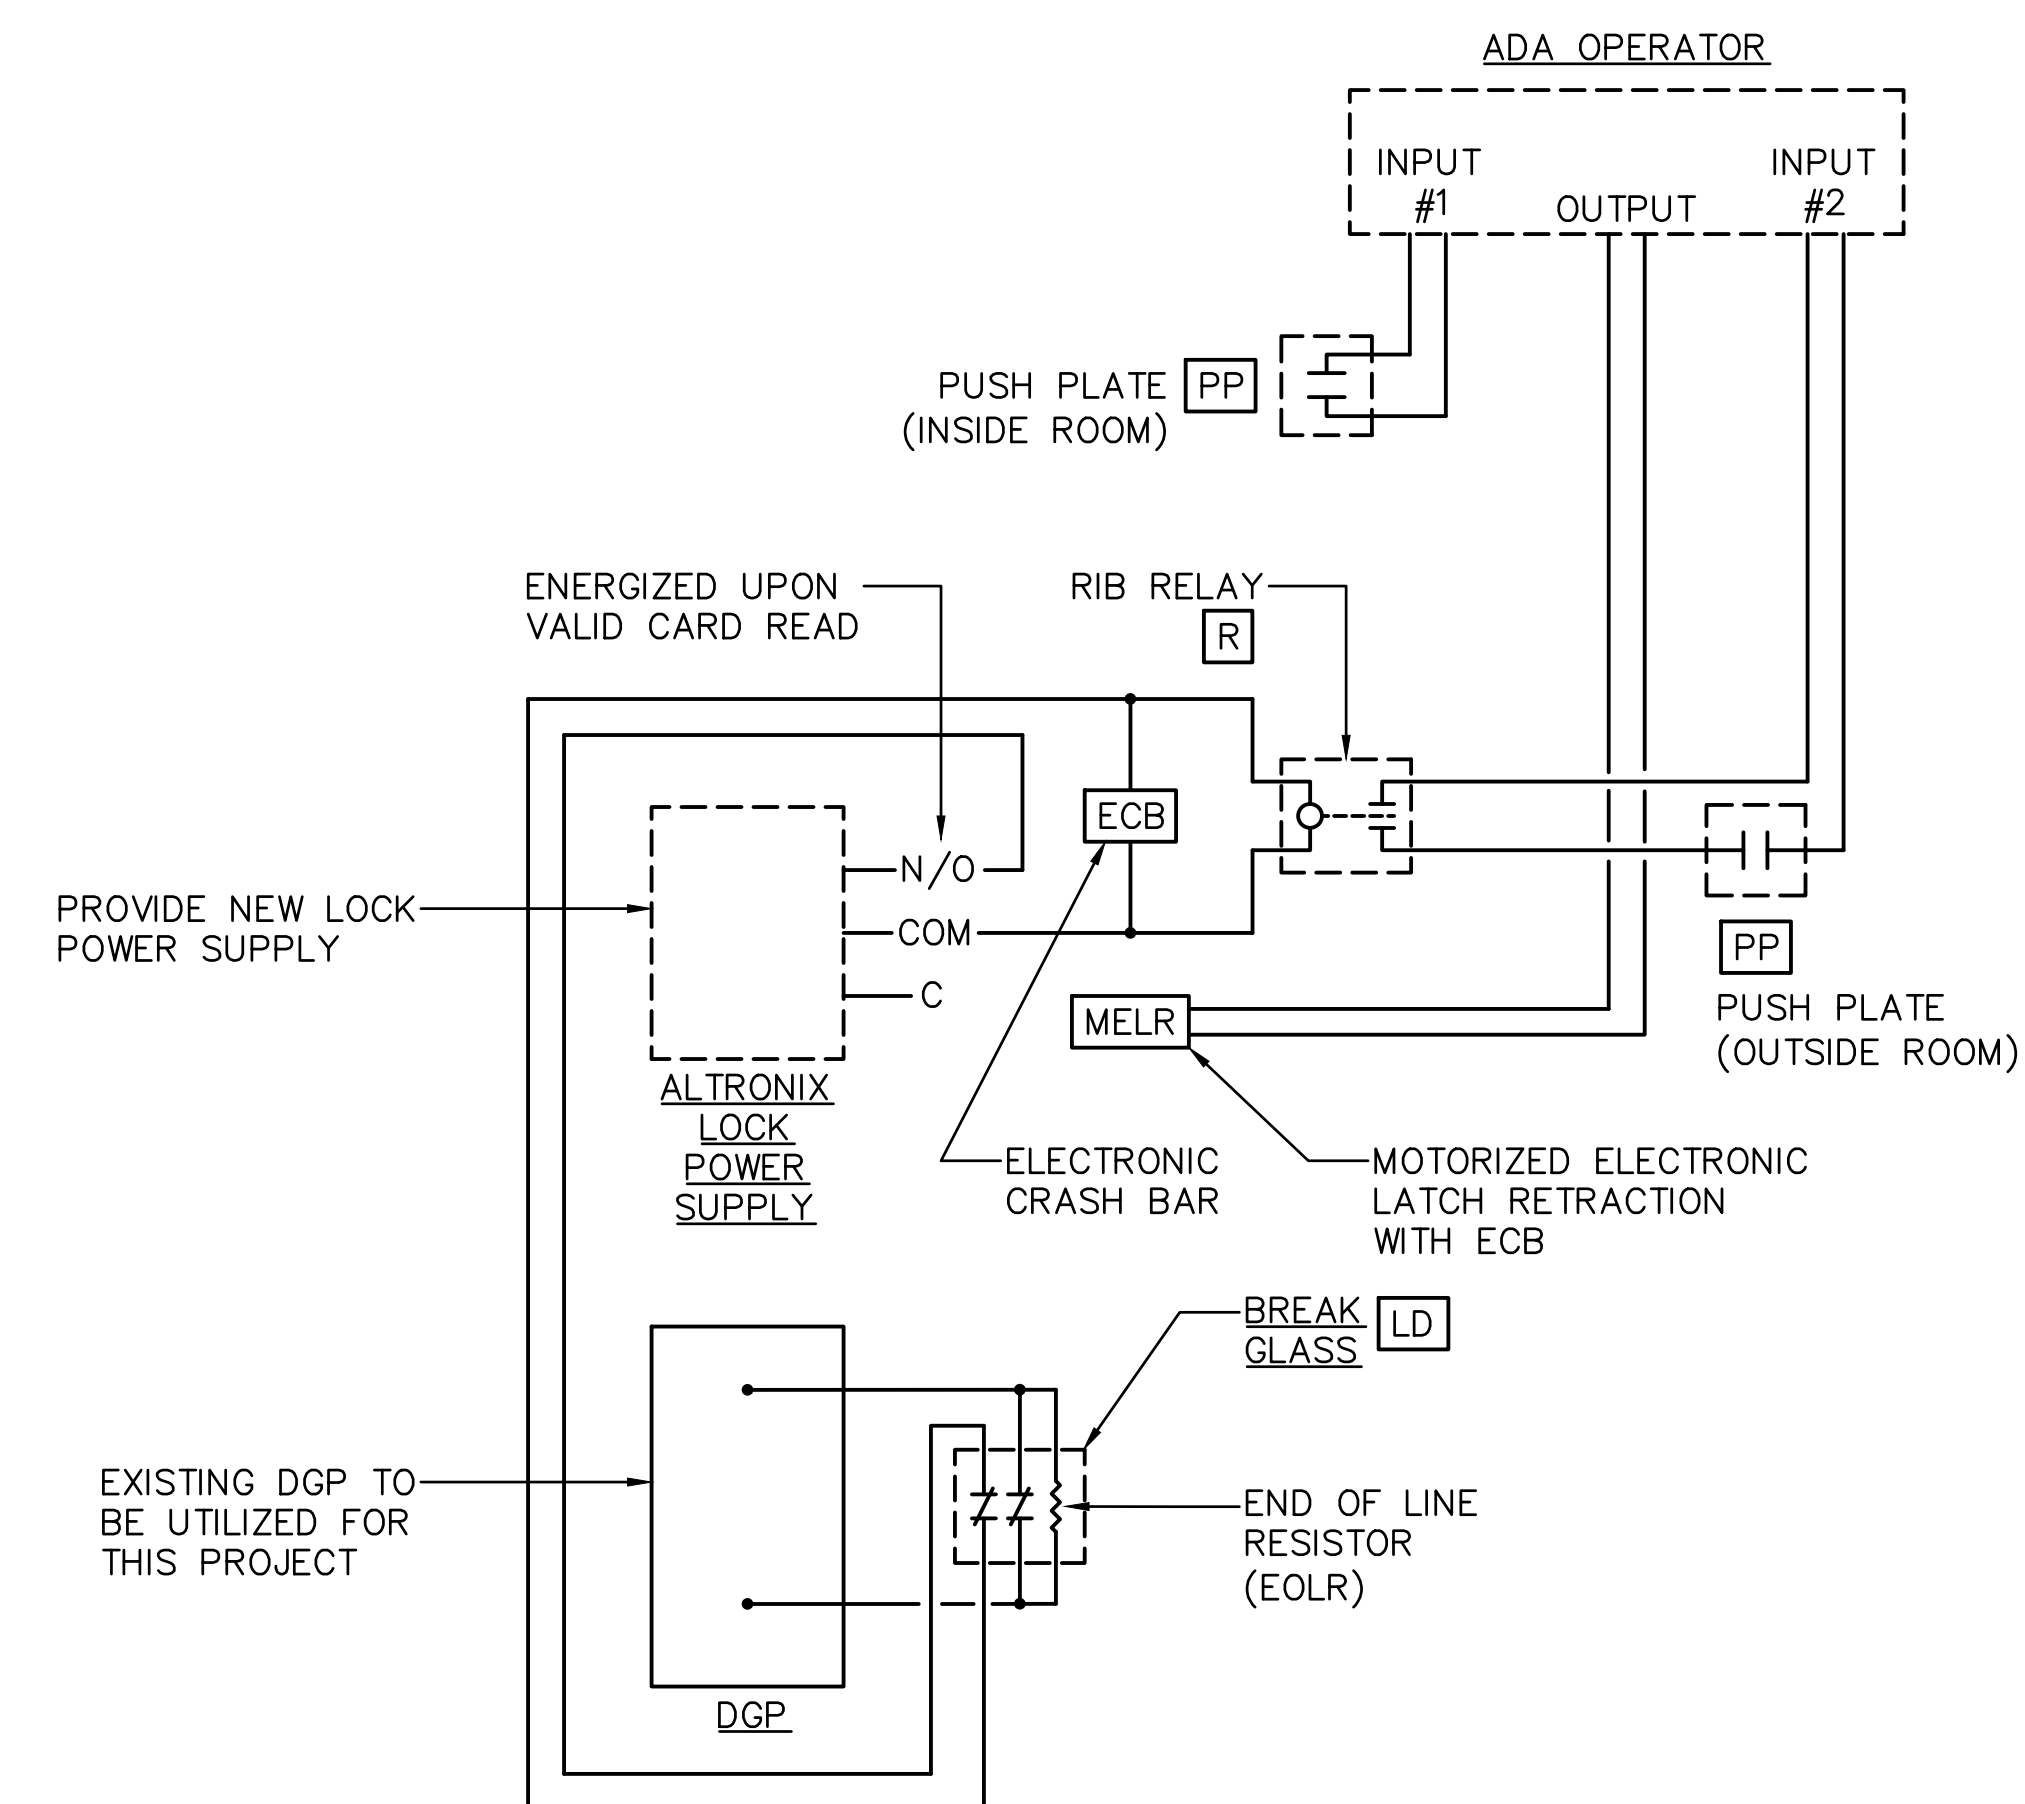


SEQUENCE OF OPERATION:

1. NORMAL STATE – BREAK GLASS CIRCUIT CLOSED, POWER TO ECB NOT SUPPLIED BY ALTRONIX POWER SUPPLY AT THIS TIME
2. ACCESS REQUEST – VALID CARD READ SHALL ENERGIZE THE ECB COMPONENT TO ALLOW ACCESS INTO THE ROOM
3. UPON SUCCESSFUL ACCESS REQUEST THE RIB RELAY SHALL BE ENERGIZED TO MAKE AND ALLOW THE EXTERNAL PUSH PLATE TO ACTIVATE THE ADA DOOR OPERATOR FOR INGRESS TO THE ROOM
4. THE INTERNAL PUSH PLATE FOR THE ADA OPERATOR SHALL ALWAYS ALLOW EGRESS FROM THE ROOM
5. INGRESS OR EGRESS FUNCTIONS ALLOWED TO THE ADA OPERATOR SHALL INITIATE THE MELR TO FUNCTION WITHIN THE ECB
6. UPON GLASS BREAK / LOCK DOWN ACTIVATION – CONTACTS BREAK TO INTERRUPT POWER TO THE ECB AND RIB RELAY / ADA OPERATOR TO BLOCK ENTRY INTO THE ROOM.
7. UPON GLASS BREAK / LOCK DOWN ACTIVATION – CONTACTS MAKE OR BREAK TO SEND A SIGNAL TO THE DATA GATHERING PANEL THAT A LOCAL LOCKDOWN ACTIVATION HAS BEEN INITIATED AND THE SYSTEM SENDS A SIGNAL TO THE LOCAL POLICE DEPARTMENT.

3 ADA ACCESS CONTROL WITH LOCK DOWN CIRCUIT
SCALE: N.T.S.


SECURITY SYSTEM NOTES

1. BACKBONE CABLING FOR ACCESS CONTROL SHALL BE SUPPLIED BY WCSU AND INSTALLED UNDER THIS DIVISION. THE EC SHALL IDENTIFY REQUIRED PATHWAYS FOR ANY NEW CABLE INSTALLATIONS AND PROVIDE AN ESTIMATED LENGTH TO WCSU ENGINEERING DEPARTMENT TO OBTAIN THE REQUIRED AMOUNT FOR JOB COMPLETION. THE CABLE ASSEMBLY SHALL BE BELDEN Y60929 1C14 12C20 SHIELDED 050513 1403 ROHS CONSTRUCTED TO WCSU STANDARDS WITH DEDICATED #14 AWG GROUND.

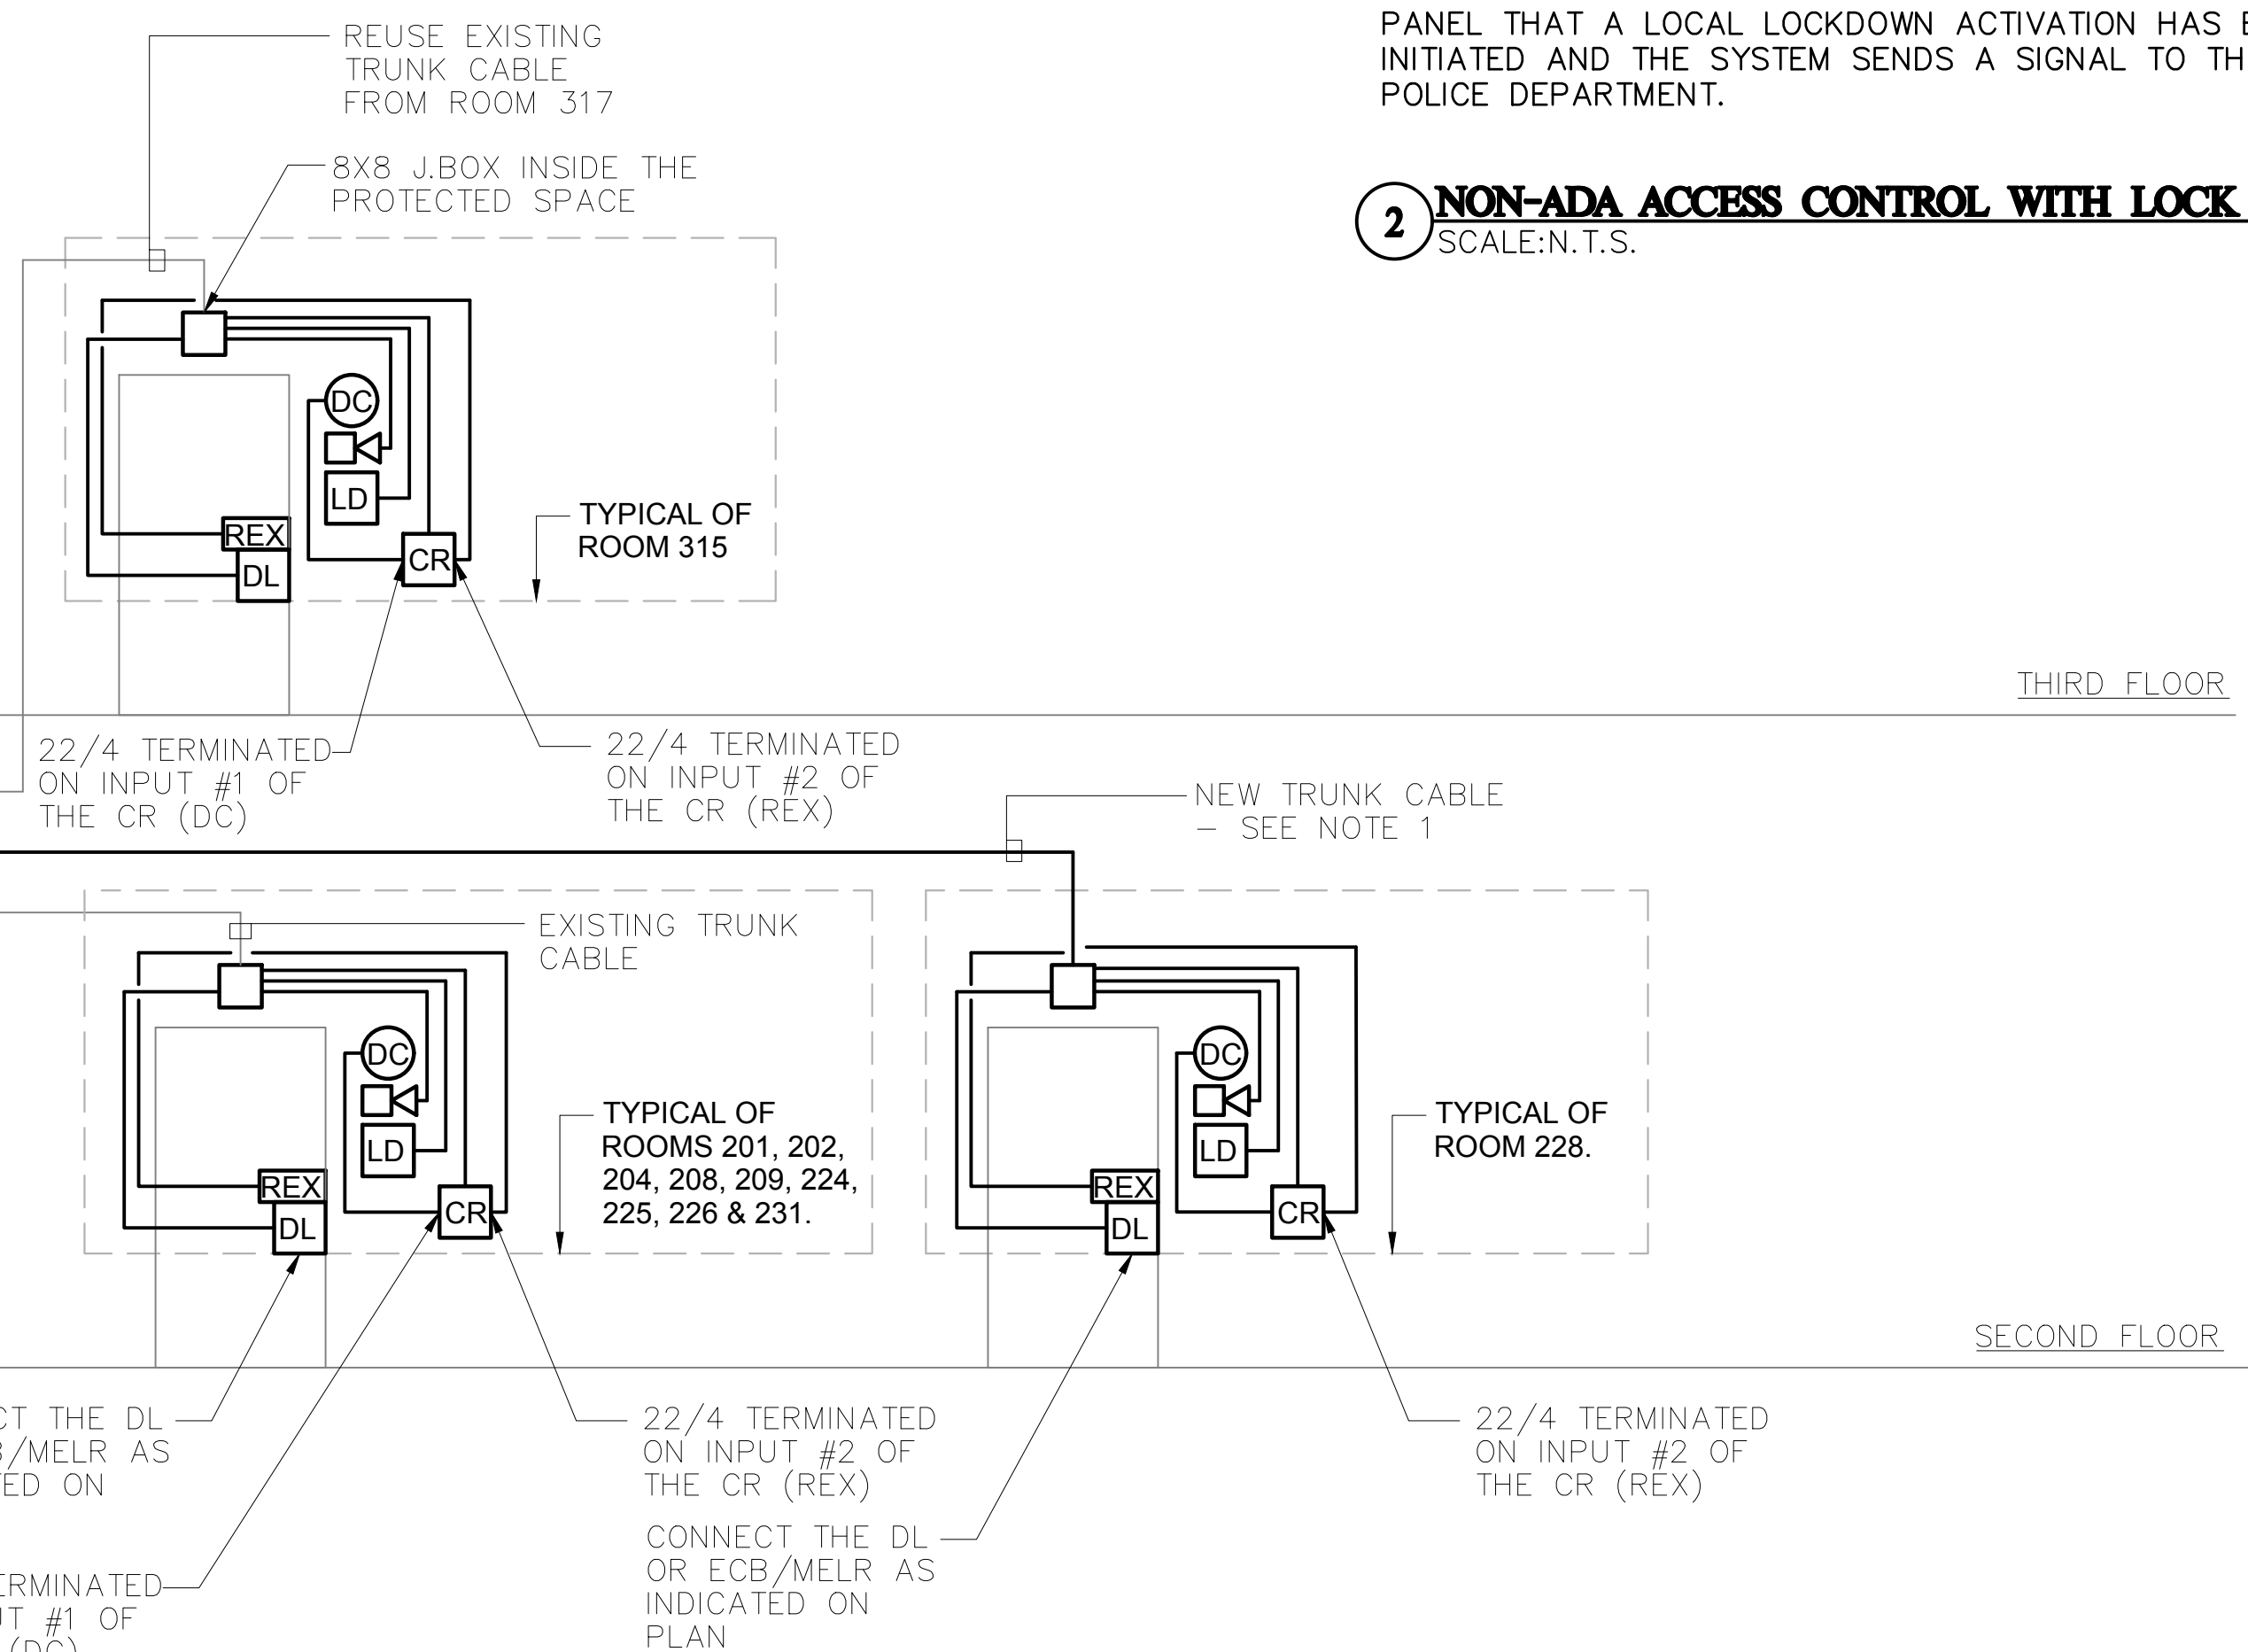


1 SECURITY/ACCESS CONTROL SYSTEM RISER DIAGRAM
SCALE: N.T.S.


| drawing title | | | STATE OF CONNECTICUT DEPARTMENT OF ADMINISTRATIVE SERVICES | | |
|-----------------------|--------------------------------|-------------------------------|--|---|----------------------|
| ELECTRICAL DETAILS | | | REVISIONS | | |
| mark | date | description | drawing prepared by | date | |
| | 8/4/17 | SCHEMATIC DESIGN SUBMISSION | CONSULTING ENGINEERING SERVICES, INC. 811 MIDDLE STREET MIDDLETOWN, CT | 07/25/18 | |
| | 1/15/18 | DESIGN DEVELOPMENT SUBMISSION | | scale AS NOTED | |
| | 4/16/18 | CONSTRUCTION DOCUMENTS | | project WESTERN CT STATE UNIVERSITY WHITE HALL 2ND AND 3RD FLOOR RENOVATIONS DANBURY, CONNECTICUT | drawn by MAL |
| | 5/23/18 7/25/18 12/11/19 | | | approved by SJM | drawing no. E3.01 |
| | | | CAD no. | project no. BI-RD-299 | |

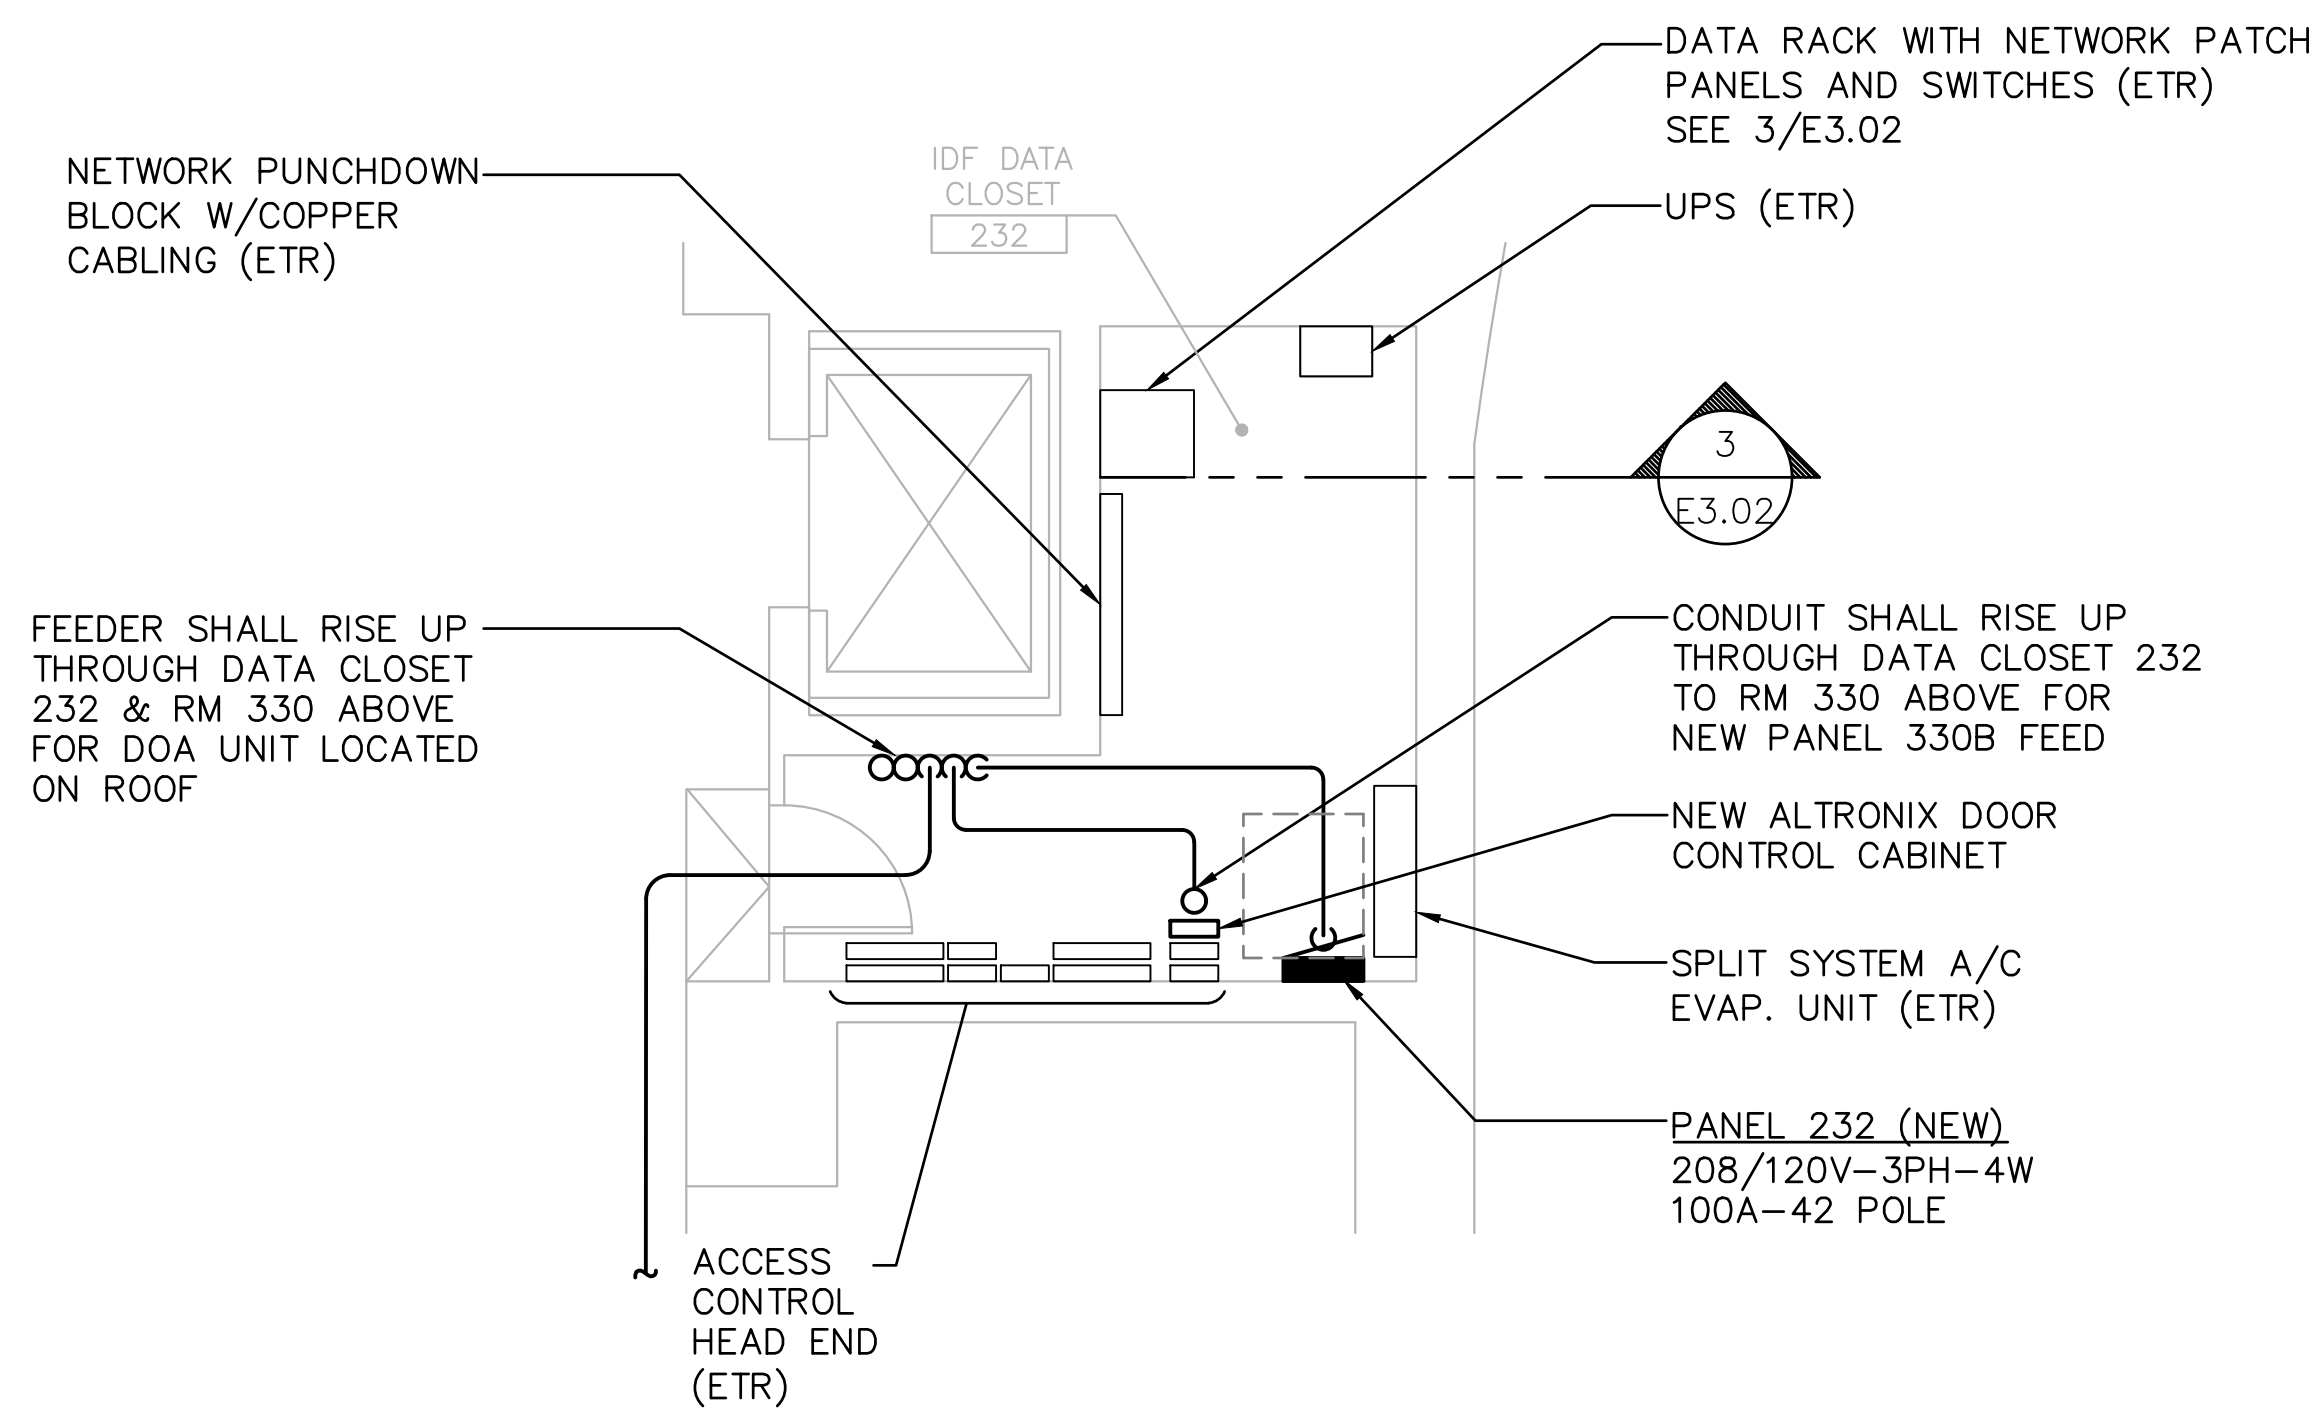


1 SECOND FLOOR IT ROOM 232 PART PLAN
SCALE: 1/4"=1'-0"

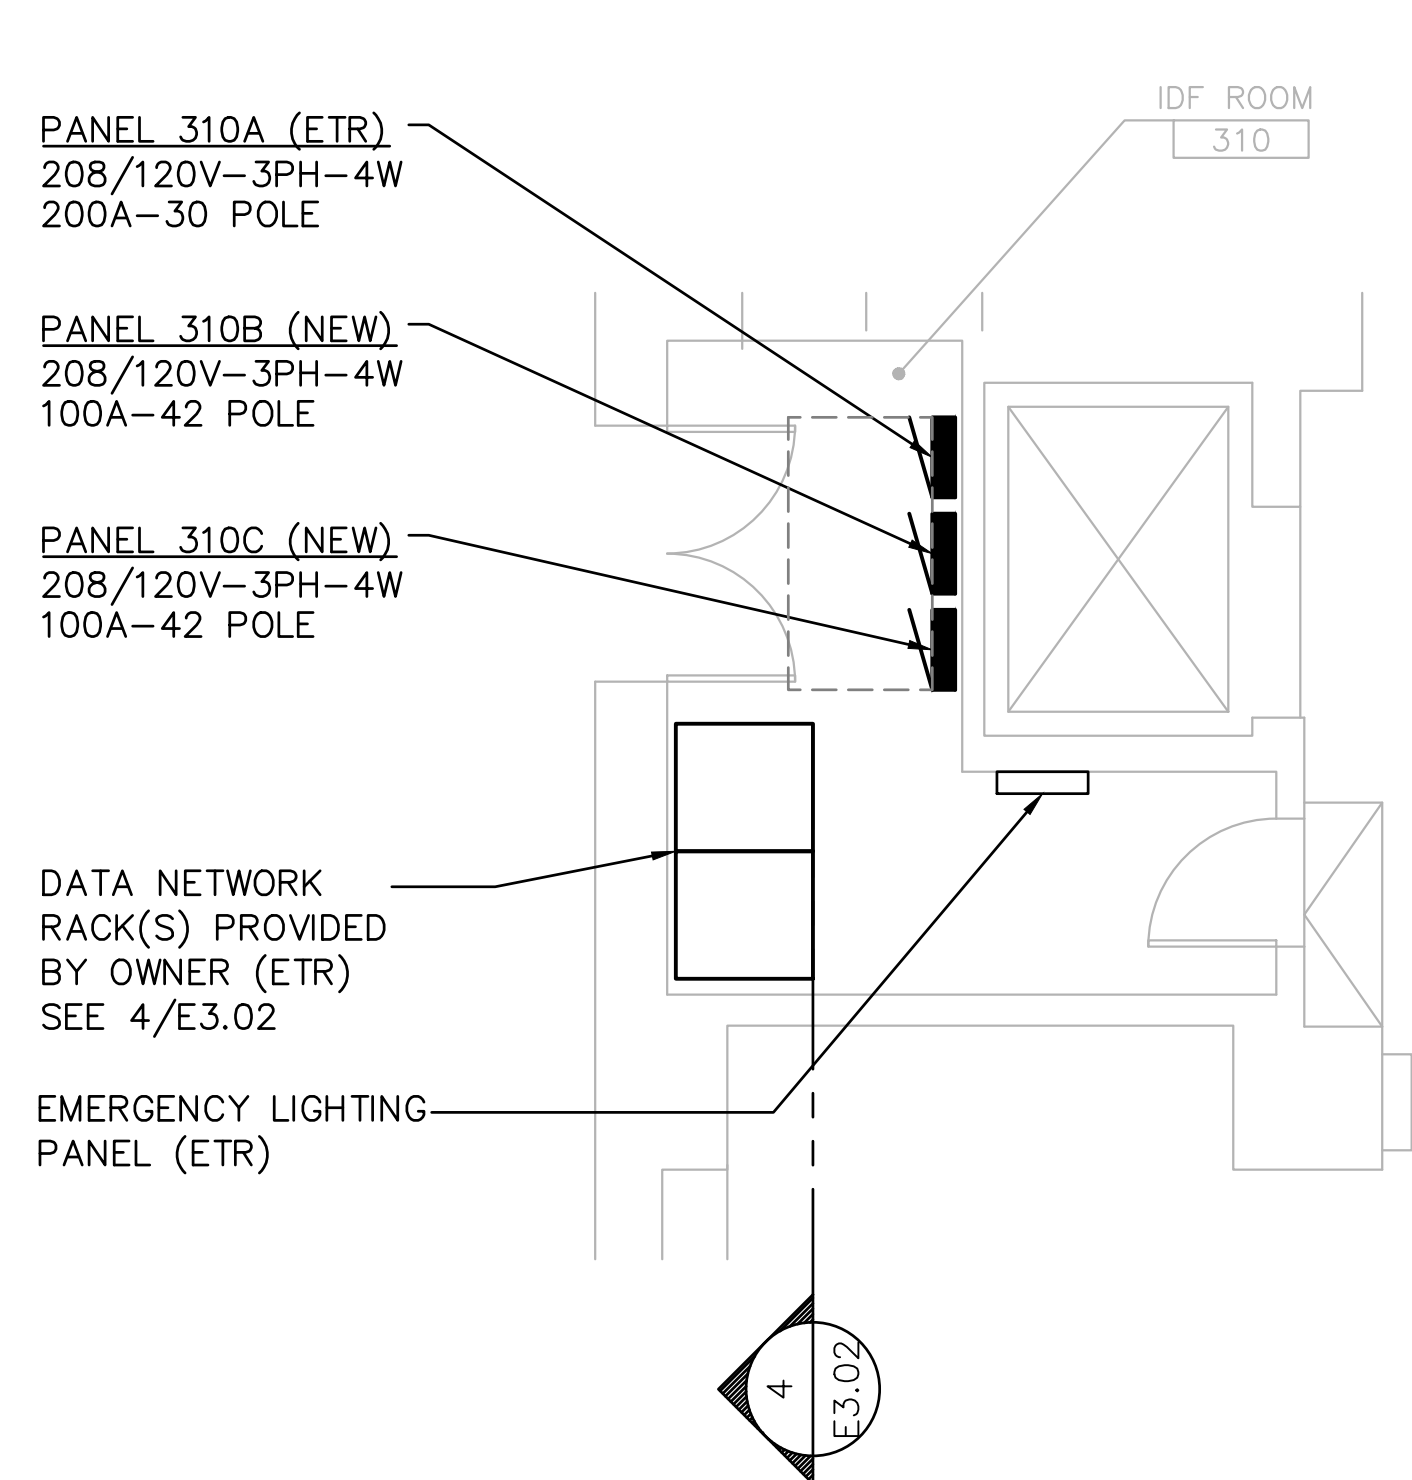


2 THIRD FLOOR IT ROOM 310 PART PLAN
SCALE: 1/4"=1'-0"

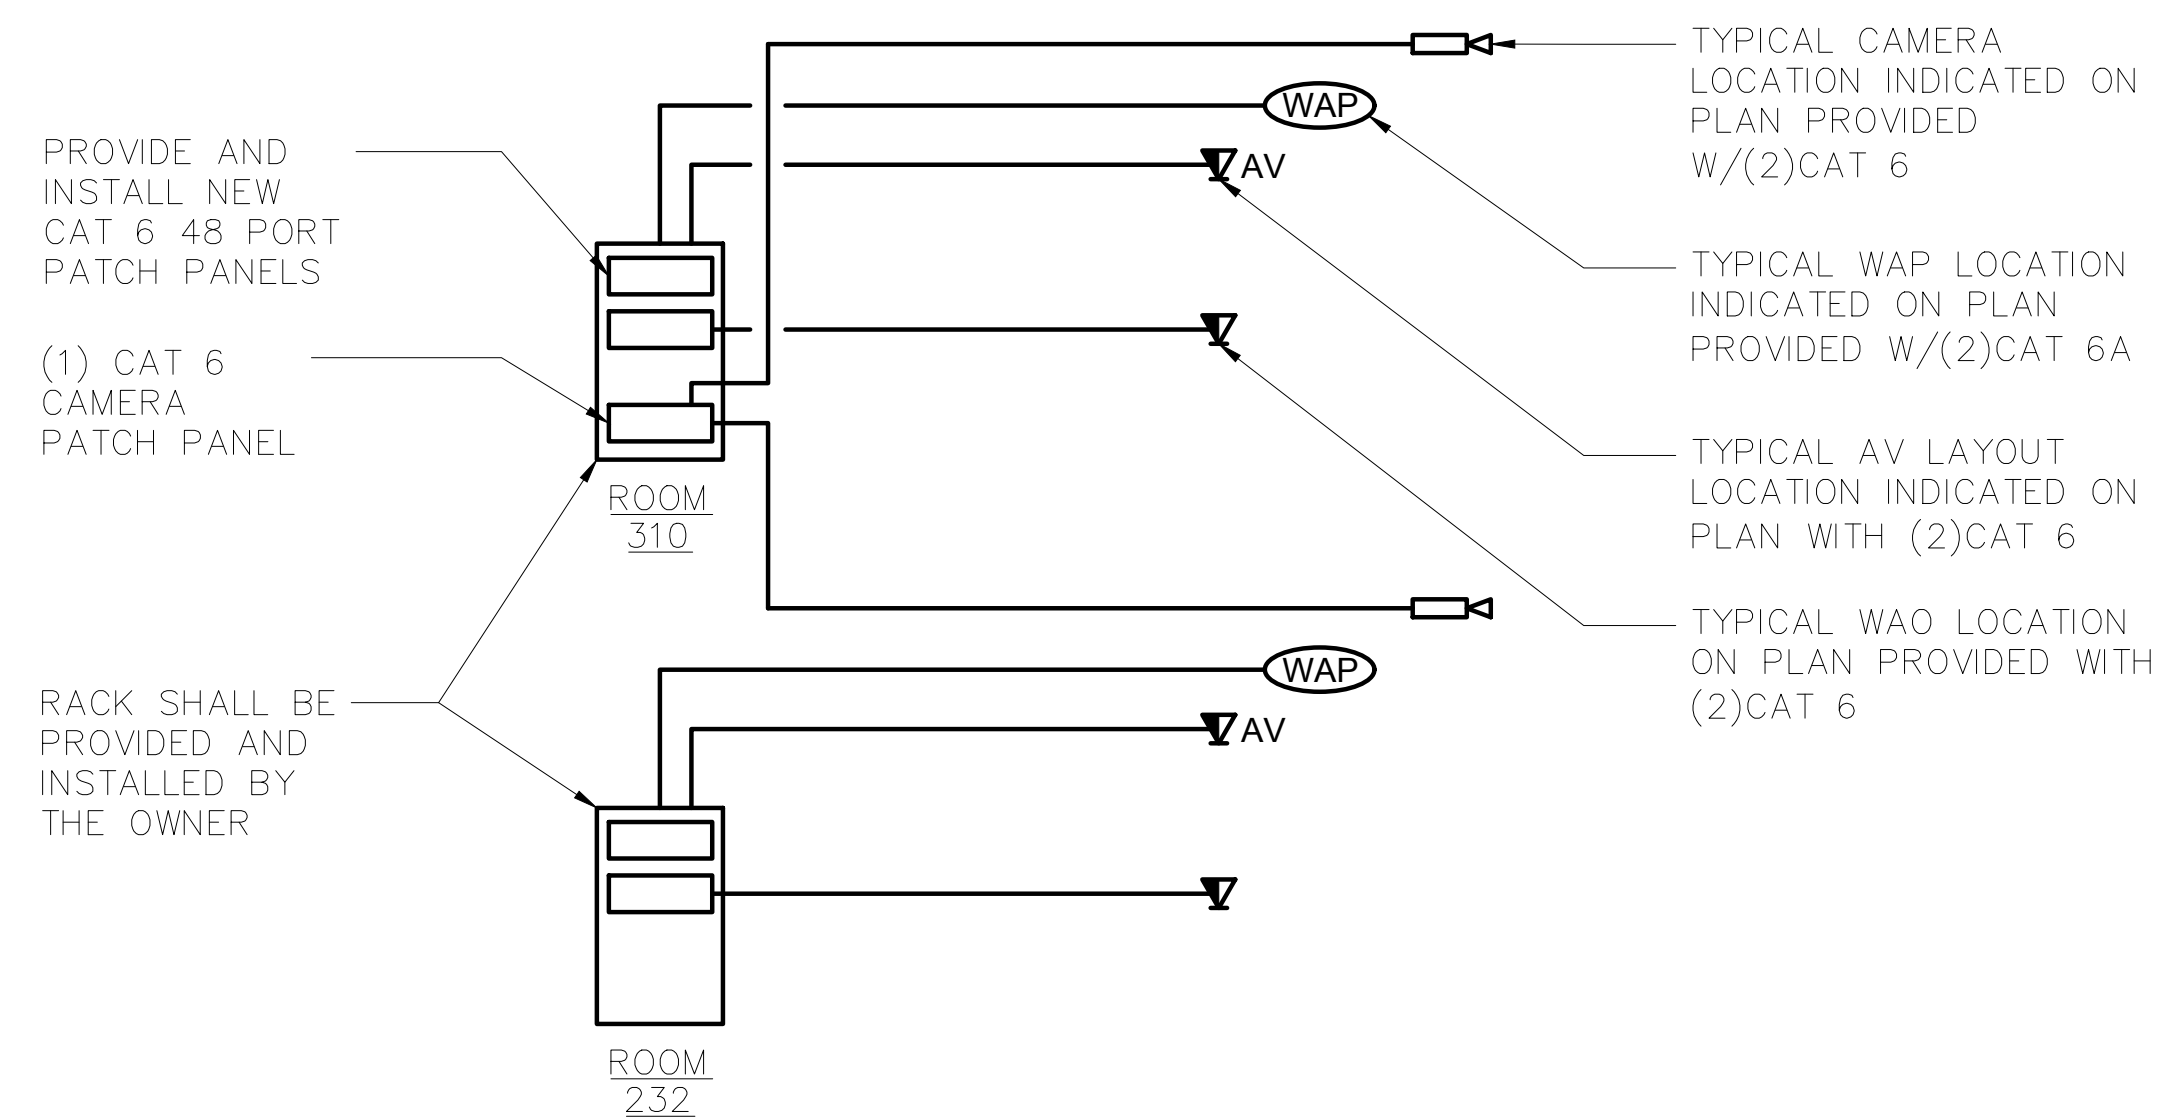

5 DATA NETWORK RISER DIAGRAM
SCALE:N.T.S.

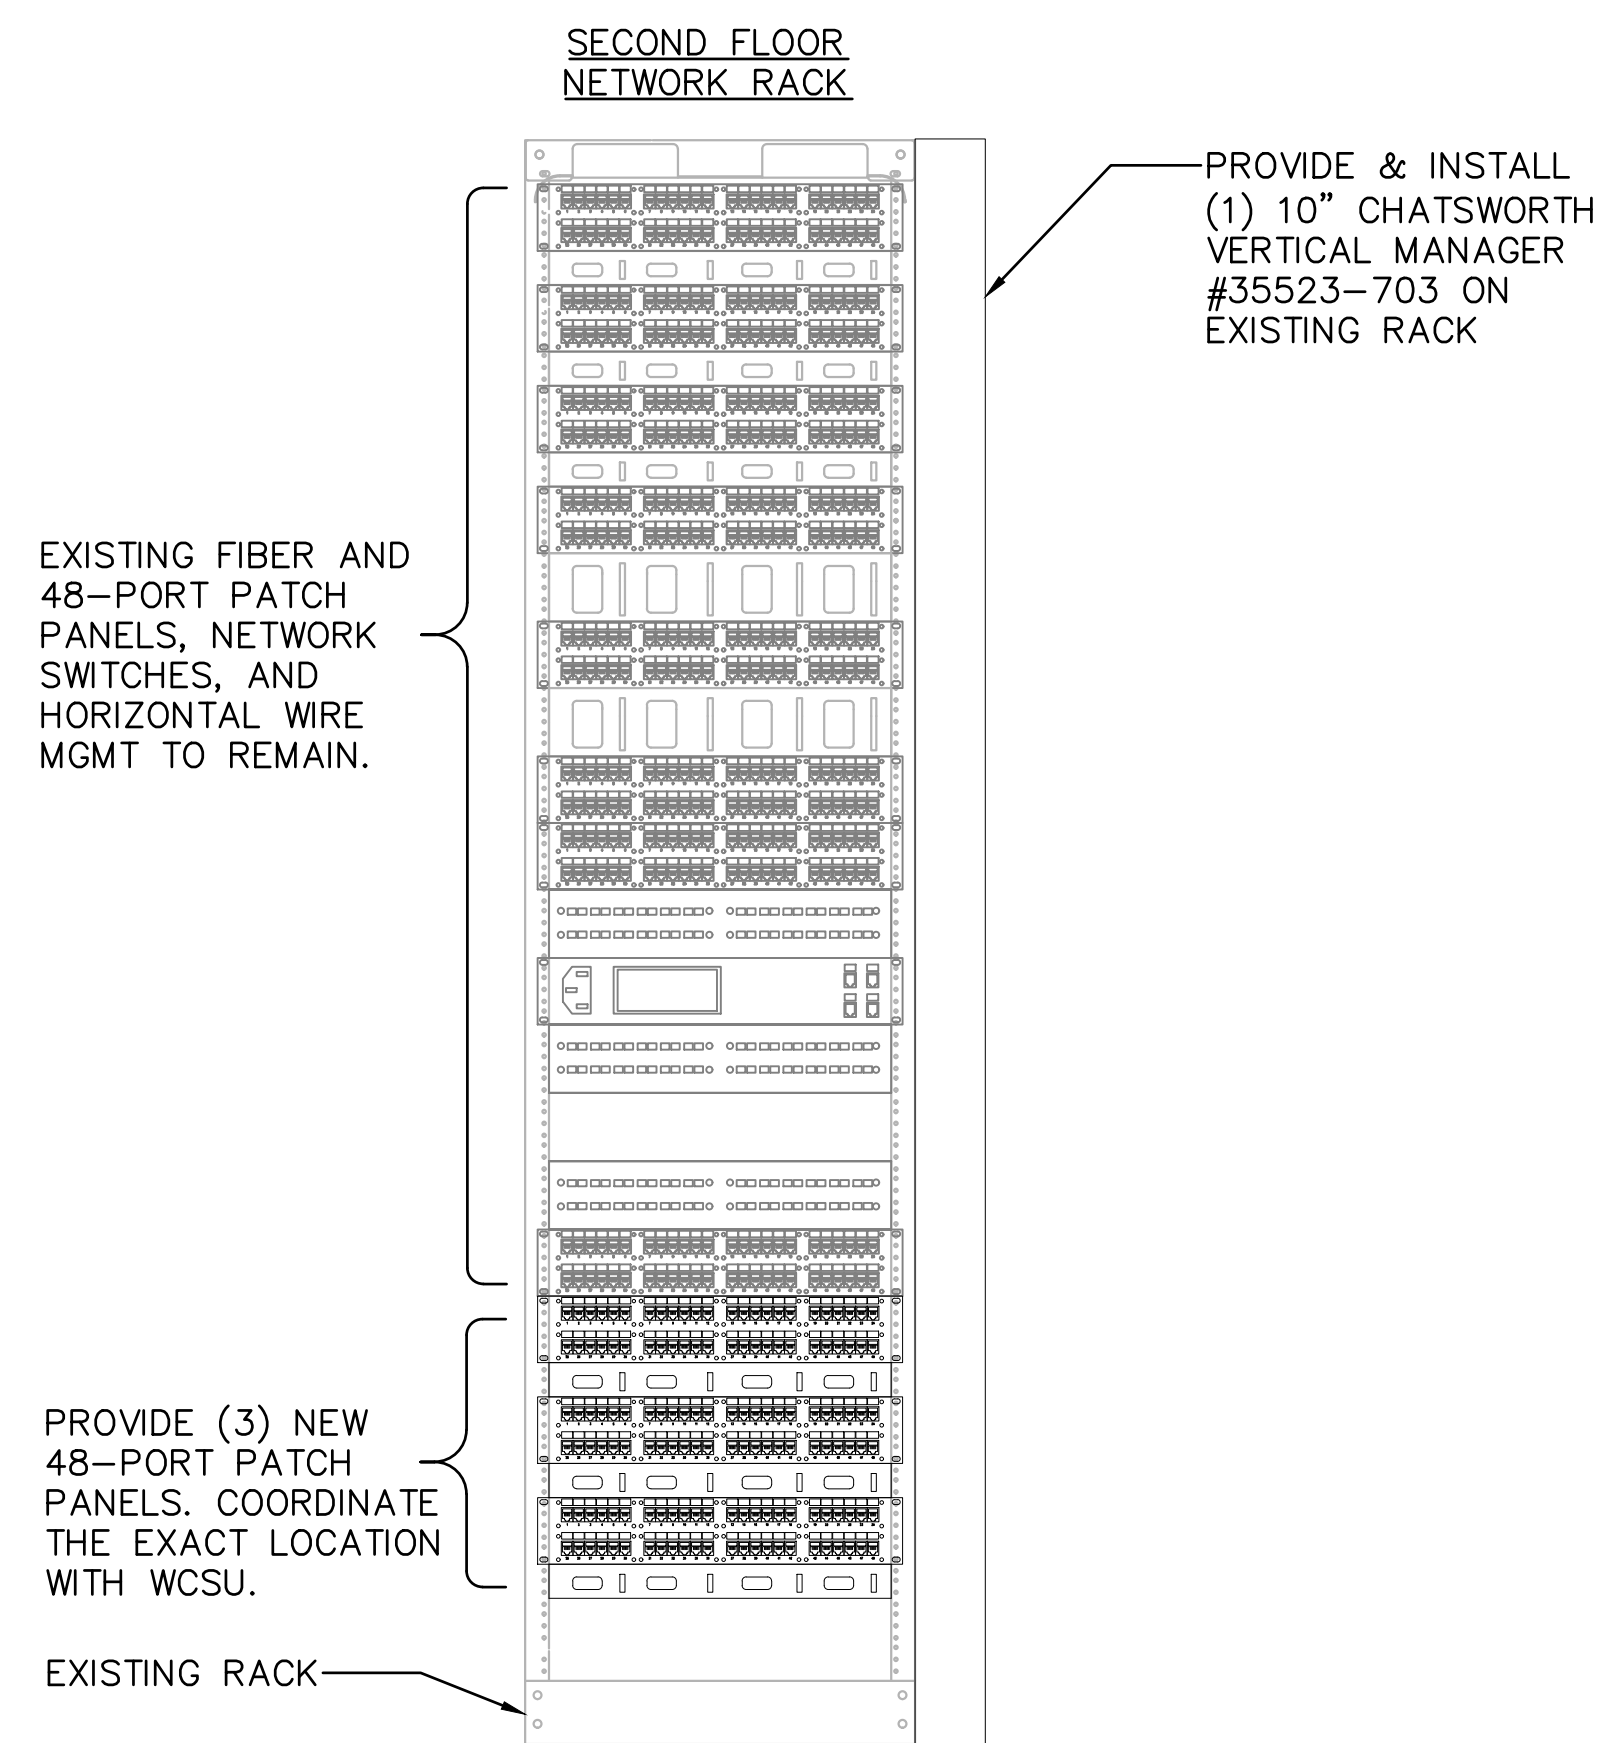

3 SECOND FLOOR IT ROOM 232 RACK FRONT ELEVATION
SCALE:N.T.S.

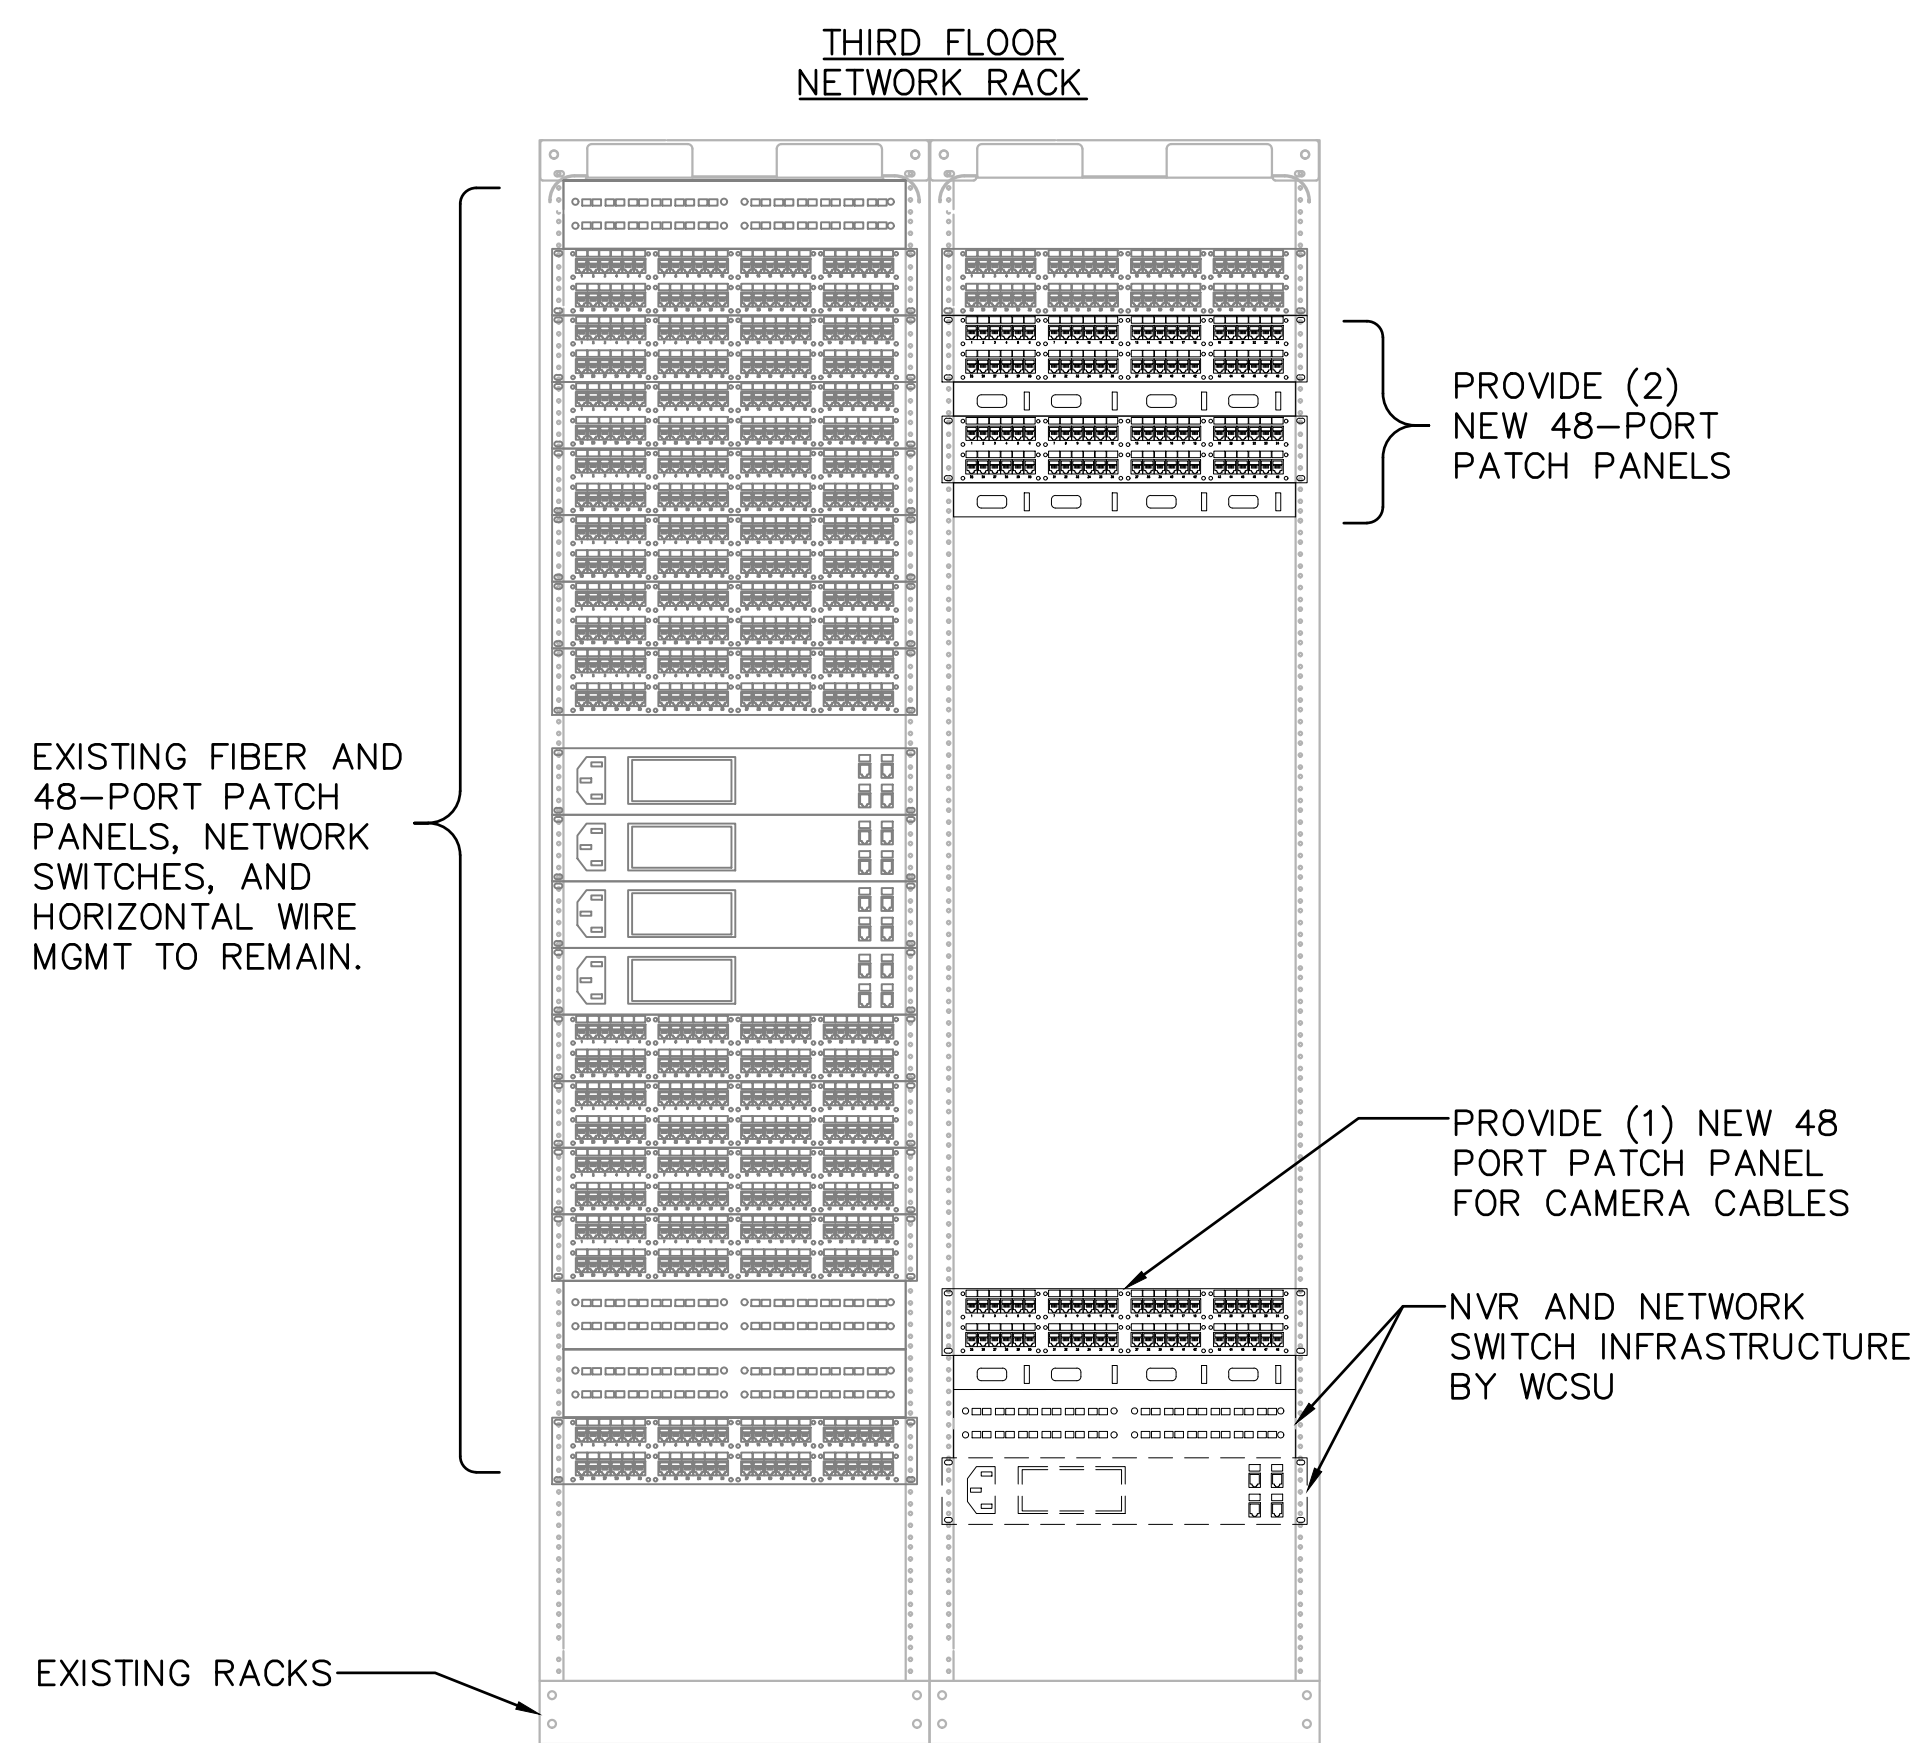

4 THIRD FLOOR IT ROOM 310 RACK FRONT ELEVATION
SCALE:N.T.S.

DATA NETWORK GENERAL NOTES:

- ALL DATA CABLING FOR WAO, AV, AND CAMERAS SHALL BE BLUE CAT 6 WITH BLUE JACKS.
- ALL DATA CABLING FOR WAP INSTALLATIONS SHALL BE WHITE CAT 6A WITH WHITE JACKS.
- ALL PATCH PANELS IDENTIFIED AS NEW SHALL BE PROVIDED AND INSTALLED UNDER THIS CONTRACT. PROVIDE HUBBELL #HP6-48AU ANGLED TYPE.
- PATCH PANELS SHALL BE ASSIGNED THE NEXT CORRESPONDING LETTER THAT IS APPROPRIATE FOR THE RACK IN WHICH THEY ARE INSTALLED. EXAMPLE, IF A RACK HAS PATCH PANELS A THROUGH D ANY ADDED PANELS SHALL BE E,F,G, ETC.
- ALL DATA JACKS SHALL BE BLUE WITH THE FOLLOWING LABELING CONVENTION ASSOCIATED WITH THE PATCH PANEL LETTER DESIGNATION:
PANEL A PORTS 1-48
DROP "A1", "A2"
PANEL B PORTS 1-48
DROP "B1", "B2"

| drawing title | | | STATE OF CONNECTICUT | |
|--------------------|----------|-------------------------------|--|-----------------------------|
| ELECTRICAL DETAILS | | | DEPARTMENT OF ADMINISTRATIVE SERVICES | |
| REVISIONS | | | | |
| mark | date | description | drawing prepared by | date |
| | 8/4/17 | SCHEMATIC DESIGN SUBMISSION | CONSULTING ENGINEERING SERVICES, INC. 811 MIDDLE STREET MIDDLETOWN, CT | 07/25/18 |
| | 1/15/18 | DESIGN DEVELOPMENT SUBMISSION | | AS NOTED |
| | 4/16/18 | CONSTRUCTION DOCUMENTS | | project |
| | 5/23/18 | | | WESTERN CT STATE UNIVERSITY |
| | 7/25/18 | | | WHITE HALL |
| | 12/11/19 | | DANBURY, CONNECTICUT | approved by SJM |
| CAD no. | | | project no. | drawing no. |
| | | | BI-RD-299 | E3.02 |

| Panel: PANEL 2-5 | | Location: 2ND FLOOR COORDOR | | Volts: 120/208V | A.I.C. Rating: ETR | | | | | |
|--|---------------------|-----------------------------|-------|---------------------|--------------------|---|------------|--------------------------|-----|--|
| Supply From: ETR | | Phases: 3 | | Mains Type: CU | | | | | | |
| Mounting: SURFACE | | Wires: 4 | | Mains Rating: 100 A | | | | | | |
| Enclosure: NEMA 1 | | | | MLO Rating: 100 A | | | | | | |
| CKT | Circuit Description | Trip | Poles | A | B | C | Poles/Trip | Circuit Description | CKT | |
| 1 | CORR LTG (EXT) | 20 | 1 | | | | 1 20 | CORR LTG (EXT) | 2 | |
| 3 | LTG 203 (EXT) | 20 | 1 | | | | 1 20 | AMPLIFIER 206 (EXT) | 4 | |
| 5 | LTG 203 (EXT) | 20 | 1 | | | | 1 20 | PROJ SCREEN 206 (EXT) | 6 | |
| 7 | RCPT 203 (EXT) | 20 | 1 | | | | 1 20 | RCPT 206 (EXT) | 8 | |
| 9 | RCPT 203/204 (EXT) | 20 | 1 | | | | 1 20 | RCPT 206/207/208 (EXT) | 10 | |
| 11 | LTG 204 (EXT) | 20 | 1 | | | | 1 20 | LTG 207 (EXT) | 12 | |
| 13 | RCPT 204 (EXT) | 20 | 1 | | | | 1 20 | LTG 208 (EXT) | 14 | |
| 15 | LTG 205 (EXT) | 20 | 1 | | | | 1 20 | LTG 208 (EXT) | 16 | |
| 17 | LTG 205 (EXT) | 20 | 1 | | | | 1 20 | CORR RCPT (EXT) | 18 | |
| 19 | LTG 206 (EXT) | 20 | 1 | | | | 1 20 | RCPT 204 (EXT) | 20 | |
| 21 | SPACE | - | - | | | | - | SPACE | 22 | |
| 23 | SPACE | - | - | | | | - | SPACE | 24 | |
| Phase Load (kVA): | | | | | | | | (EXT) = EXISTING CIRCUIT | | |
| Phase Amps: | | | | | | | | | | |
| Notes: EXISTING PANELBOARD TO REMAIN SEE NOTE 1 | | | | | | | | | | |

| Panel: PANEL 206 | | Location: PROJ. BOOTH 206 | | Volts: 120/208V | A.I.C. Rating: ETR | | | | | |
|--|---------------------|---------------------------|-------|---------------------|--------------------|---|------------|--------------------------|-----|--|
| Supply From: ETR | | Phases: 3 | | Mains Type: CU | | | | | | |
| Mounting: SURFACE | | Wires: 4 | | Mains Rating: 100 A | | | | | | |
| Enclosure: NEMA 1 | | | | MLO Rating: 100 A | | | | | | |
| CKT | Circuit Description | Trip | Poles | A | B | C | Poles/Trip | Circuit Description | CKT | |
| 1 | CEILING LTG (EXT) | 20 | 1 | | | | 2 20 | A/C RM 207 (EXT) | 2 | |
| 3 | SPARE | 20 | 1 | | | | - | - | 4 | |
| 5 | RCPT CKT (EXT) | 20 | 1 | | | | 1 20 | A/C RM 202 (EXT) | 6 | |
| 7 | RCPT CKT (EXT) | 20 | 1 | | | | 1 20 | A/C RM 208 (EXT) | 8 | |
| 9 | SPARE | 20 | 1 | | | | 2 20 | A/C RM 201 (EXT) | 10 | |
| 11 | SPARE | 20 | 1 | | | | - | - | 12 | |
| 13 | SPARE | 20 | 1 | | | | 1 20 | A/C CKT (EXT) | 14 | |
| 15 | SPARE | 20 | 1 | | | | 1 20 | A/C CKT (EXT) | 16 | |
| 17 | SPARE | 20 | 1 | | | | 1 20 | A/C CKT (EXT) | 18 | |
| 19 | SPARE | 20 | 1 | | | | 1 20 | A/C CKT (EXT) | 20 | |
| 21 | SPARE | 20 | 2 | | | | 1 30 | SPOT LIGHTS CKT (EXT) | 22 | |
| 23 | - | - | - | | | | 1 30 | SPARE | 24 | |
| Phase Load (kVA): | | | | | | | | (EXT) = EXISTING CIRCUIT | | |
| Phase Amps: | | | | | | | | | | |
| Notes: EXISTING PANELBOARD TO REMAIN SEE NOTE 1 | | | | | | | | | | |

| Panel: PANEL 213 | | Location: STORAGE 213 | | Volts: 120/208V | A.I.C. Rating: 10K | | | | | |
|-------------------------------|------------------------|-----------------------|-------|--------------------|--------------------|------|------------|---------------------|-----|--|
| Supply From: MAIN SWITCHBOARD | | Phases: 3 | | Mains Type: CU | | | | | | |
| Mounting: SURFACE | | Wires: 4 | | Mains Rating: 100A | | | | | | |
| Enclosure: NEMA 1 | | | | MCB Rating: 100A | | | | | | |
| CKT | Circuit Description | Trip | Poles | A | B | C | Poles/Trip | Circuit Description | CKT | |
| 1 | CLASSROOM 208 RCPT | 20 | 1 | 0.90 | 0.79 | | 2 15 | VRV-A,B,D | 2 | |
| 3 | CLASSROOM 208 RCPT | 20 | 1 | | 0.18 | 0.79 | - | - | 4 | |
| 5 | CLASSROOM 207 RCPT | 20 | 1 | | | 1.08 | 2 15 | VRV-Gx2 | 6 | |
| 7 | CLASSROOM 207 RCPT | 20 | 1 | 0.36 | 0.04 | | - | - | 8 | |
| 9 | WOMEN BR 215 RCPT | 20 | 1 | | 0.18 | 0.26 | 2 15 | BC-1,1A | 10 | |
| 11 | STORAGE 218 RCPT | 20 | 1 | | | 0.18 | 2 15 | - | 12 | |
| 13 | OFFICE 222 RCPT | 20 | 1 | 0.90 | | | 1 20 | SPARE | 14 | |
| 15 | OFFICE 221A RCPT | 20 | 1 | | 1.08 | | 1 20 | SPARE | 16 | |
| 17 | OFFICE 221 RCPT | 20 | 1 | | | 0.72 | 1 20 | SPARE | 18 | |
| 19 | OFFICE 221A, 222 LTG | 20 | 1 | 0.56 | | | 1 20 | SPARE | 20 | |
| 21 | CLASSROOM 206, 207 LTG | 20 | 1 | | 0.81 | | 1 20 | SPARE | 22 | |
| 23 | CORRIDOR 298 RCPT | 20 | 1 | | | 0.36 | 1 20 | SPARE | 24 | |
| 25 | OFFICE 221 RCPT | 20 | 1 | 0.72 | | | 1 20 | SPARE | 26 | |
| 27 | OFFICE 221 RCPT | 20 | 1 | | 0.72 | | 1 20 | SPARE | 28 | |
| 29 | SPARE | 20 | 1 | | | | 1 20 | SPARE | 30 | |
| 31 | SPARE | 20 | 1 | | | | 1 20 | SPARE | 32 | |
| 33 | SPARE | 20 | 1 | | | | 1 20 | SPARE | 34 | |
| 35 | SPARE | 20 | 1 | | | | 1 20 | SPARE | 36 | |
| 37 | SPARE | 20 | 1 | | | | 1 20 | SPARE | 38 | |
| 39 | SPARE | 20 | 1 | | | | 1 20 | SPARE | 40 | |
| 41 | SPARE | 20 | 1 | | | | 1 20 | SPARE | 42 | |
| Phase Load (kVA): | | | | 4.27 | 4.01 | 2.64 | | | | |
| Phase Amps: | | | | 35.6 A | 33.4 A | 22 A | | | | |
| Notes: NEW PANELBOARD | | | | | | | | | | |

| Panel: PANEL 220 | | Location: STORAGE 220-4 | | Volts: 120/208V | A.I.C. Rating: 10K | | | | | |
|-------------------------------|---------------------|-------------------------|-------|--------------------|--------------------|--------|------------|----------------------|----------------------|----|
| Supply From: MAIN SWITCHBOARD | | Phases: 3 | | Mains Type: CU | | | | | | |
| Mounting: SURFACE | | Wires: 4 | | Mains Rating: 100A | | | | | | |
| Enclosure: NEMA 1 | | | | MCB Rating: 100A | | | | | | |
| CKT | Circuit Description | Trip | Poles | A | B | C | Poles/Trip | Circuit Description | CKT | |
| 1 | OFFICE 220-9 | 20 | 1 | 1.08 | 0.52 | | 2 15 | VRV-Gx2, Hx2 | 2 | |
| 3 | OFFICE 220-8 | 20 | 1 | | 1.08 | 0.52 | - | - | 4 | |
| 5 | OFFICE 220-7 | 20 | 1 | | | 1.08 | 1 20 | SUITE 220 COOR. RCPT | 6 | |
| 7 | OFFICE 220-5 | 20 | 1 | 1.08 | 0.98 | | 1 20 | CORRIDOR 220 LTG | 8 | |
| 9 | OFFICE 220-3 | 20 | 1 | | 1.08 | 0.81 | 1 20 | OFFICE SUITE 220 LTG | 10 | |
| 11 | OFFICE 220-2 | 20 | 1 | | | 0.81 | 0.00 | 1 20 | OFFICE SUITE 220 LTG | 12 |
| 13 | OFFICE 220-1 | 20 | 1 | 1.08 | 0.00 | | 1 20 | SPARE | 14 | |
| 15 | OFFICE 220-20 | 20 | 1 | | 1.08 | 0.00 | 1 20 | SPARE | 16 | |
| 17 | OFFICE 220-21 | 20 | 1 | | | 1.08 | 0.00 | 1 20 | SPARE | 18 |
| 19 | OFFICE 220-22 | 20 | 1 | 1.08 | 0.00 | | 1 20 | SPARE | 20 | |
| 21 | OFFICE 220-23 | 20 | 1 | | 1.08 | 0.00 | 1 20 | SPARE | 22 | |
| 23 | OFFICE 220-24 | 20 | 1 | | | 1.08 | 0.00 | 1 20 | SPARE | 24 |
| 25 | OFFICE 220-25 | 20 | 1 | 1.08 | 0.00 | | 1 20 | SPARE | 26 | |
| 27 | OFFICE 220-19 | 20 | 1 | | 1.08 | 0.00 | 1 20 | SPARE | 28 | |
| 29 | OFFICE 220-18 | 20 | 1 | | | 1.08 | 0.00 | 1 20 | SPARE | 30 |
| 31 | OFFICE 220-17 | 20 | 1 | 1.08 | 0.00 | | 1 20 | SPARE | 32 | |
| 33 | OFFICE 220-16 | 20 | 1 | | 1.08 | 0.00 | 1 20 | SPARE | 34 | |
| 35 | OFFICE 220-15 | 20 | 1 | | | 1.08 | 0.00 | 1 20 | SPARE | 36 |
| 37 | OFFICE 220-12 | 20 | 1 | 1.08 | 0.00 | | 1 20 | SPARE | 38 | |
| 39 | OFFICE 220-11 | 20 | 1 | | 1.08 | 0.00 | 1 20 | SPARE | 40 | |
| 41 | OFFICE 220-10 | 20 | 1 | | | 1.08 | 0.00 | 1 20 | SPARE | 42 |
| Phase Load (kVA): | | | | 9.06 | 8.89 | 9.09 | | | | |
| Phase Amps: | | | | 75.5 A | 74.1 A | 75.8 A | | | | |
| Notes: NEW PANELBOARD | | | | | | | | | | |

| Panel: PANEL 232 | | Location: IDF CLOSET 232 | | Volts: 120/208V | A.I.C. Rating: 10K | | | | | |
|-------------------------------|----------------------|--------------------------|-------|--------------------|--------------------|--------|------------|----------------------|--------------------|----|
| Supply From: MAIN SWITCHBOARD | | Phases: 3 | | Mains Type: CU | | | | | | |
| Mounting: SURFACE | | Wires: 4 | | Mains Rating: 100A | | | | | | |
| Enclosure: NEMA 1 | | | | MCB Rating: 100A | | | | | | |
| CKT | Circuit Description | Trip | Poles | A | B | C | Poles/Trip | Circuit Description | CKT | |
| 1 | CLASSROOM 201 RCPT | 20 | 1 | 0.36 | 0.48 | | 2 15 | VRV-Bx2,G | 2 | |
| 3 | CLASSROOM 201 RCPT | 20 | 1 | | 1.08 | 0.48 | - | - | 4 | |
| 5 | CLASSROOM 202 RCPT | 20 | 1 | | | 0.36 | 0.60 | 2 15 | VRV-A,E,F | |
| 7 | CLASSROOM 202 RCPT | 20 | 1 | 1.08 | 0.60 | | - | - | 8 | |
| 9 | CLASSROOM 204 RCPT | 20 | 1 | | 0.36 | 0.75 | 2 15 | VRV-A,B,C,G | 10 | |
| 11 | CLASSROOM 204 RCPT | 20 | 1 | | | 0.90 | 0.75 | - | 12 | |
| 13 | CLASSROOM 231 RCPT | 20 | 1 | 0.90 | 0.14 | | 2 15 | BC-2 | 14 | |
| 15 | CLASSROOM 231 RCPT | 20 | 1 | | 0.36 | 0.14 | - | - | 16 | |
| 17 | NURSING LAB 228 RCPT | 20 | 1 | | | 0.36 | 1.26 | 1 20 | OFFICE 223 RCPT | |
| 19 | NURSING LAB 228 RCPT | 20 | 1 | 0.90 | 0.90 | | 1 20 | NURSING LAB 224 RCPT | 20 | |
| 21 | NURSING LAB 228 RCPT | 20 | 1 | | 0.90 | 0.50 | 1 20 | TOLOSCOPE 224 RCPT | 22 | |
| 23 | NURSING LAB 228 RCPT | 20 | 1 | | | 0.36 | 0.50 | 1 20 | TOLOSCOPE 224 RCPT | 24 |
| 25 | MEN BR 230 RCPT | 20 | 1 | 0.18 | 0.50 | | 1 20 | TOLOSCOPE 226 RCPT | 26 | |
| 27 | NURSING LAB 225 RCPT | 20 | 1 | | 0.36 | 0.00 | 1 20 | SPARE | 28 | |
| 29 | NURSING LAB 225 RCPT | 20 | 1 | | | 0.90 | 0.00 | 1 20 | SPARE | 30 |
| 31 | NURSING LAB 224 RCP | 20 | 1 | 1.08 | 0.00 | | 1 20 | SPARE | 32 | |
| 33 | STORAGE 227 RCPT | 20 | 1 | | 0.18 | 0.00 | 1 20 | SPARE | 34 | |
| 35 | CORRIDOR 298B RCPT | 20 | 1 | | | 0.00 | 0.00 | 1 20 | SPARE | 36 |
| 37 | 2ND FLOOR LTG | 20 | 1 | 0.84 | 0.00 | | 1 20 | SPARE | 38 | |
| 39 | 2ND FLOOR LTG | 20 | 1 | | 1.16 | 0.00 | 1 20 | SPARE | 40 | |
| 41 | RM 201,202,204 LTG | 20 | 1 | | | 0.98 | 0.00 | 1 20 | SPARE | 42 |
| Phase Load (kVA): | | | | 7.95 | 6.26 | 6.97 | | | | |
| Phase Amps: | | | | 66.3 A | 52.2 A | 58.1 A | | | | |
| Notes: NEW PANELBOARD | | | | | | | | | | |

| Panel: PANEL 301 | | Location: ROOM 301 | | Volts: 208V | A.I.C. Rating: ETR | | | | | |
|--|--------------------------|--------------------|-------|---------------------|--------------------|---|------------|----------------------|-----|--|
| Supply From: ETR | | Phases: 1 | | Mains Type: ETR | | | | | | |
| Mounting: RECESSED | | Wires: 3 | | Mains Rating: 125 A | | | | | | |
| Enclosure: NEMA 1 | | | | MLO Rating: 125 A | | | | | | |
| CKT | Circuit Description | Trip | Poles | A | B | C | Poles/Trip | Circuit Description | CKT | |
| 1 | FLUSH CARTS CKT (EXT) | 20 | 1 | | | | 1 20 | PLUGMOLD CKT (EXT) | 2 | |
| 3 | LTG CKT (EXT) | 20 | 1 | | | | 1 20 | PLUGMOLD CKT (EXT) | 4 | |
| 5 | WALL RCPT #1 (EXT) | 20 | 1 | | | | 1 20 | PLUGMOLD CKT (EXT) | 6 | |
| 7 | WALL RCPT #3 (EXT) | 20 | 1 | | | | 1 20 | PLUGMOLD CKT (EXT) | 8 | |
| 9 | WALL RCPT CKT (EXT) | 20 | 1 | | | | 1 20 | PROJECTOR RCPT (EXT) | 10 | |
| 11 | SPARE | 20 | 1 | | | | 1 20 | ATU RCPT (EXT) | 12 | |
| 13 | WALL RCPT #7 (EXT) | 20 | 1 | | | | 1 20 | SCREEN CKT (EXT) | 14 | |
| 15 | WALL/FLOOR RCPT #9 (EXT) | 20 | 1 | | | | 1 20 | PLUGMOLD CKT (EXT) | 16 | |
| 17 | WINDOW AC RCPT (EXT) | 20 | 1 | | | | 1 20 | ALARM RCPT (EXT) | 18 | |
| 19 | SPACE | - | - | | | | - | - | 20 | |
| Phase Load (kVA): | | | | 0.00 | 0.00 | | | | | |
| Phase Amps: | | | | 0 A | 0 A | | | | | |
| Notes: EXISTING PANELBOARD TO REMAIN SEE NOTE 1 | | | | | | | | | | |

| Panel: PANEL 302 | | Location: ROOM 302 | | Volts: 208V | A.I.C. Rating: ETR | | | | |
|--------------------|---------------------|--------------------|-------|-------------------|--------------------|---|------------|---------------------|-----|
| Supply From: ETR | | Phases: 1 | | Mains Type: ETR | | | | | |
| Mounting: RECESSED | | Wires: 3 | | Mains Rating: ETR | | | | | |
| Enclosure: NEMA 1 | | | | MLO Rating: ETR | | | | | |
| CKT | Circuit Description | Trip | Poles | A | B | C | Poles/Trip | Circuit Description | CKT |
| 1 | COMPUTER RCPT (EXT) | 20 | 1 | | | | 1 20 | COMPUTER RCPT (EXT) | 2 |
| 3 | COMPUTER RCPT (EXT) | 20 | 1 | | | | 1 20 | COMPUTER RCPT (EXT) | 4 |

| Panel: PANEL 330A | | | | | | | | | | | | | | |
|---|------------------------|------|-----------------|--------|------|---------------------|-------|--------|----------------------|------------------------|---------------------|----|--|--|
| Location: ROOM 330 | | | Volts: 120/208V | | | A.I.C. Rating: ETR | | | | | | | | |
| Supply From: ETR | | | Phases: 3 | | | Mains Type: CU | | | | | | | | |
| Mounting: SURFACE | | | Wires: 4 | | | Mains Rating: 100 A | | | | | | | | |
| Enclosure: NEMA 1 | | | | | | MLO Rating: 100 A | | | | | | | | |
| CKT | Circuit Description | Trip | Poles | A | B | C | Poles | Trip | Circuit Description | CKT | | | | |
| 1 | SATELLITE RACK (EXT) | 20 | 1 | 0.75 | 0.75 | | 1 | 20 | SATELLITE RACK (EXT) | 2 | | | | |
| 3 | SATELLITE RACK (EXT) | 20 | 1 | | | 0.75 | 0.75 | 1 | 20 | SATELLITE RACK (EXT) | 4 | | | |
| 5 | SPARE (EXT) | 20 | 2 | | | | | 1 | 20 | CONDENSATE PUMP (EXT) | 6 | | | |
| 7 | | 20 | 2 | 0.00 | 0.36 | | | 1 | 20 | 325B WIREMOLD (EXT) | 8 | | | |
| 9 | SATELLITE RM A/C (EXT) | 20 | 2 | | 1.02 | 0.36 | | 1 | 20 | 325B WIREMOLD (EXT) | 10 | | | |
| 11 | | 20 | 1 | | | | 1.02 | 0.72 | 1 | 20 | 325B WIREMOLD (EXT) | 12 | | |
| 13 | SPARE (EXT) | 20 | 1 | 0.00 | 0.72 | | | 1 | 20 | 325B WIREMOLD (EXT) | 14 | | | |
| 15 | SPARE (EXT) | 20 | 1 | | | 0.00 | 0.36 | 1 | 20 | 325B WIREMOLD (EXT) | 16 | | | |
| 17 | SPARE (EXT) | 20 | 1 | | | | | 1 | 20 | 325B CLOSET RCPT (EXT) | 18 | | | |
| 19 | SPARE (EXT) | 20 | 1 | 0.00 | 0.00 | | | 1 | 20 | SPARE (EXT) | 20 | | | |
| 21 | SPARE (EXT) | 20 | 1 | | | 0.00 | 0.00 | 1 | 20 | SPARE (EXT) | 22 | | | |
| 23 | SPARE (EXT) | 20 | 1 | | | | | 1 | 20 | SPARE (EXT) | 24 | | | |
| 25 | COMPUTER LAB 316 RCPT | 20 | 1 | 0.75 | 0.75 | | | 1 | 20 | COMPUTER LAB 316 RCPT | 26 | | | |
| 27 | COMPUTER LAB 316 RCPT | 20 | 1 | | | 0.75 | 0.75 | 1 | 20 | COMPUTER LAB 316 RCPT | 28 | | | |
| 29 | COMPUTER LAB 316 RCPT | 20 | 1 | | | | | 1 | 20 | COMPUTER LAB 316 RCPT | 30 | | | |
| 31 | COMPUTER LAB 316 RCPT | 20 | 1 | 0.75 | 0.72 | | | 1 | 20 | COMPUTER LAB 316 RCPT | 32 | | | |
| 33 | COMPUTER LAB 316 RCPT | 20 | 1 | | | 0.72 | 0.72 | 1 | 20 | CONF. RM. 322A RCPT | 34 | | | |
| 35 | CONF. RM. 324 RCPT | 20 | 1 | | | | | 1 | 20 | CONF. RM. 322A RCPT | 36 | | | |
| 37 | CONF. RM. 324 RCPT | 20 | 1 | 0.72 | - | | | - | - | SPARE | 38 | | | |
| 39 | CONF. RM. 324 RCPT | 20 | 1 | | | 0.72 | 0.36 | - | - | COMP. STATION 316 RCPT | 40 | | | |
| 41 | SPACE | 20 | 1 | | | | | 1 | 20 | COMP. STATION 316 RCPT | 42 | | | |
| Phase Load (kVA): | | | | 6.27 | | 7.26 | | 6.90 | | | | | | |
| Phase Amps: | | | | 52.3 A | | 60.5 A | | 55.7 A | | | | | | |
| Notes: EXISTING PANELBOARD TO REMAIN | | | | | | | | | | | | | | |
| INSTALL NEW BREAKERS IN EXISTING SPACES 25 THROUGH 37 | | | | | | | | | | | | | | |

| Panel: PANEL 330B (Section 1) | | | | | | | | | | | | | | |
|--------------------------------------|---------------------|------|-----------------|---------|------|---------------------|-------|---------|---------------------|---------------|----|---------------|--|--|
| Location: ROOM 330 | | | Volts: 120/208V | | | A.I.C. Rating: 10K | | | | | | | | |
| Supply From: MAIN SWITCHBOARD | | | Phases: 3 | | | Mains Type: CU | | | | | | | | |
| Mounting: SURFACE | | | Wires: 4 | | | Mains Rating: 225 A | | | | | | | | |
| Enclosure: NEMA 1 | | | | | | MCB Rating: 225 A | | | | | | | | |
| CKT | Circuit Description | Trip | Poles | A | B | C | Poles | Trip | Circuit Description | CKT | | | | |
| 1 | CU-2 [MODULE 1] | 60 | 3 | 5.09 | 0.36 | | | 2 | 15 | VRV-A, G, Hx2 | 2 | | | |
| 3 | | - | - | | | 5.09 | 0.36 | | | - | 4 | | | |
| 5 | | - | - | | | | | 5.09 | 0.25 | 2 | 15 | VRV-E, Gx8, H | | |
| 7 | CU-2 [MODULE 2] | 60 | 3 | 5.09 | 0.25 | | | | | - | 8 | | | |
| 9 | | - | - | | | 5.09 | 0.58 | | | 2 | 15 | VRV-A, D, G | | |
| 11 | | - | - | | | | | | | - | 12 | | | |
| 13 | CU-3 [MODULE 1] | 40 | 3 | 3.17 | 0.14 | | | | | 2 | 15 | BC-3 | | |
| 15 | | - | - | | | 3.17 | 0.14 | | | - | 16 | | | |
| 17 | | - | - | | | | | 3.17 | 0.14 | 2 | 15 | SUB-BC | | |
| 19 | CU-3 [MODULE 2] | 30 | 3 | 2.30 | 0.14 | | | | | - | 20 | | | |
| 21 | | - | - | | | 2.30 | 0.00 | | | 1 | 20 | SPARE | | |
| 23 | | - | - | | | | | 2.30 | 0.00 | 1 | 20 | SPARE | | |
| 25 | SPARE | 20 | 1 | 0.00 | 0.00 | | | | | 1 | 20 | SPARE | | |
| 27 | SPARE | 20 | 1 | | | 0.00 | 0.00 | | | 1 | 20 | SPARE | | |
| 29 | SPARE | 20 | 1 | | | 0.00 | 0.00 | | | 1 | 20 | SPARE | | |
| 31 | SPARE | 20 | 1 | 0.00 | 0.00 | | | | | 1 | 20 | SPARE | | |
| 33 | SPARE | 20 | 1 | | | 0.00 | 0.00 | | | 1 | 20 | SPARE | | |
| 35 | SPARE | 20 | 1 | | | | | 0.00 | 0.00 | 1 | 20 | SPARE | | |
| 37 | SPARE | 20 | 1 | 0.00 | 0.00 | | | | | 1 | 20 | SPARE | | |
| 39 | SPARE | 20 | 1 | | | 0.00 | 0.00 | | | 1 | 20 | SPARE | | |
| 41 | SPARE | 20 | 1 | | | | | 0.00 | 0.00 | 1 | 20 | SPARE | | |
| Phase Load (kVA): | | | | 19.69 | | 21.51 | | 20.58 | | | | | | |
| Phase Amps: | | | | 164.1 A | | 179.3 A | | 171.5 A | | | | | | |
| Notes: NEW PANELBOARD | | | | | | | | | | | | | | |

| | | | | | | | | | | | | | |
|--------------------------------------|------------------|---------------------|---|---------|-------|---------|------|---------|-------|------|---------------------|-----------------------|----|
| Panel: PANEL 330B (Section 2) | | | | | | | | | | | | | |
| CKT | | Circuit Description | | Trip | Poles | A | B | C | Poles | Trip | Circuit Description | CKT | |
| 43 | ROOF MAINT. RCPT | 20 | 1 | 0.36 | 0.00 | | | | | 1 | 20 | SPARE | 44 |
| 45 | ROOF MAINT. RCPT | 20 | 1 | | | | 0.18 | 0.00 | | 1 | 20 | SPARE | 46 |
| 47 | THIRD FLOOR LTG | 20 | 1 | | | | | 0.84 | 0.00 | 1 | 20 | SPARE | 48 |
| 49 | THIRD FLOOR LTG | 20 | 1 | 0.50 | 0.18 | | | | | 1 | 20 | MEN 328 RCPT | 50 |
| 51 | THIRD FLOOR LTG | 20 | 1 | | | | 1.19 | 0.72 | | 1 | 20 | OFFICE 325A RCPT | 52 |
| 53 | THIRD FLOOR LTG | 20 | 1 | | | | | 0.43 | 0.72 | 1 | 20 | OFFICE 325B RCPT | 54 |
| 55 | THIRD FLOOR LTG | 20 | 1 | 0.32 | 0.36 | | | | | 1 | 20 | OFFICE 325C RCPT | 56 |
| 57 | THIRD FLOOR LTG | 20 | 1 | | | 0.53 | 0.72 | | | 1 | 20 | OFFICE 325D RCPT | 58 |
| 59 | SPARE | 20 | 1 | | | | | 0.00 | 0.72 | 1 | 20 | OFFICE 329A RCPT | 60 |
| 61 | SPARE | 20 | 1 | 0.00 | 0.72 | | | | | 1 | 20 | OFFICE 329B RCPT | 62 |
| 63 | SPARE | 20 | 1 | | | 0.00 | 0.72 | | | 1 | 20 | OFFICE 329C RCPT | 64 |
| 65 | SPARE | 20 | 1 | | | | | 0.00 | 0.54 | 1 | 20 | OFFICE 329D RCPT | 66 |
| 67 | SPARE | 20 | 1 | 0.00 | 0.72 | | | | | 1 | 20 | OFFICE 329E RCPT | 68 |
| 69 | SPARE | 20 | 1 | | | 0.00 | 0.72 | | | 1 | 20 | OFFICE 329F RCPT | 70 |
| 71 | SPARE | 20 | 1 | | | | | 0.00 | 0.72 | 1 | 20 | OFFICE 329G RCPT | 72 |
| 73 | SPARE | 20 | 1 | 0.00 | 0.00 | | | | | 1 | 20 | 3RD FLR COORIDOR RCPT | 74 |
| 75 | SPARE | 20 | 1 | | | 0.00 | 0.00 | | | 1 | 20 | SPARE | 76 |
| 77 | SPARE | 20 | 1 | | | | | 0.00 | 0.00 | 1 | 20 | SPARE | 78 |
| 79 | SPARE | 20 | 1 | 0.00 | 0.00 | | | | | 1 | 20 | SPARE | 80 |
| 81 | SPARE | 20 | 1 | | | 0.00 | 0.00 | | | 1 | 20 | SPARE | 82 |
| 83 | SPARE | 20 | 1 | | | | | 0.00 | 0.00 | 1 | 20 | SPARE | 84 |
| Phase Load (kVA): | | | | 19.69 | | 21.51 | | 20.58 | | | | | |
| Phase Amps: | | | | 164.1 A | | 179.3 A | | 171.5 A | | | | | |
| Notes: NEW PANELBOARD | | | | | | | | | | | | | |

| Panel: PANEL 332 | | | | | | | | | | | | | | |
|---|---------------------|------|-----------------|------|------|--------------------|-------|------|---------------------|-----|----|-------|----|--|
| Location: VACANT RAW SPACE 332 | | | Volts: 120/208V | | | A.I.C. Rating: 10K | | | | | | | | |
| Supply From: MAIN SWITCHBOARD | | | Phases: 3 | | | Mains Type: CU | | | | | | | | |
| Mounting: SURFACE | | | Wires: 4 | | | Mains Rating: 100A | | | | | | | | |
| Enclosure: NEMA 1 | | | | | | MCB Rating: 100A | | | | | | | | |
| CKT | Circuit Description | Trip | Poles | A | B | C | Poles | Trip | Circuit Description | CKT | | | | |
| 1 | SPARE | 20 | 1 | 0.00 | 0.00 | | | | | 1 | 20 | SPARE | 2 | |
| 3 | SPARE | 20 | 1 | | | 0.00 | 0.00 | | | 1 | 20 | SPARE | 4 | |
| 5 | SPARE | 20 | 1 | | | | | 0.00 | 0.00 | 1 | 20 | SPARE | 6 | |
| 7 | SPARE | 20 | 1 | 0.00 | 0.00 | | | | | 1 | 20 | SPARE | 8 | |
| 9 | SPARE | 20 | 1 | | | 0.00 | 0.00 | | | 1 | 20 | SPARE | 10 | |
| 11 | SPARE | 20 | 1 | | | | | 0.00 | 0.00 | 1 | 20 | SPARE | 12 | |
| 13 | SPARE | 20 | 1 | 0.00 | 0.00 | | | | | 1 | 20 | SPARE | 14 | |
| 15 | SPARE | 20 | 1 | | | 0.00 | 0.00 | | | 1 | 20 | SPARE | 16 | |
| 17 | SPARE | 20 | 1 | | | | | 0.00 | 0.00 | 1 | 20 | SPARE | 18 | |
| 19 | SPARE | 20 | 1 | 0.00 | 0.00 | | | | | 1 | 20 | SPARE | 20 | |
| 21 | SPARE | 20 | 1 | | | 0.00 | 0.00 | | | 1 | 20 | SPARE | 22 | |
| 23 | SPARE | 20 | 1 | | | | | 0.00 | 0.00 | 1 | 20 | SPARE | 24 | |
| 25 | SPARE | 20 | 1 | 0.00 | 0.00 | | | | | 1 | 20 | SPARE | 26 | |
| 27 | SPARE | 20 | 1 | | | 0.00 | 0.00 | | | 1 | 20 | SPARE | 28 | |
| 29 | SPARE | 20 | 1 | | | | | 0.00 | 0.00 | 1 | 20 | SPARE | 30 | |
| 31 | SPARE | 20 | 1 | 0.00 | 0.00 | | | | | 1 | 20 | SPARE | 32 | |
| 33 | SPARE | 20 | 1 | | | 0.00 | 0.00 | | | 1 | 20 | SPARE | 34 | |
| 35 | SPARE | 20 | 1 | | | | | 0.00 | 0.00 | 1 | 20 | SPARE | 36 | |
| 37 | SPARE | 20 | 1 | 0.00 | 0.00 | | | | | 1 | 20 | SPARE | 38 | |
| 39 | SPARE | 20 | 1 | | | 0.00 | 0.00 | | | 1 | 20 | SPARE | 40 | |
| 41 | SPARE | 20 | 1 | | | | | 0.00 | 0.00 | 1 | 20 | SPARE | 42 | |
| Phase Load (kVA): | | | | 0.00 | | 0.00 | | 0.00 | | | | | | |
| Phase Amps: | | | | 0 A | | 0 A | | 0 A | | | | | | |
| Notes: NEW PANELBOARD | | | | | | | | | | | | | | |
| PROVIDE FOR FUTURE OFFICE SPACE WITH ESTIMATED LOAD FACTOR OF 5.08W PER SQUARE FOOT TOTALING 22.1 KVA (61 AMPS) | | | | | | | | | | | | | | |

| Panel: PANEL 3-2 | | | | | | | | | | | | | | |
|--------------------------------------|---------------------|------|-------------|------|---|--------------------|-------|------|---------------------|---------------------|--------------------------|--|--|--|
| Location: 3RD FLR CORRIDOR | | | Volts: 208V | | | A.I.C. Rating: ETR | | | | | | | | |
| Supply From: ETR | | | Phases: 1 | | | Mains Type: ETR | | | | | | | | |
| Mounting: RECESSED | | | Wires: 3 | | | Mains Rating: 60 A | | | | | | | | |
| Enclosure: NEMA 1 | | | | | | MLO Rating: 60 A | | | | | | | | |
| CKT | Circuit Description | Trip | Poles | A | B | C | Poles | Trip | Circuit Description | CKT | | | | |
| 1 | CORD LTG (EXT) | 20 | 1 | | | | | 1 | 20 | 316 RCPT (EXT) | 2 | | | |
| 3 | 316 RCPT (EXT) | 20 | 1 | | | | | 1 | 20 | 315 LTG (EXT) | 4 | | | |
| 5 | 315 RCPT (EXT) | 20 | 1 | | | | | 1 | 20 | 315, 316 RCPT (EXT) | 6 | | | |
| 7 | 316 RCPT (EXT) | 20 | 1 | | | | | 1 | 20 | HALL RCPT (EXT) | 8 | | | |
| 9 | 315 LTG (EXT) | 20 | 1 | | | | | 1 | 20 | 315 LTG (EXT) | 10 | | | |
| 11 | 316 RCPT (EXT) | 20 | 1 | | | | | 1 | 15 | SPARE (EXT) | 12 | | | |
| Phase Load (kVA): | | | | 0.00 | | 0.00 | | - | | | | | | |
| Phase Amps: | | | | 0 A | | 0 A | | - | | | (EXT) = EXISTING CIRCUIT | | | |
| Notes: EXISTING PANELBOARD TO REMAIN | | | | | | | | | | | | | | |
| SEE NOTE 1 | | | | | | | | | | | | | | |

| Panel: PANEL 3-5 | | | | | | | | | | | | | | |
|--------------------------------------|---------------------|------|-----------------|------|---|---------------------|-------|------|---------------------|-----------------|--------------------------|--|--|--|
| Location: 3RD FLOOR COORIDOR | | | Volts: 120/208V | | | A.I.C. Rating: ETR | | | | | | | | |
| Supply From: ETR | | | Phases: 3 | | | Mains Type: CU | | | | | | | | |
| Mounting: SURFACE | | | Wires: 4 | | | Mains Rating: 100 A | | | | | | | | |
| Enclosure: NEMA 1 | | | | | | MLO Rating: 100 A | | | | | | | | |
| CKT | Circuit Description | Trip | Poles | A | B | C | Poles | Trip | Circuit Description | CKT | | | | |
| 1 | CKT (EXT) | 20 | 1 | | | | | 1 | 20 | CKT (EXT) | 2 | | | |
| 3 | CKT (EXT) | 20 | 1 | | | | | 1 | 20 | CKT (EXT) | 4 | | | |
| 5 | CKT (EXT) | 20 | 1 | | | | | 1 | 20 | CKT (EXT) | 6 | | | |
| 7 | CKT (EXT) | 20 | 1 | | | | | 1 | 20 | CKT (EXT) | 8 | | | |
| 9 | CKT (EXT) | 20 | 1 | | | | | 1 | 20 | CKT (EXT) | 10 | | | |
| 11 | CKT (EXT) | 20 | 1 | | | | | 1 | 20 | CKT (EXT) | 12 | | | |
| 13 | CKT (EXT) | 20 | 1 | | | | | 1 | 20 | CKT (EXT) | 14 | | | |
| 15 | CKT (EXT) | 20 | 1 | | | | | 1 | 20 | CKT (EXT) | 16 | | | |
| 17 | CKT (EXT) | 20 | 1 | | | | | 1 | 20 | CKT (EXT) | 18 | | | |
| 19 | CKT (EXT) | 20 | 1 | | | | | 1 | 20 | CKT (EXT) | 20 | | | |
| 21 | CKT (EXT) | 20 | 1 | | | | | 2 | 50 | PANEL 302 (EXT) | 22 | | | |
| 23 | CKT (EXT) | 20 | 1 | | | | | - | - | - | 24 | | | |
| Phase Load (kVA): | | | | 0.00 | | 0.00 | | 0.00 | | | | | | |
| Phase Amps: | | | | 0 A | | 0 A | | 0 A | | | (EXT) = EXISTING CIRCUIT | | | |
| Notes: EXISTING PANELBOARD TO REMAIN | | | | | | | | | | | | | | |
| SEE NOTE 1 | | | | | | | | | | | | | | |