# STATE OF CONNECTICUT



# DANNEL P. MALLOY GOVERNOR


DEPARTMENT OF ADMINISTRATIVE SERVICES MELODY A. CURREY COMMISSIONER


DEPARTMENT OF EDUCATION DIANNA R. WENTZELL COMMISSIONER


21 HAYESTOWN AVE HENRY ABBOTT THS NEW GARAGE BUILDING DANBURY, CONNECTICUT

PROJECT NO. BI-RT-888


BID DOCUMENT SUBMISSION AUGUST 21, 2018 CLOHESSY HARRIS & KAISER, LLC 573 HOPMEADOW STREET SIMSBURY, CT, 06070 860.651.3777

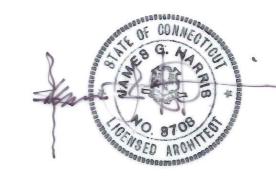

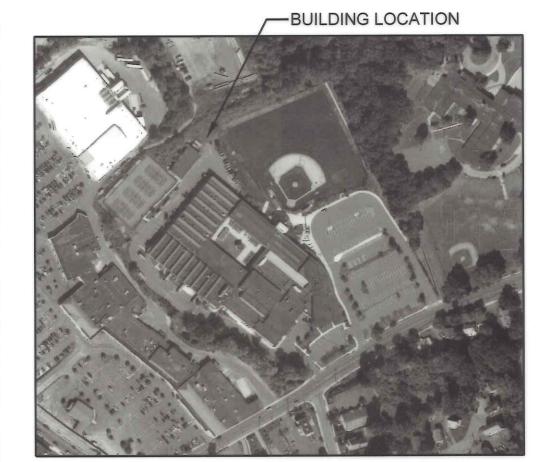

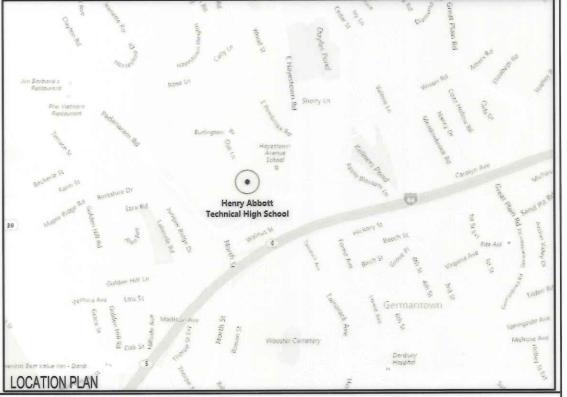

in Fatone 8.23.18

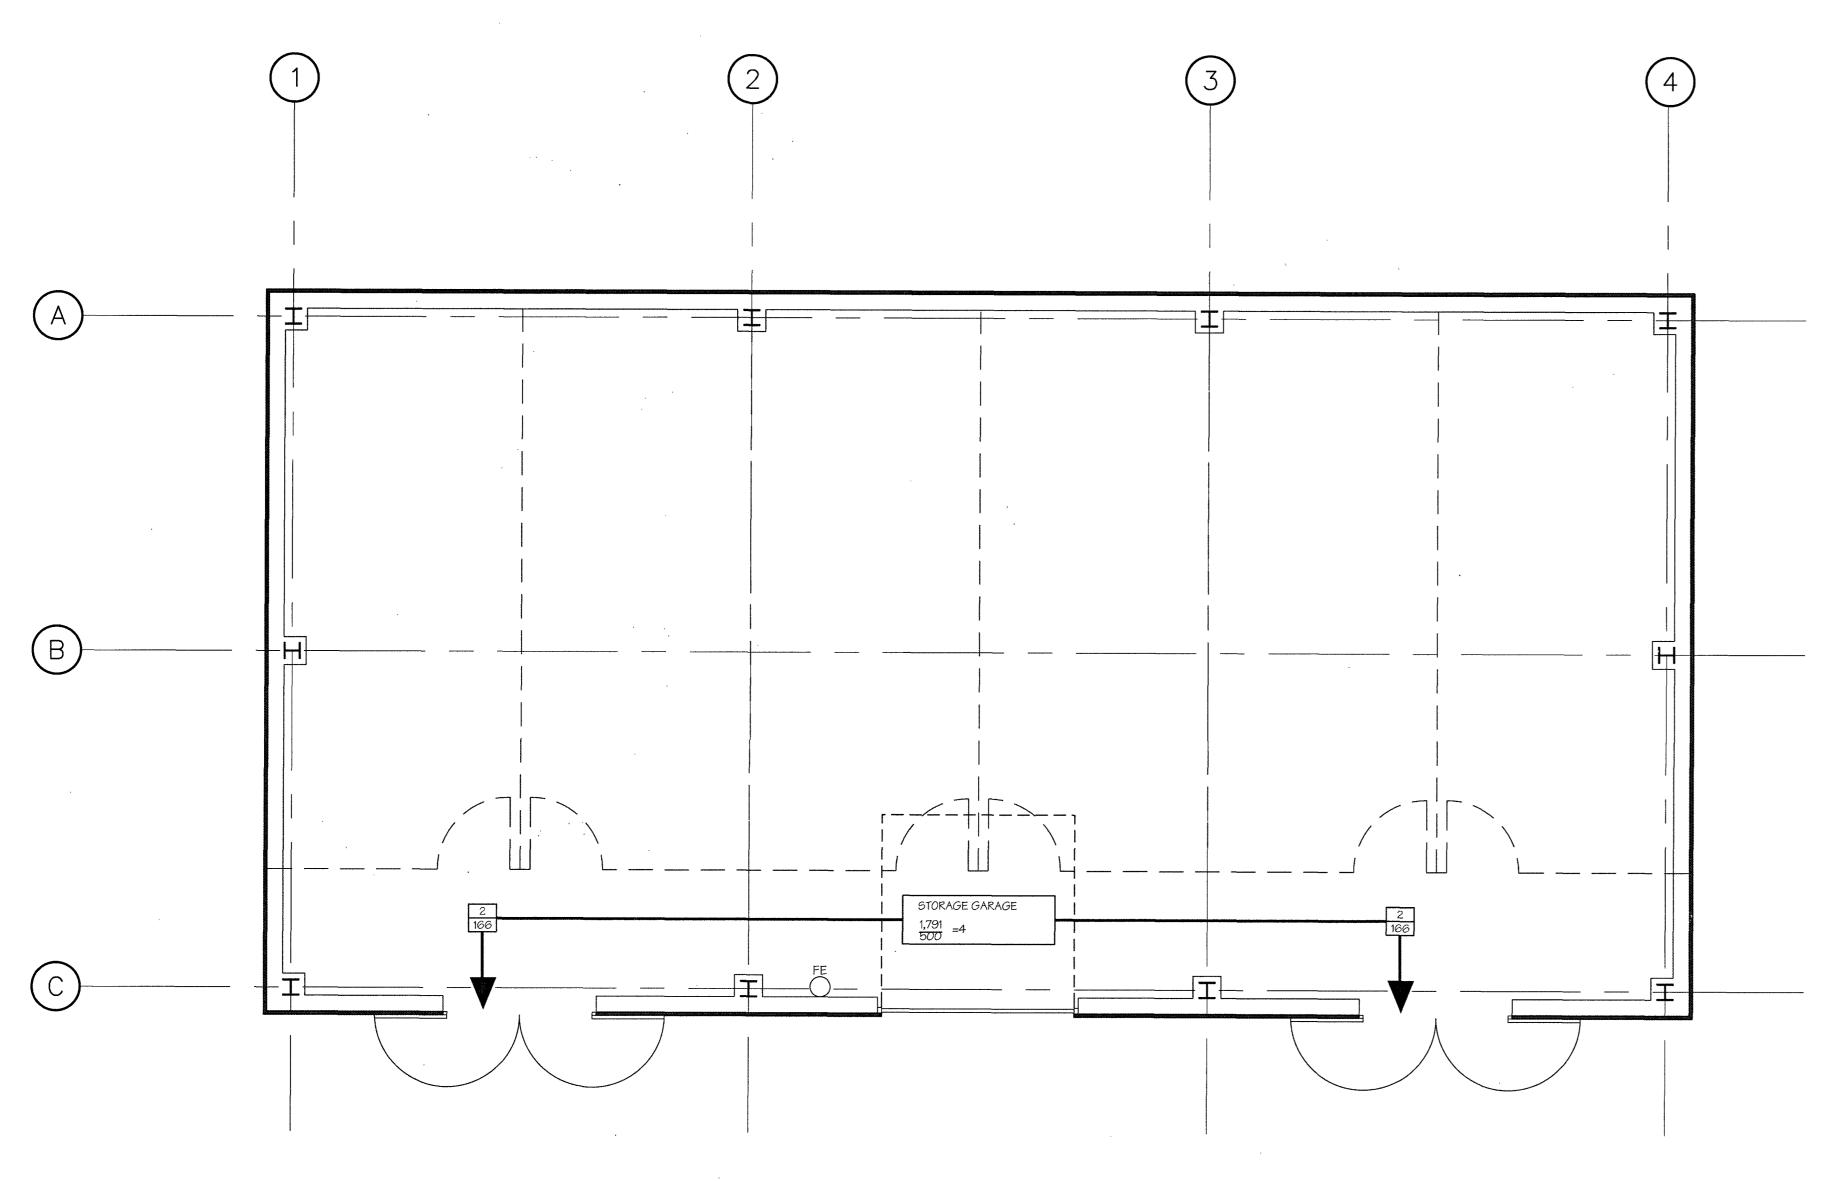

## FLOOR PLAN

#### **APPLICABLE CODES**

#### ALL CONSTRUCTION SHALL CONFORM TO THE FOLLOWING APPLICABLE CODES:

EXISTING BUILDING CODE

2012 International Existing Building Code

STATE BUILDING CODE

2016 State of Connecticut Building Code

EXISTING FIRE/ SAFETY CODE

2012 NFPA 101 Life Safety Code

BUILDING/ DWELLING CODE

2016 Connecticut State Building Code

STRUCTURAL CODE PLUMBING CODE

2016 Connecticut State Building Code 2012 International Plumbing Code

MECHANICAL CODE

2012 International Mechanical Code

ELECTRICAL CODE

2014 National Electrical Code (NFPA 70)

FIRE/ SAFETY CODE

2016 Connecticut Fire Safety Code 2012 ICC- International Fire Code (IFC), NFPA 1 Fire Code- 2012 Edition

(New Construction, Renovations or Change of Use)

ACCESSIBILITY CODE

**ENERGY CODE** 

**BOILER CODE** 

ICC/ANSI A117.1-2009 Accessible and Usable Building and Facilities 2012 International Energy Conservation Code

GAS CODE

2016 Connecticut Fire Safety Code; NFPA 2, 54 & 58 -2012 Edition

**ELEVATORS AND ESCALATORS** CGS Sections 29-192-1d to 29-192-6d; ASME A17.1-1996; ASME A17.1a-1997- Addenda; ASME A17.1b-1998- Addenda; ANSI A10.4-1990

DEPT. OF HEALTH CODE

#### NOTE:

A. PLEASE DO NOT SCALE DRAWINGS. PLEASE USE DIMENSIONS.

N/A

- B. THE GENERAL CONTRACTOR/CONSTRUCTION MANAGER IS TO FIELD VERIFY ALL DIMENSIONS AND CONDITIONS AND SHALL BE RESPONSIBLE FOR SAME.
- C. THESE DOCUMENTS ARE THE SOLE PROPERTY OF THE ARCHITECT AND SHALL NOT BE USED FOR CONSTRUCTION ON ANY OTHER SITE WITHOUT THE WRITTEN PERMISSION OF THE ARCHITECT.
- D. CONSTRUCTION DOCUMENTS ARE TO BE USED AS A COMPLETE SET. THE ARCHITECT SHALL NOT BE RESPONSIBLE FOR ERRORS OR MISINTERPRETATIONS RESULTING FROM THE USE OF AN INCOMPLETE SET OF DOCUMENTS. CONTRACT DOCUMENTS ARE COMPLIMENTARY AND WHAT IS REQUIRED BY ONE SHALL BE BINDING AS IF REQUIRED BY ALL.

#### **CODE DATA NOTES**

- 1. A VALUE OF 0.2 INCHES OF WIDTH PER OCCUPANT HAS BEEN USED TO CALCULATE DOOR AND CORRIDOR EGRESS CAPACITY. IN ALL CASES, THE ACTUAL CLEAR OPENING OF THE DOORS AND ACTUAL CLEAR WIDTH OF CORRIDORS IS USED.
- 2. A VALUE OF 0.3 INCHES OF WIDTH PER OCCUPANT HAS BEEN USED TO CALCULATE STAIR EGRESS CAPACITY.

DOOR CLEAR OPENING AND OCCUPANT TABLE 3'-0" DOOR = 33.25" / .2 = 166 OCCUPANTS 3'-4" DOOR = 37.25" / .2 = 186 OCCUPANTS 3'-6" DOOR = 39.25" / .2 = 196 OCCUPANTS 4'-0" DOOR = 45.25" / .2 = 226 OCCUPANTS PAIR 3'-0" DOORS = 67.5" / .2 = 337 OCCUPANTS

#### CODE DATA LEGEND

#### ROOM/AREA OCCUPANCY LOAD

- OCCUPANCY TYPE STORAGE -AREA IN SQUARE FEET 4,900 =49 ACTUAL OCCUPANCY OCCUPANCY LOAD FACTOR

#### DOOR CAPACITY

----- ACTUAL CAPACITY OF DOOR ---- MAXIMUM ALLOWABLE CAPACITY

> DIRECTION OF TRAVEL WITH ACCUMULATED OCCUPANT LOAD

## CODE DATA

1. USE GROUP: (302.1)

S-2 (LOW HAZARD STORAGE)

II. CONSTRUCTION CLASSIFICATION: (602.1)

11B (NONCOMBUSTIBLE)

III. HIEGHT and AREA LIMITATIONS: (503.0 - 508.0)

A. Allowable area per floor:

1. Per Table 503 26,000 SF 2. Open Perimeter (506.2 - 75% increase) Auto Sprinkler Sys. increase (506.3) (200% increase)

Total allowable area per floor: 34,580 SF

B. Proposed Area Calculations:

Storage Building 1,792 SF.

C: Number of Stories:

1. Per Table 503 3 Stories 2. Total number of stories proposed: 1 Story

D. Height:

1. Per Table 503

55 Feet 3. Total Height Proposed: 13.5 Feet

IV. FIRE RESISTANCE RATINGS of STRUCTURAL ELEMENTS - (Tobie 601 & 602)

A. Structural frame (including columns, girders & trusses) B. Loadbearing walls (Exterior) 0 hour (Interior) 0 hour C. Non loadbearing walls & partitions (Exterior) 0 hour (Interior) 0 hour

D. Floor construction 0 hour (including supporting beams & joists) E. Roof construction

V. INTERIOR WALL & CEILING FINISH REQUIREMENTS - (Tobie 803.5)

(including supporting beams & joists)

B Use Group:

A. Vertical Exits — Class B (Flame Spread 26—75; Smoke Developed 0—450)
B. Exit Access Corridors — Class C (Flame Spread 76—200; Smoke Developed 0—450) C. Rooms/Enclosed Spaces - Class C (Flame Spread 76-200; Smoke Developed 0-450)

VI. INTERIOR FLOOR FINISH REQUIREMENTS - (Tobie 804.5.1)

A. Vertical Exits, Exit Passageways and Exit Access Corridors — Class II

VII. OCCUPANCY LOAD

Allowable per code (Table 1004.1.2)

First Floor: 1,792 SF. / 500 = 4 OccupantsAreas

VIII. EGRESS WIDTH PER OCCUPANT (Tobie 1005.1)


STAIR (.3" PER PERSON)

Stairs: (44" min. per sect 1009.1)


DOORS, RAMPS AND CORRIDORS (.2" PER PERSON) <u>Doors:</u> (32" clear min. per sect 1008.1.1)


Ramps: (44" min. per sect. 1010.5.1 and 1016.2)


<u>Corridors:</u> (44" min. per sect. 1016.2)

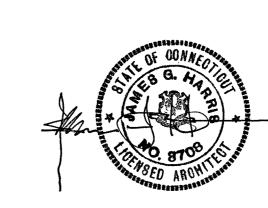



drawing title CODE DATA AND EGRESS PLAN			STATE OF DEPARTMENT OF A		
	REV	VISIONS			
mark	date	description	drawing prepared by	IARRIS & KAISER, LLC	date 2/28/18
1	2/28/18	CS/DD SUBMISSION	573 H	scale	
2	5/8/18	CS/DD RESUBMISSION	0,011	1/4"=1'-0"	
3	6/4/18	CD SUBMISSION	project	drawn by	
4	8/21/18	FINAL BID DOCUMENTS		RAM	
			21 HAYESTOWI NEW GARAGE I	approved by JH	
			DANBURY, CT		drawing no.
			CAD no. g:\17191\DWG\17191.DWG	project no. BI-RT-888	C1.01

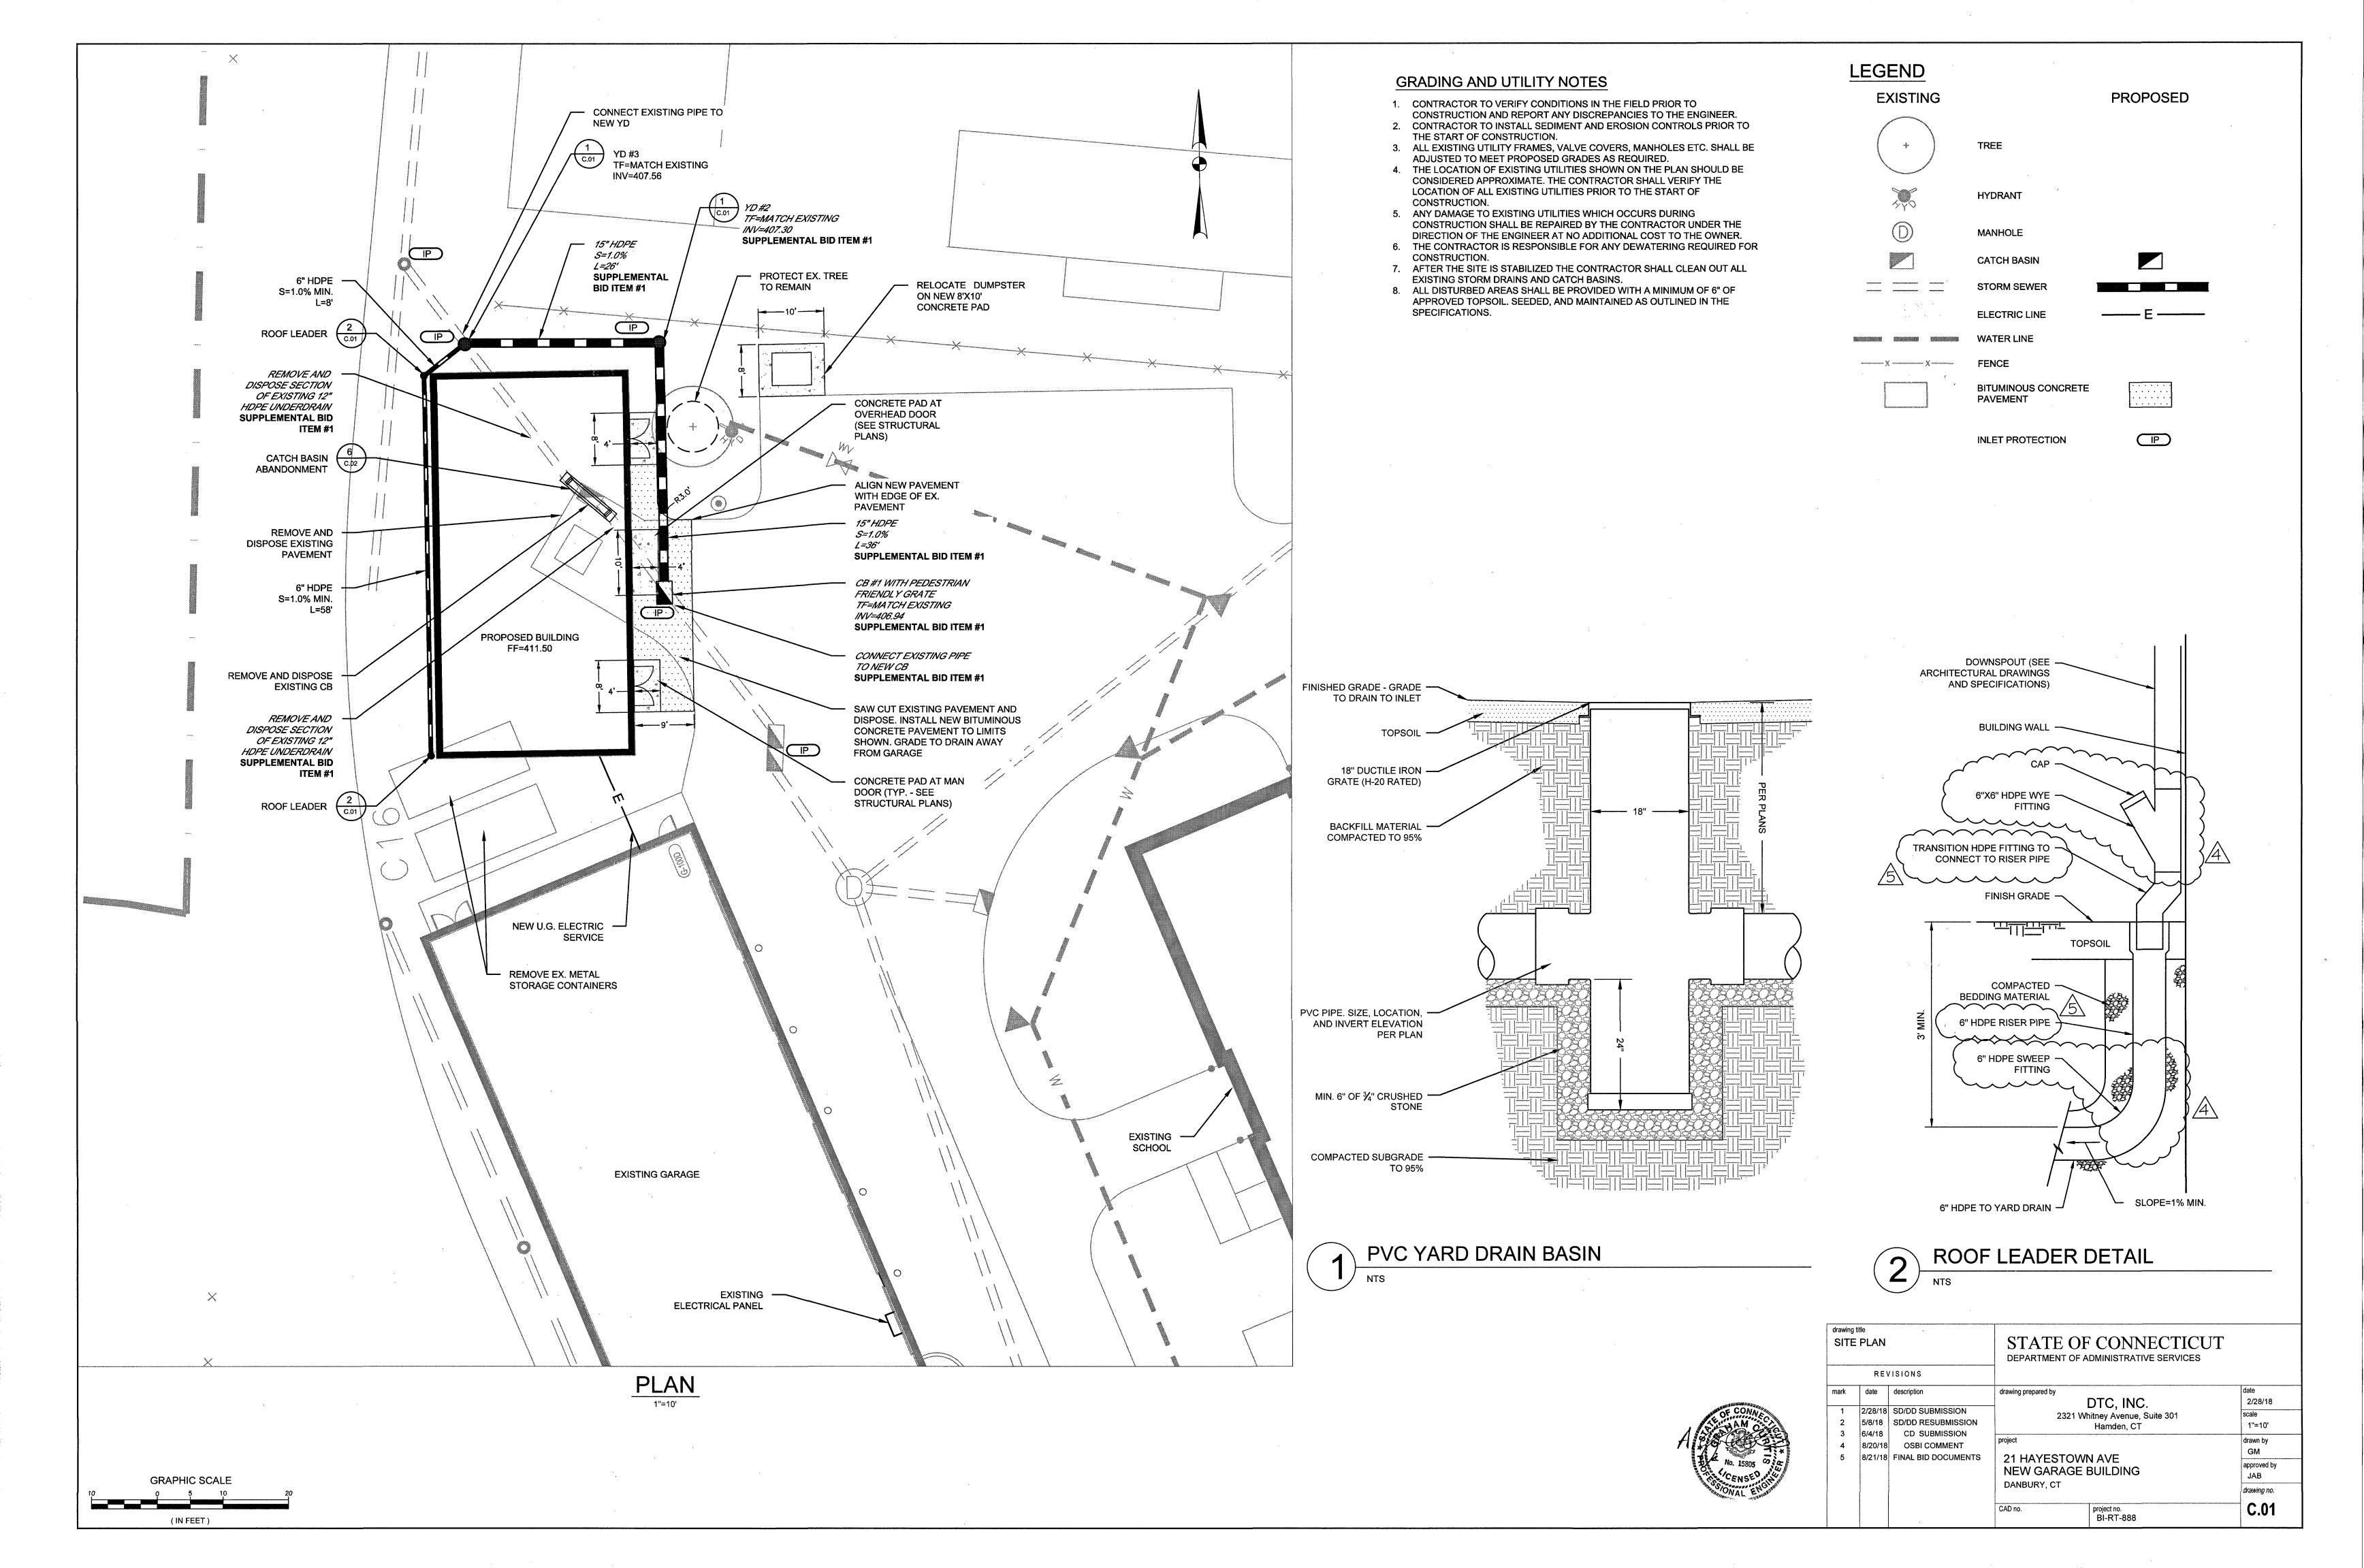

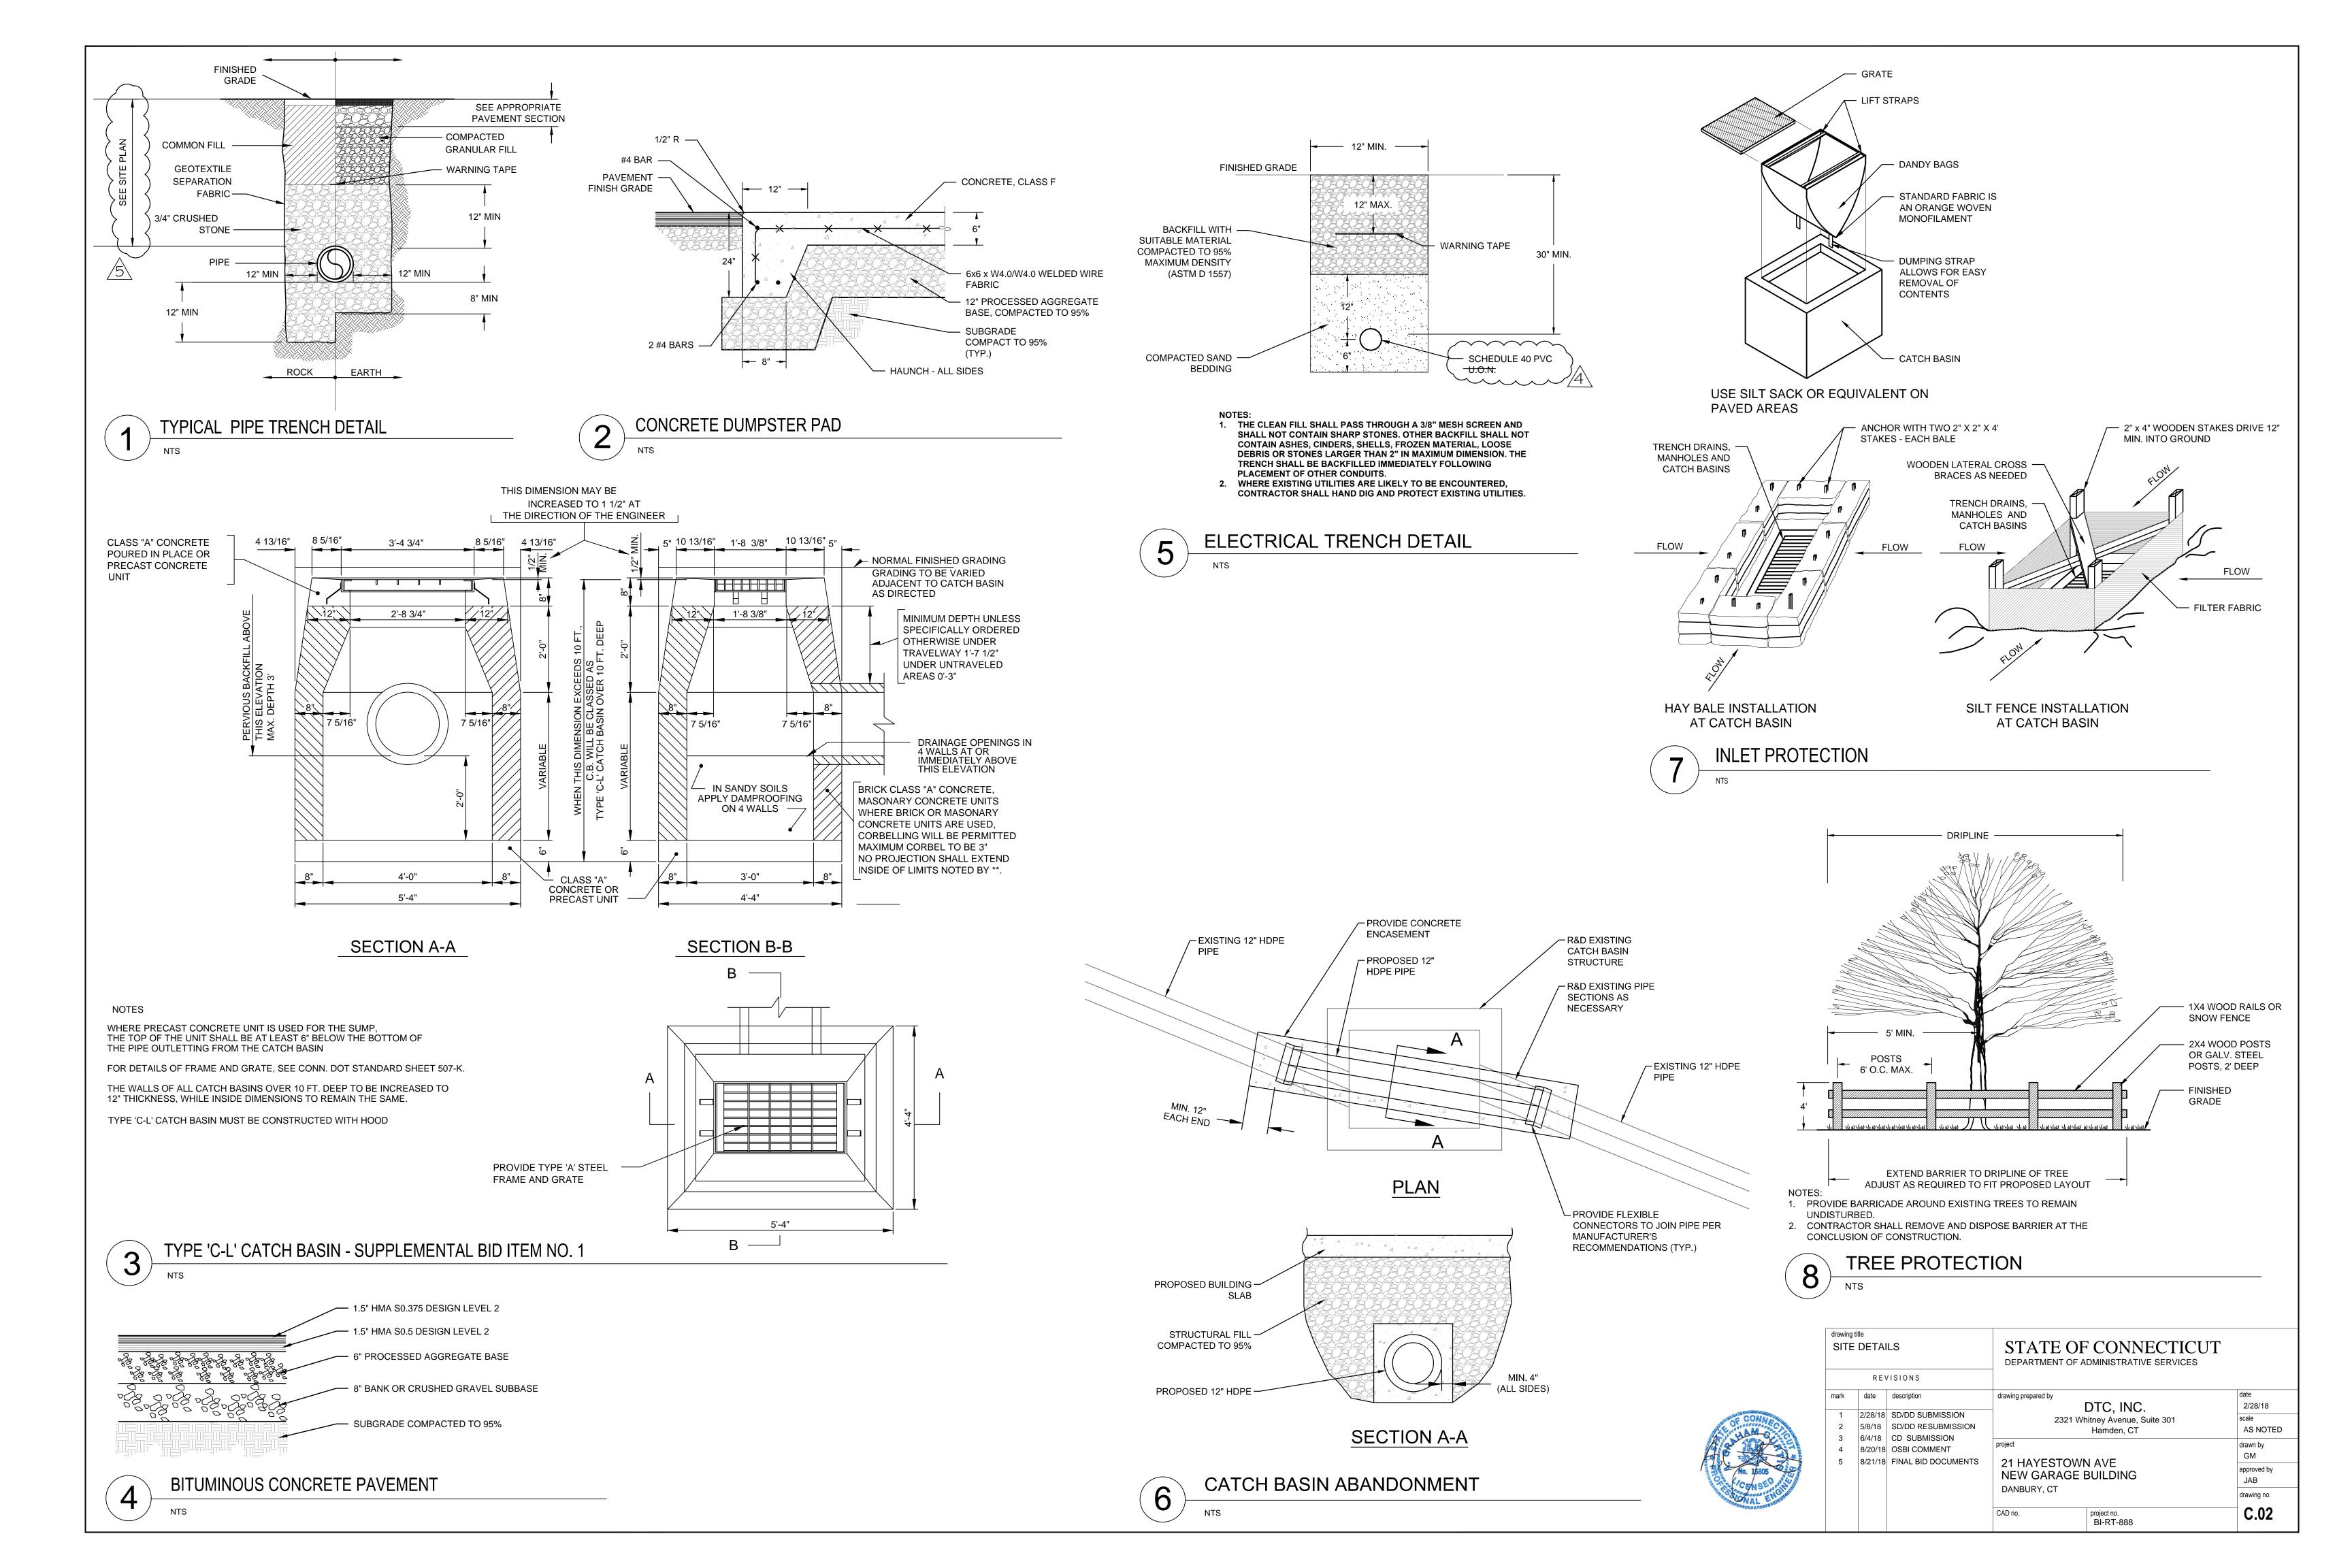

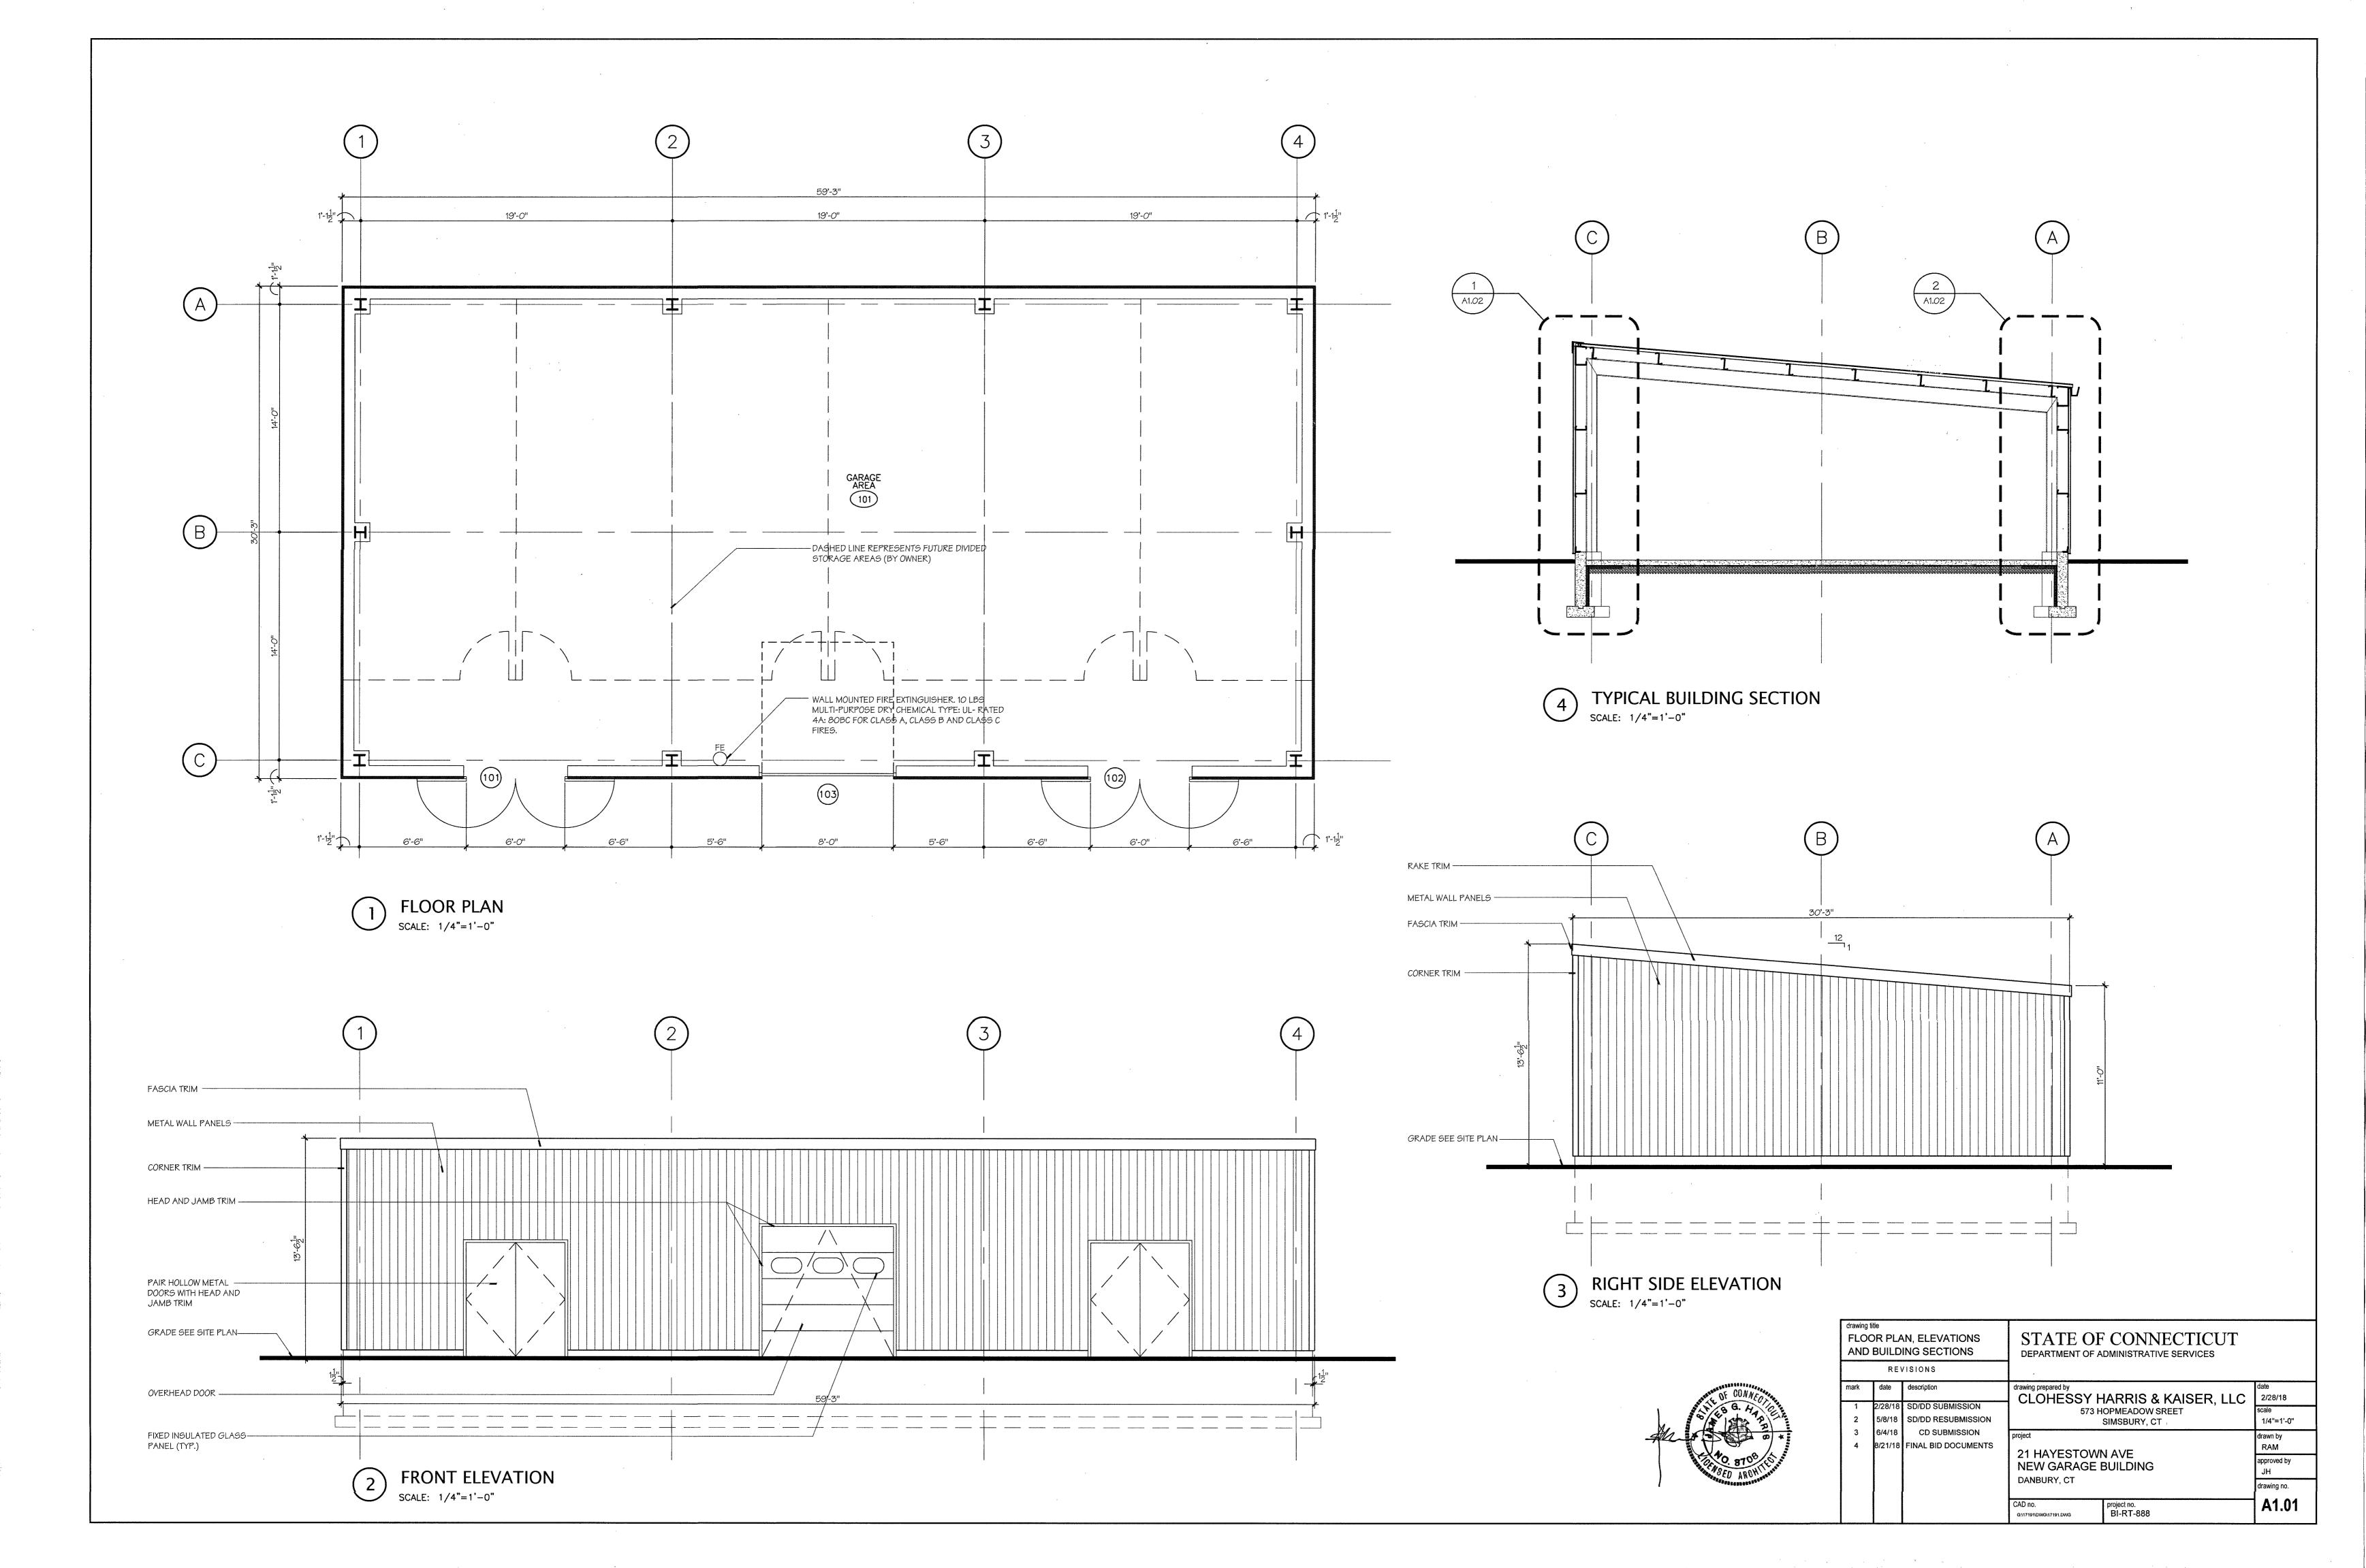


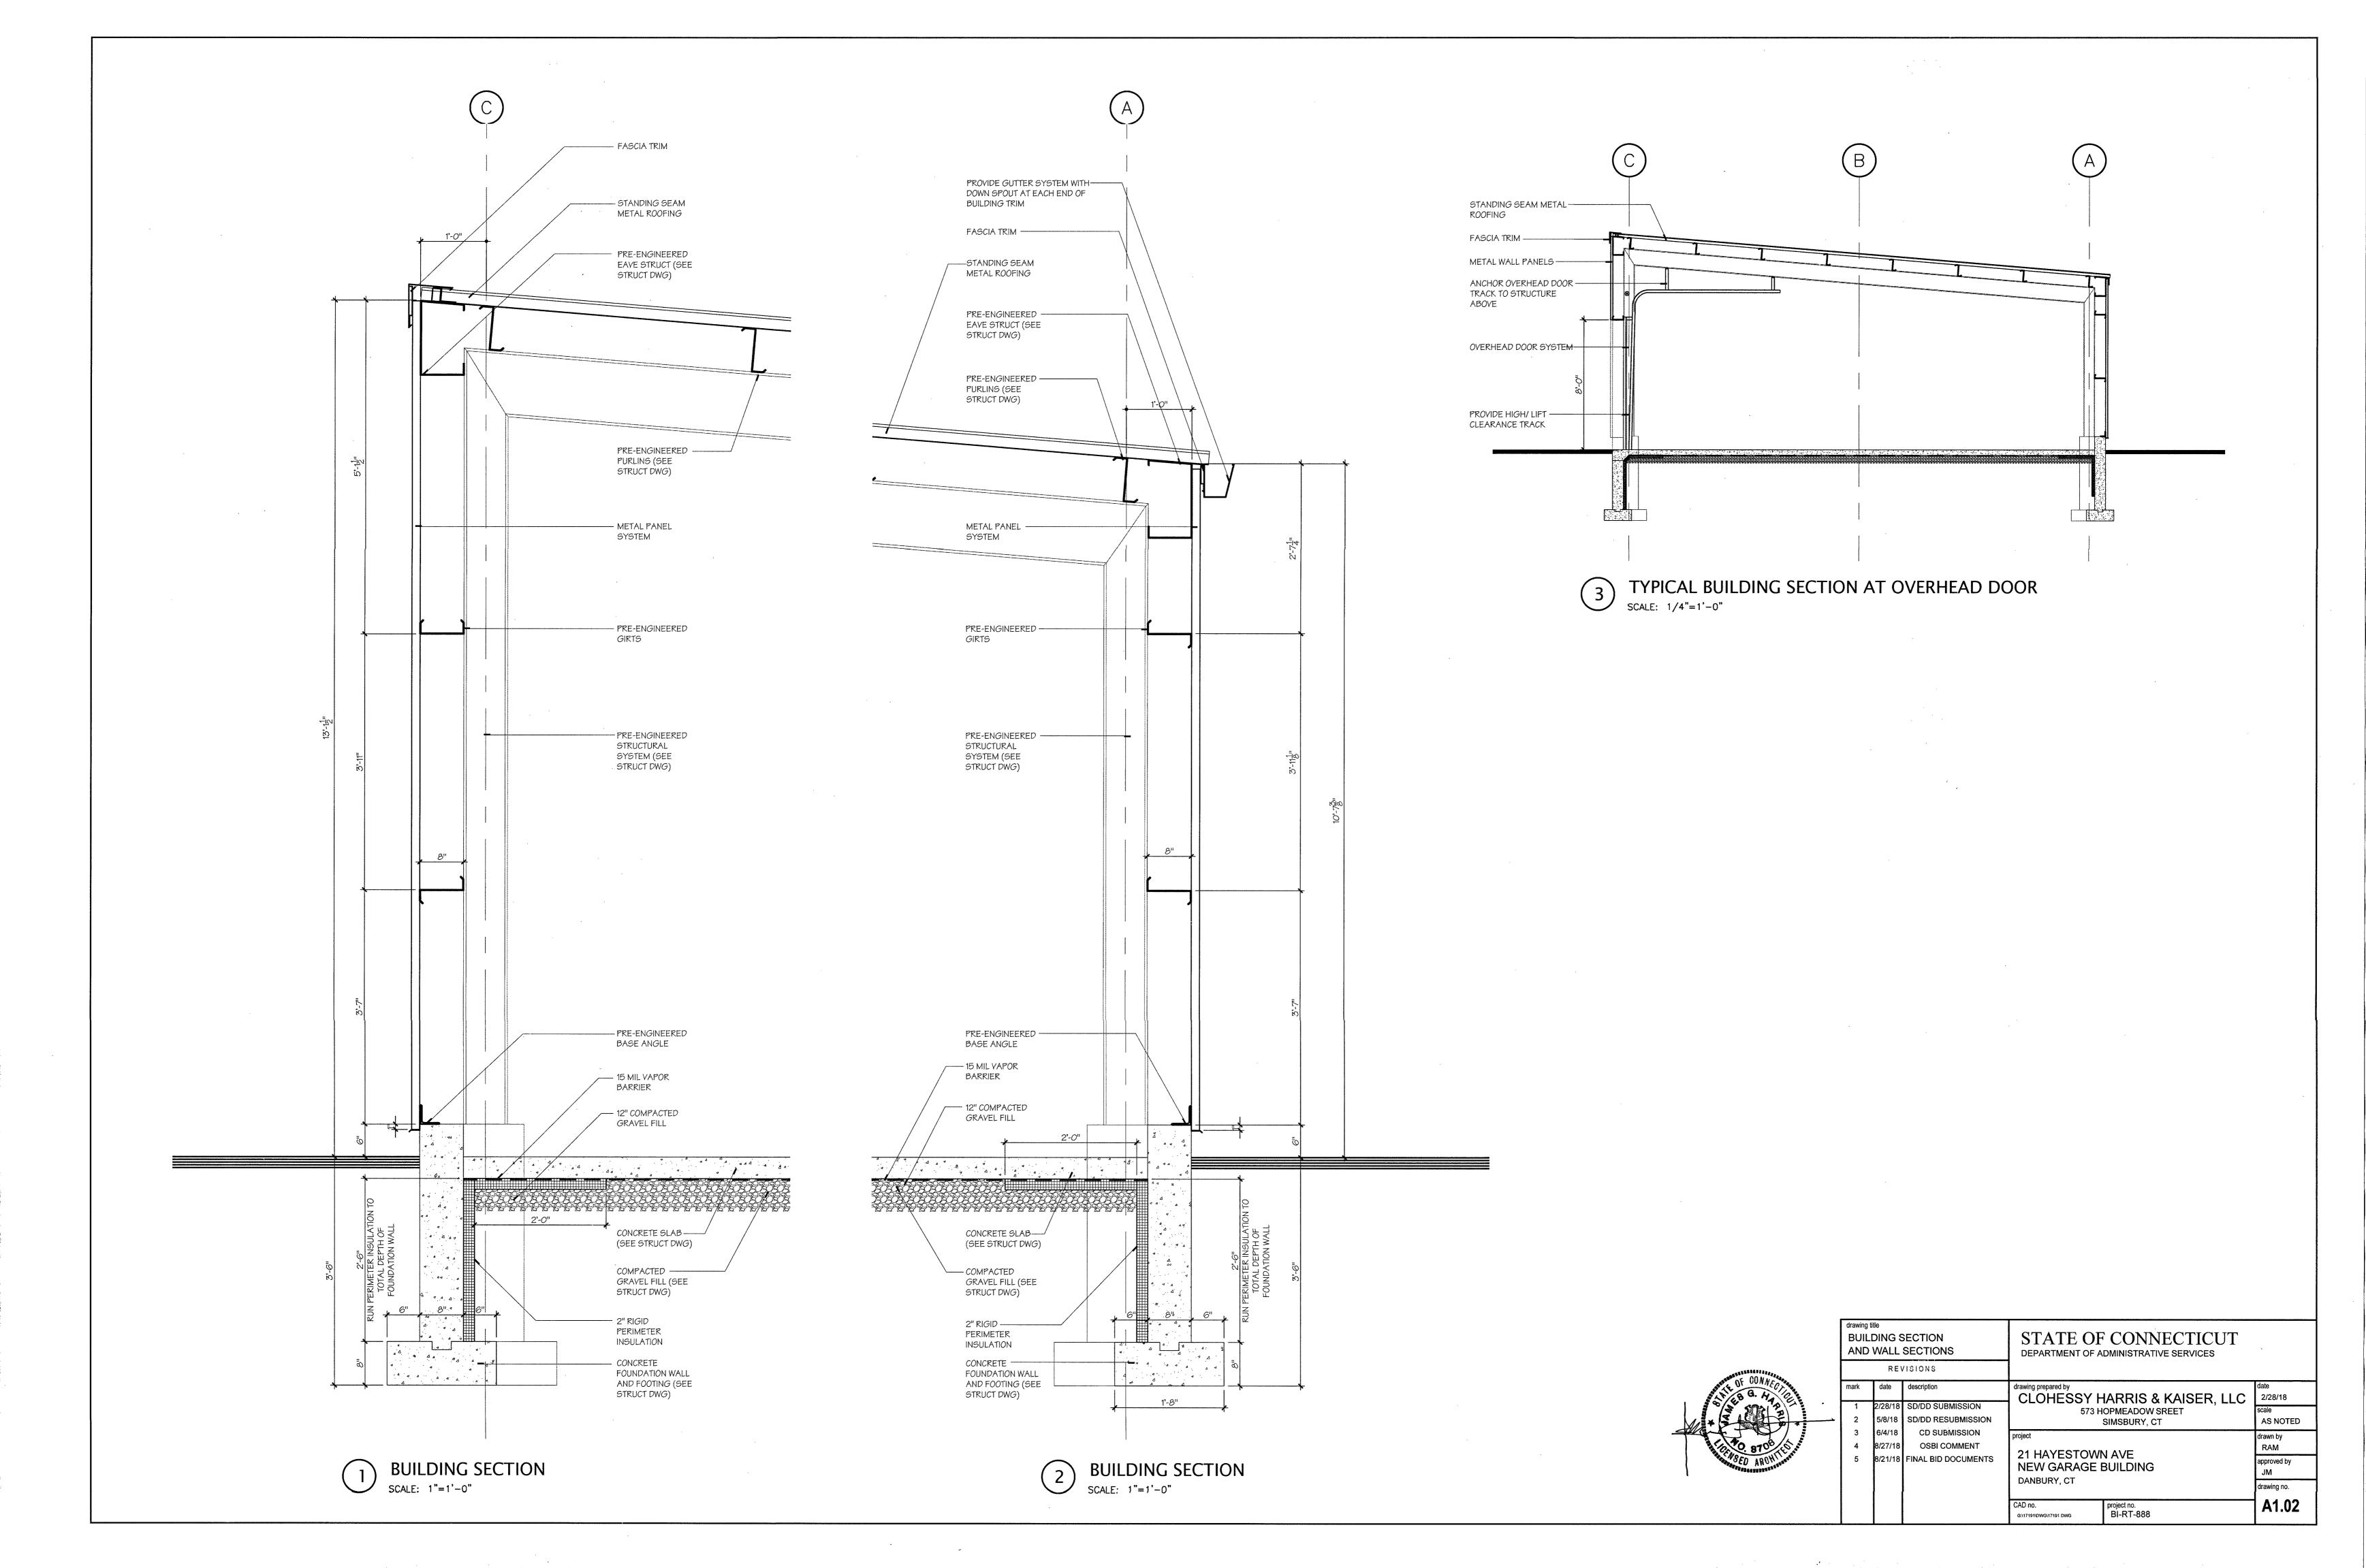

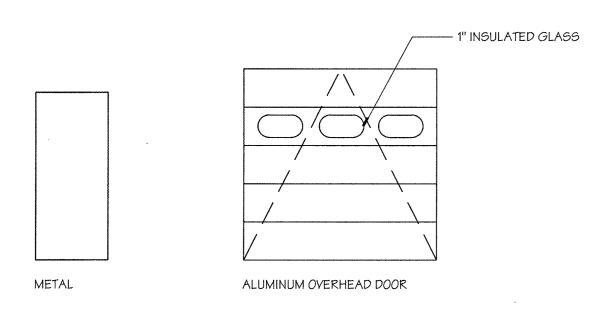


A.

**DOORS**SCALE: 1/4"=1'-0"

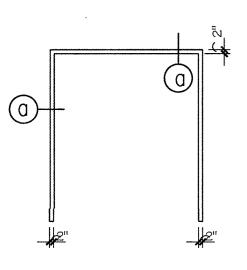

**HOLLOW METAL DOOR FRAMES** 

SCALE: 1/4"=1'-0"

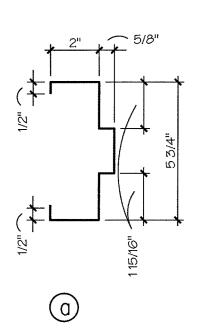

HOLLOW METAL FRAME PROFILE

SCALE 3"=1'-0"

DOOR DETAILS

SCALE 1 1/2"=1'-0"

DOOR NUMBER	LOCATION		DOOR			FRAME														
	FROM	10	WIDTH	НЕІСНТ	THICKNESS	MATERIAL	FINISH	TYPE	UC./LOUV.	TYPE	DEРТН	HEAD	LJAMB	R.JAMB	MATERIAL	FINISH	THRESHOLD	FIRE RATING	HARDWARE	REMARKS
101	101	EXT	6'-0"	7'-0"	13/4"	НМ	PAINT	Α		ı	5 3/4"	1	2	2	НМ	PAINT		-	Α	PAIR 3'-0"X7'-0" DOORS
102	101	EXT	6'-0"	7'-0"	1 3/4"	НМ	PAINT	Α		1	5 3/4"	1	2	2	НМ	PAINT			Α	PAIR 3'-0"X7'-0" DOORS
103	101	EXT	8'-0"	8'-0"	1 3/4"	MTL	ALUM	В			8	3	4	4	MTL	PRIMER			В	·

#### HARDWARE SETS


#### SET A


SILENCERS

11/2 PR BUTTS EA LEAF
LOCKSET STORAGE FUNCTION ACTIVE LEAF
FLUSH BOLT TOP AND BOTTOM INACTIVE LEAF
EXTERIOR SECURITY PLATE OVER LOCKSET LATCH AREA
HEAD AND JAMB WEATHER SEAL
DROP WEATHER SEAL DOOR BOTTOM


### SET B


PROVIDE FACTORY STANDARD LOCK DEVICE INSIDE LATCH LOCK EACH SIDE

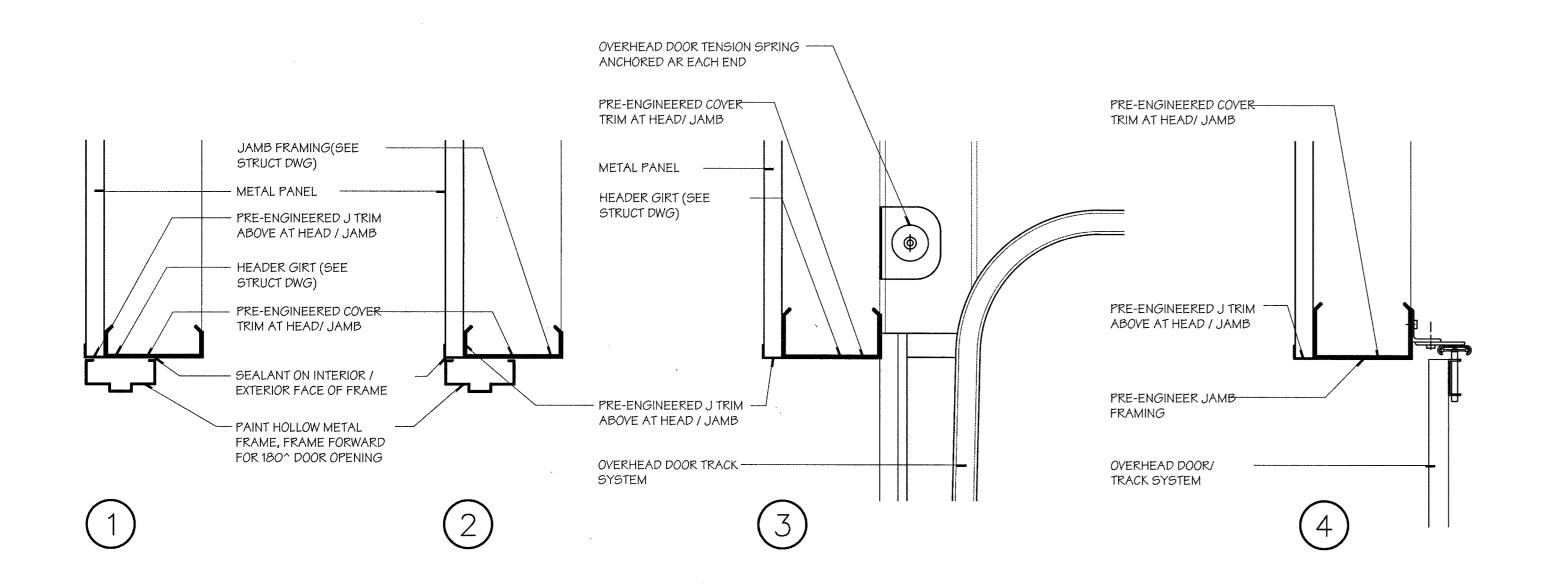


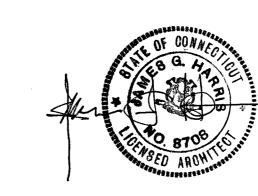

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	REV	/ISIONS				
mark	date	description	drawing prepared by  CLOHESSY H	date 2/28/18		
1	2/28/18	SD/DD SUBMISSION	573 H	scale		
2	5/8/18	SD/DD RESUBMISSION	0,011	1/4"=1'-0"		
3	6/4/18	CD SUBMISSION	project	drawn by		
4 8/21/18 FINAL BID DOCUMENTS			21 HAYESTOWN	RAM		
			NEW GARAGE	approved by		
			DANBURY, CT	drawing no.		
					ľ	
			CAD no. g:\17191\DWg\17191.DWg	project no. BI-RT-888	A1.03	

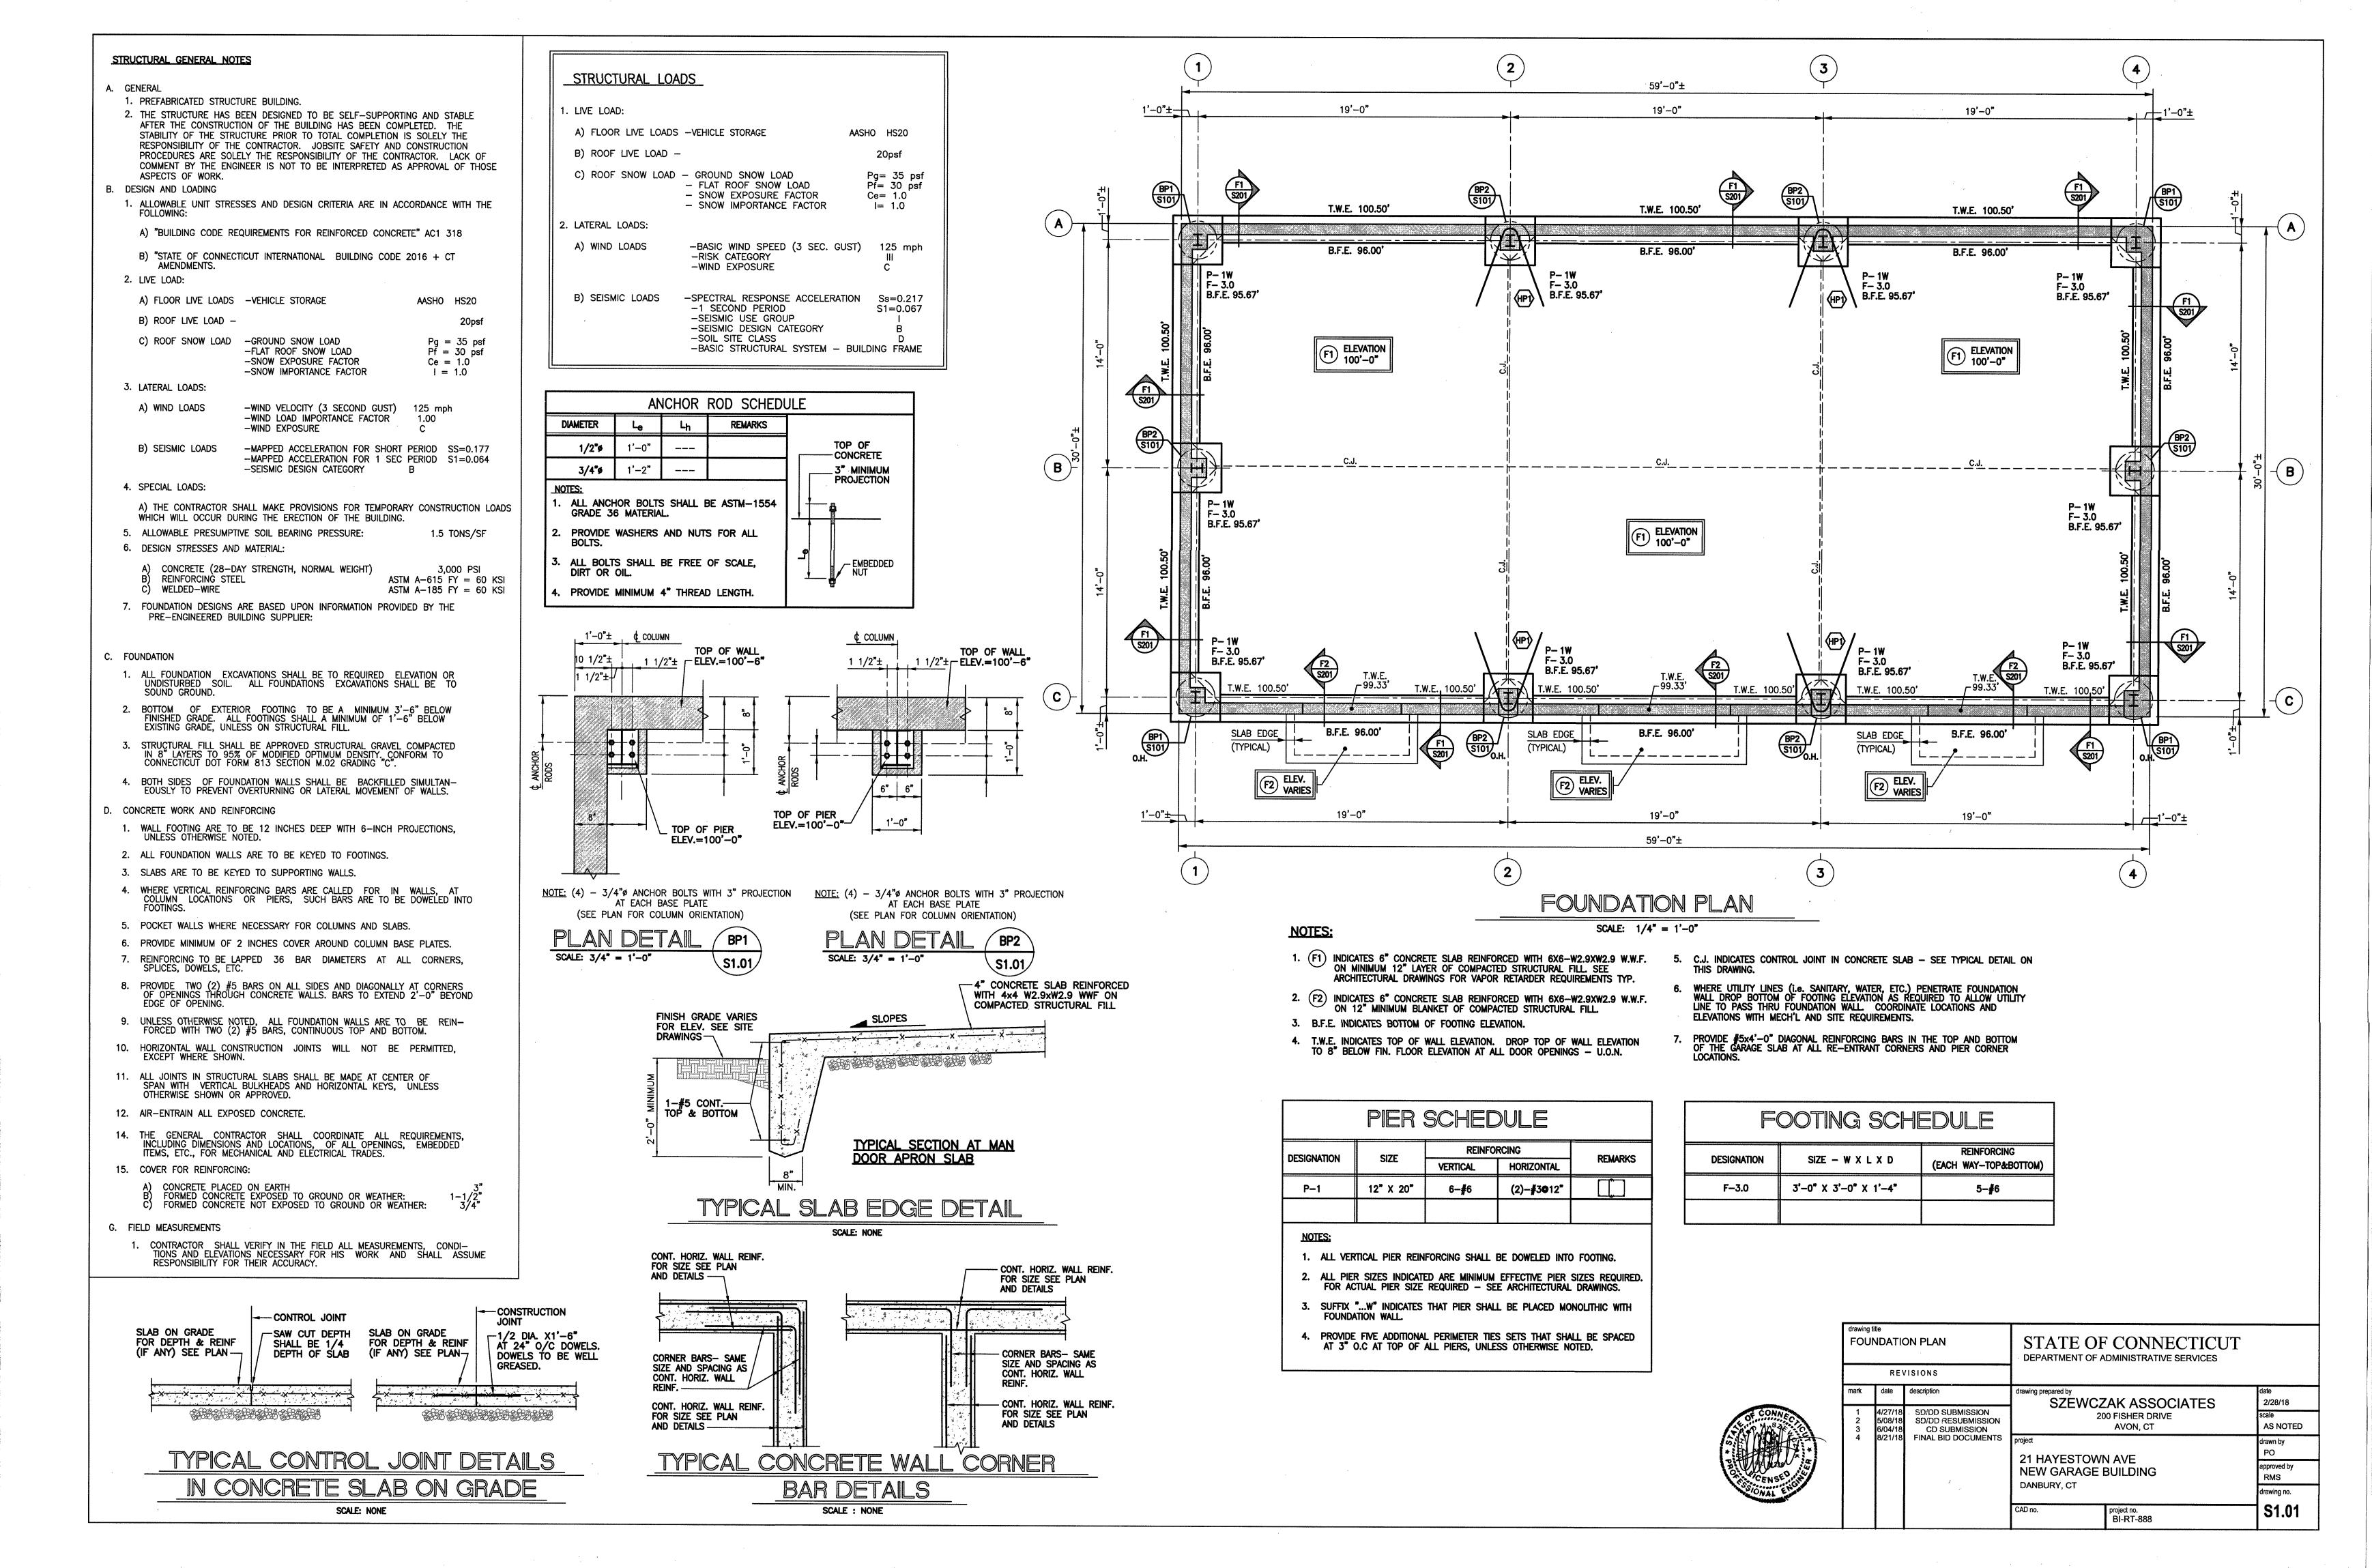


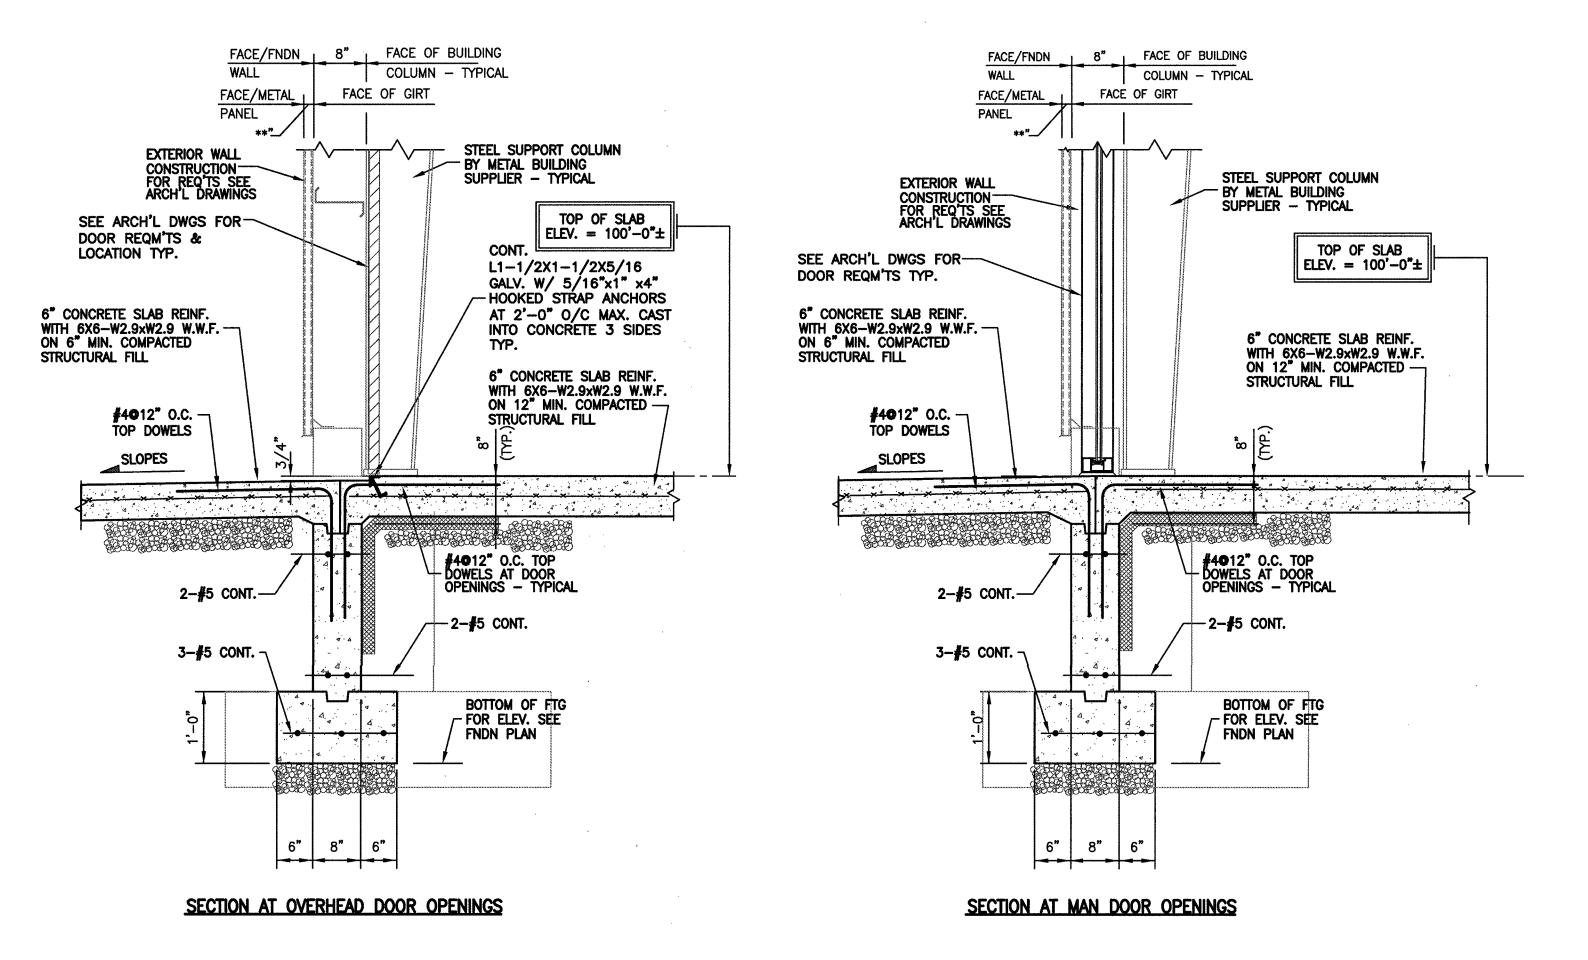

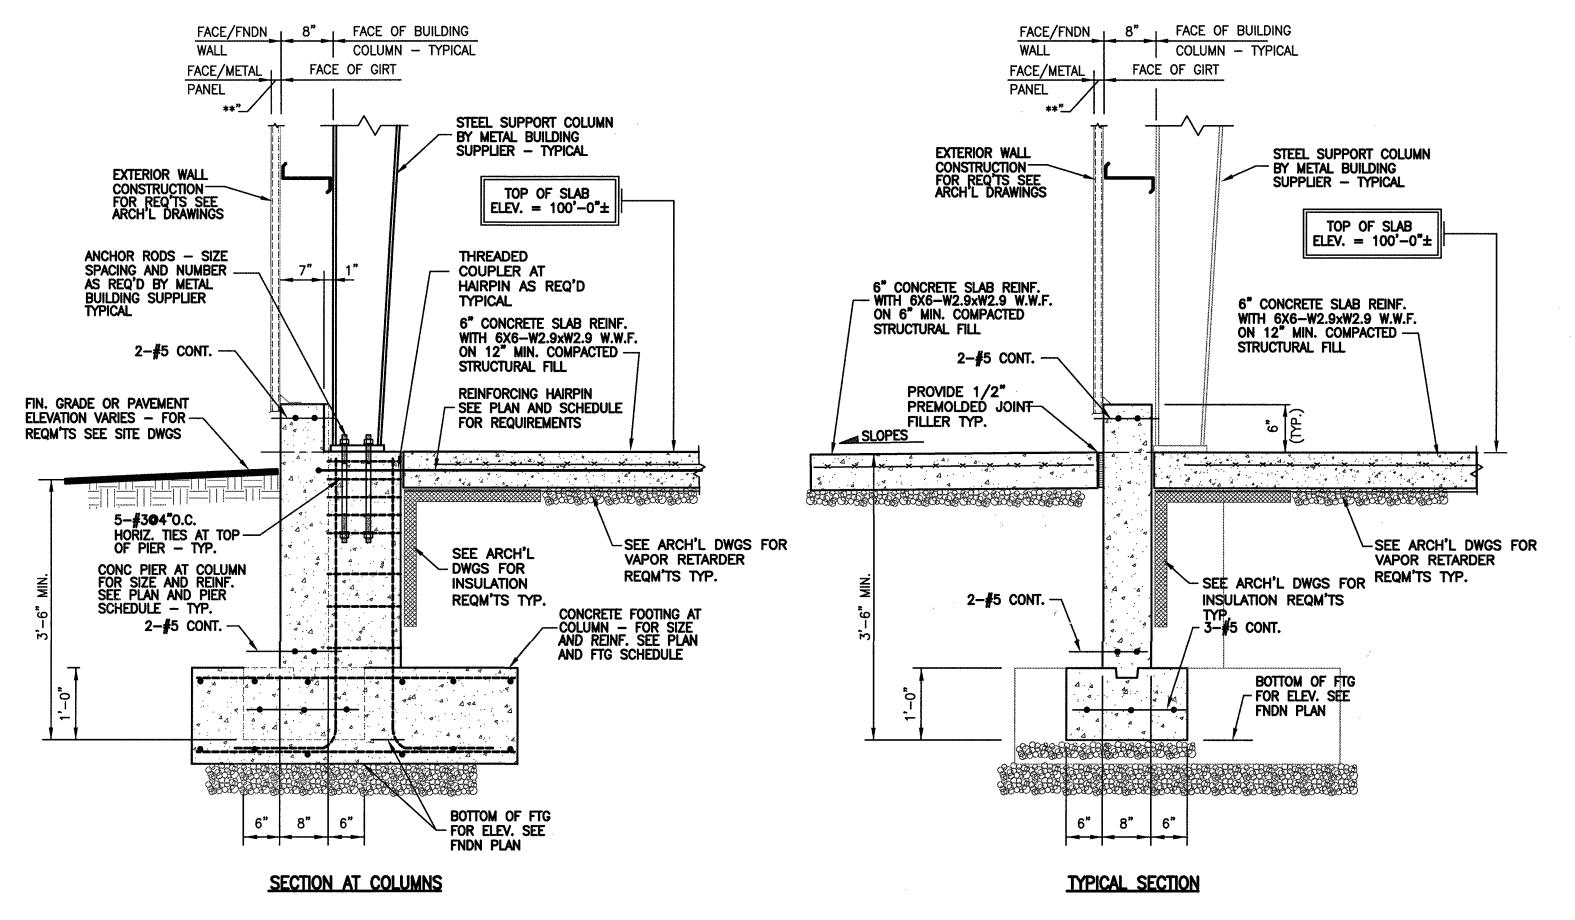


#### EXTERIOR FOUNDATION WALL \S2.01 SCALE: 3/4" = 1'-0"



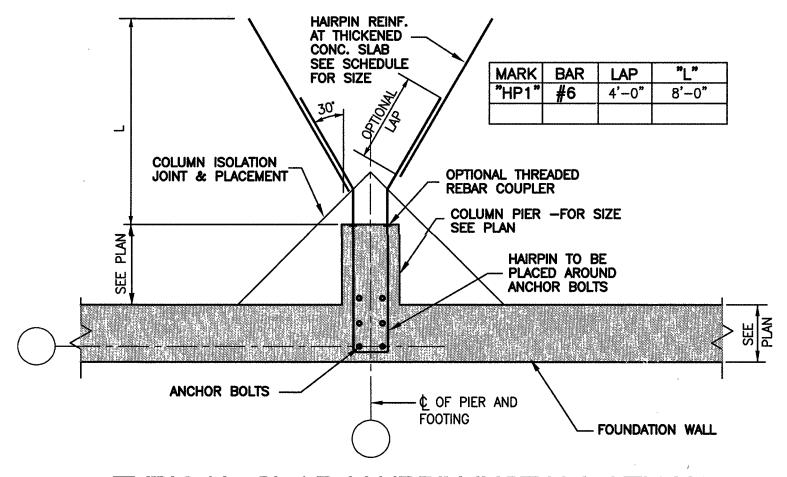



TYPICAL SLAB HAIRPIN INSTALLATION SCALE: NONE

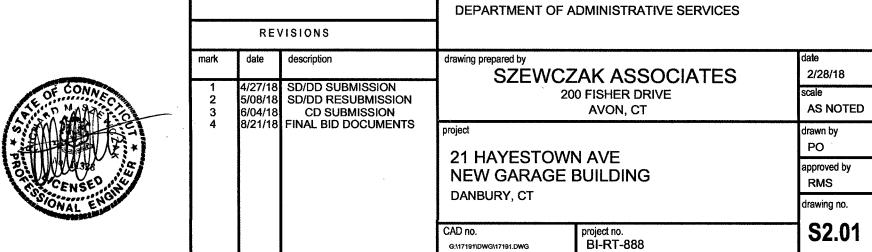


STRUCTURAL SECTIONS

STATE OF CONNECTICUT

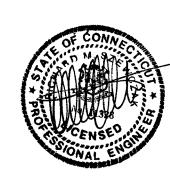

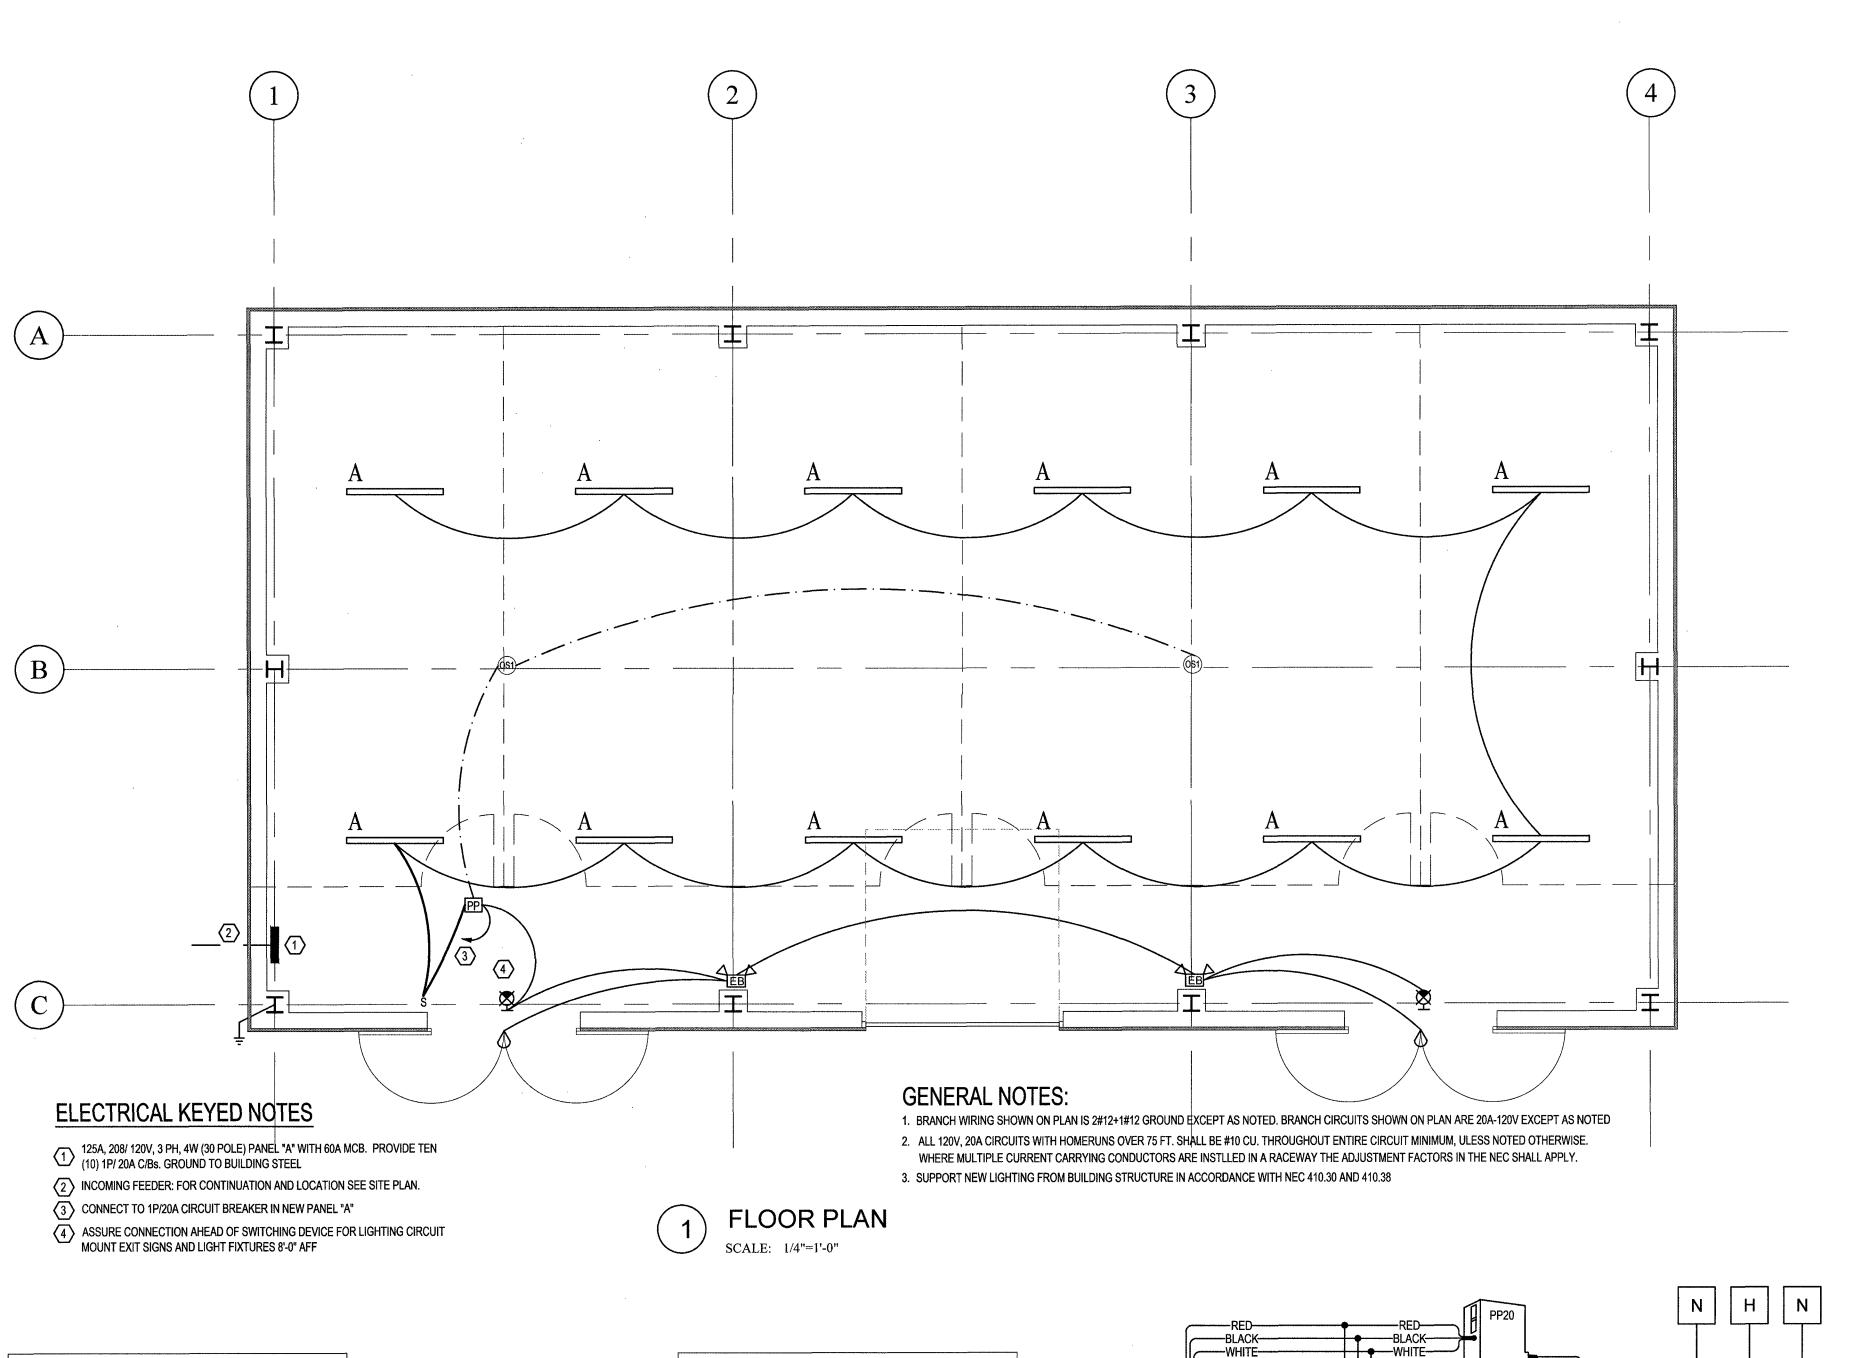

NEW STORAGE BLD

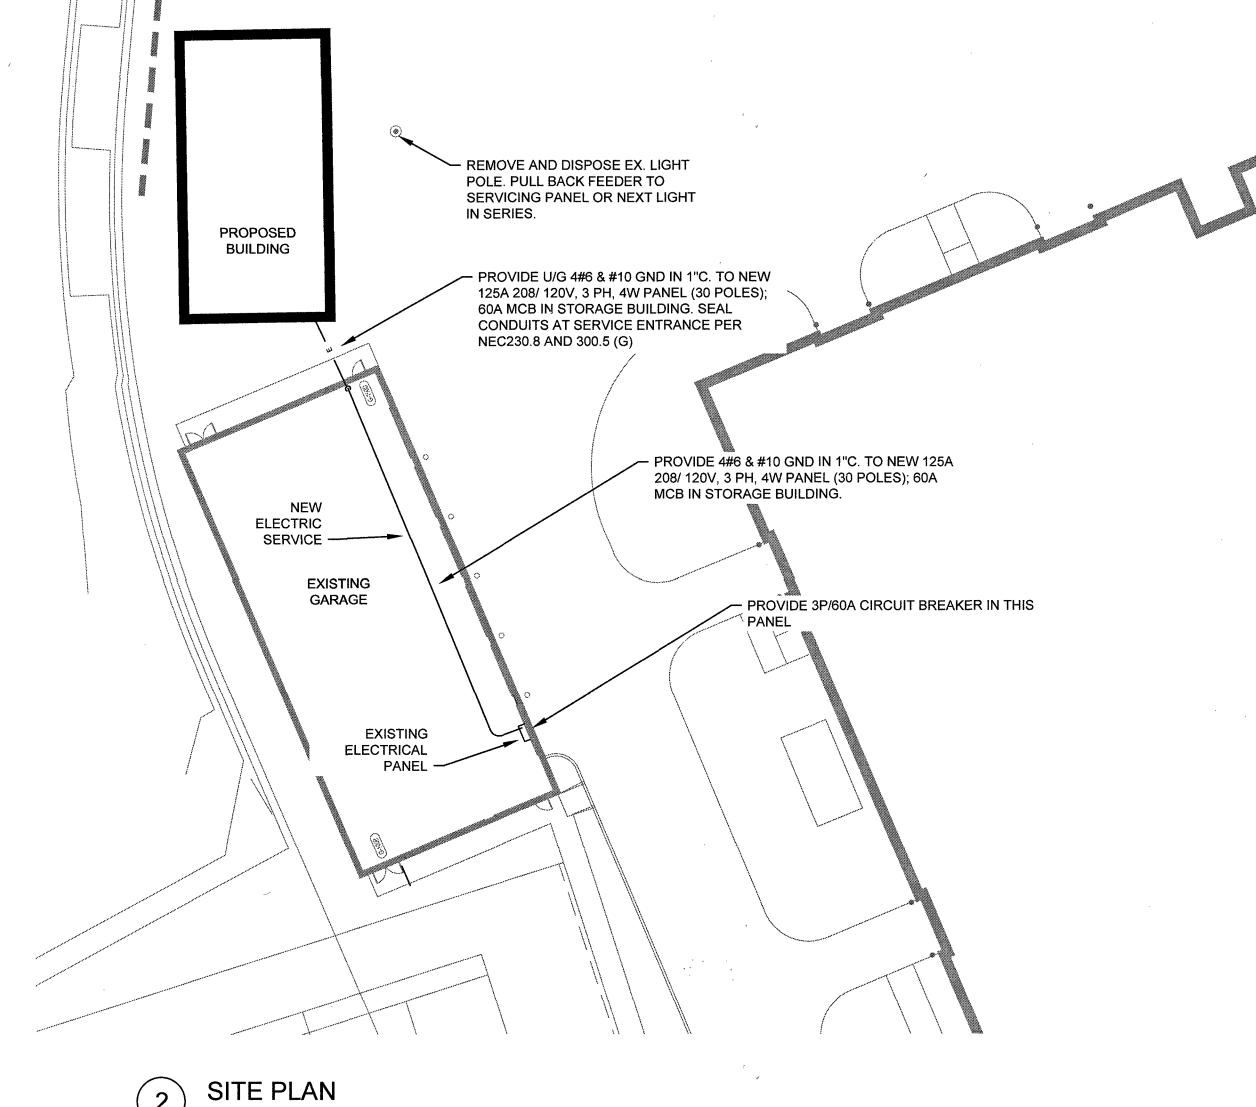


TYPE	DESCRIPTION	LAMPS	REMARKS
<b>\$</b>	EVENLITE EXIT SIGN # TLWCOM R 1 W CW LOW ENERGY CONSUMPTION, COLD WEATHER MOUNT ABOVE EXIT DOORS EQUAL MANUFACTURERS: DUAL LITE, EATON-SURE LITE	4 WATTS LED	COLD WEATHER RATING VANDAL RESISTANT
	EXITRONIX #LED-RX-2-BL WITH ONE (EACH) REMOTE HEAD (#MLED1) MOUNT REMOTE HEAD ABOVE EXIT DOORS  OSYMBOL INDICATES REMOTE LIGHT HEAD  EQUAL MANUFACTURERS: DUAL LITE, EATON-SURE LITE	4 WATTS LED INCLUDED	WET LOCATION, WHITE HOUSING NICKEL CADMIUM BATTERY PROVIDE REMOTE HEAD
A	DAYBRITE LBX55L835-UNV-FD LINEAR SUSPENDED LUMINAIRE WITH FLAT LENS CHAIN MOUNTED @ 10FT AFF TO BOTTOM OF FIXTURE EQUAL MANUFACTURERS: LITHONIA, COLUMBIA	41 WATTS LED	INDOOR SUSPENDED LED PROVIDE WITH V-BRACKET AND CHAIN 0-10 V DIMMABLE

OCCUPANCY SENSOR SCHEDULE NOTE; PROVIDE SENSOR CONTROL WIRING IN ACCORDANCE WITH MFR RECOMMENDATIONS PHILIPS #LRM225500-WHITE FINISH 2000 SQ. FT. COVERAGE (CEILING MOUNTED)

PP POWER PACK
PHILIPS #LCA SERIES S WALL SWITCH

LIGHTING CONTROLS TO BE BY: PHILLIPS STEINEL ACUITY HUBBELL

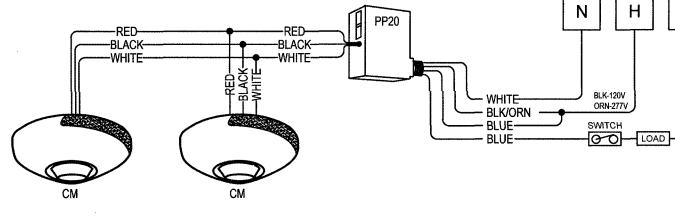

TYPICAL CEILING OCCUPANCY SENSORS WITH POWER PACK

## ELECTRICAL POWER RISER DIAGRAM 1. FEEDER CONDUCTORS ABOVE BASED ON COPPER WITH 75° INSULATION MINIMUM.

2. GROUNDING FOR ALL CIRCUITS SHALL BE IN ACCORDANCE WITH THE NATIONAL ELECTRICAL CODE.


EXISTING STORAGE BLD

NEW PANEL (65000 AIC RATED); SEE PLAN ABOVE FOR DETAILS. IDENTIFY CIRCUITS CONNECTED WITH DIRECTORY UPON COMPLETION OF WORK


PROVIDE GROUNDING ELECTRODE CONDUCTOR (# 8 AWG CU) TO TWO (2) GROUND RODS; 8'-0" RODS SPACED 20'-0" APART. PROVIDE LOW IMPEDANCE TESTING PER NEC.

PROVIDE CONDUIT SEALS AT SERVICE ENTRANCE PER NEC 230.8 AND 300.5 (G).
NEUTRAL CONDUCTOR SHALL BE ELECTRICALLY ISOLATED FROM THE EGC PER NEC 250.32.

PROVIDE 4#6 & #10 GND IN 1"C. TO NEW 125A 208/ 120V, 3 PH, 4W PANEL (30 POLES); 60A MCB IN STORAGE BUILDING.

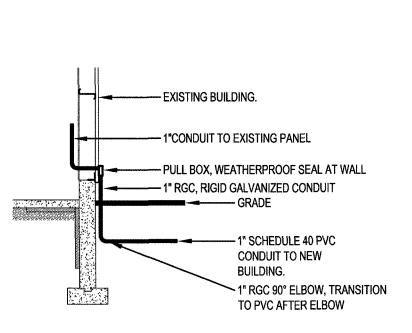

WALL PENETRATION AT EXISTING BUILDING NO SCALE

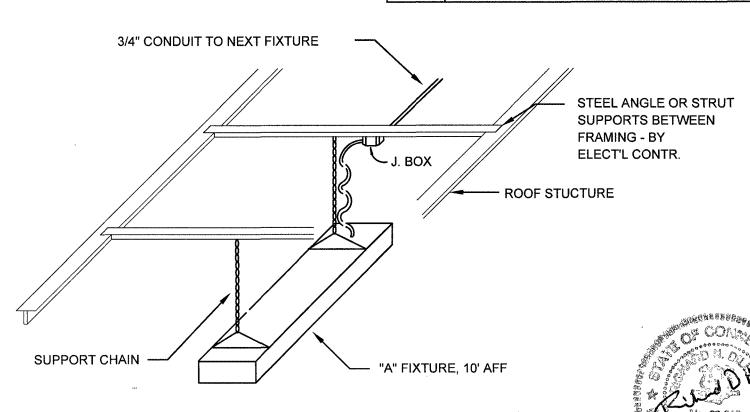

LIGHT	<b>FIXT</b>	URE	SUPPORT	DETAIL
NO SCALE		·		

	OR PLA	NN, ELEVATIONS ING SECTIONS VISIONS	STATE OF A			
mark	date	description	drawing prepared by	ulting Engineers LLC	date 2/28/18	
1	2/28/18	SD/DD SUBMISSION		scale		
2	5/8/18	SD/DD RESUBMISSION	Ì	1/4"=1'-0"		
3	6/4/18	CD SUBMISSION	project	drawn by		
4	4 8/21/18 FINAL BID DOCUMENTS		24 114 1/5 (70) 4/1	RND		
			21 HAYESTOWI NEW GARAGE		approved by RND	
		DAN	DANBURY, CT	DANBURY, CT		
			CAD no. 6:\17191\DWG\17191 DWG	project no. BI-RT-888	E1.01	