



Addendum No.: 4

Date Of Addendum: 1/27/2017

CT DAS ● Construction Services ● Process Management and Procurement Unit

PHASE 1 ENHANCEMENTS
SILVER SANDS STATE PARK
MILFORD, CT
BI - T - 604

Original Bid Due Date / Time:

February 1, 2017

1:00 pm

Previous Addendums: Addendum #3 dated 1/24/2017, Addendum #2 dated 1/13/2017, Addendum #1 dated 1/3/2017

TO: Prospective Bid Proposers:

This Addendum forms part of the "Contract Documents" and modifies or clarifies the original "Contract Documents" for this Project dated 11/28/2016. Prospective Bid Proposers **shall** acknowledge receipt of the total number the Addenda issued for this Project on the space provided on Section 00 41 00 Bid Proposal Form.

Failure to acknowledge receipt of the total number the Addenda issued for this Project on the space provided on Section 00 41 00 Bid Proposal Form **shall** subject Bid Proposers to disqualification.

The following clarifications are applicable to drawings and specifications for the project referenced above.

Item 1:

Attached is the drawing E-103 from Addendum #3


End of Addendum 4

Mellanee Walton, Associate Fiscal Administrative Officer
State of Connecticut
Department of Administrative Services, Construction Services
Process Management and Procurement Unit
450 Columbus Boulevard, Suite 1302
Hartford, CT 06103


GENERAL NOTES:
 1. SEE DWG. E-001 FOR ELECTRICAL LEAD SHEET.

KEYED NOTES:

- 20BY/120V, 100A, 3P BUS COMBINER BOX. ENCLOSURE SHALL BE PAD LOCKABLE
- PV SYSTEM AC DISCONNECT SWITCH, 100A, 240V, 3P, NEMA4X. SEE DRAWING E-602 FOR MORE INFORMATION. PROVIDE A PLAQUE WHICH STATES "PV SYSTEM MAIN AC DISCONNECT SWITCH".
- RECEPTACLE MOUNTED IN FLOORBOX. NEMA 6-2R 20A-RPOLE 250V. COORDINATE EXACT LOCATION WITH OWNER.
- NEMA 5-20R RECEPTACLE MOUNTED IN FLOORBOX FOR SMALL EQUIPMENT LIFT.
- JUNCTION BOX MOUNTED ABOVE FOR VEHICLE LIFT POWER.
- SEE DRAWING E-602 FOR MORE INFORMATION REGARDING PHOTOVOLTAIC EQUIPMENT.
- PROVIDE HEAT TRACING ON COLD WATER LINES GOING TO HOSE BIB AND EYE WASH STATIONS. SEE PLUMBING DRAWING P-103 FOR PIPE SIZE AND EXTENT. SEE DRAWING E-503 FOR HEAT TRACE SPECIFICATIONS.
- ALL INVERTERS SHALL BE LOCKABLE ENCLOSURES.
- PROVIDE A PLAQUE WHICH STATES "UTILITY MAIN DISCONNECT SWITCH".
- UNDERGROUND CONDUIT FROM MAIN DISCONNECT SWITCH TO PANEL PPM.

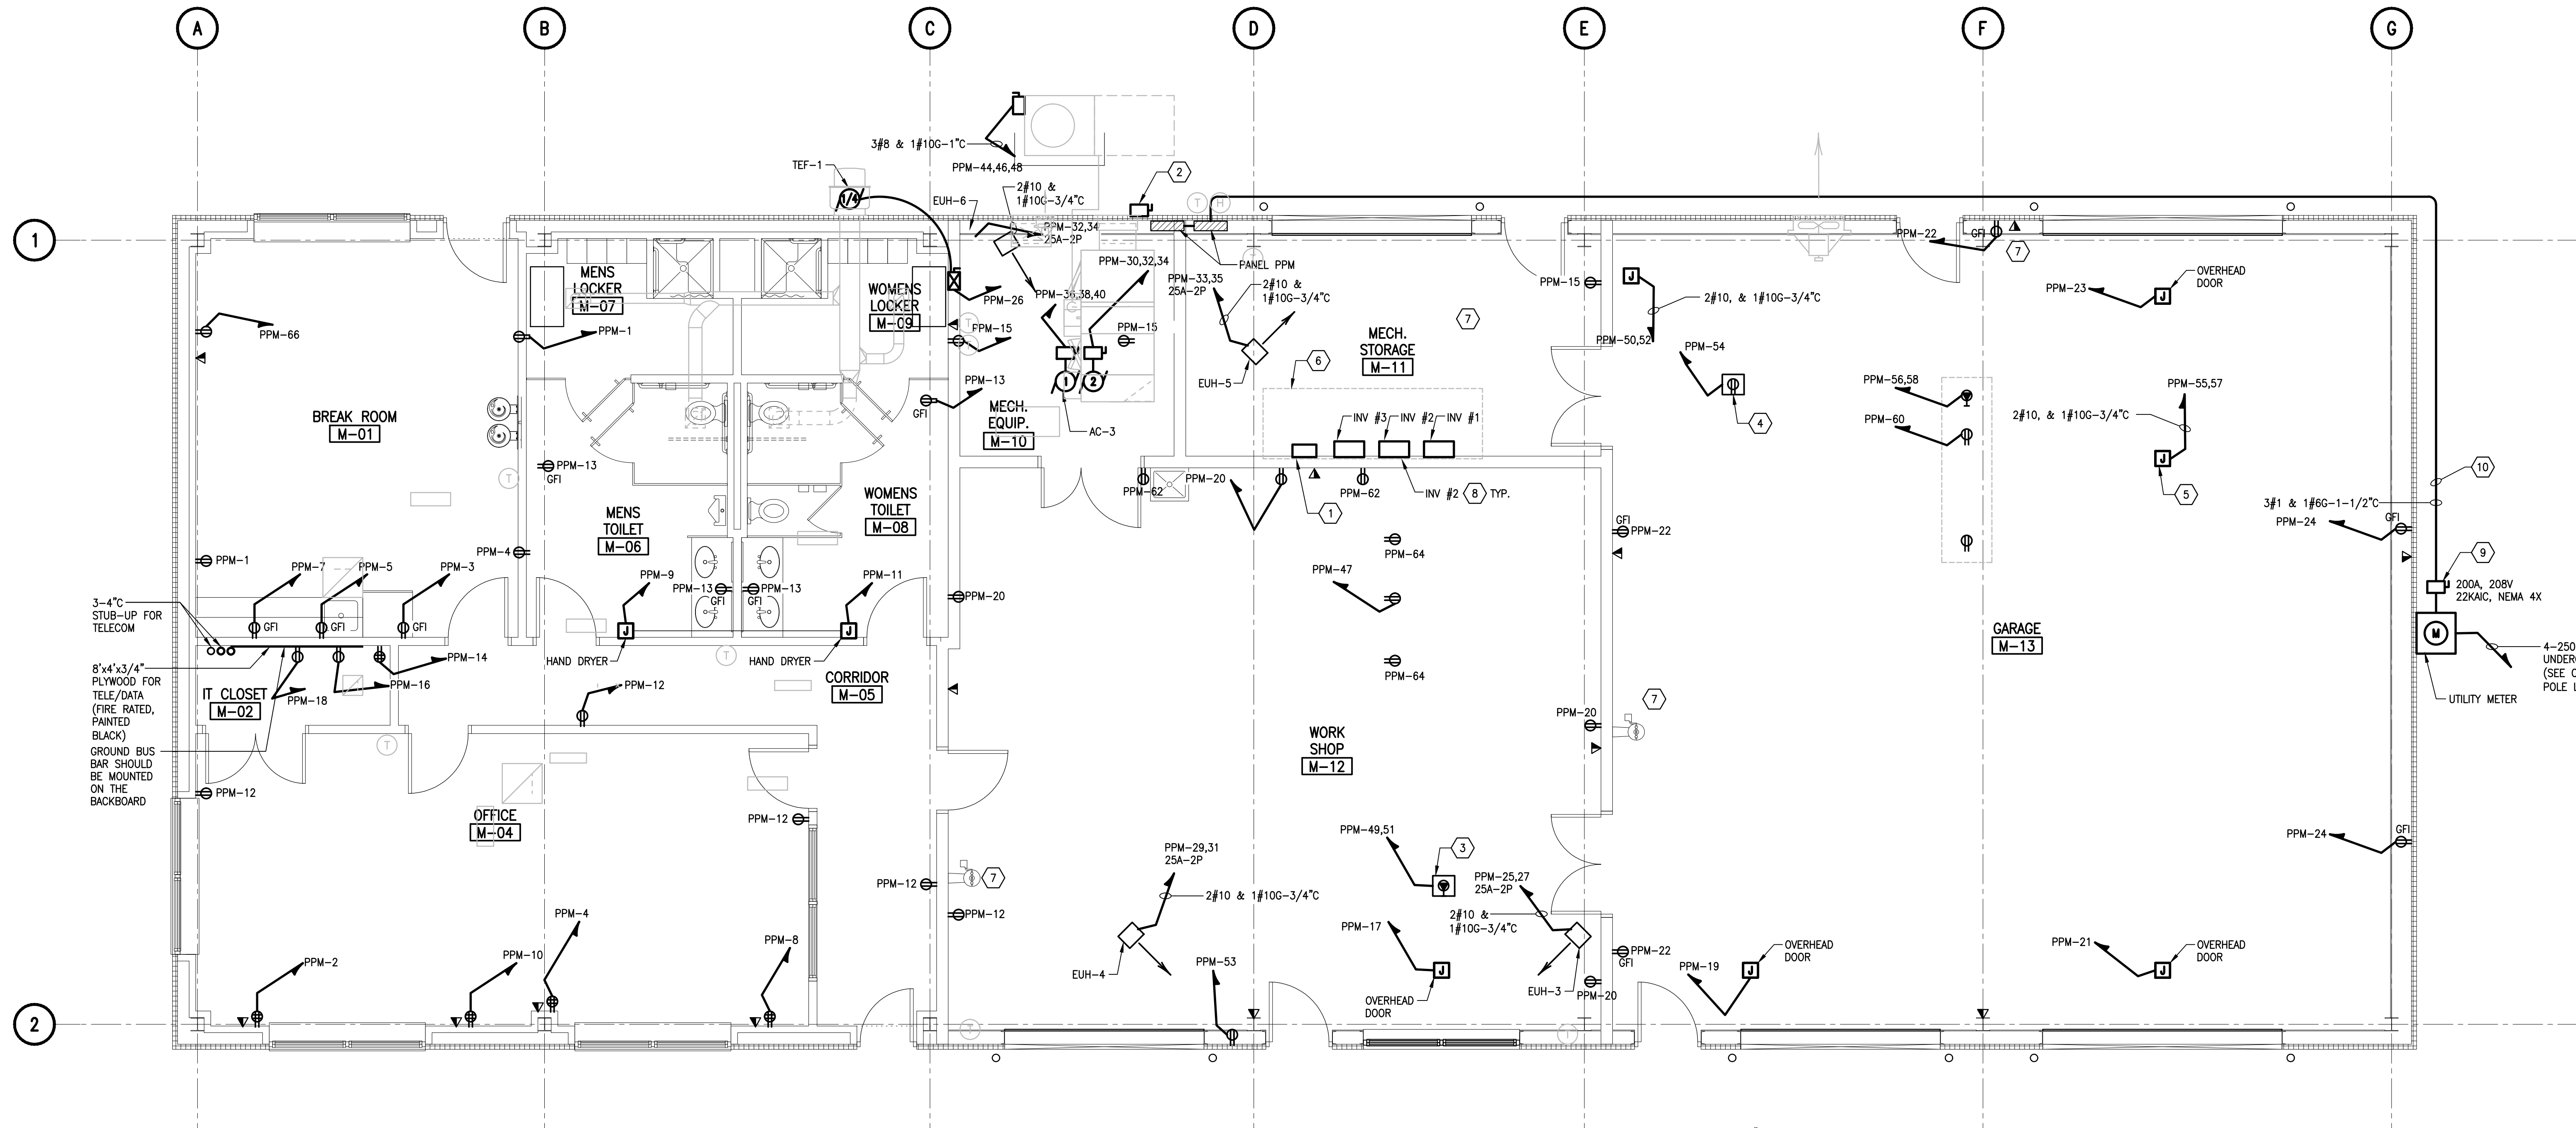

MAINTENANCE/OFFICE BUILDING POWER PLAN
 SCALE: 1/4" = 1'-0"

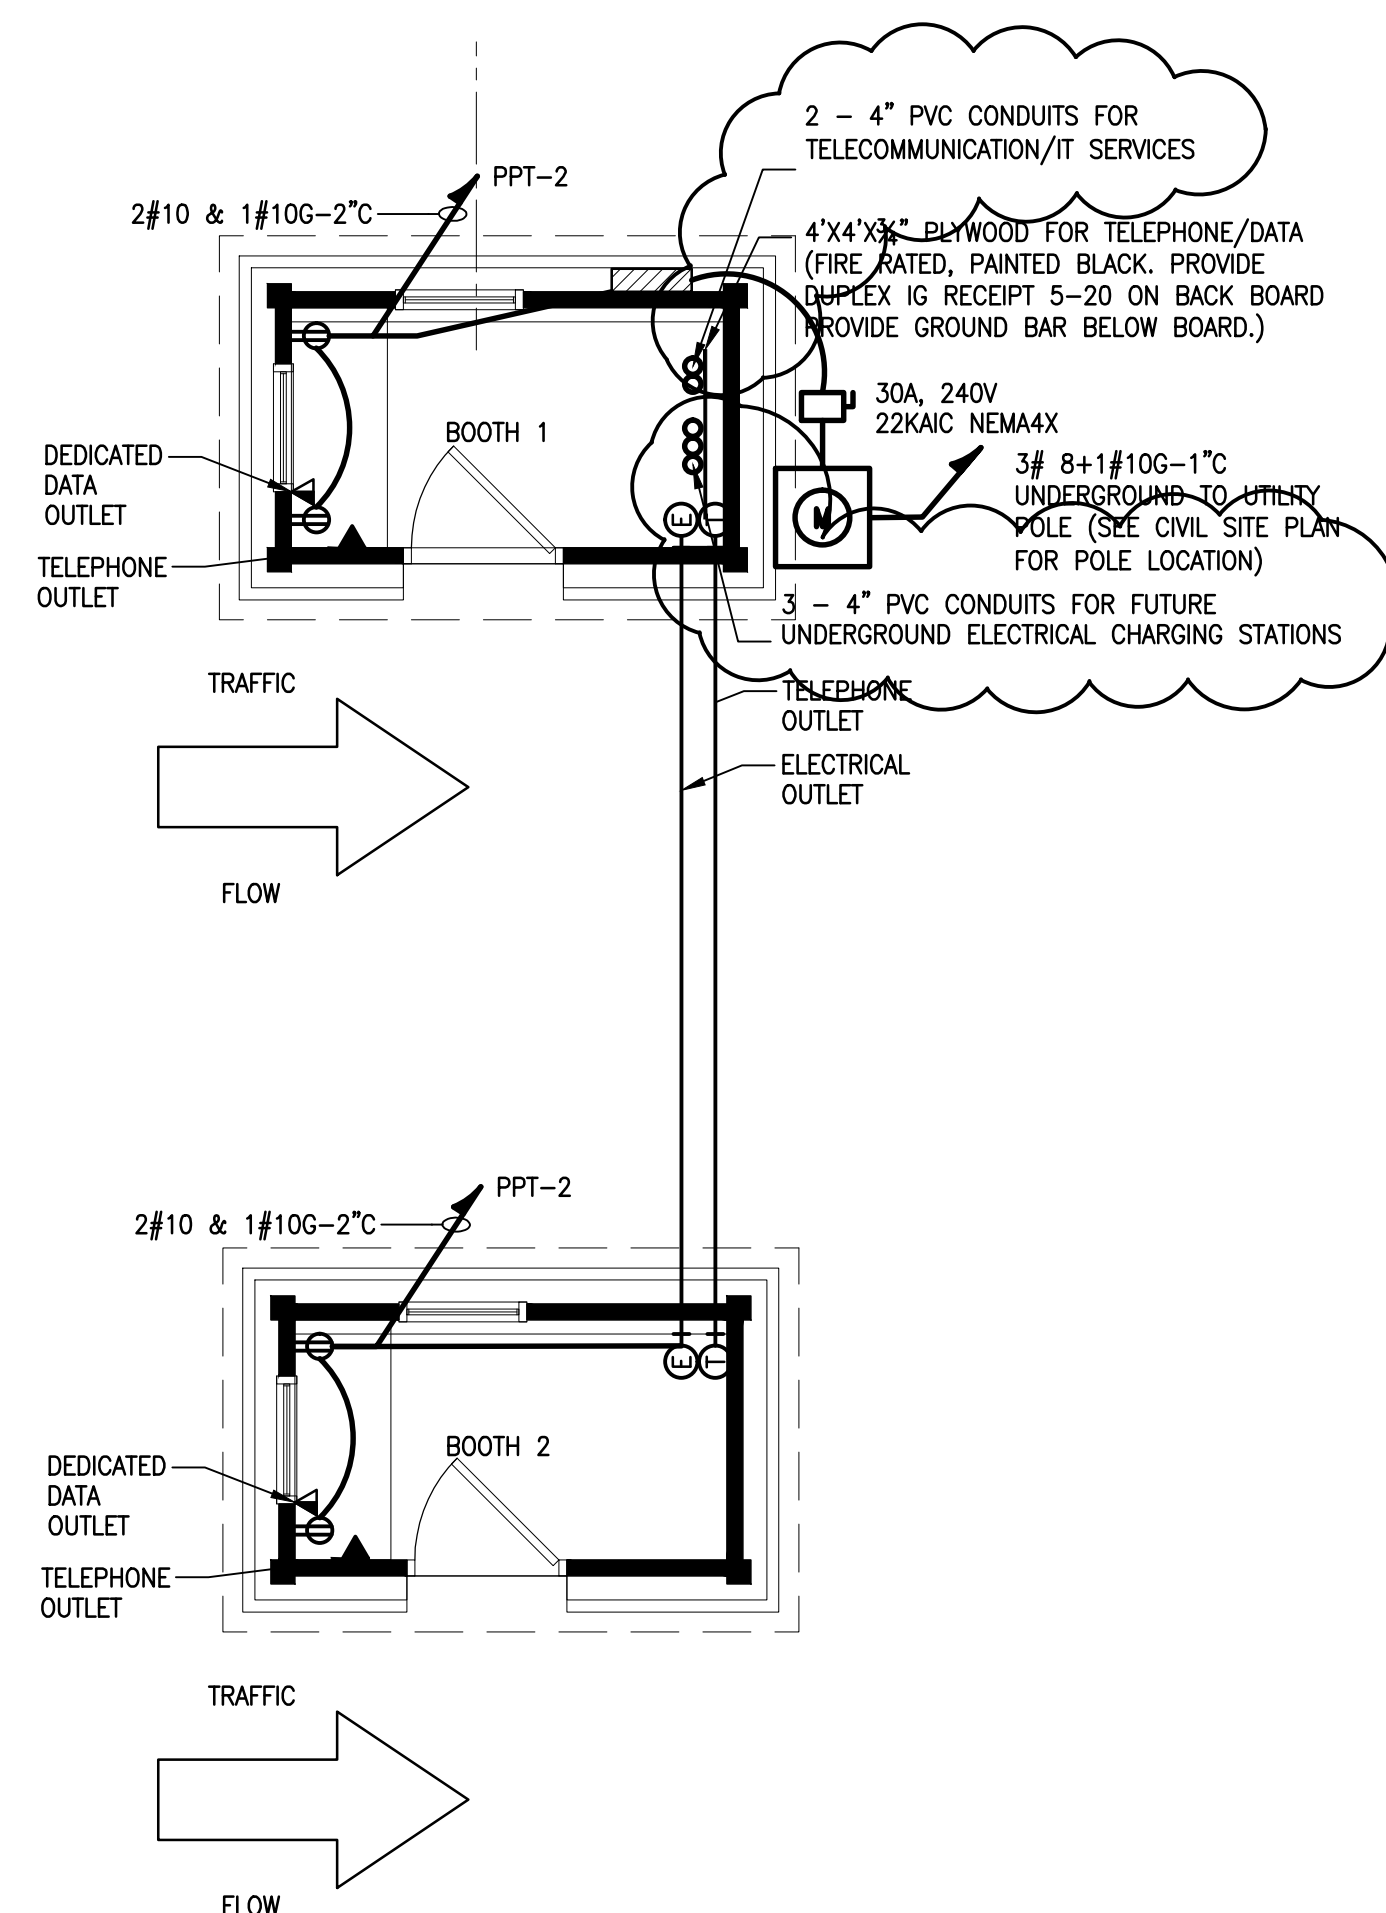

TYPICAL TICKET BOOTH POWER PLAN
 SCALE: 1/4" = 1'-0"

drawing title: POWER PLAN - MAINT./OFFICE BLDG. & TICKET BOOTH	STATE OF CONNECTICUT DEPARTMENT OF ADMINISTRATIVE SERVICES	date: 07/1/16
ADDENDUM 2 - 1/9/2017	drawing prepared by: STANTEC CONSULTING SERVICES INC. 55 CHURCH STREET, SUITE 601 NEW HAVEN, CT 06510 (203) 495-1645	scale: 1/4" = 1'-0"
project: SILVER SANDS STATE PARK PHASE 1B ENHANCEMENTS Milford, CT	drawn by: R.W.	approved by: R.W.
CAD no: 192310379	project no: BI-T-604	E-103